



PRELIMINARY NOT FOR CONSTRUCTION

CONSULTANT:

RUNBERG ARCHITECTURE GROUP

PROJECT NUMBER

GRANT PARK VILLAGE

NE 33RD & BROADWAY PORTLAND, OR


SHEET TITLE:

VICINITY PLAN

DRAWN BY:

X>



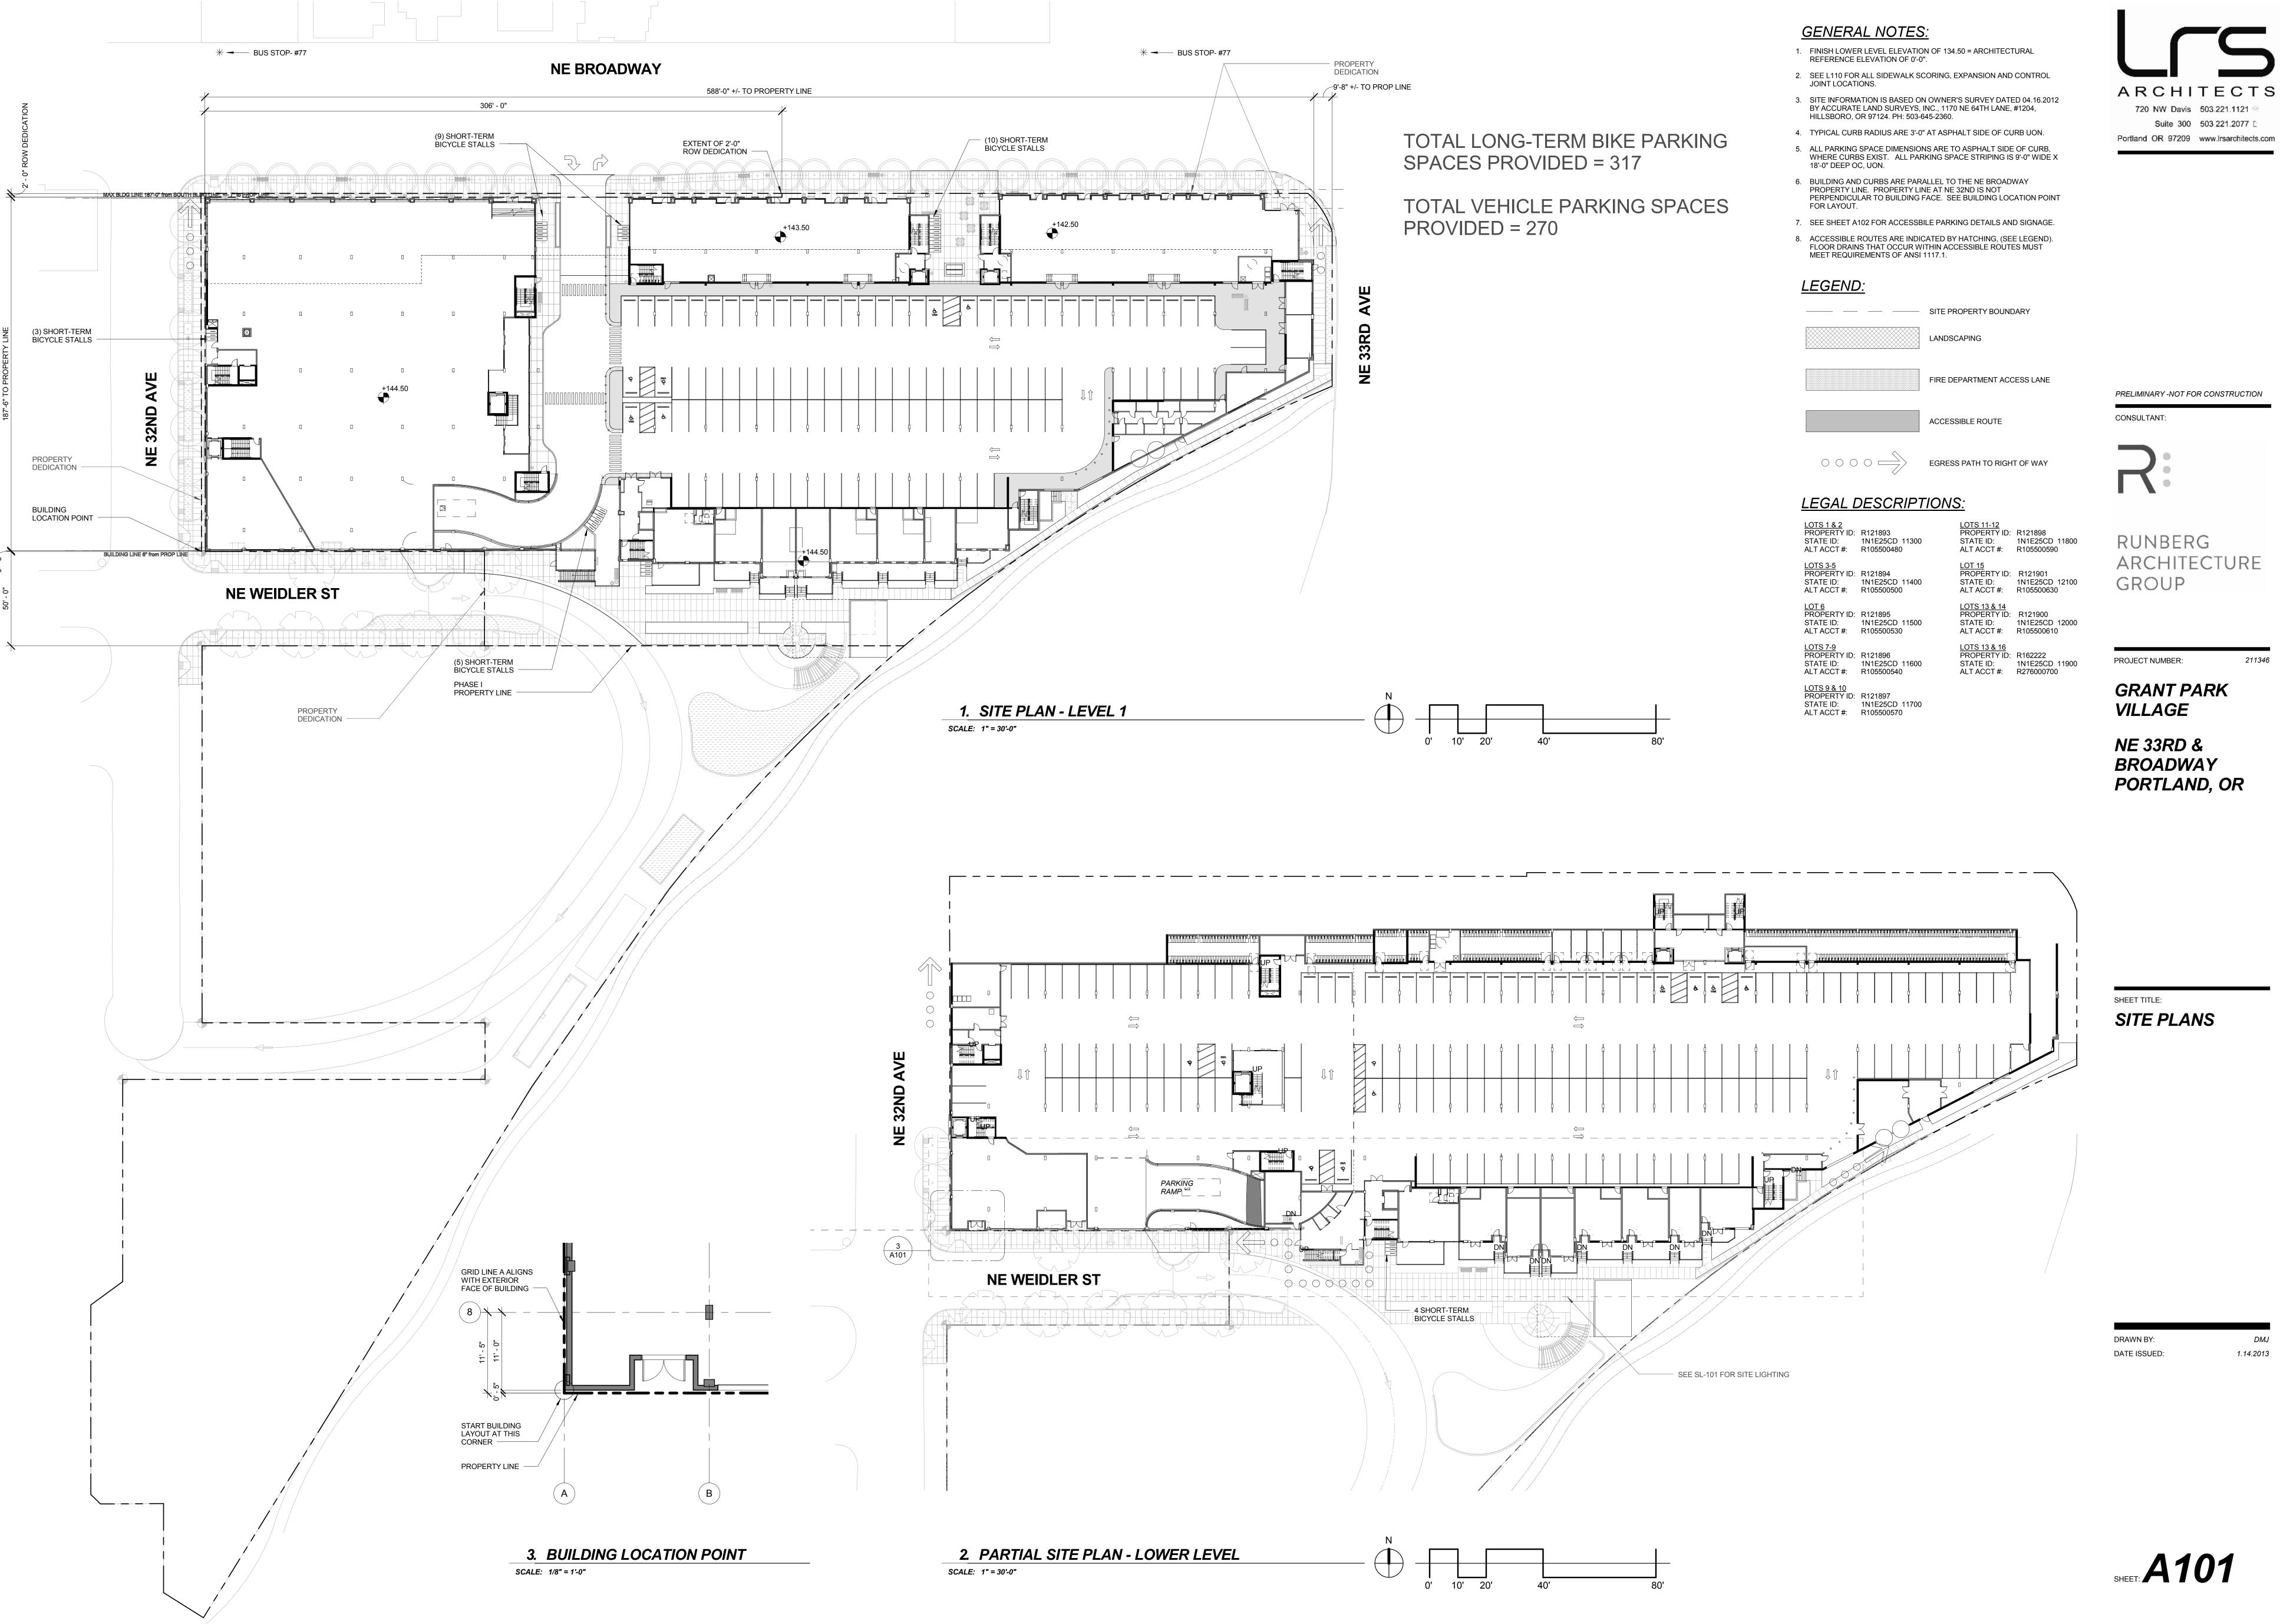

PROJECT NUMBER:

Suite 300 503 221.2077 [

GRANT PARK VILLAGE

NE 33RD & BROADWAY PORTLAND, OR

SHEET TITLE:





Portland OR 97209 www.lrsarchitects.com GROUP



GRANT PARK VILLAGE

NE 33rd & BROADWAY PORTLAND, OR

PROJECT NAME:

REVISION:

GRANT PARK VILLAGE

PROJECT NUMBER:

211346

DATE ISSUED: 01.14.13









GRANT PARK VILLAGE

NE 33rd & BROADWAY PORTLAND, OR

PROJECT NAME:

DATE ISSUED:

REVISION:

PROJECT NUMBER:


GRANT PARK VILLAGE

211346 01.14.13

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SHEET:



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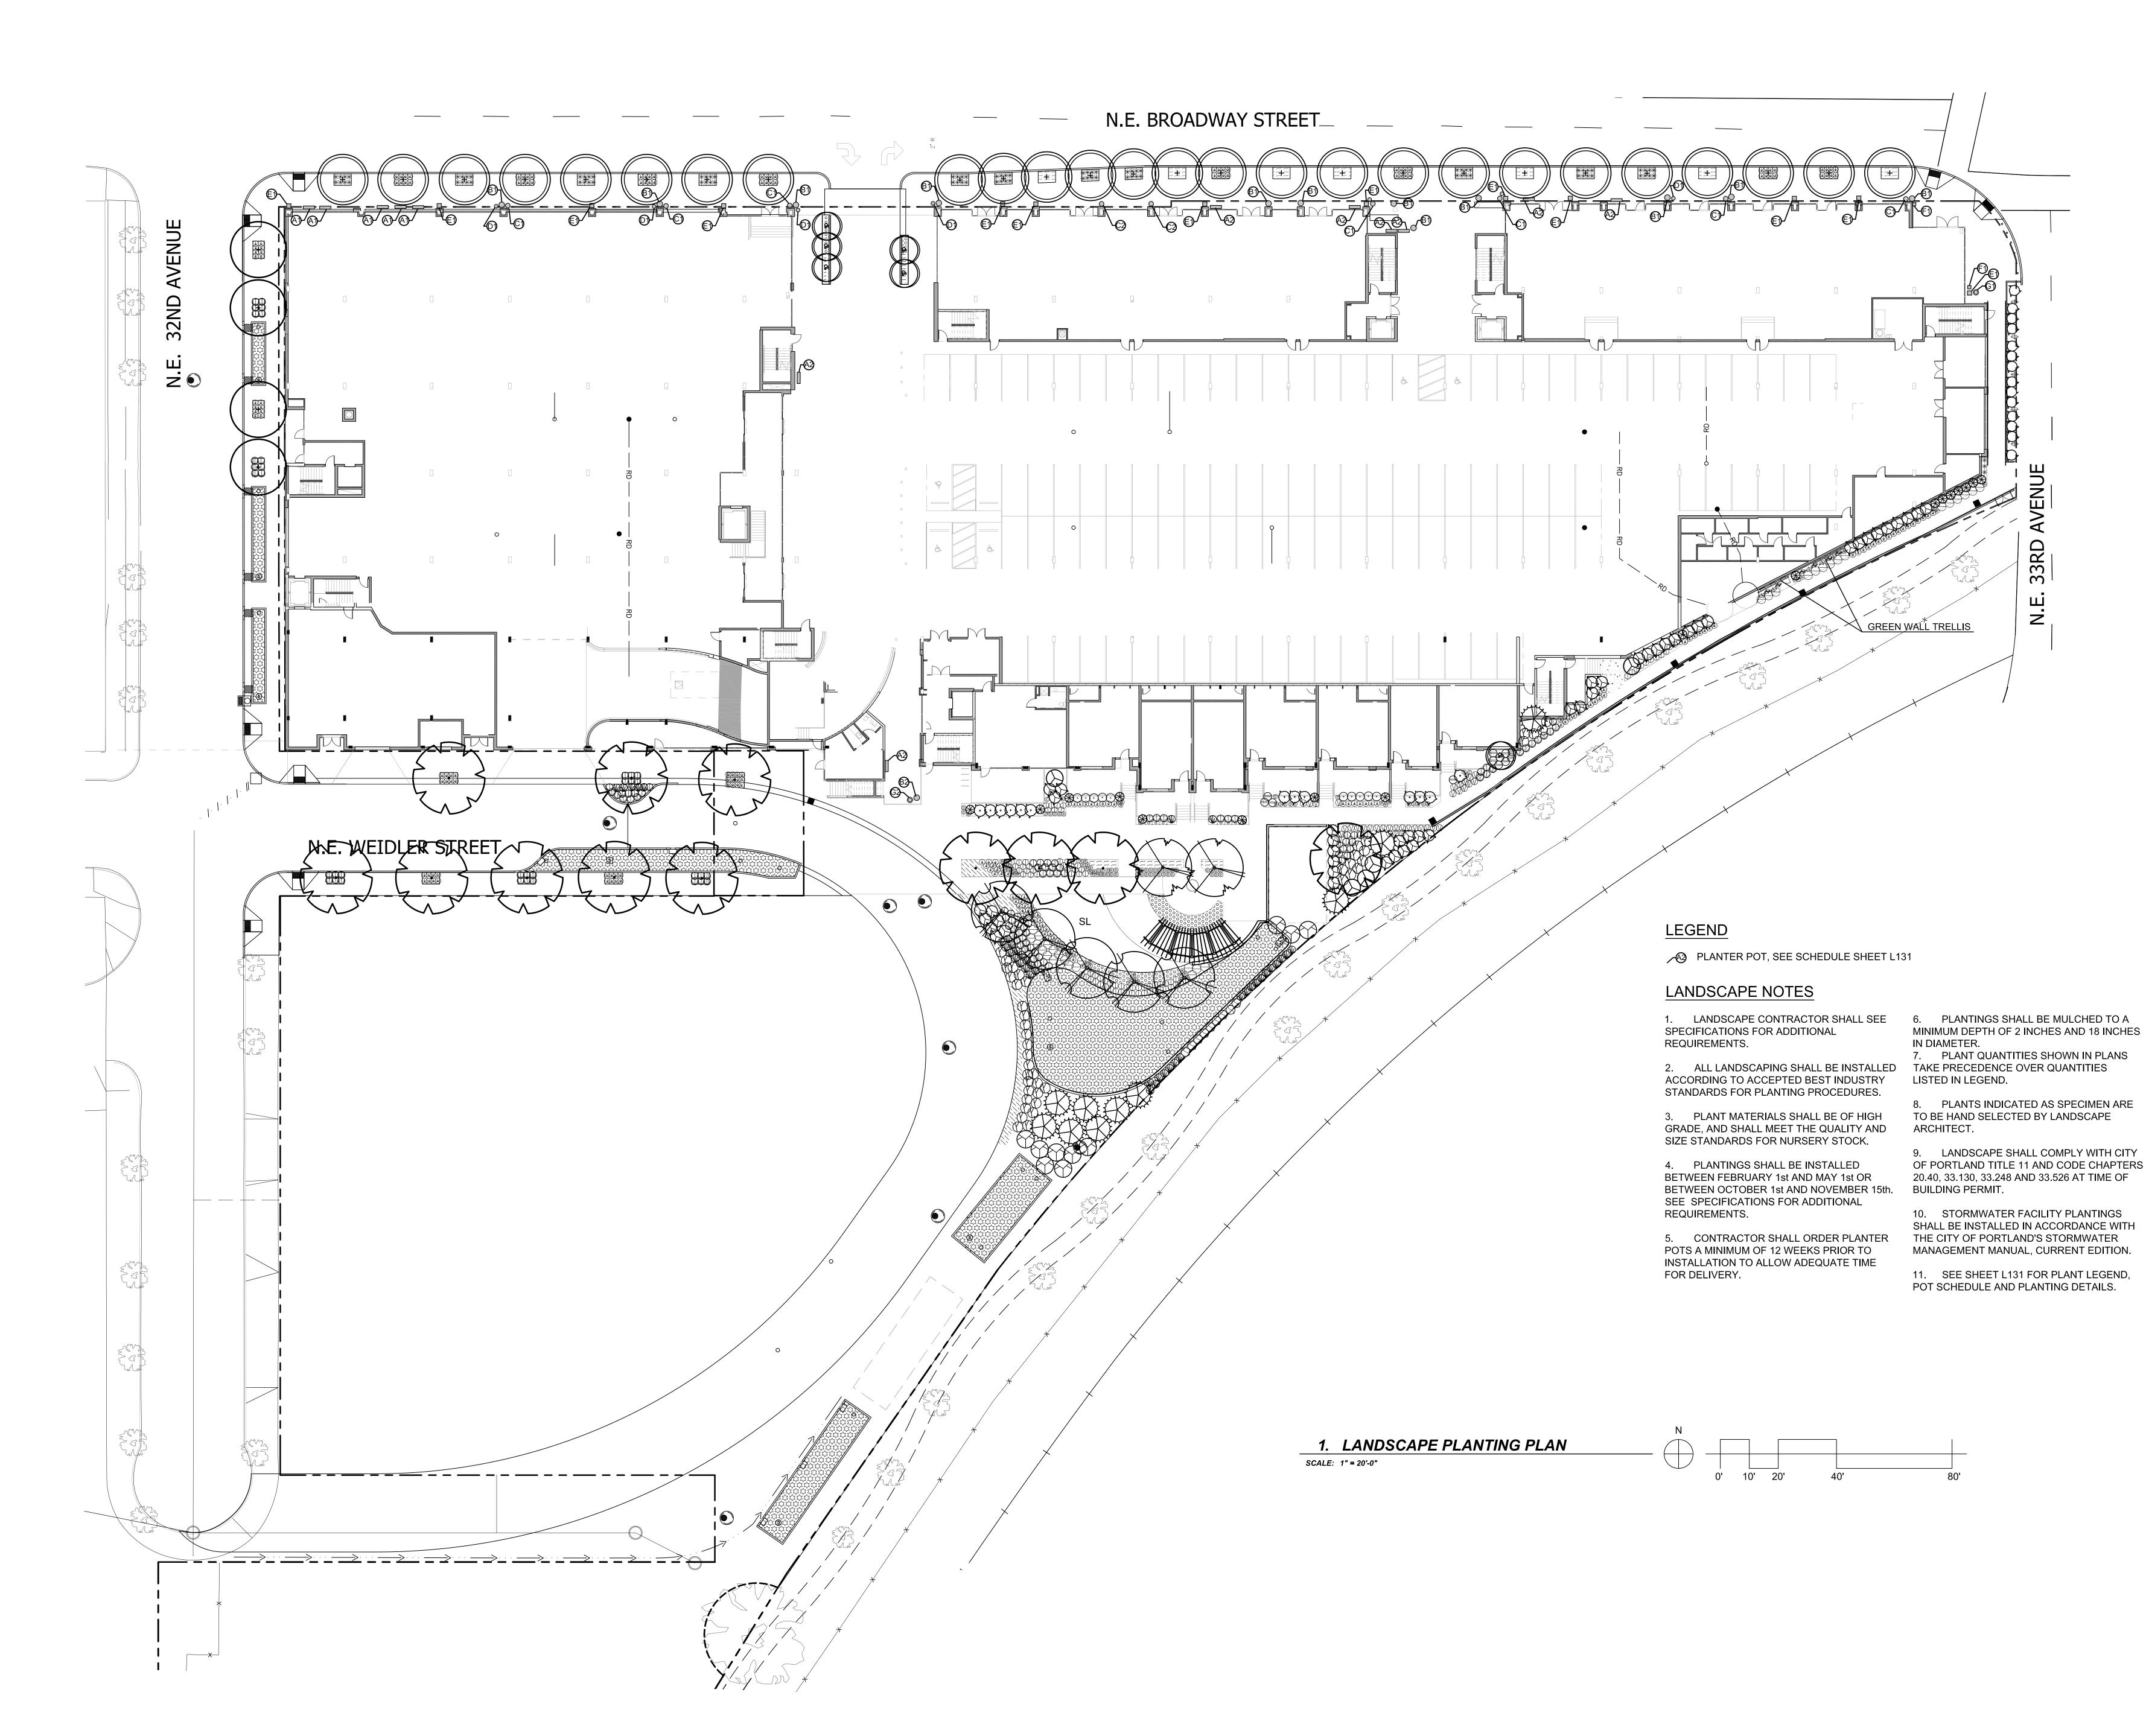
RUNBERG ARCHITECTURE

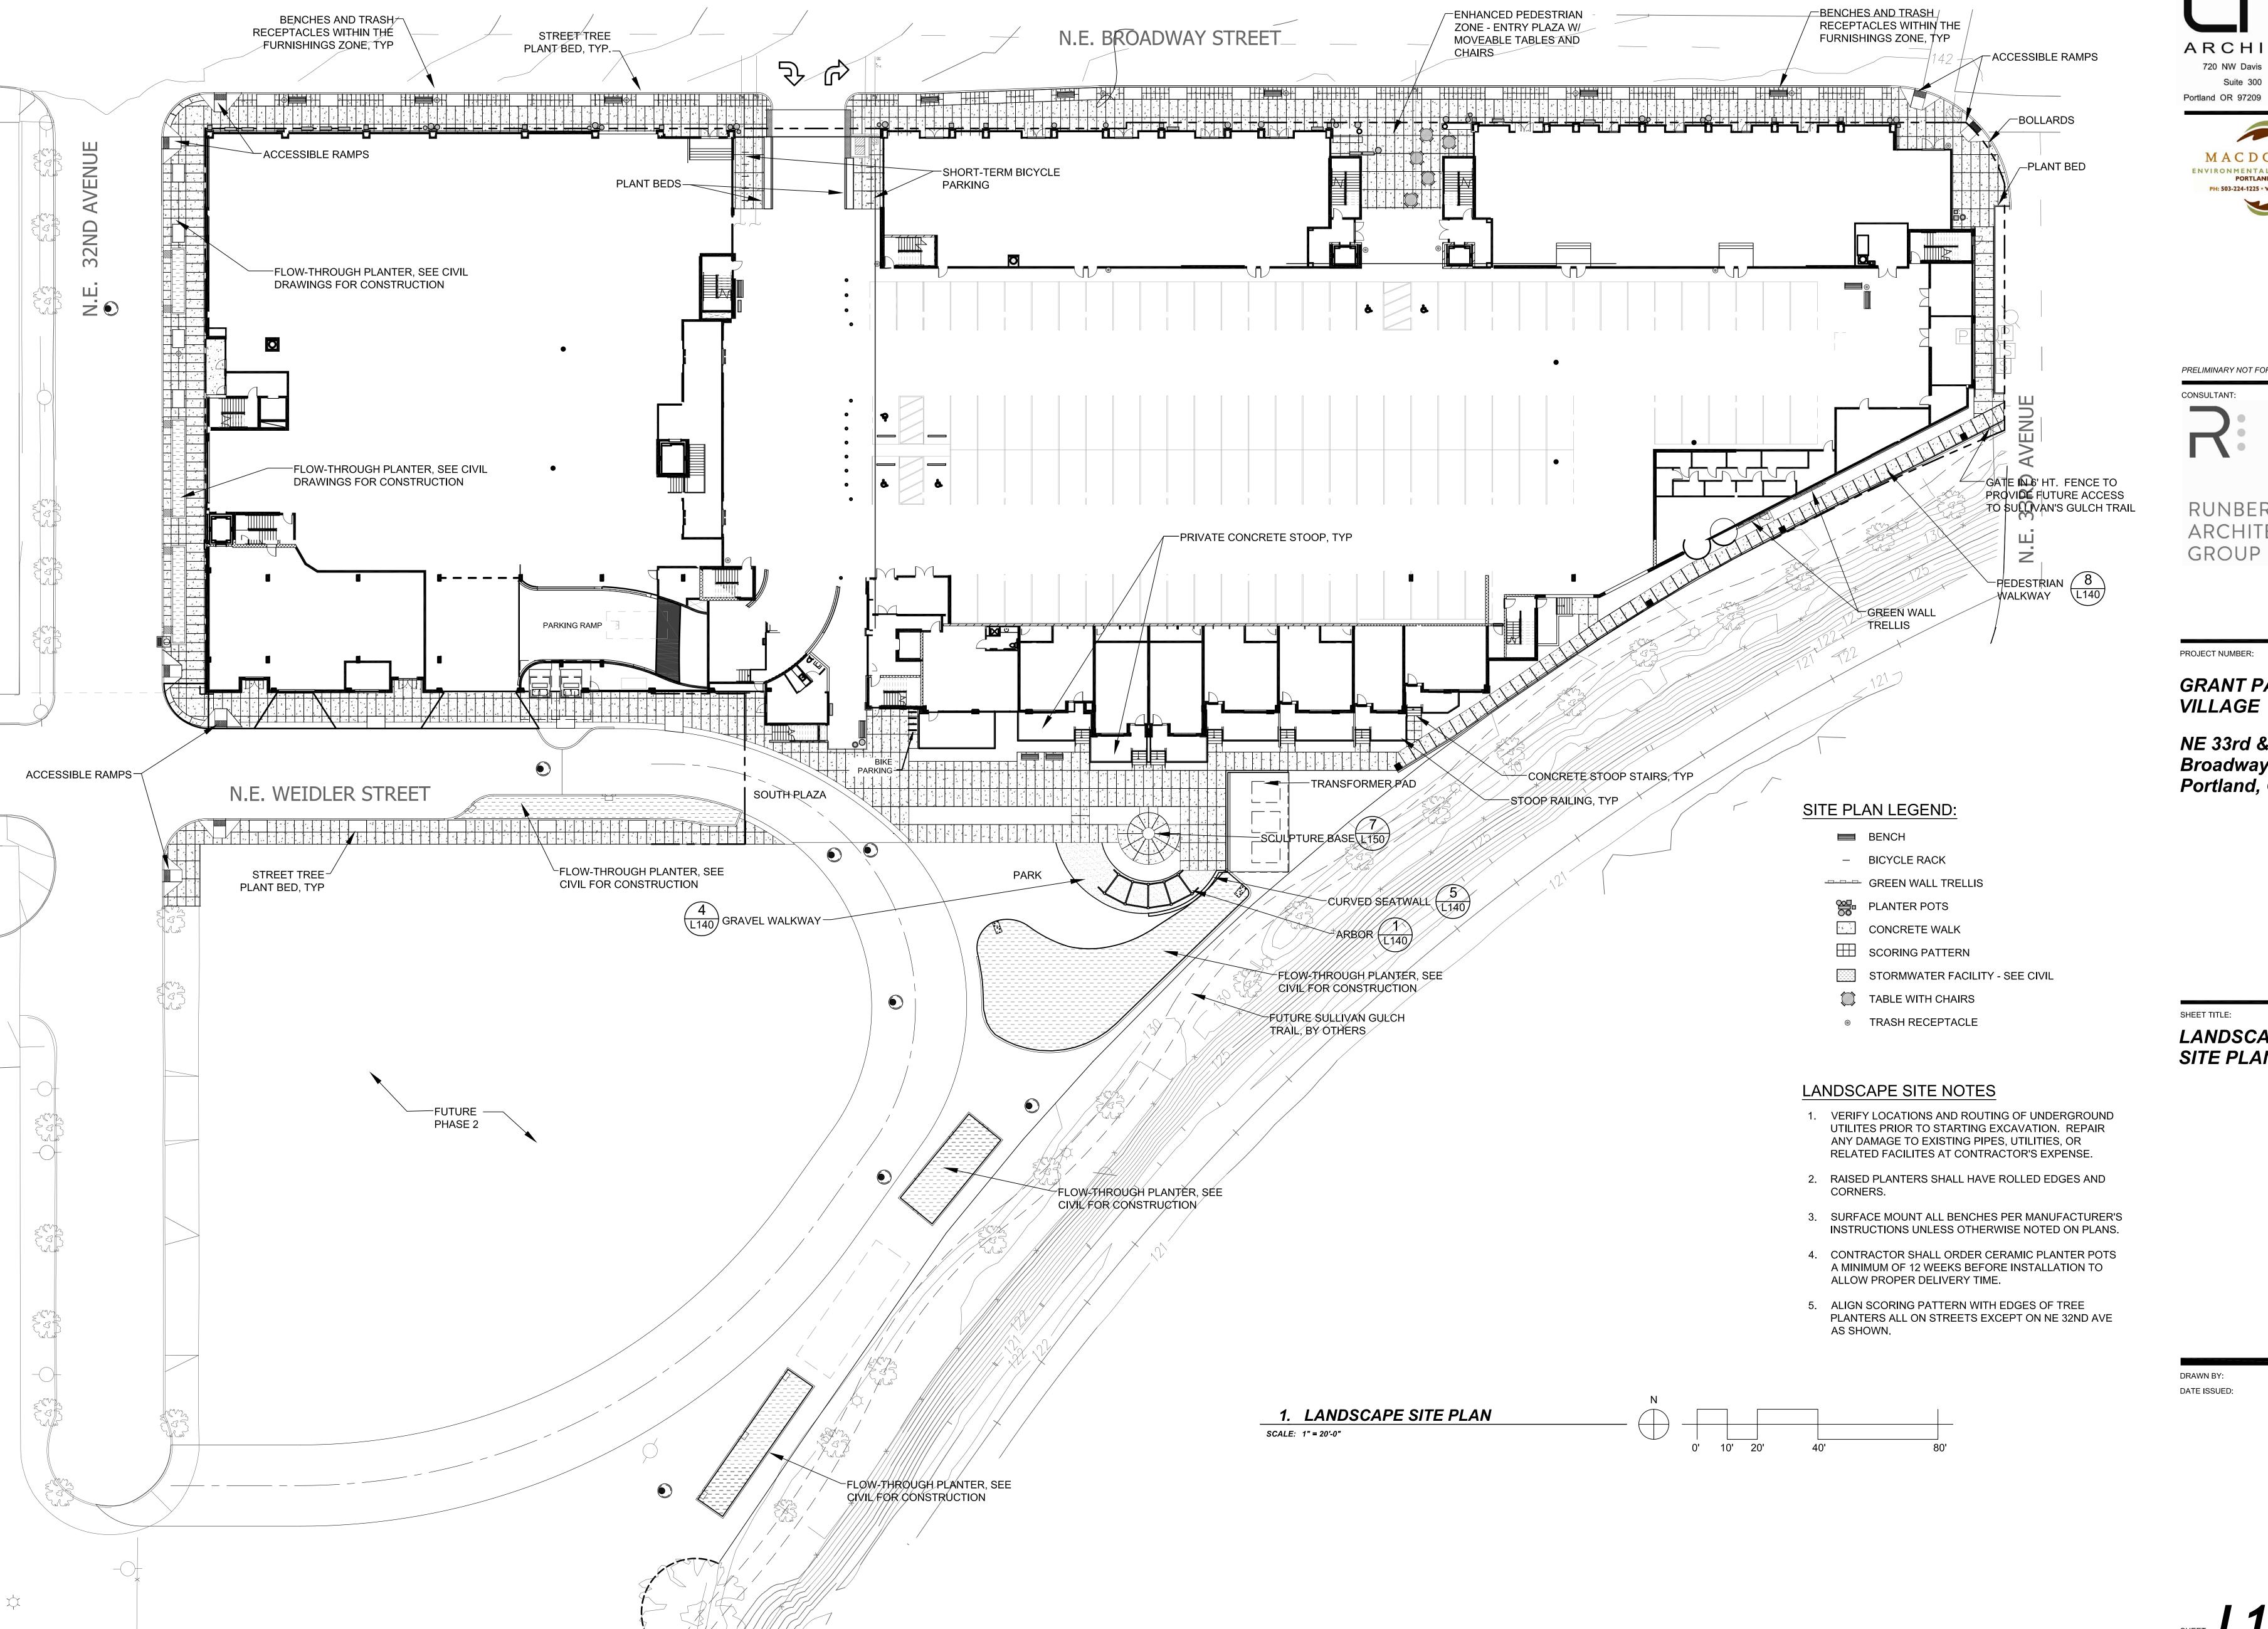GRANT PARK

NE 33rd & Broadway Portland, OR

LANDSCAPE SITE PLAN

01.14.2013



ARCHITECTS

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2:

RUNBERG ARCHITECTURE GROUP

PROJECT NUMBE

GRANT PARK VILLAGE

NE 33rd & Broadway Portland, OR

SHEET TITLE:

LANDSCAPE PLANTING PLAN

DRAWN BY: LMB/ BR
DATE ISSUED: 01.14.2013


L130

DI ANTER POT SCHEDI II E

<u> POT</u>	TYPE	NUMBER	PLANTING		PLANTS PER POT			
۷.	MONSOON PLANTER BY IAP: 48" L, 14" W, 24" H., COLOR: BRONZE	A1	P6 P	P6)	OPHIOPOGON JABURAN 'HOCF' PP#17430 Crystal Falls® Mondo Grass	9	1 GAL	CONTAINER
		A2	(P4)(P4)(P4)(P4)		CAREX DIOCHOSTACHYA 'KAGA NISHIKI' Gold Fountains Sedge	9	1 GAL.	CONTAINER
3.	TALL CONE - LG BY CHAMPA:		F2P2		ACER PALMATUM 'RED EMPEROR'	1	1.5" CAL.	SPECIMEN
	25" DIA., 35" H., COLOR: RUSTIC	B1	2202	P2	Red Emperor Japanese Maple AJUGA REPTANS 'CAITLIN'S GIANT' Caitlin's Giant Carpet Bugle	6	1 GAL	CONTAINER
)000 ₀	COTINUS COGGYGRIA VELVET CLOAK'	1	7 GAL.	TREE FORM
		B2	E 00)000 6 5	Velvet Cloak Smoke Bush HEUCHERA AMERICANA 'GREEN SPICE' Green Spice Coral Bells	7	1 GAL	CONTAINER
	TALL CONE - MED BY CHAMPA:	(A)		₩ R1	RHODODENDRON 'WOJNAR'S PURPLE'	1	30-36"	CONTAINER
	21" DIA. 29' H., COLOR: RUSTIC	C1 💥	(5)P)/	W	Wojnar's Purple Rhododendron ARENARIA BALEARICA Corsican Sandwort	5	1 GAL	CONTAINER
		(A	37	S2)	HYDRANGEA ASPERA 'PLUM PASSION'	1	5 GAL	CONTAINER
		C2 🖎		P5)	Plum Passion® Hydrangea ARENARIA BALEARICA Corsican Sandwort	5	1 GAL	CONTAINER
	TALL CONE - SML BY CHAMPA: 17" DIA. 25" H., COLOR: RUSTIC	D1	(F	P3)	BERGENIA CORDIFOLIA 'WINTERGLUT' Winterglow Bergenia	3	1 GAL	CONTAINER
	PINNACLE - LG BY CHAMPA:	X	TP)		CUPRESSUS SEMPERVIRENS 'GLAUCA'	1	5'-6' HT.	B&B
	19" SQ. 36" H., COLOR: RUSTIC	E1 ((F	P1)	Blue Italian Cypress HEUCHERA 'SANTA ANA CARDINAL' Santa Ana Cardinal Coral Bells	4	1 GAL.	CONTAINER
					CHAMACYPARIS OBTUSA 'GRACILIS'	1	5-6' HT.	B&B
		E2 (A1	Slender Hinoki Cypress AJUGA x 'TOFFEE CHIP' PP18805 Toffee Chip Carpet Bugle	4	1 GAL.	CONTAINER
	PINNACLE - SML BY CHAMPA: 15" SQ. 32" H., COLOR: RUSTIC	F1	(F	P4)	CAREX DIOCHOSTACHYA 'KAGA NISHIKI' Gold Fountains Sedge	3	1 GAL.	CONTAINER
€.	CANA - LG BY CHAMPA: 24" DIA. 18" H., COLOR: BLACK	G1	SI	S1	LEUCOTHOE FOUNTANESIANA 'ZEBLID' Scarletta® Fetterbush	2 G/	AL CON	NTAINER
		G2			Seasonal Color - TBD			

PLANTER POTS AND PLANT SYMBOLS IN PLANTER POT SCHEDULE ARE SHOWN AT $\frac{1}{4}$ " = 1'-0" SCALE FOR CLARITY

PLANT LEGEND - SITE & LEVEL 1 PLANTERS

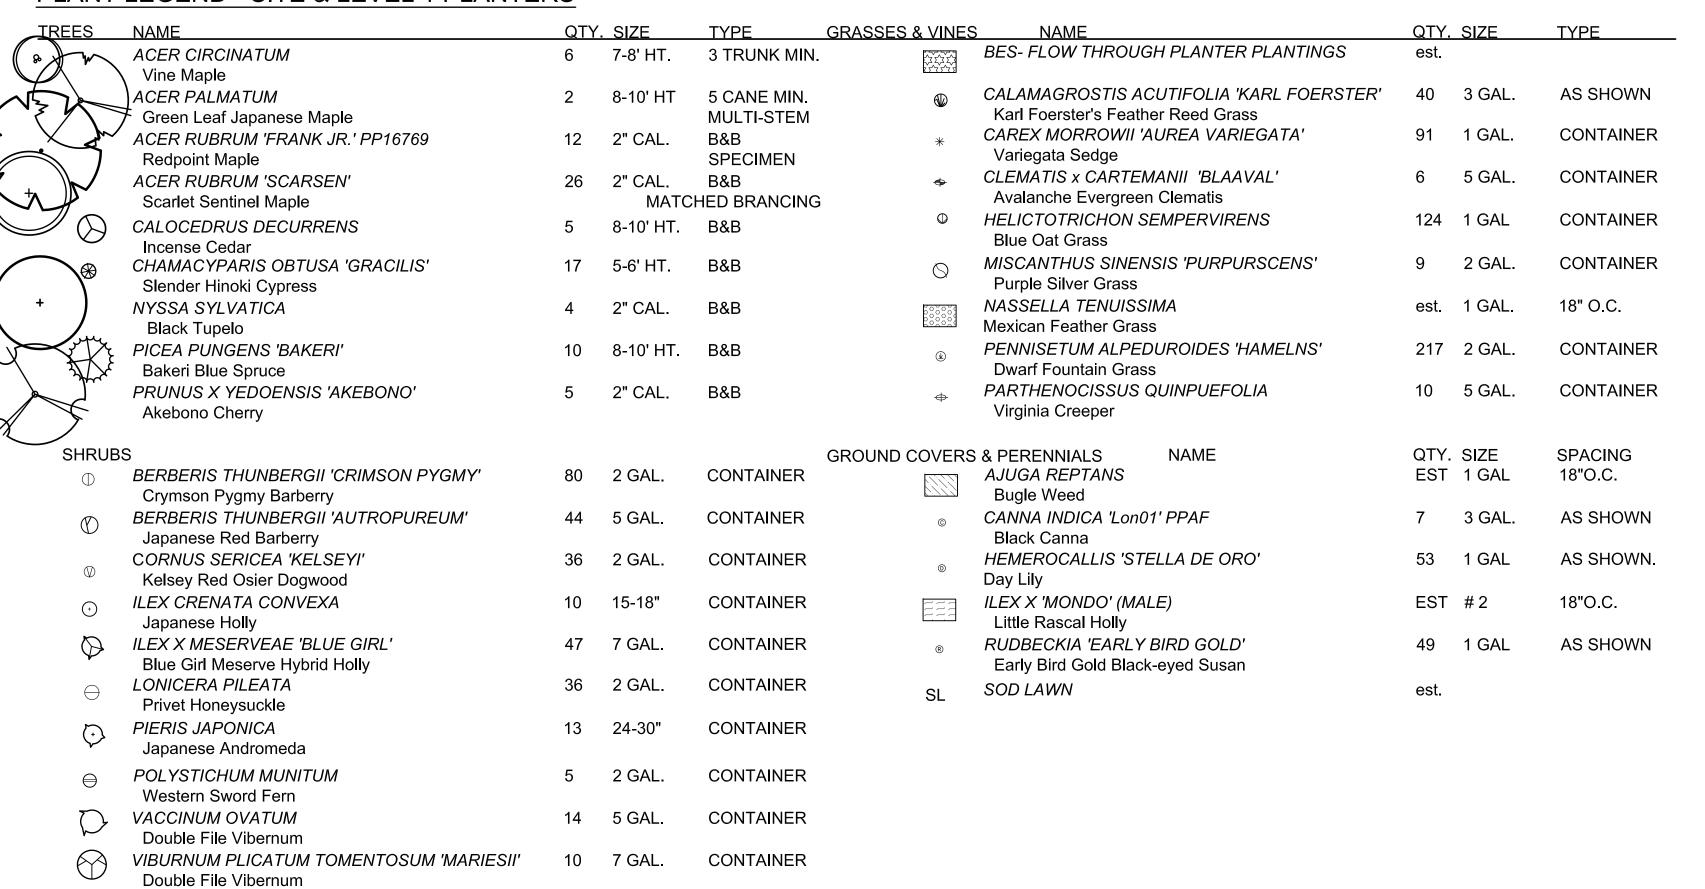





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CONSULTANT:

RUNBERG ARCHITECTURE GROUP

PROJECT NUMBER:

GRANT PARK VILLAGE

NE 33rd & Broadway Portland, OR

SHEET TITLE:

PLANTING


DETAILS


DRAWN BY:

DATE ISSUED:

GROUND LEVEL -

PLANT LEGEND &

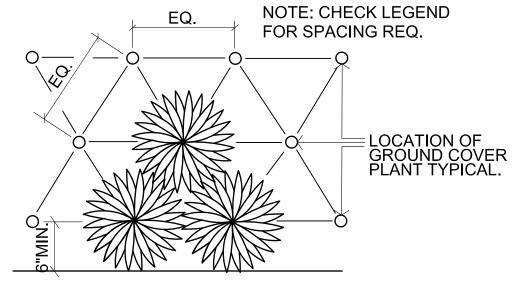


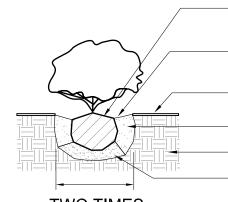

REMOVE BURLAP FROM TOP 1/3 OF ROOT BALL 2" DEEP RAINWATER COLLECTION BASIN MULCH TO GRADE. 2" BARK MULCH WHERE SPECIFIED PREPARED PLANTING SOIL EXISTING SOIL COMPACTED PLANTING SOIL

TWO TIMES ROOTBALL SIZE


2. SHRUB PLANTING DETAIL, TYP SCALE: NTS

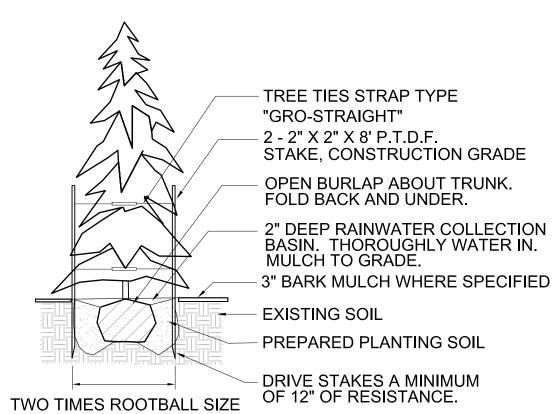

1. GROUNDCOVER PLANTING DETAIL, TYP

SCALE: NTS

3. EVERGREEN TREE PLANTING DETAIL SCALE: NTS

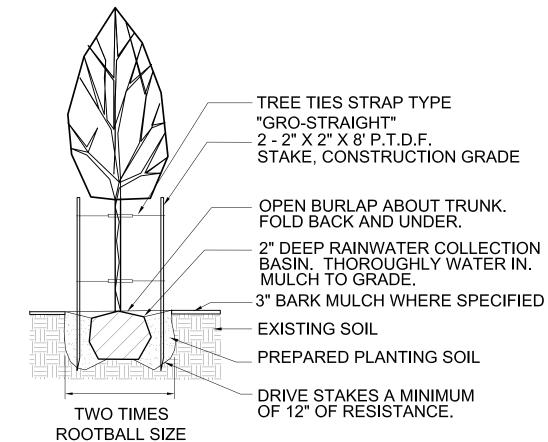



4. DECIDUOUS TREE PLANTING DETAIL, TYP SCALE: NTS




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01.14.2013



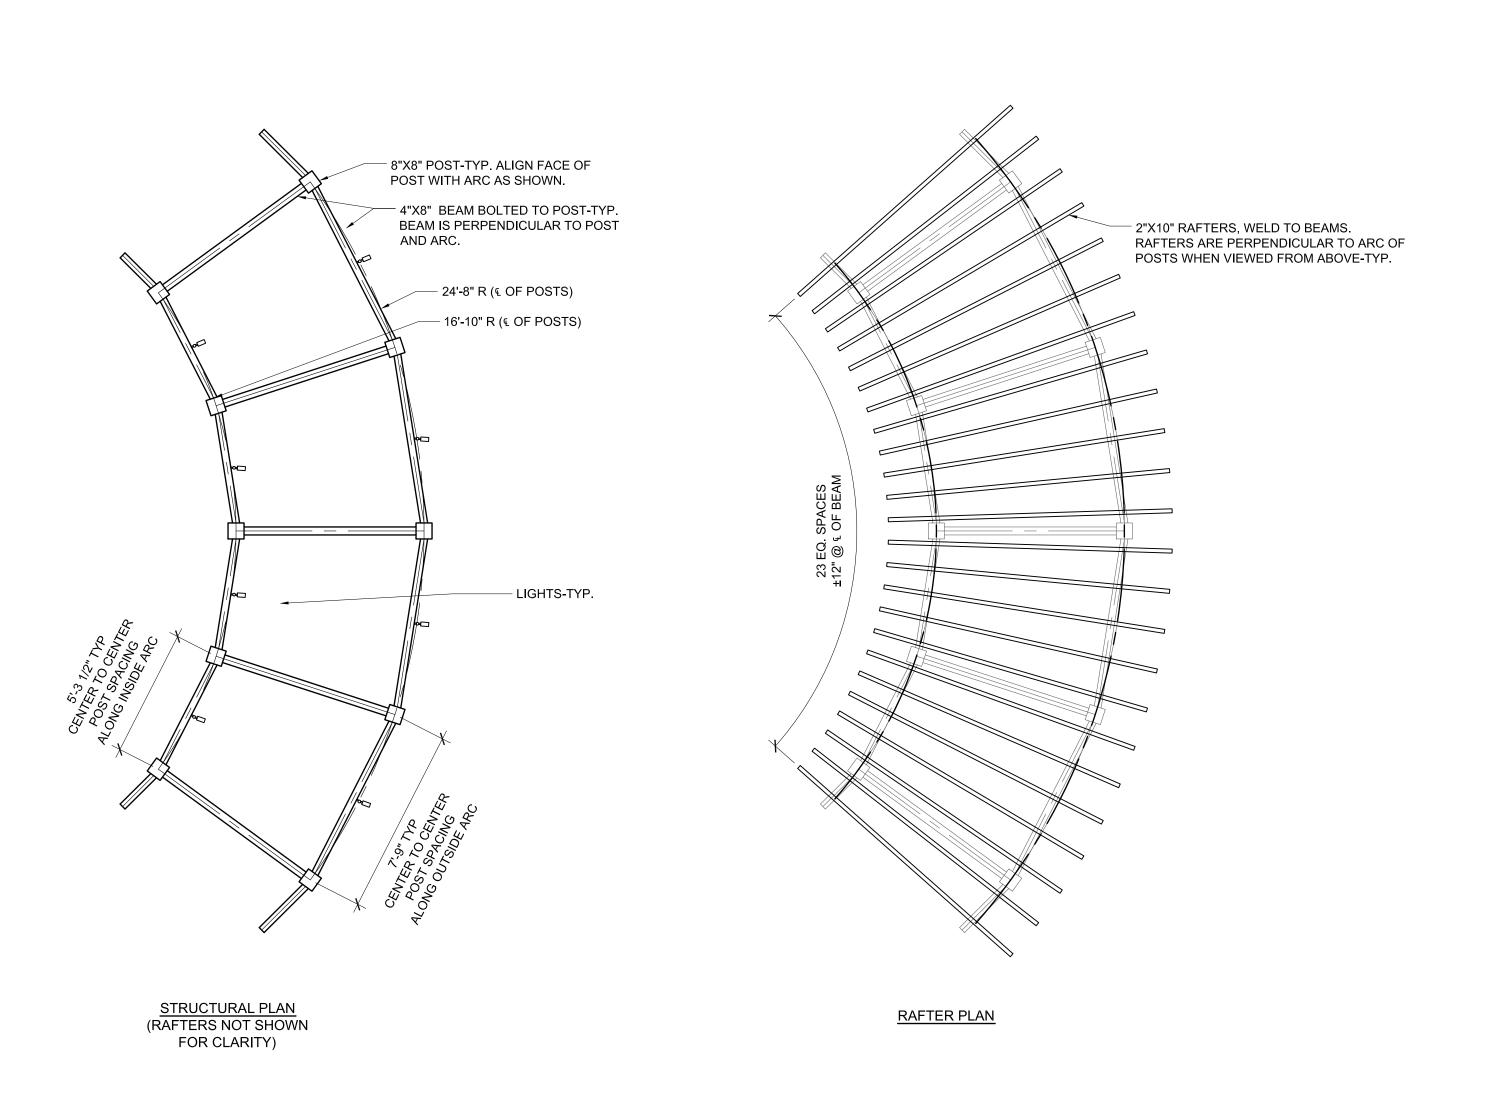

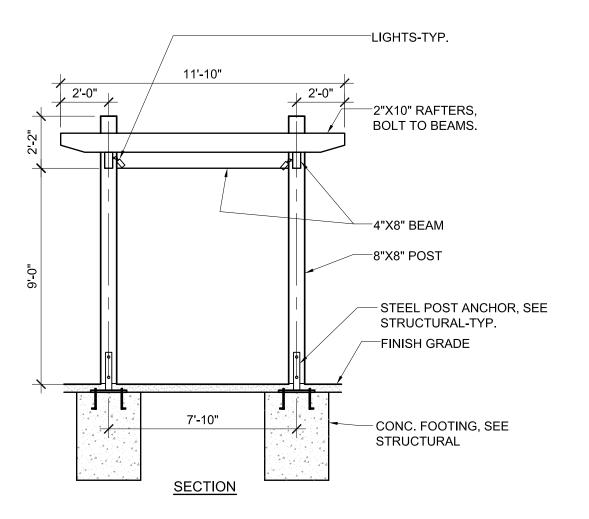- POSTS, BEAMS AND RAFTERS SHALL BE CEDAR.
 MOUNT LIGHTS ON INSIDE FACES OF BEAMS AS SHOWN.
- 3. ALL STEEL COMPONENTS SHALL BE HOT-DIP GALVANIZED AND POWDERCOATED
- 4. ALL STEEL BOLTS AND FASTENERS SHALL BE HOT-DIP GALVANIZED.
- 5. NUMBER OF LIGHTS SHOWN IS APPROXIMATE. ACTUAL NUMBER OF LIGHTS MAY VARY BASED ON FIXTURE CHOSEN AND PHOTOMETRIC DATA.

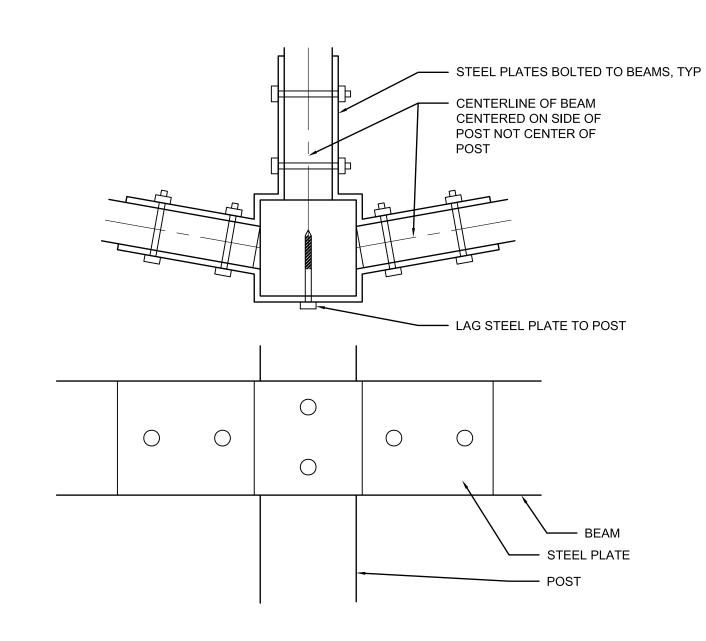

1. ARBOR - ARNTSON YARD SCALE: 1/4" = 1'-0"


____3. CONCRETE WALK

JUNCTION BOX WITH —

LOCKABLE COVER, CENTER

SCALE: NTS

- 1) SEE LAYOUT PLANS FOR SCORE JOINT SPACING AND SCORE JOINT TYPE (TOOLED).
- 2) INSTALL EXPANSION JOINTS WHERE NEW PAVING MEETS EXISTING PAVING, WALLS, CURBS, FOUNDATIONS, OR OTHER FIXED OBJECTS, AND CHANGES IN WALK DIRECTIONS.

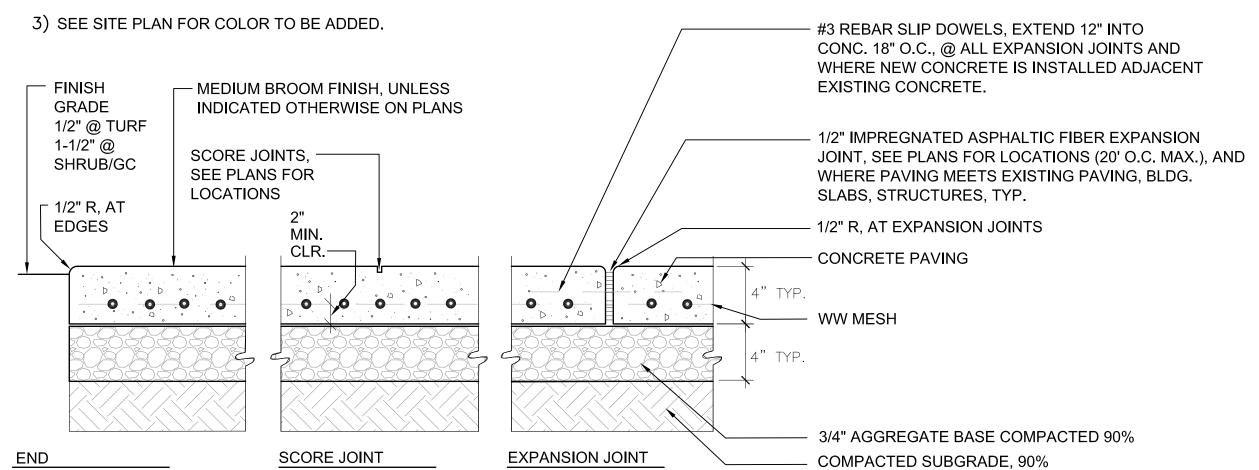

— CONCRETE SCULPTURE BASE

EMBEDDED CAN LIGHTS (1 OF 4), EVENLY


DRAIN AWAY FROM CENTER AT 1/4" PER

SPACE ON CONSTANT RADIUS


TOP OF SCULPTURE BASE, SLOPE TO

/ EXPANSION JOINT

— ELECTRICAL CONDUIT

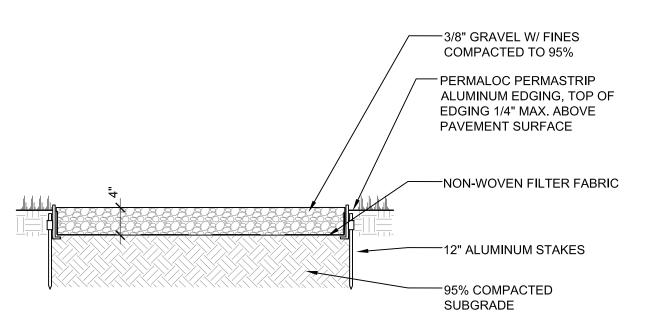

SCALE: 3/4" = 1'-0"

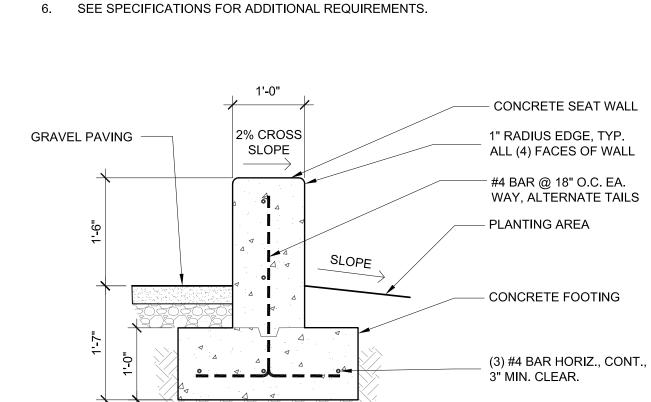

2. ARBOR POST & BEAM CONNECTION

SEE GRADING PLAN FOR TOP AND BOTTOM OF WALL ELEVATIONS.

INTEGRAL COLOR TO BE SELECTED BY LANDSCAPE ARCHITECT.

PROVIDE SMOOTH SACKED FINISH TO ALL EXPOSED WALL SURFACES.

PROVIDE TWO VERTICAL EXPANSION JOINTS IN WALL EVENLY SPACED FROM ENDS OF WALL.

TOP OF WALL ELEVATION TO REMAIN CONSTANT. DO NOT SLOPE TOP OF WALL WITH GRADE.

SCALE: 1 1/2"=1'-0"

3/4" AGGREGATE BASE 2'-6" COMPACTED 90% SCALE: 3/4" = 1'-0"





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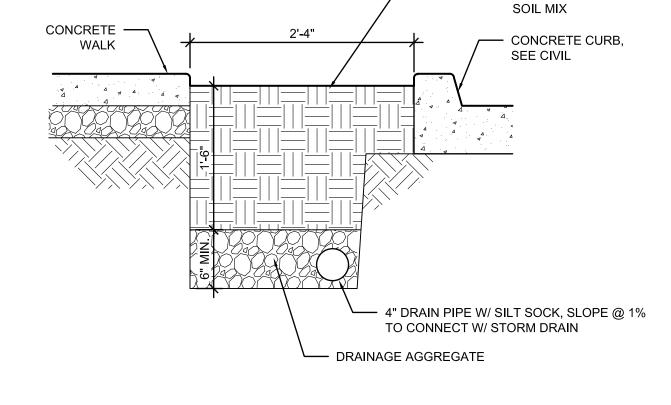
PROJECT NUMBER:

GRANT PARK VILLAGE

NE 33rd & Broadway Portland, OR

SHEET TITLE:

GROUND LEVEL SITE DETAILS



6. AT GRADE PLANTER

SCALE: 1" = 1'-0"


— PLANTING BED

DRAWN BY: DATE ISSUED: 01.14.2013

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7. CONCRETE SCULPTURE BASE

COMPACTED OR
UNDISTURBED SUBGRADE



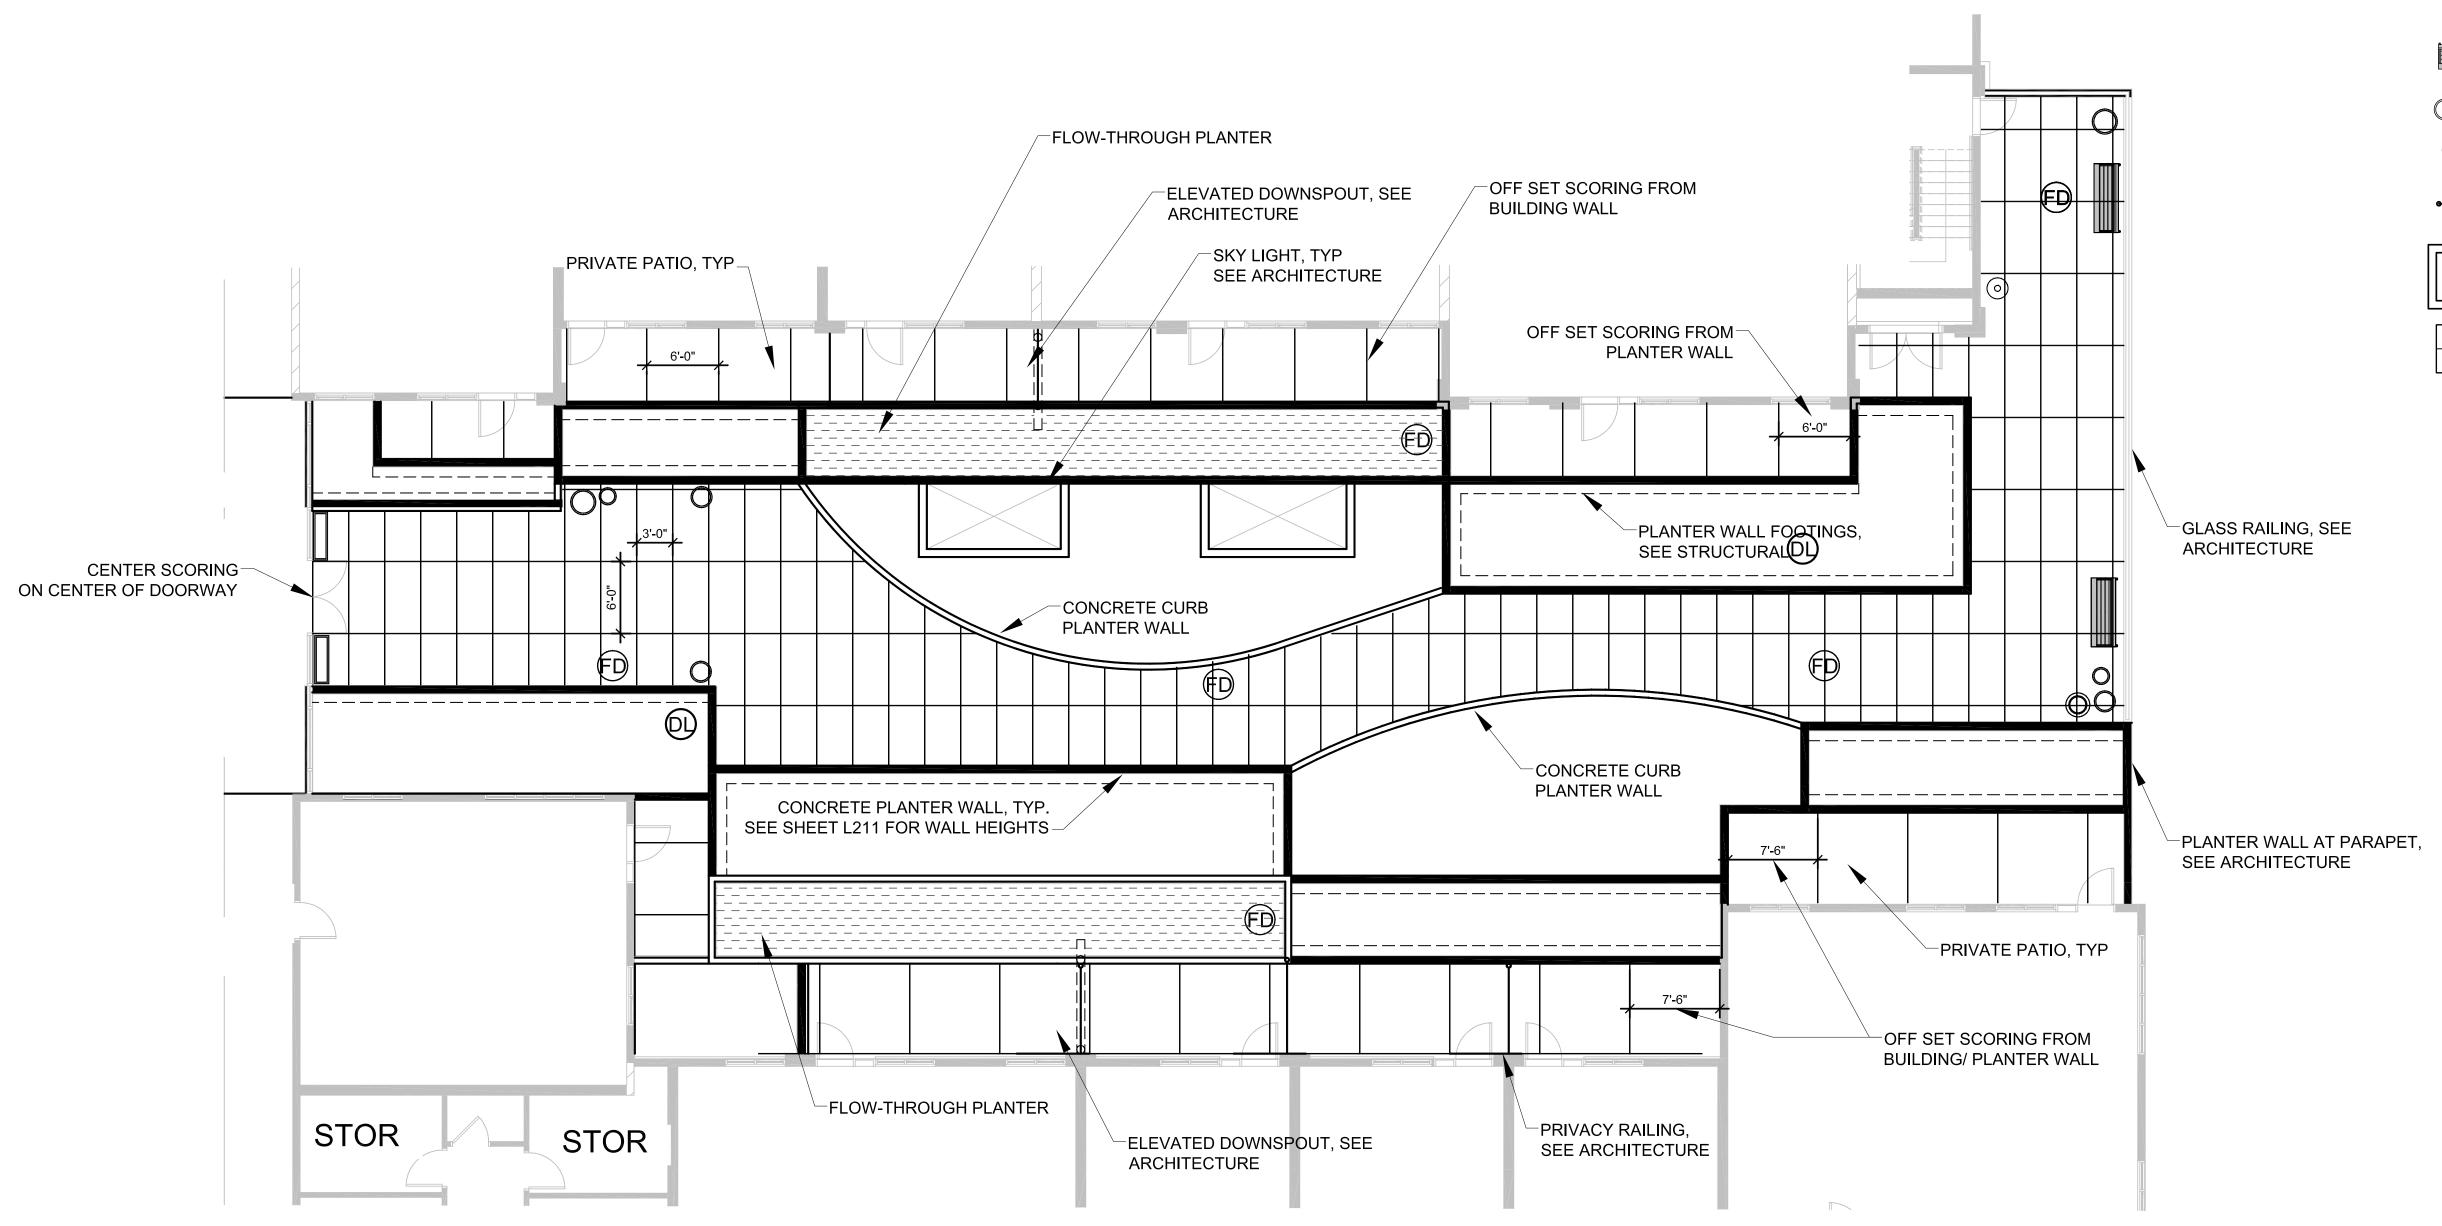

SITE PLAN LEGEND:

BENCH, BY OWNER



PLANTER POTS




PRIVACY RAILING, SEE ARCHITECTURE



RAISED PLANTER, TYP

SCORE PATTERN

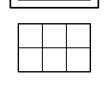

TRASH RECEPTACLE, BY OWNER

1. CONTRACTOR TO PROTECT INTEGRITY OF ROOF ASSEMBLY. REPAIR ANY DAMAGE TO EXISTING ROOF ASSEMBLY, ROOF DRAINS, OR RELATED FACILITIES AT

CONSTRUCTION NOTES:

CONTRACTOR'S EXPENSE. 2. CONTRACTOR TO COORDINATE WORK WITH RELATED

3. SEE DETAILS AND SPECIFICATIONS FOR ADDITIONAL REQUIREMENTS.





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PROJECT NUMBER:

GRANT PARK **VILLAGE**


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SHEET TITLE:

WEST TERRACE -LANDSCAPE SITE PLAN

DRAWN BY: DATE ISSUED:

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EYE BOLT


SCALE: 1/2"= 1'- 0"

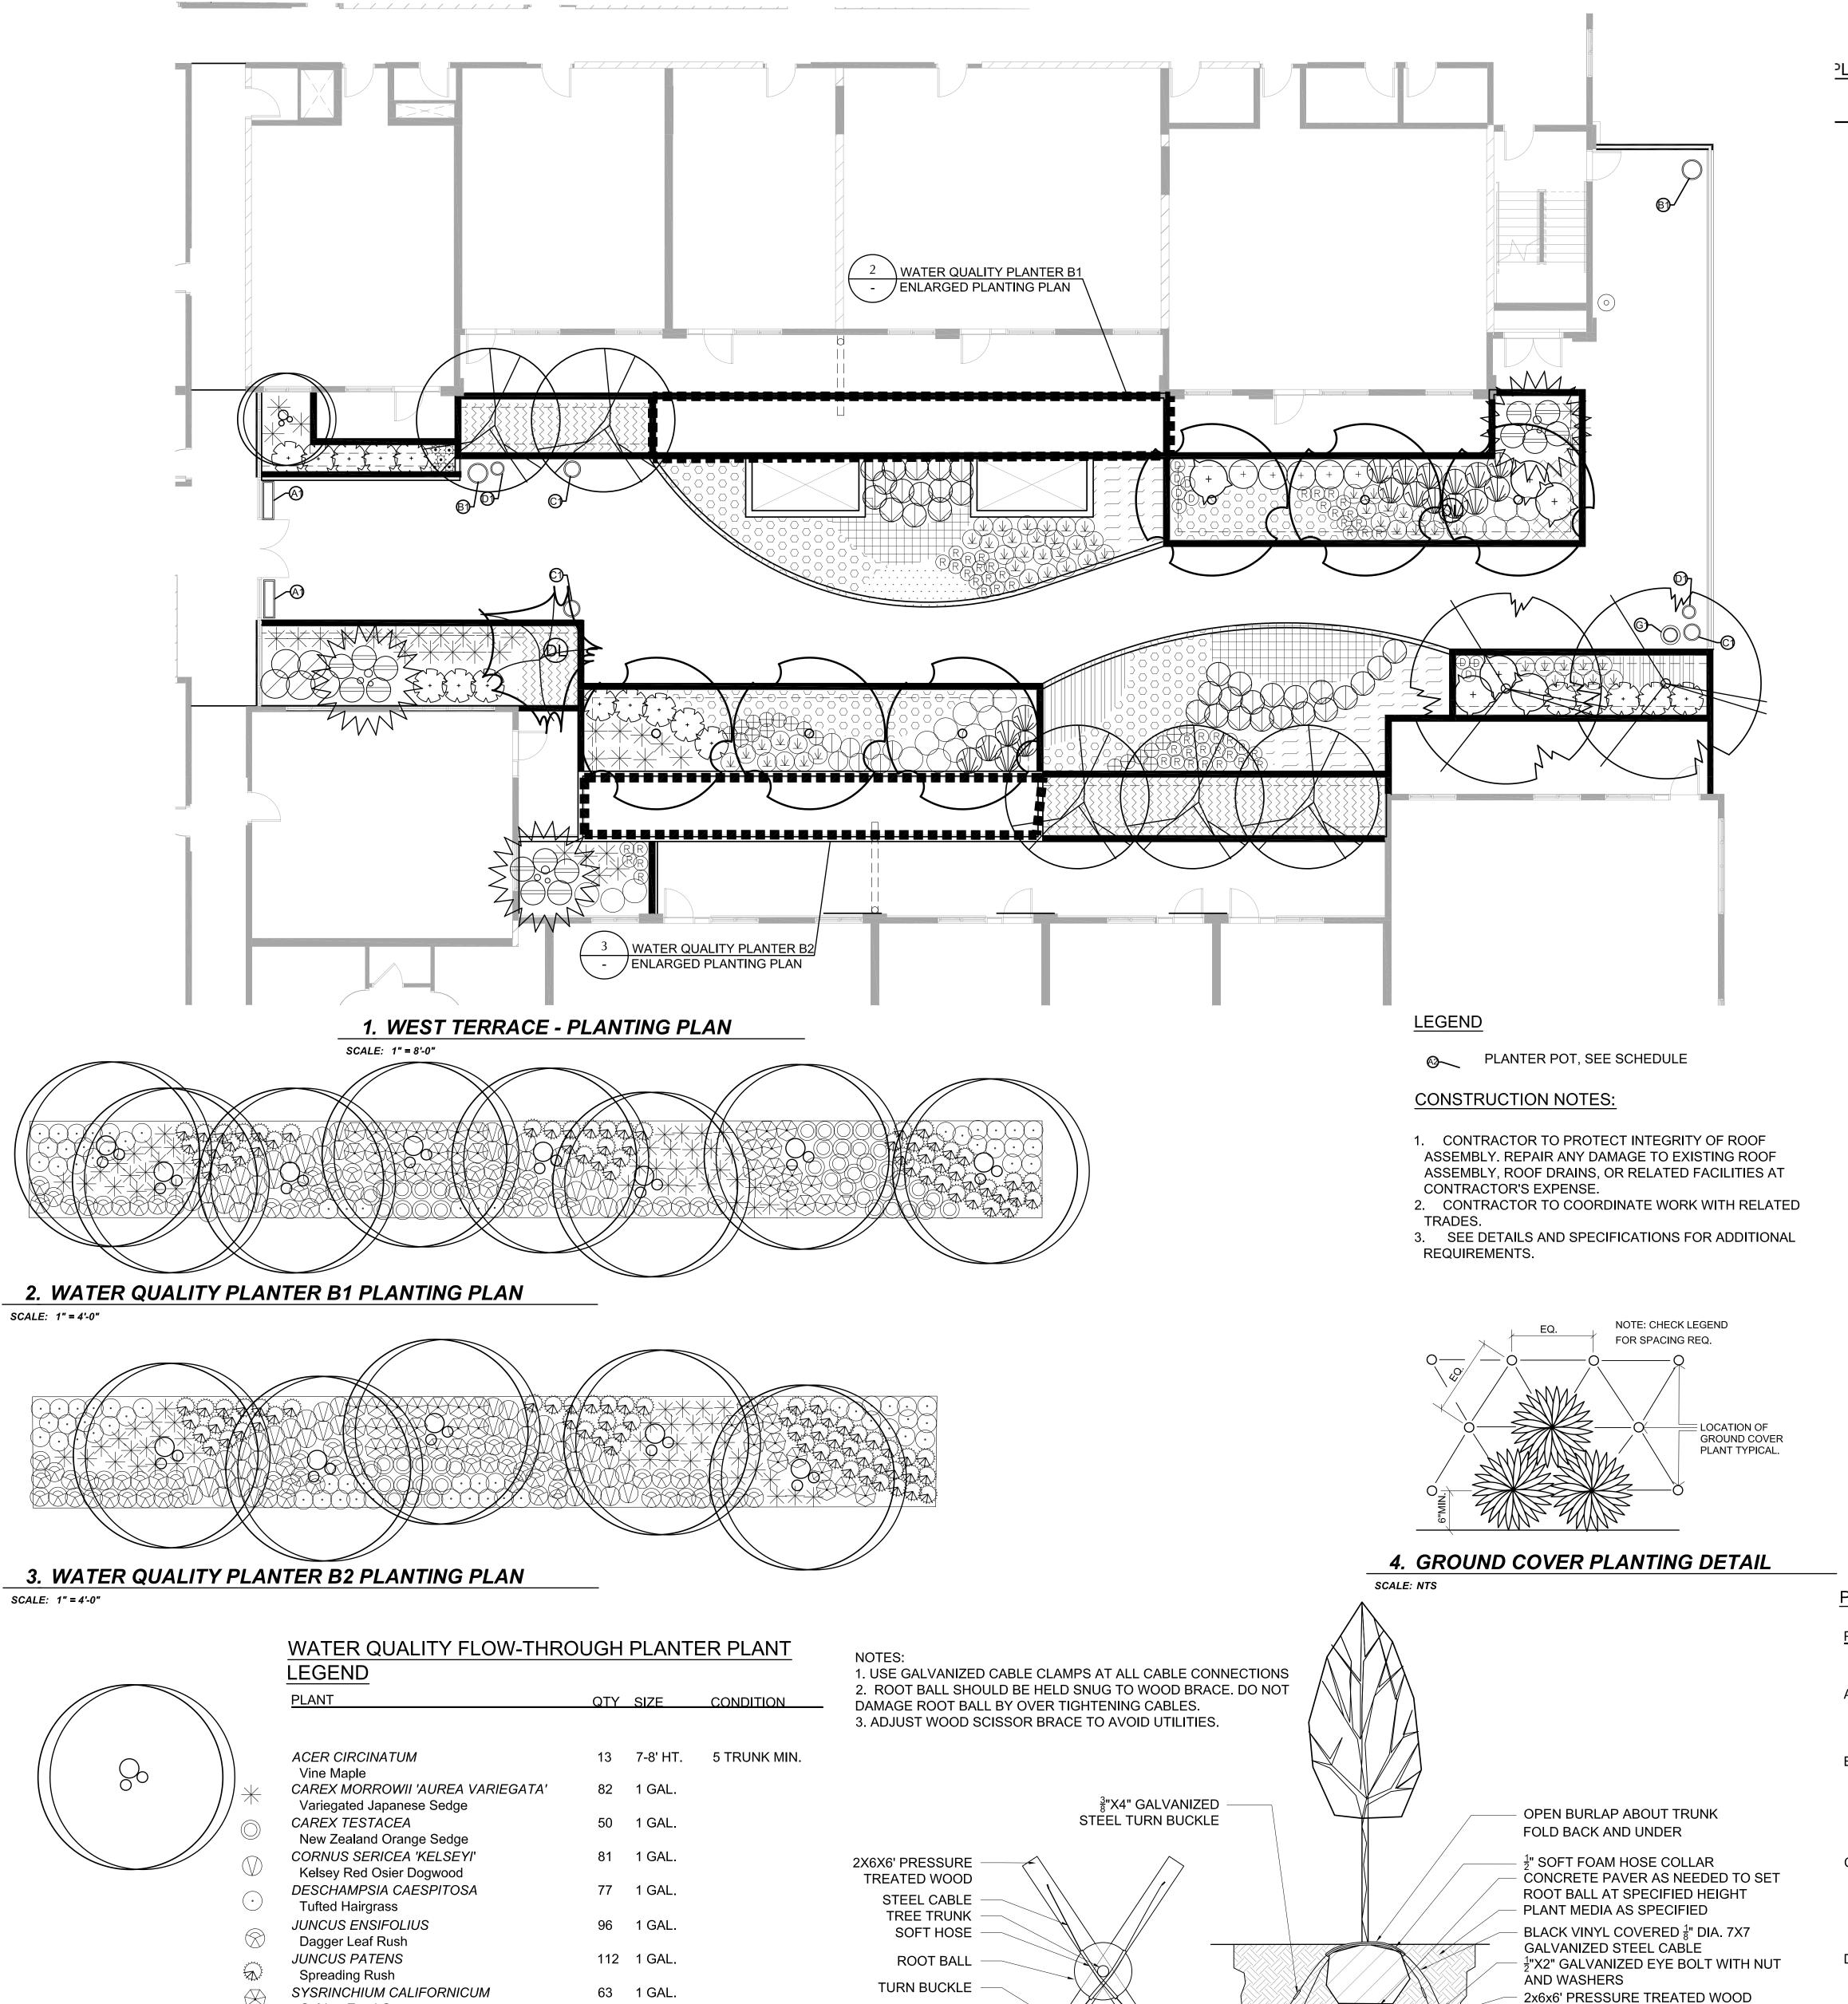3'-0" MIN.

5. ROOFTOP TREE PLANTING W ANCHOR DETAIL

Golden-Eyed Grass

PLANT LEGEND - WEST TERRACE ONLY

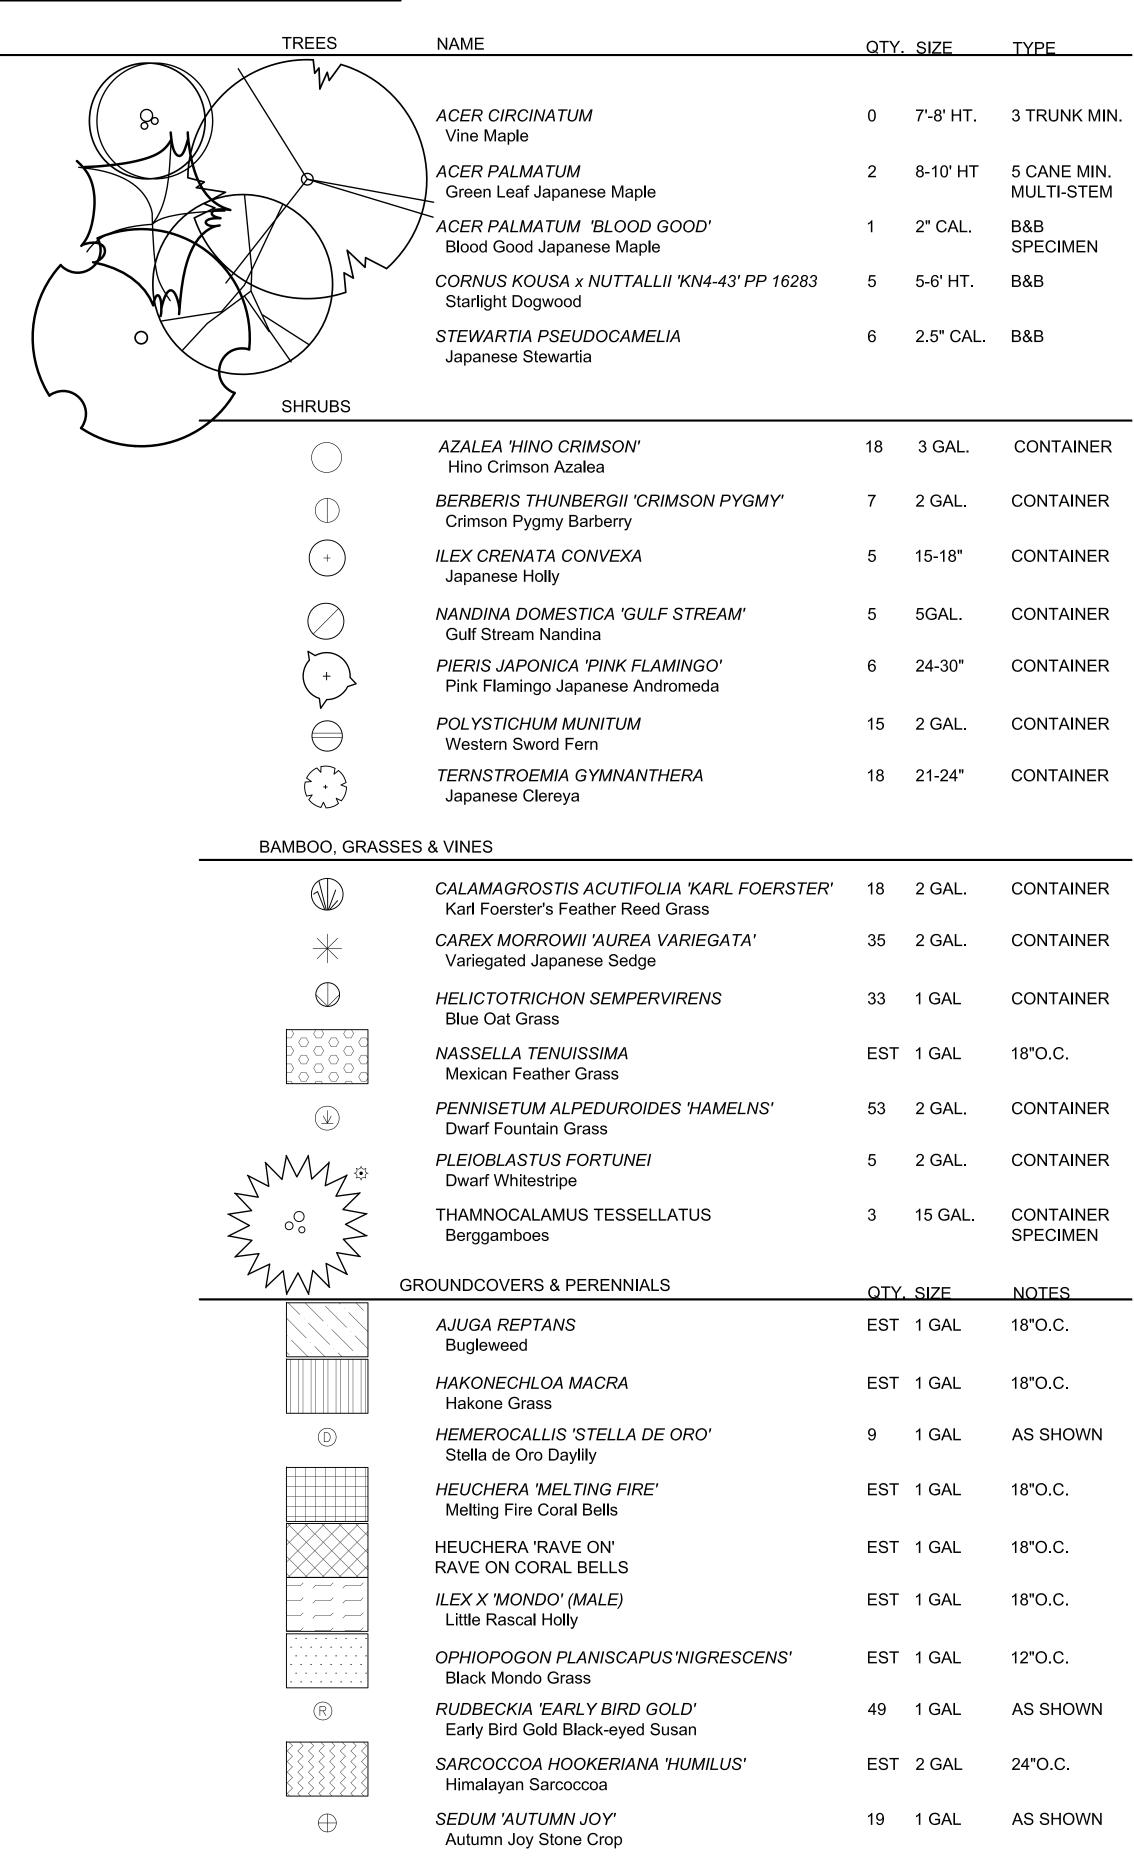

2x6x6' PRESSURE TREATED WOOD

SPACER ATTACH WITH GALVANIZED NAILS

<u>PO</u>	T TYPE	NUMBER	PLANTING		PLANTS PER POT		
A.	MONSOON PLANTER BY IAP: 48" L, 14" W, 24" H., COLOR: BRONZE	A1	P4 P4 P4 P4 P4 P4	(P4)	CAREX DIOCHOSTACHYA 'KAGA NISHIKI' Gold Fountains Sedge		
В.	TALL CONE - LG BY CHAMPA: 25" DIA., 35" H., COLOR: RUSTIC	B1		72 88 72 88 700009	COTINUS COGGYGRIA VELVET CLOAK' Velvet Cloak Smoke Bush HEUCHERA AMERICANA 'GREEN SPICE' Green Spice Coral Bells		
C.	TALL CONE - MED BY CHAMPA: 21" DIA. 29' H., COLOR: RUSTIC	C1		(S4) (H3)	ILEX CRENATA 'SKY PENCIL' Sky Pencil Japanese Holly HEUCHERA VILLOSA 'CITRONELLE' PP1793 Citronelle Coral Bells		
D.	TALL CONE - SML BY CHAMPA: 17" DIA. 25" H., COLOR: RUSTIC	D1	(FG) FG) PG	(P6)	CAREX ALBULA Frosty Curls Sedge		
G.	CANA - LG BY CHAMPA:		(Pg)	(P9)	SEDUM 'BLACK BEAUTY'		

G1

Black Beauty® Stonecrop

PLANTER POTS AND PLANT SYMBOLS IN PLANTER POT SCHEDULE ARE SHOWN AT $\frac{1}{4}$ " = 1'-0" SCALE FOR CLARITY

24" DIA. 18" H., COLOR: BLACK



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CONSULTANT:

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PROJECT NUMBER: 211346 / 322105


GRANT PARK VILLAGE

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SHEET TITLE:


WEST TERRACE -**PLANTING PLAN**

DATE ISSUED:

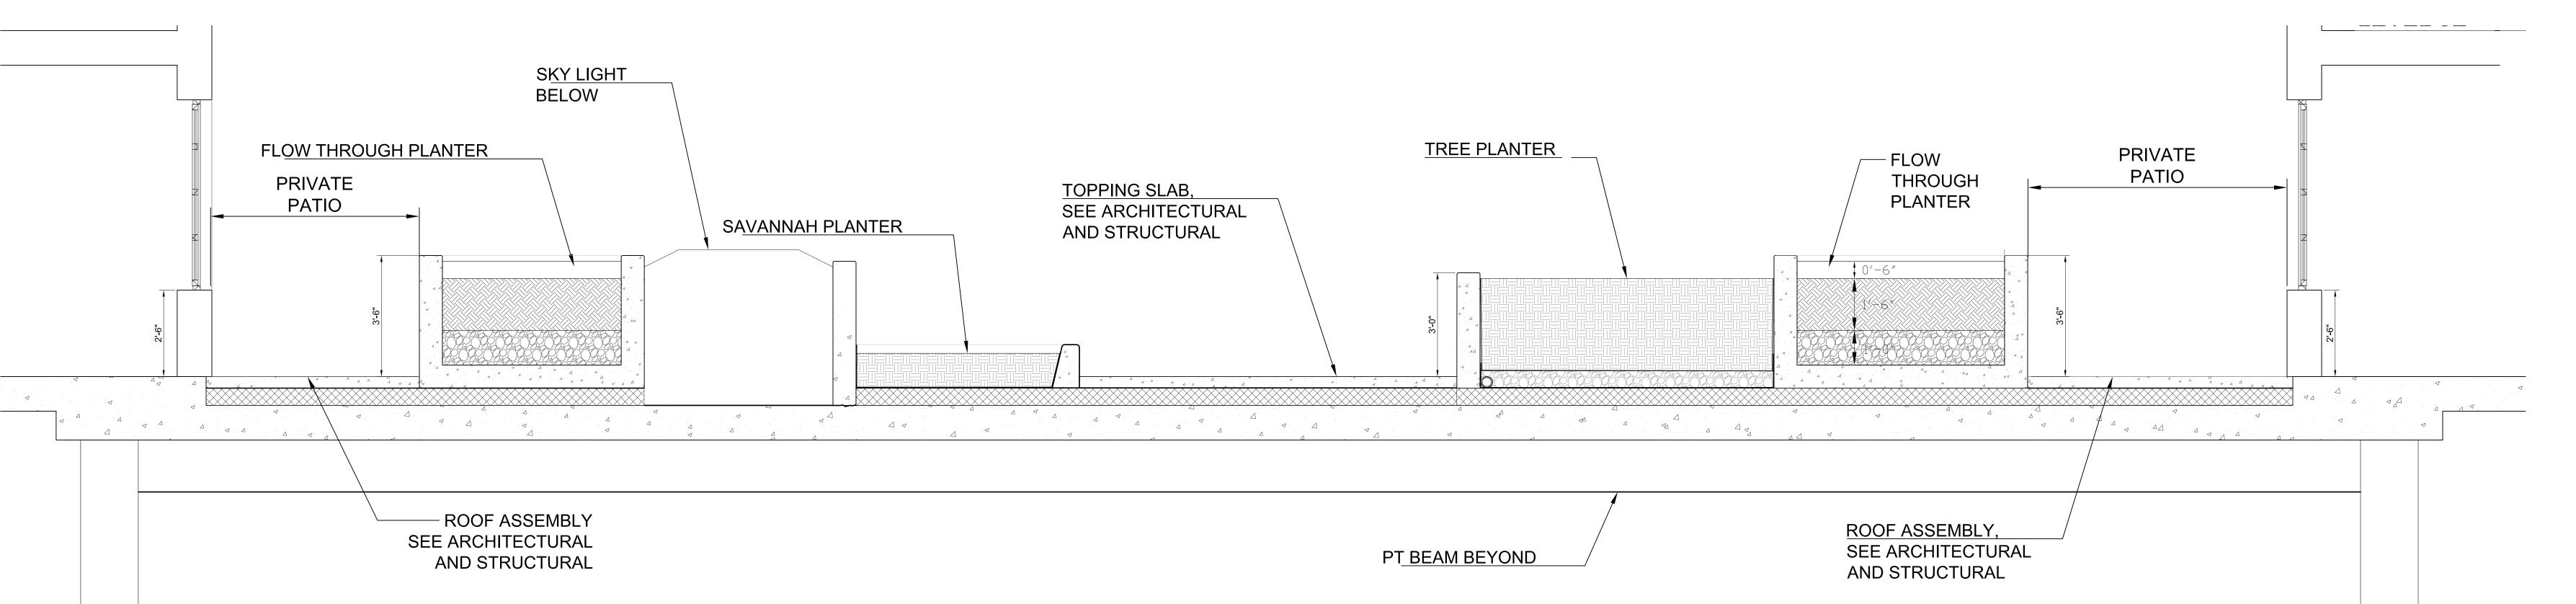

1. WEST TERRACE - NS SECTION LOOKING EAST

SCALE: 1/2" = 1'-0"

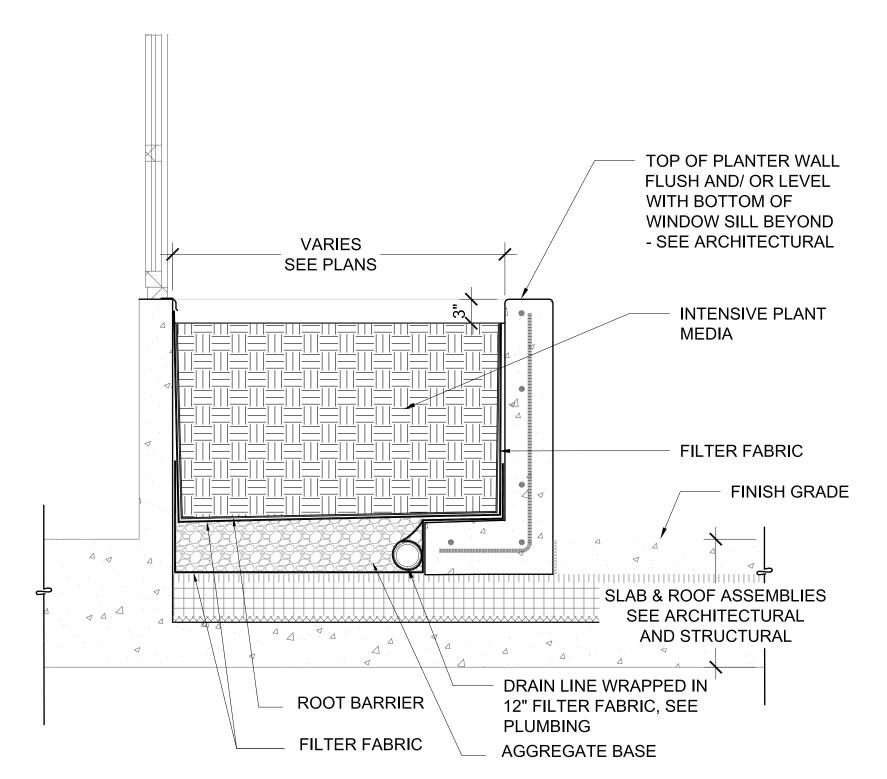

2. WEST TERRACE PLANTER AT WINDOW, TYP

SCALE: 3/4" = 1'-0"

ARCHITECTS

720 NW Davis 503.221.1121 Suite 300 503 221.2077 Portland OR 97209 www.lrsarchitects.com



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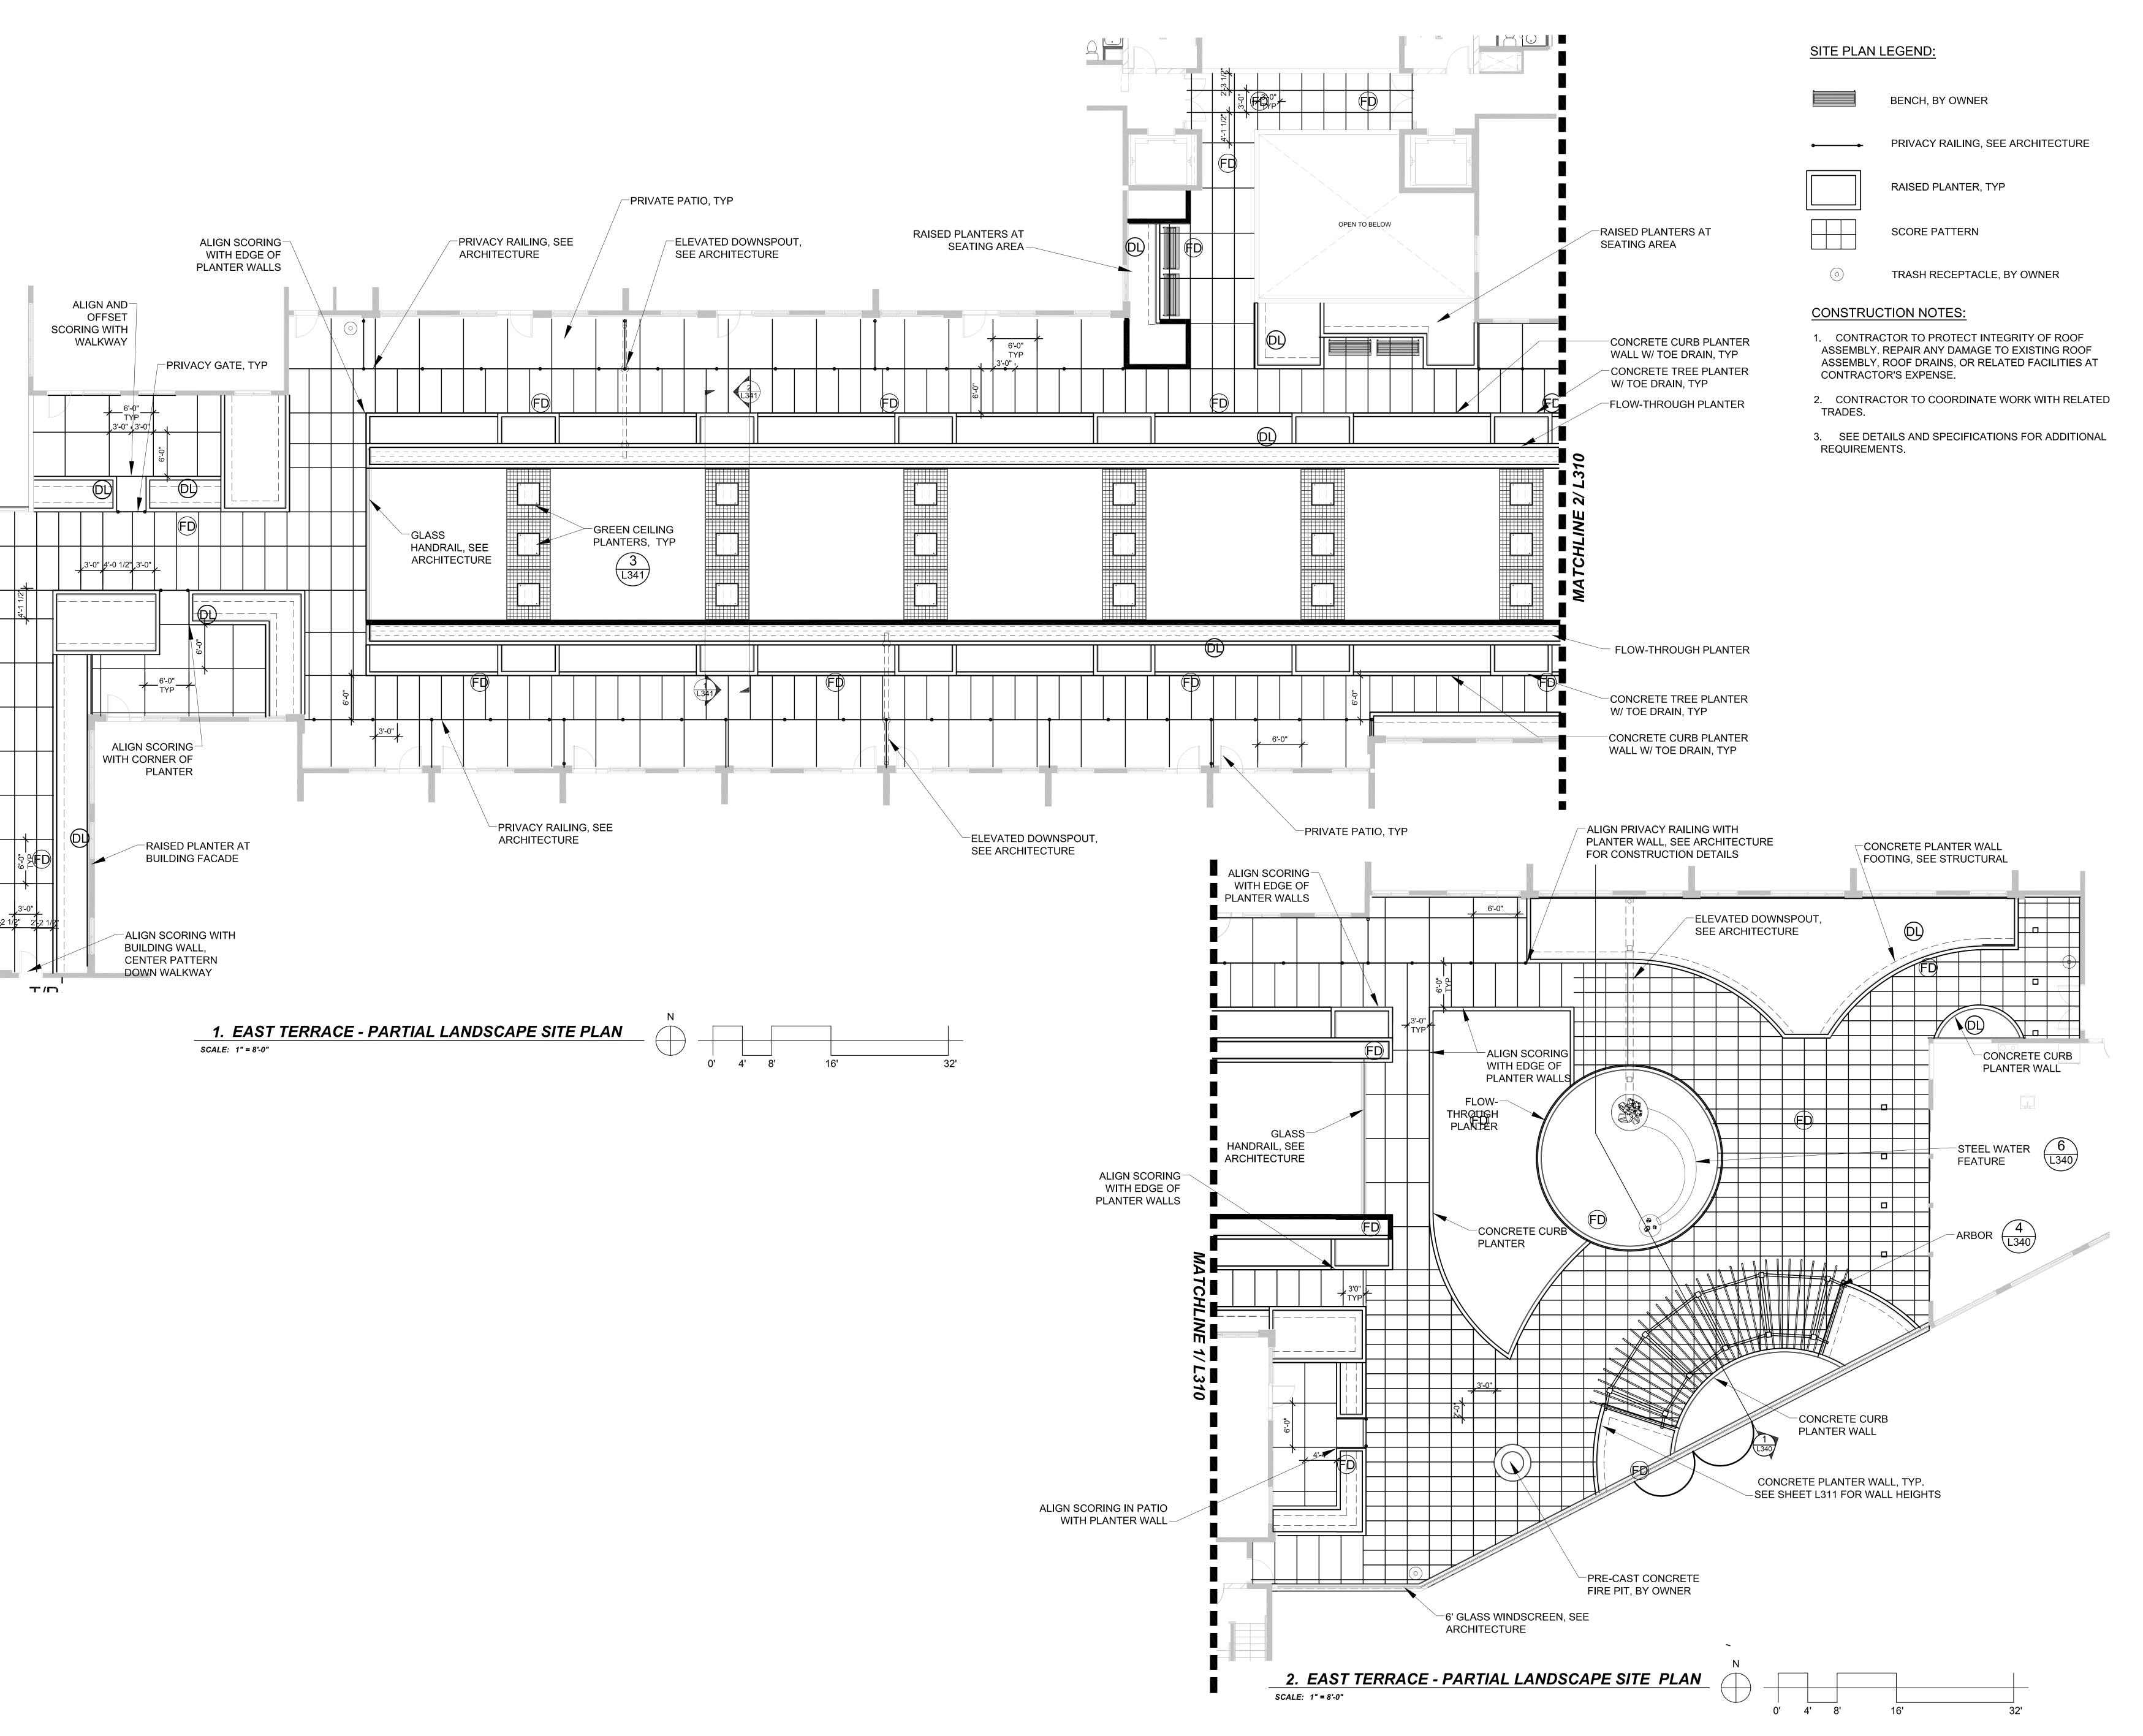
NE 33rd & Broadway Portland, OR

SHEET TITLE:

WEST TERRACE -SECTIONS AND DETAILS

DRAWN BY: LMB/ BR
DATE ISSUED: 01.14.2013

SHEET: **L240**







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CONSULTANT:



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PROJECT NUMBER: 2113

GRANT PARK VILLAGE

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SHEET TITLE:

EAST TERRACE -LANDSCAPE SITE PLAN


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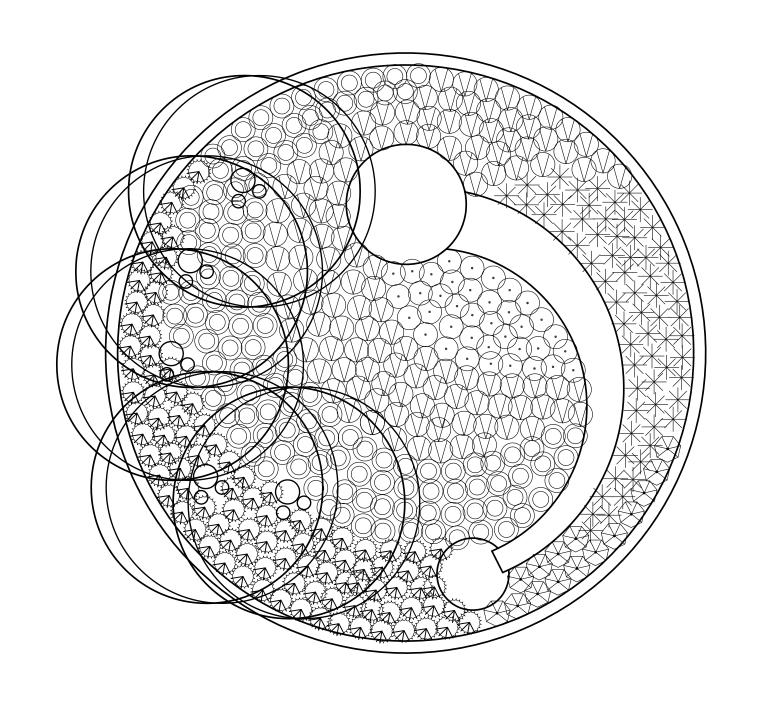
GROUP

ARCHITECTURE

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L.U.R. APPLICATION



WATER QUALITY FLOW-THROUGH PLANTER PLANT LEGEND PLANT QTY SIZE CO ACER CIRCINATUM 5 7-8' HT. 5 TO VINE Maple CAREX MORROWII 'AUREA VARIEGATA' 138 1 GAL. Variegated Japanese Sedge CAREX TESTACEA 224 1 GAL.

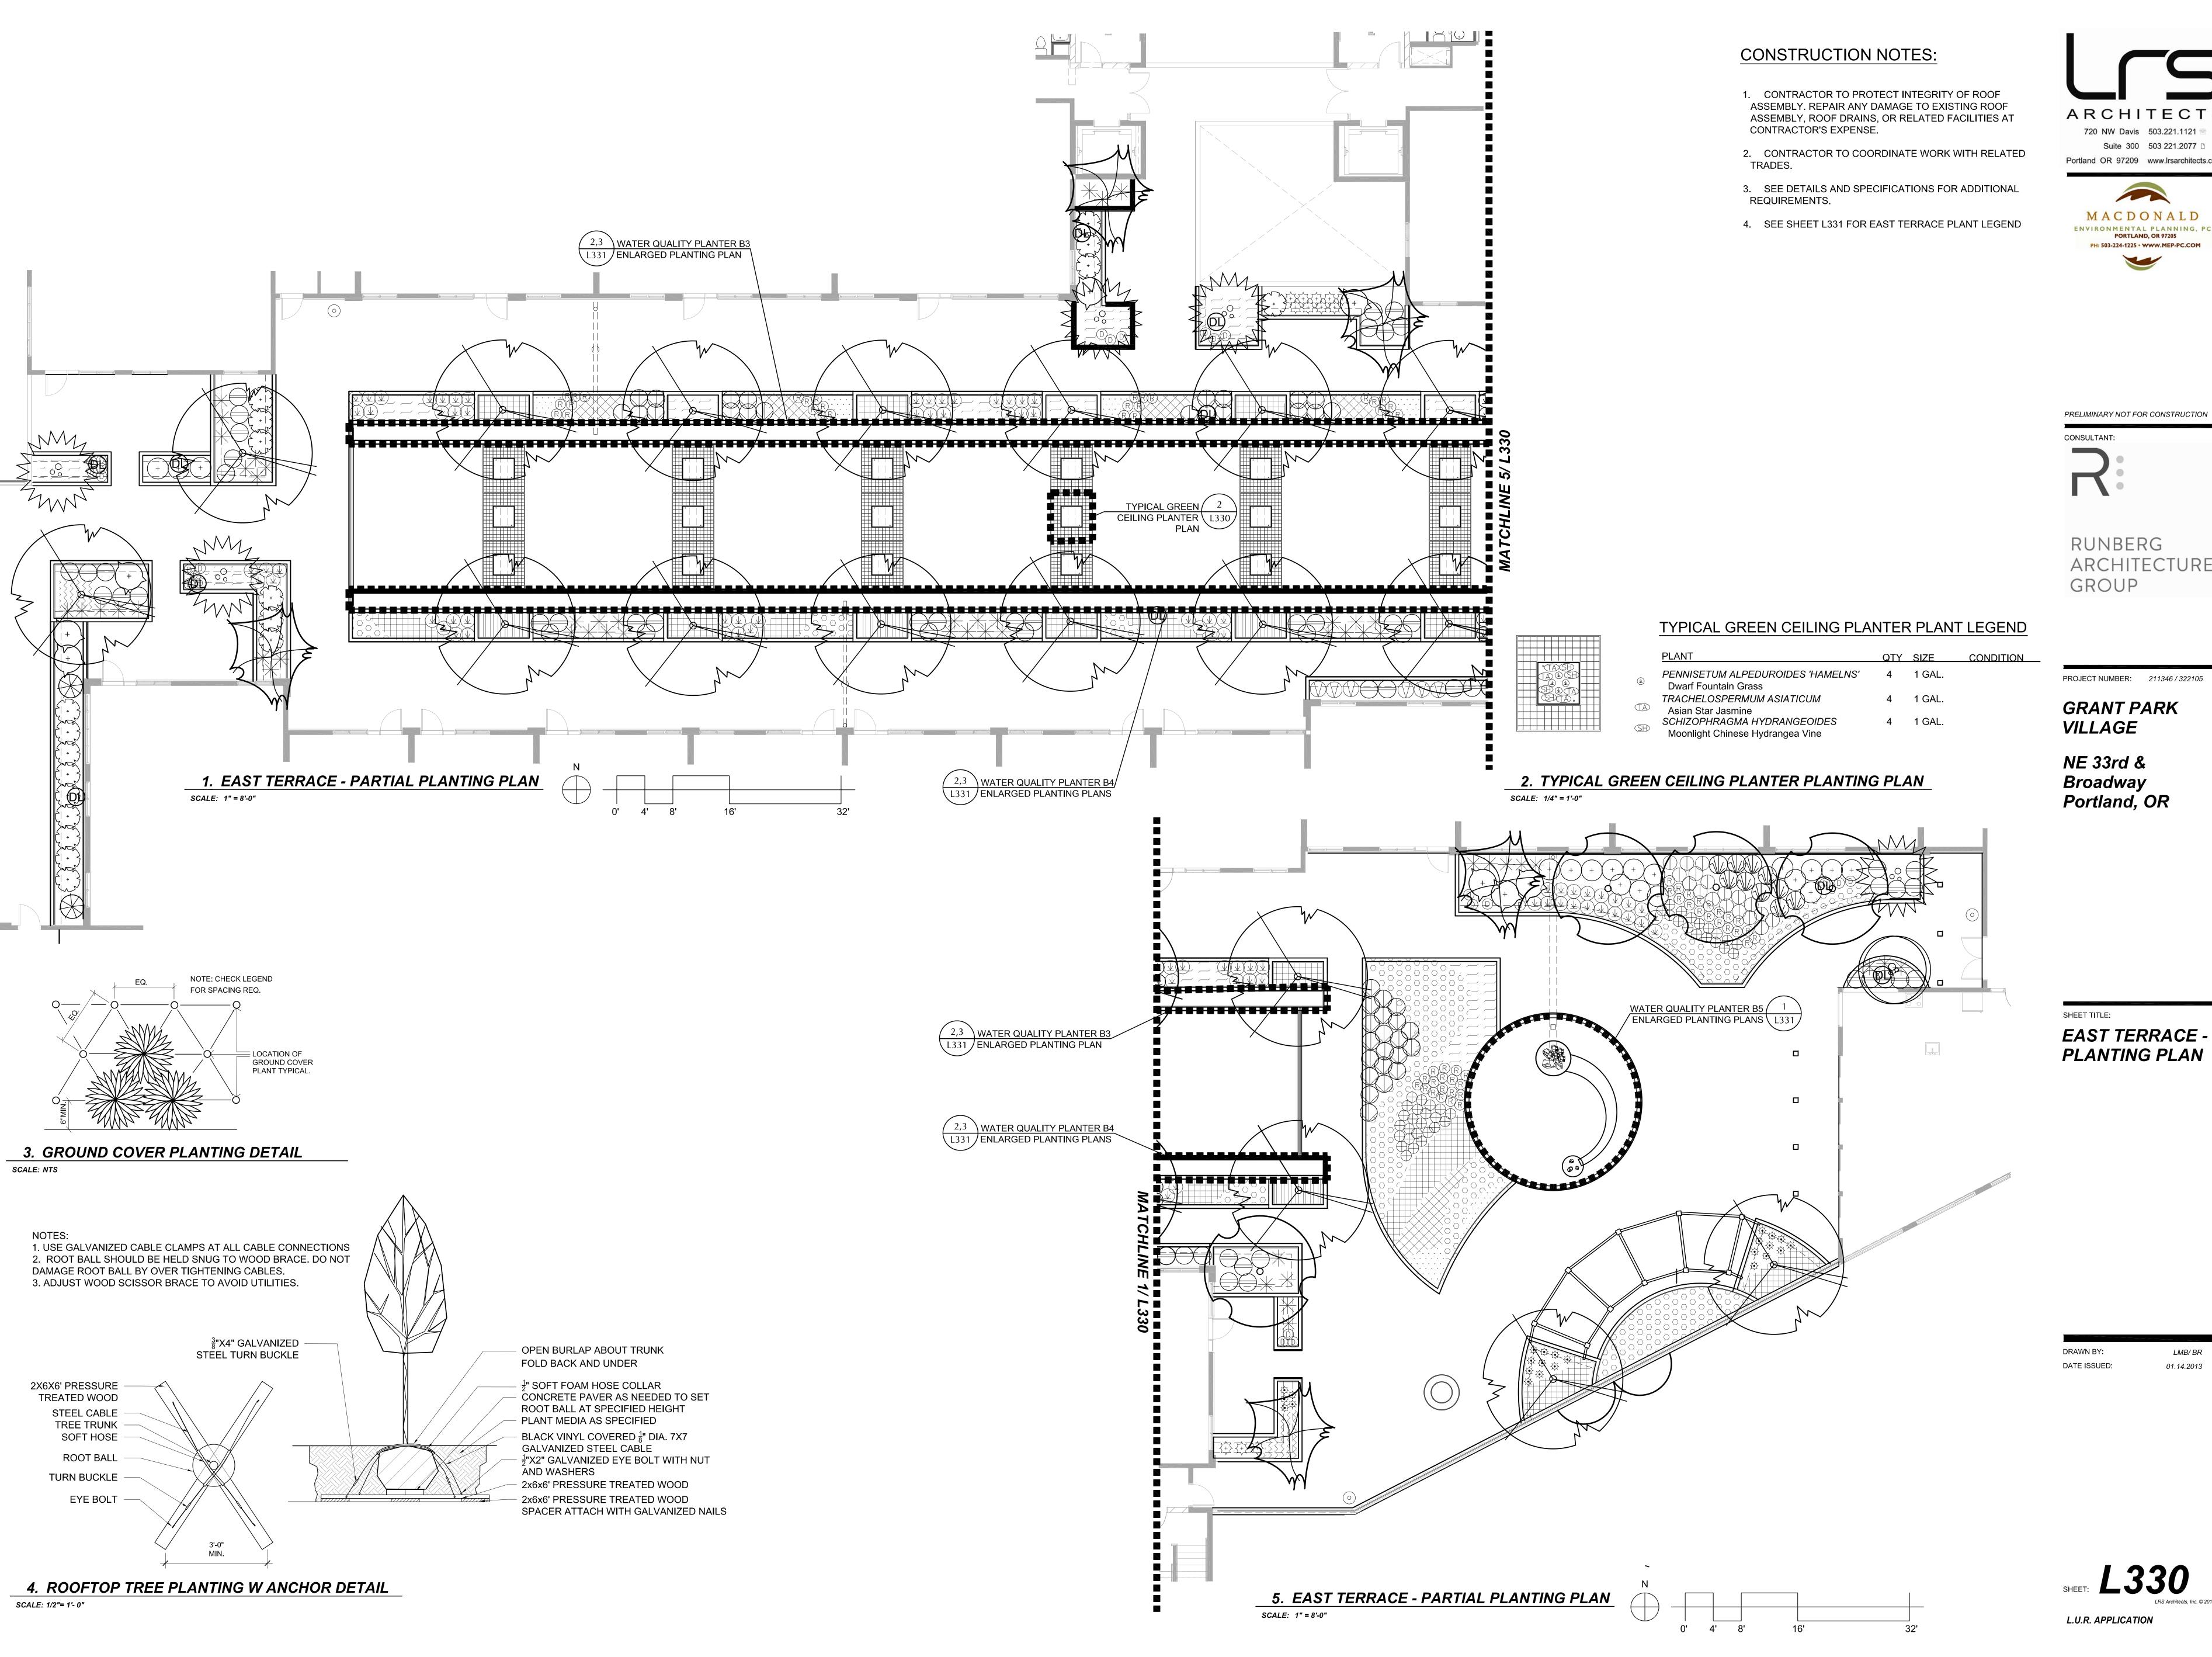
Golden-Eyed Grass

5 7-8' HT. 5 TRUNK MIN. 138 1 GAL. 224 1 GAL. New Zealand Orange Sedge CORNUS SERICEA 'KELSEYI' 225 1 GAL. Kelsey Red Osier Dogwood DESCHAMPSIA CAESPITOSA 187 1 GAL. Tufted Hairgrass JUNCUS ENSIFOLIUS 123 1 GAL. Dagger Leaf Rush JUNCUS PATENS 198 1 GAL. Spreading Rush SYSRINCHIUM CALIFORNICUM 91 1 GAL.


CONDITION

1. WATER QUALITY PLANTER B5 PLANTING PLAN

SCALE: 1/4"= 1'- 0"

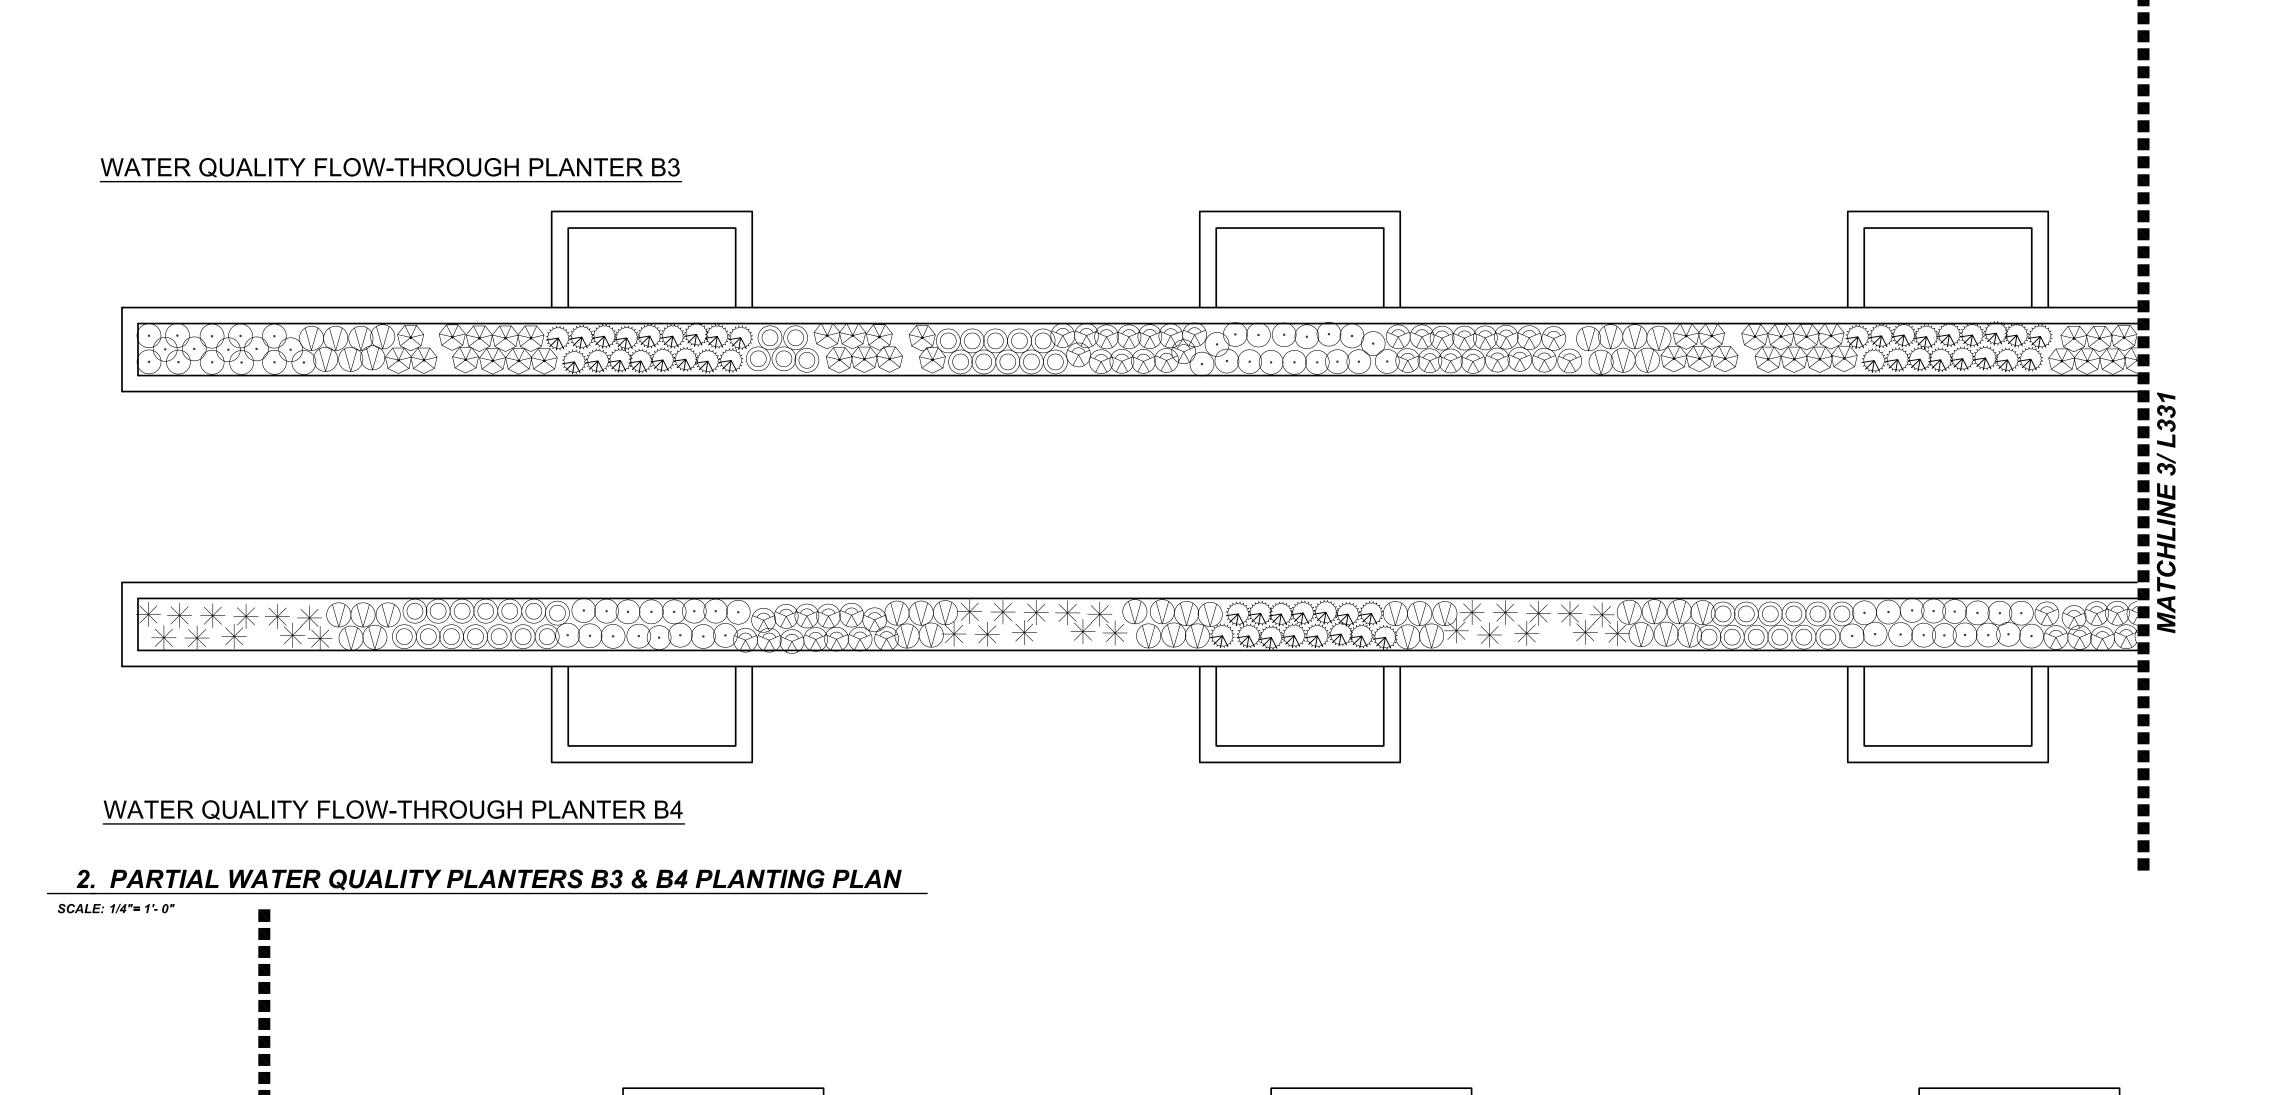

PLANT LEGEND - EAST TERRACE ONLY

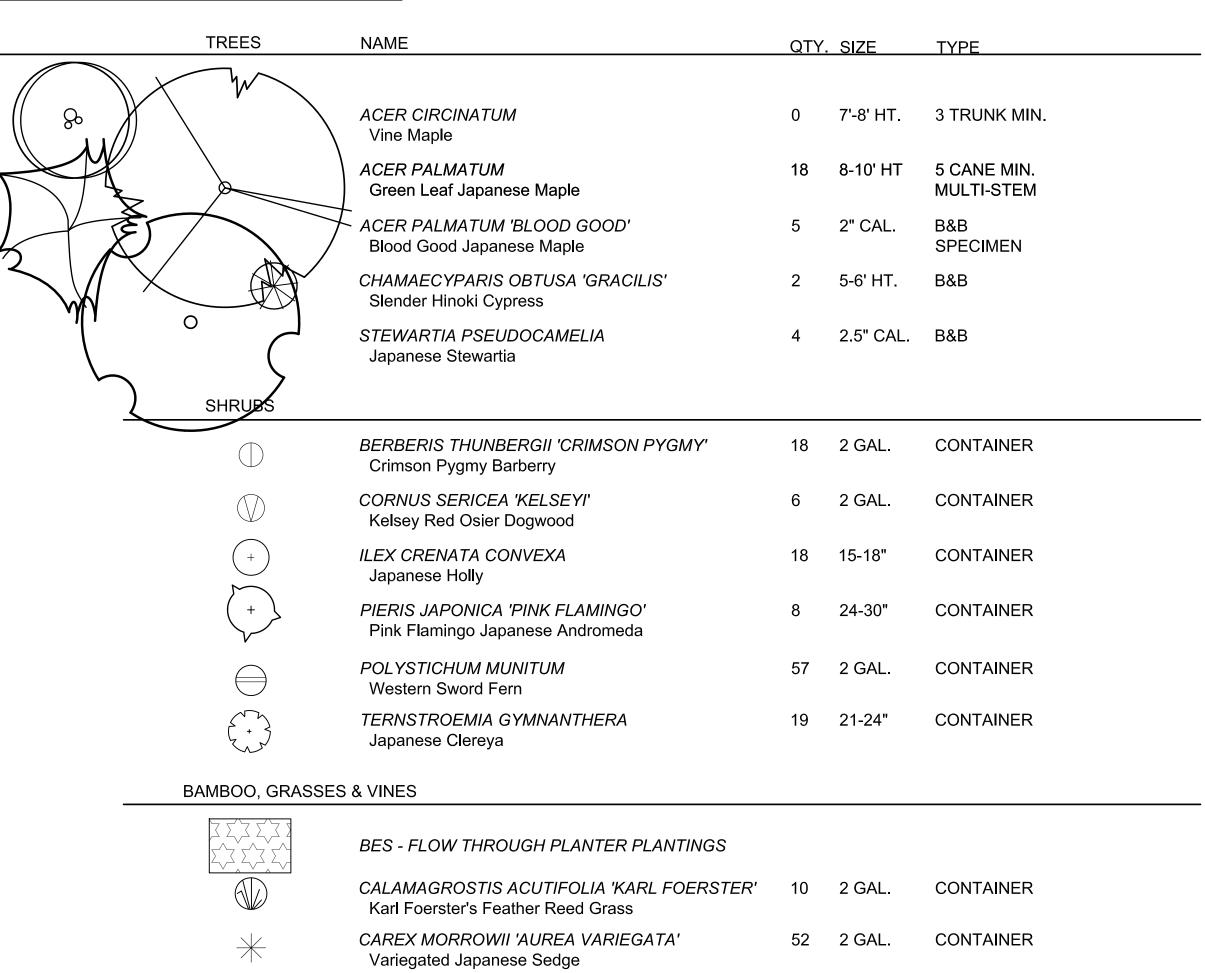

FARGESIA SP. 'JIUZHAIGOU' I CONTAINER 12 2 GAL. Red Bamboo HELICTOTRICHON SEMPERVIRENS CONTAINER Blue Oat Grass NASSELLA TENUISSIMA EST 1 GAL Mexican Feather Grass PENNISETUM ALPEDUROIDES 'HAMELNS' 88 2 GAL. CONTAINER **Dwarf Fountain Grass** PLEIOBLASTUS FORTUNEI CONTAINER Dwarf Whitestripe 00 GROUNDCOVERS & PERENNIALS THAMNOCALAMUS TESSELLATUS 5 15 GAL. CONTAINER SPECIMEN QTY. SIZE 18"O.C. AJUGA REPTANS EST 1 GAL Bugleweed HAKONECHLOA MACRA 18"O.C. Hakone Grass HEMEROCALLIS 'STELLA DE ORO' AS SHOWN Stella de Oro Daylily HEUCHERA 'MELTING FIRE' EST 1 GAL 18"O.C. Melting Fire Coral Bells HEUCHERA 'RAVE ON' 18"O.C. RAVE ON CORAL BELLS ILEX X 'MONDO' (MALE) 18"O.C. Little Rascal Holly OPHIOPOGON PLANISCAPUS'NIGRESCENS' EST 1 GAL 18"O.C. Black Mondo Grass RUDBECKIA 'EARLY BIRD GOLD' AS SHOWN Early Bird Gold Black-eyed Susan SARCOCCOA HOOKERIANA 'HUMILUS' EST 2 GAL 24"O.C. Himalayan Sarcoccoa SEDUM 'AUTUMN JOY' 41 2 GAL AS SHOWN Autumn Joy Stone Crop





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CONSULTANT:

R:

RUNBERG ARCHITECTURE GROUP

PROJECT NUMBER: 211346 / 322105

GRANT PARK VILLAGE

NE 33rd & Broadway Portland, OR

SHEET TITLE:

EAST TERRACE PLANT LEGEND &
ENLARGED
WATER QUALITY
PLANTER
PLANTING PLANS


DRAWN BY:
DATE ISSUED: 01

LMB/ BR 01.14.2013

HEET: L331

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L.U.R. APPLICATION



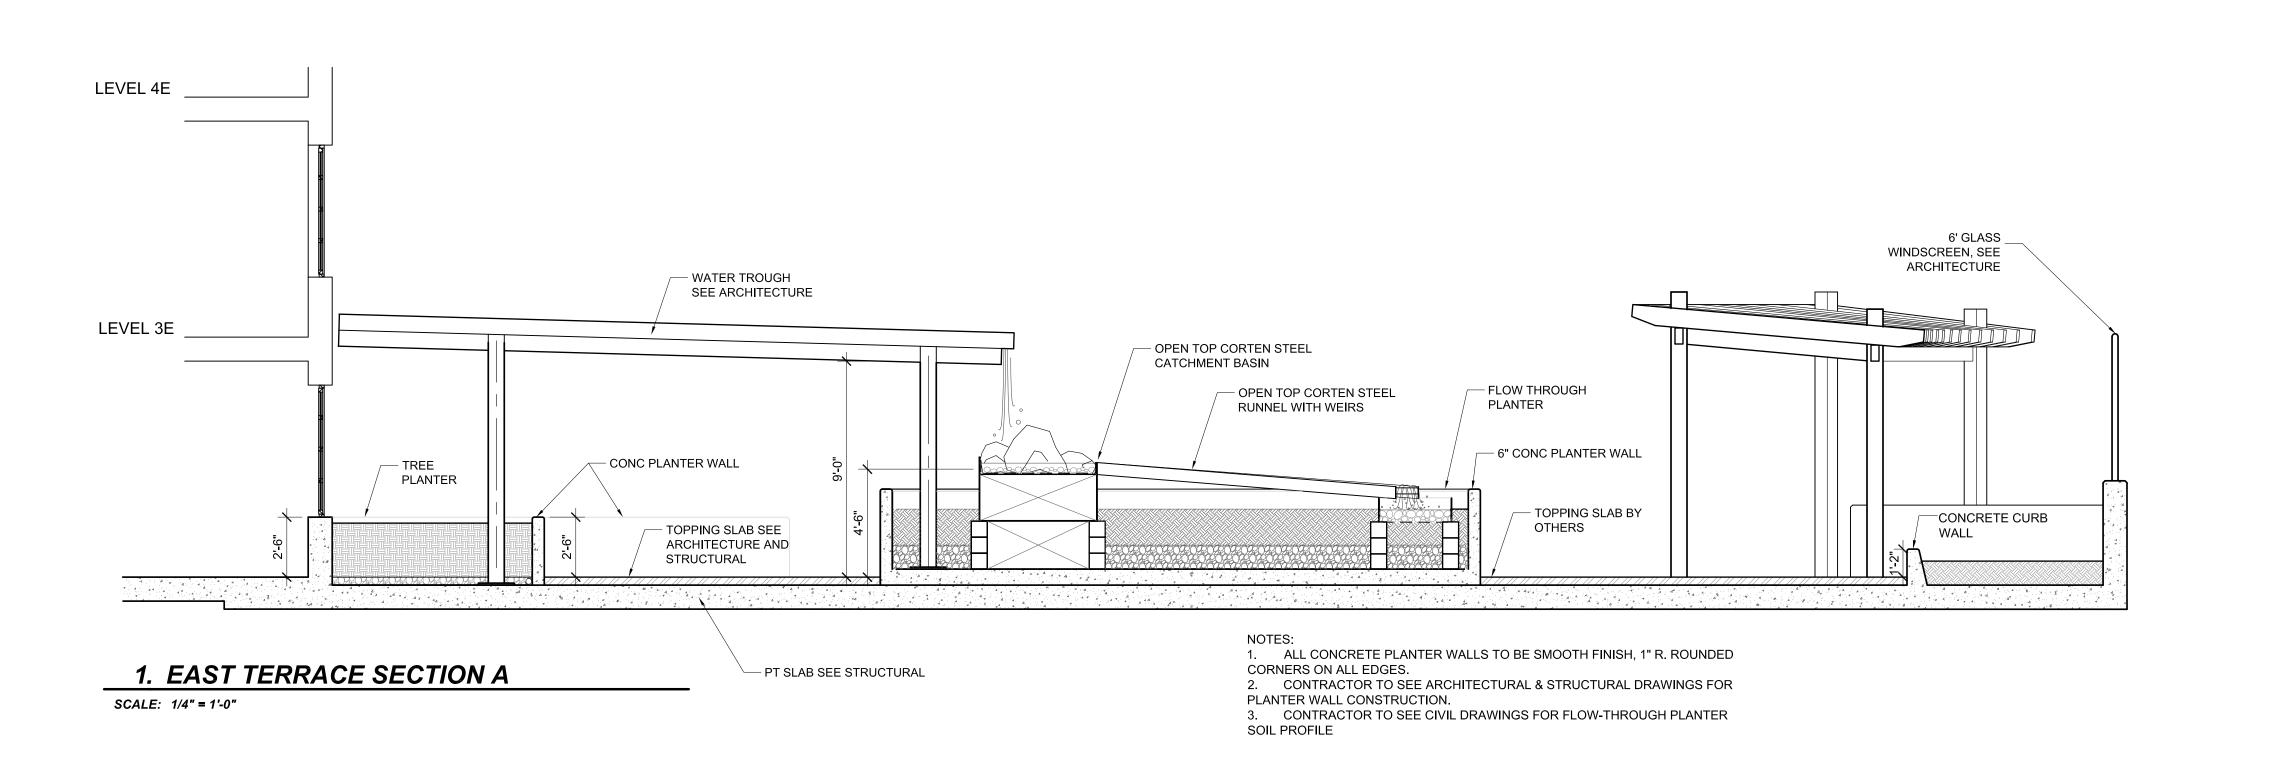



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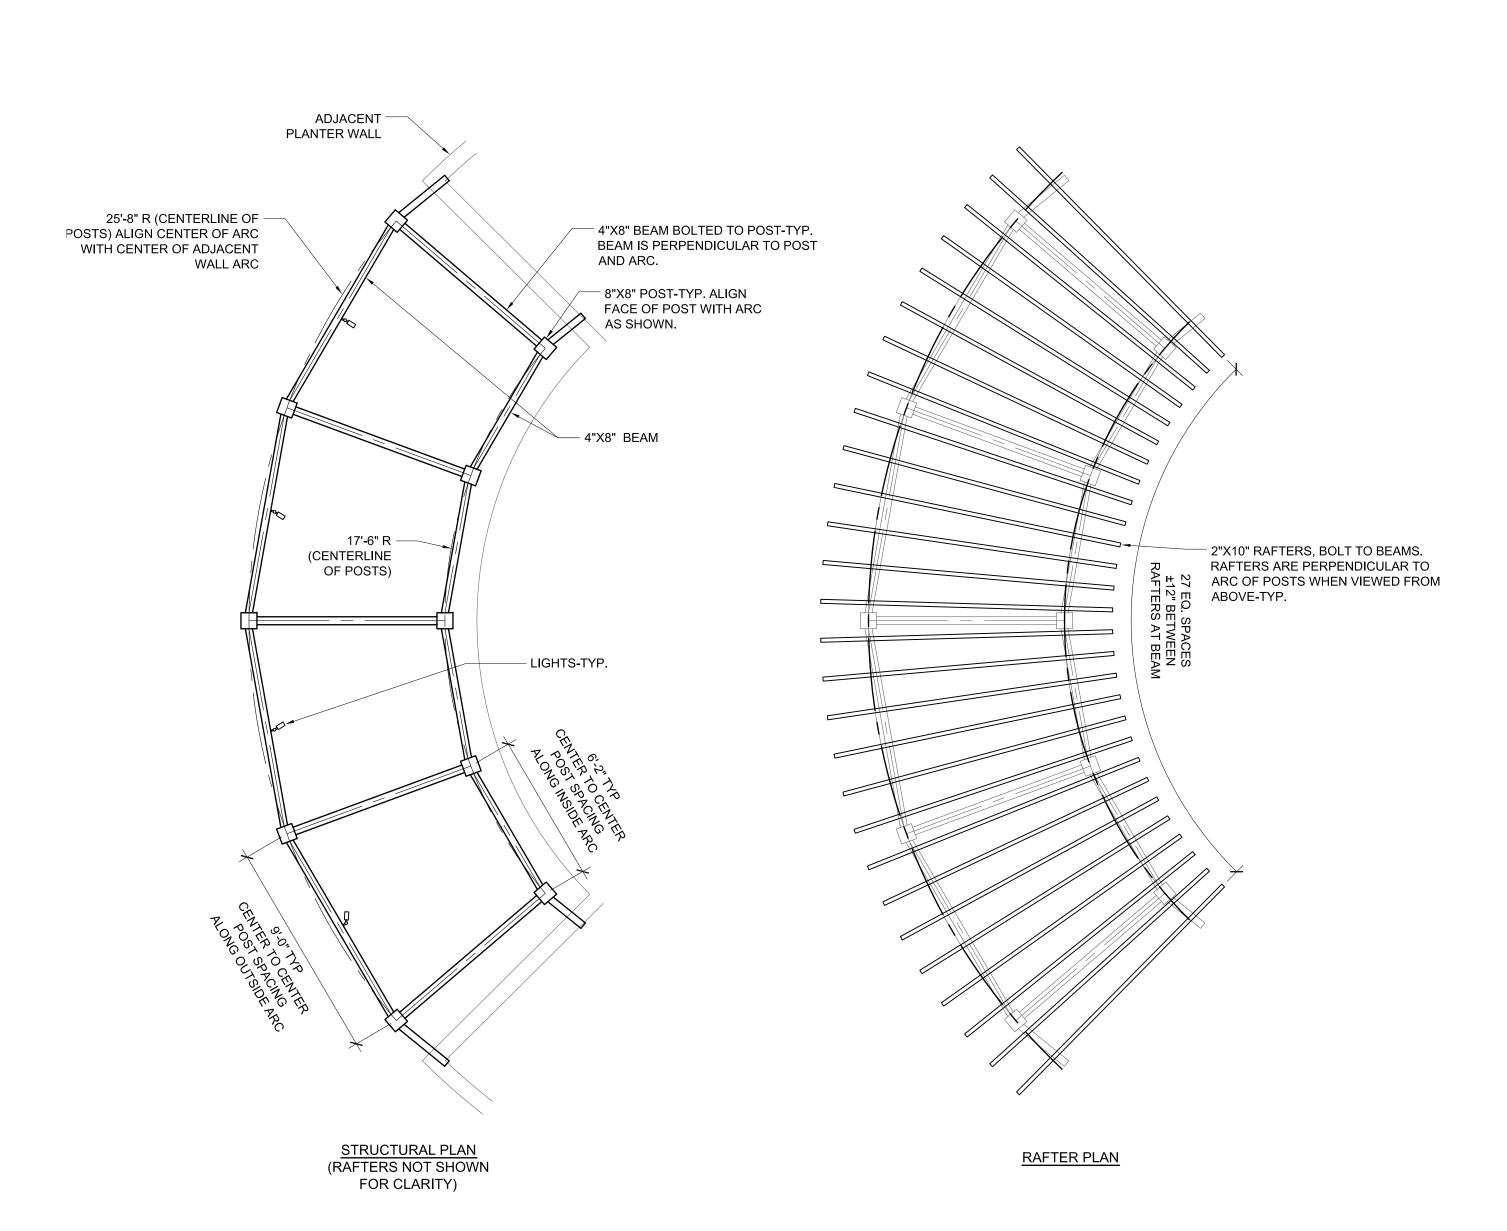
VILLAGE

NE 33rd &

Broadway Portland, OR

GRANT PARK

CONSULTANT:



STEEL PLATES BOLTED TO BEAMS, TYP

 CENTERLINE OF BEAM CENTERED ON SIDE OF POST NOT CENTER OF

— LAG STEEL PLATE TO POST

— STEEL PLATE


LIGHTS-TYP. -2"X10" RAFTERS, BOLT TO BEAMS W/ STEEL L-BRACKETS, FOUR PER RAFTER —4"X8" BEAM STEEL POST ANCHOR, SEE STRUCTURAL-TYP. 8'-2"

1. POSTS, BEAMS AND RAFTERS SHALL BE CEDAR.


BASED ON FIXTURE CHOSEN AND PHOTOMETRIC DATA.

3. ALL STEEL COMPONENTS SHALL BE HOT-DIP GALVANIZED AND POWDERCOATED 4. ALL STEEL BOLTS AND FASTENERS SHALL BE HOT-DIP GALVANIZED. 5. NUMBER OF LIGHTS SHOWN IS APPROXIMATE. ACTUAL NUMBER OF LIGHTS MAY VARY

SCALE: 1/2" = 1'-0" 2. MOUNT LIGHTS ON INSIDE FACES OF BEAMS AS SHOWN.

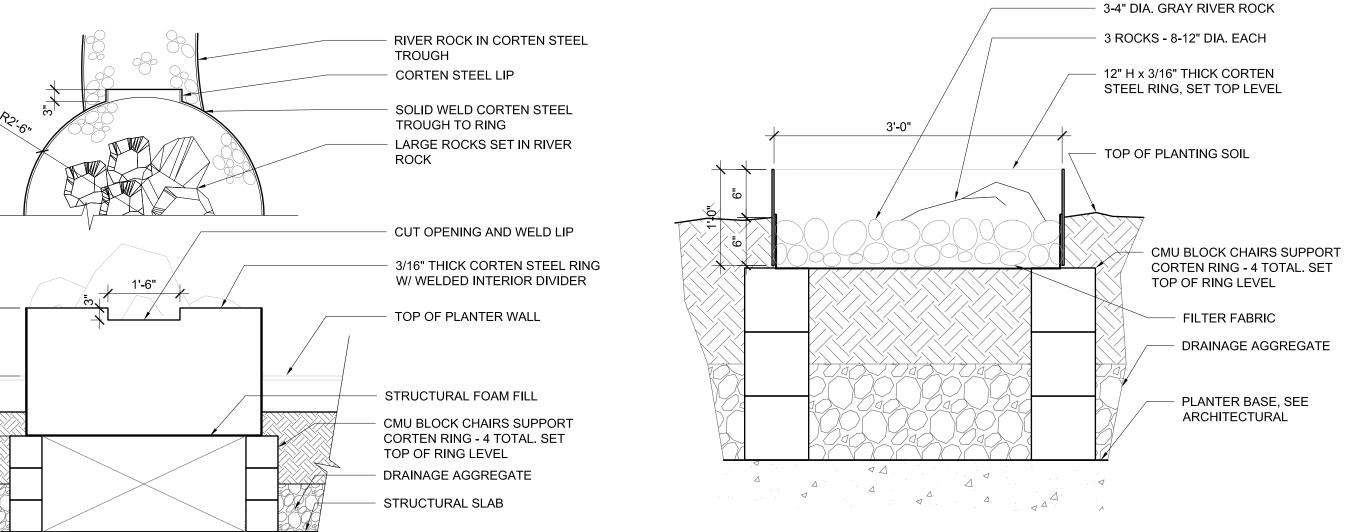

3. RIVER ROCK IN STEEL EDGING 2. CATCHMENT BASIN SCALE: 1/2" = 1'-0"

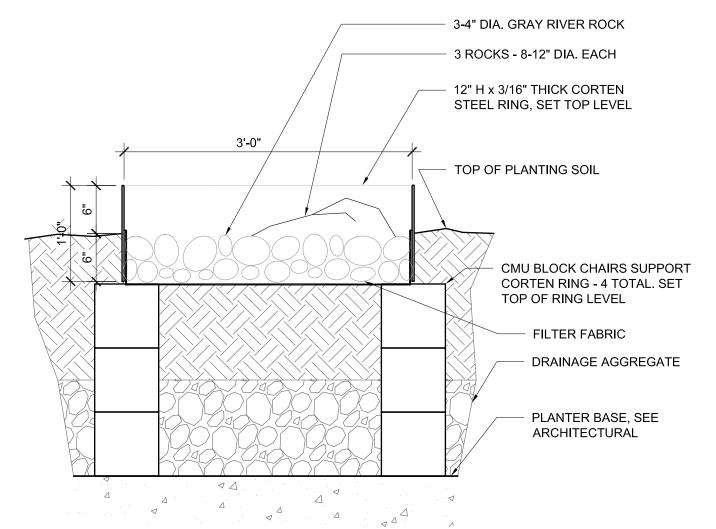

NOTES:


3" LAYER 3-4" DIA. GRAY

5'-3"

RIVER ROCK IN TROUGH

RIVER ROCK IN 3
STEEL EDGING -

1. CONTRACTOR TO COORDINATE WORK WITH ALLIED TRADES. SHEET TITLE: 2. SOLID WELD ALL CONNECTIONS, SMOOTH WELDS AND EXPOSED EDGES EAST TERRACE 3. PROVIDE ADDITIONAL STEEL BRACING **SECTIONS &** TO SUPPORT TROUGH AS NEEDED. **DETAILS** 4. ARRANGE ROCKS IN TROUGH TO ALLOW UNOBSTRUCTED WATER MOVEMENT OVER

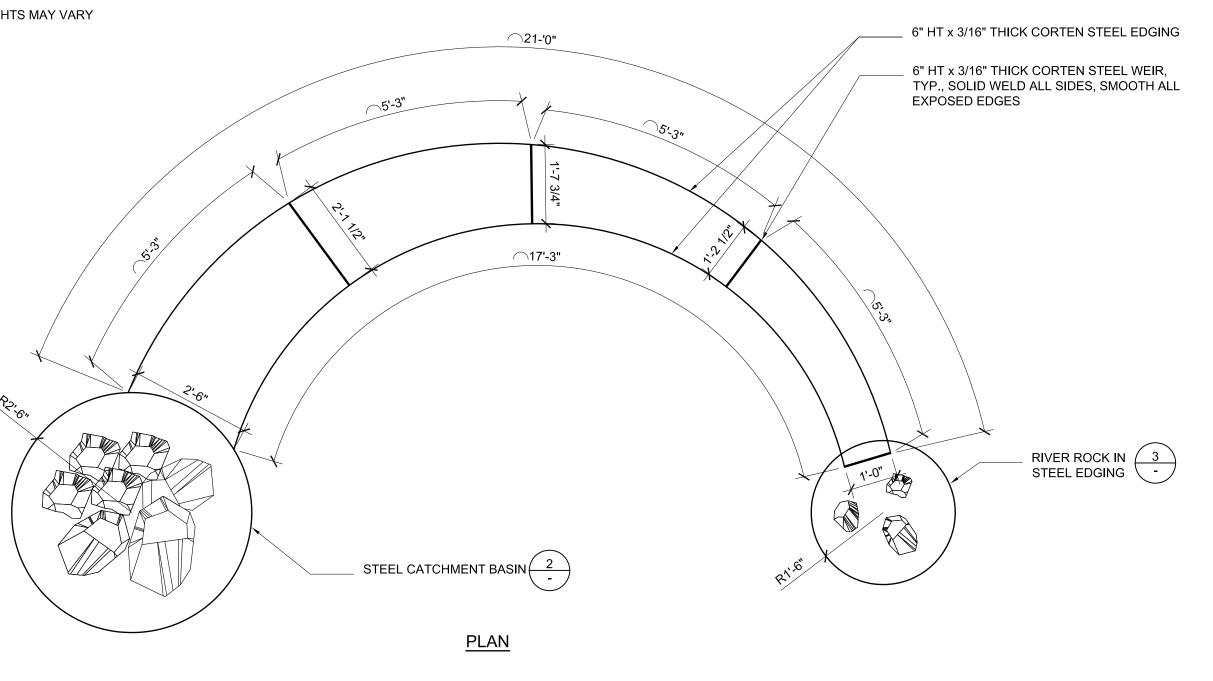

_ STEEL CATCHMENT BASIN 2 6" HT x 3/16" THICK CORTEN STEEL WEIR, 6" HT x 3/16" THICK CORTEN STEEL EDGING TYP., SOLID WELD ALL SIDES, SMOOTH ALL EXPOSED EDGES FLOW-THROUGH PLANTER, SEE 3/16" THICK STEEL BOTTOM, SOLID WELD ALL SIDES ARCHITECTURAL AND CIVIL DRAWINGS WATER LEVEL WATER LEVEL

<u>SECTION</u>

6. STEEL WATER FEATURE

DATE ISSUED: 01.14.2013


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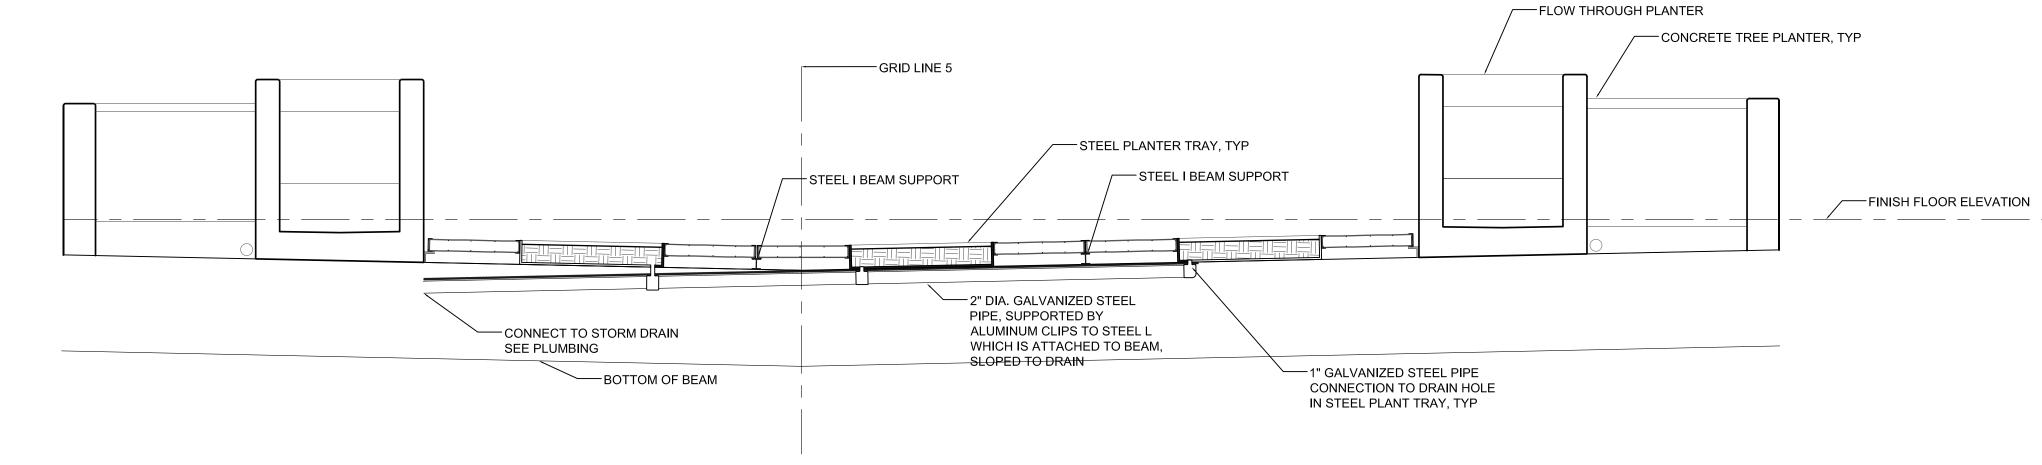
5. ARBOR POST & BEAM CONNECTION SCALE: 1 1/2"=1'-0"

 \bigcirc

SCALE: 1/4" = 1'-0"

4. ARBOR - TERRACE LEVEL 2



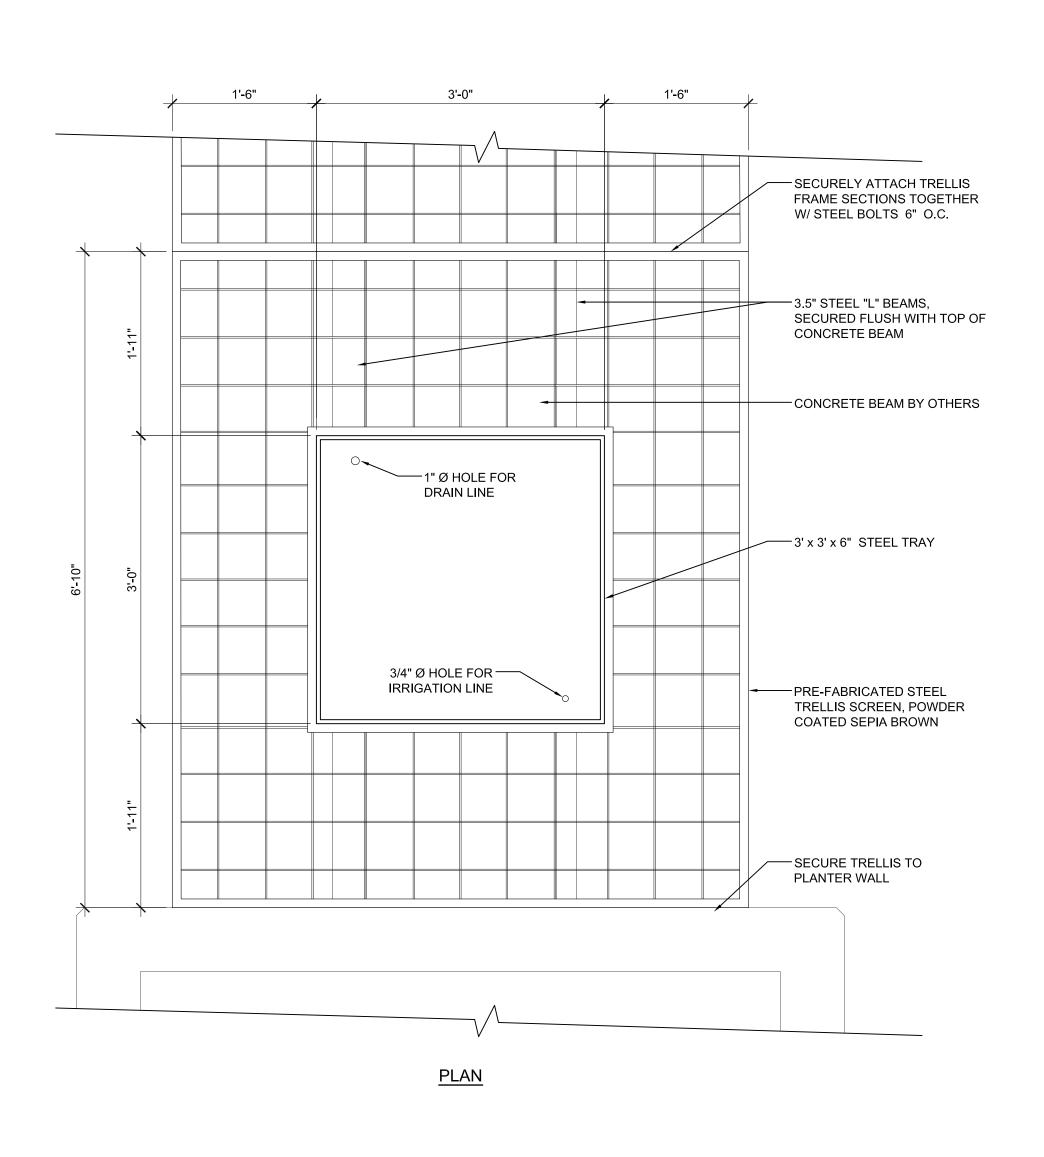



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RUNBERG

GROUP

PROJECT NUMBER:

VILLAGE

NE 33rd &

Broadway Portland, OR

GRANT PARK

ARCHITECTURE

CONSULTANT:

SECTION AT GREEN CEILING TRELLIS


1. LOOKING WEST

SCALE: 1/2" = 1'-0"

CONNECT TO IRRIGATION SYSTEM ─GRID LINE 5 STEEL PLANTER TRAY, TYP STEEL I BEAM SUPPORT STEEL I BEAM SUPPORT TOP OF BEAM — STEEL L SUPPORT, TYP CONNECT TO IRRIGATION DRIP
LINE WITHIN PLANTER TRAY 1" DIA. GALVANIZED STEEL PIPE, SUPPORTED BY ALUMINUM CLIPS TO BEAM — ВОТТОМ OF BEAM

SECTION AT GREEN CEILING TRELLIS 2. LOOKING EAST

SCALE: 1/2" = 1'-0"

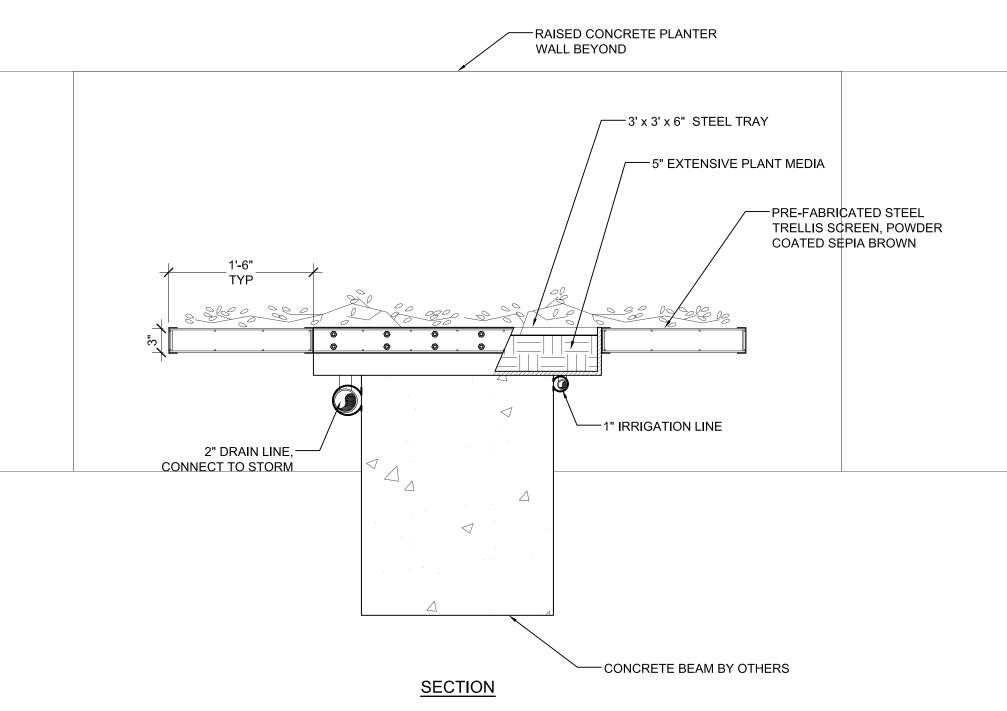

3. GREEN CEILING TRELLIS

SCALE: 1" = 1'-0"

SHEET TITLE: EAST TERRACE SECTIONS & **DETAILS**

DATE ISSUED: 01.14.2013


GENERAL NOTES

- 1. SEE 1/8" FLOOR PLAN SHEETS FOR MORE INFORMATION.
- 2. SITE INFO SHOWN FOR REFERENCE ONLY. SEE SITE PLANS
- 3. SEE A0 SHEETS FOR CODE COMPLIANCE INFORMATION



LEGEND

SHEAR WALL DESIGNATION (FOR REFERENCE ONLY) SEE STRUCTURAL FOR SHEAR WALL LOCATIONS.

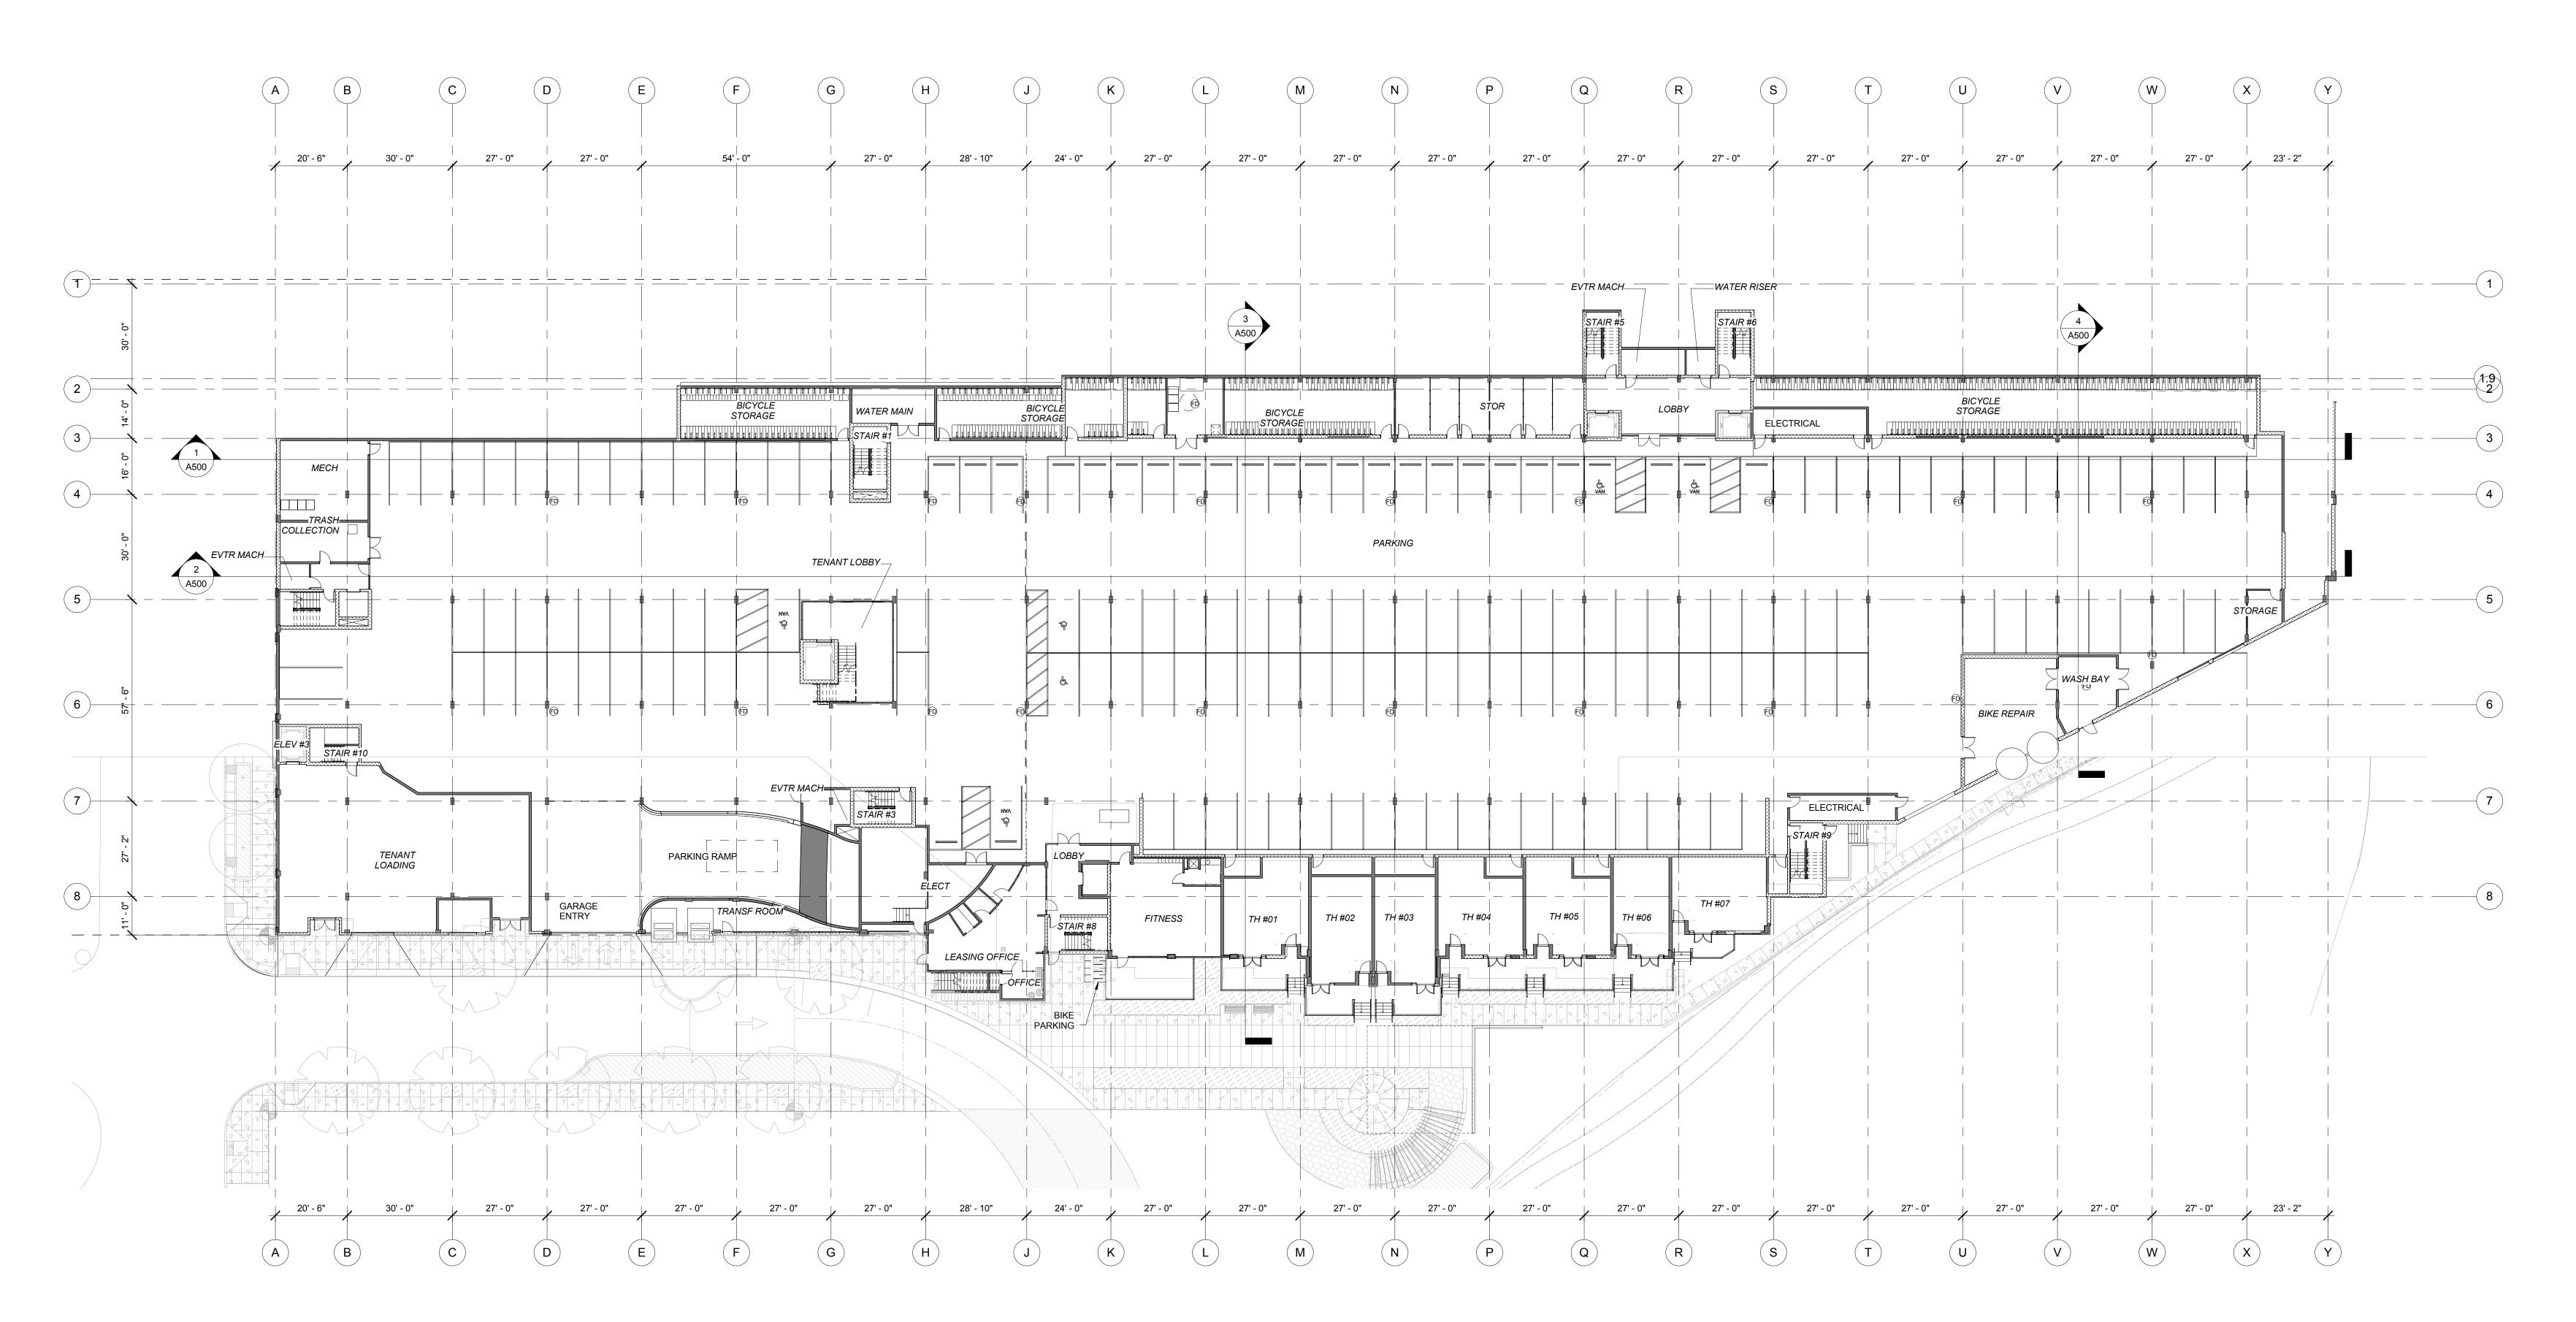

PRELIMINARY -NOT FOR CONSTRUCTION

CONSULTANT:

RUNBERG ARCHITECTURE GROUP

PROJECT NUMBER:

GRANT PARK VILLAGE

NE 33RD & BROADWAY PORTLAND, OR


SHEET TITLE:

LOWER LEVEL FLOOR PLAN

1.14.2013 DATE ISSUED:

1. LOWER LEVEL FLOOR PLAN SCALE: 1" = 20'-0"



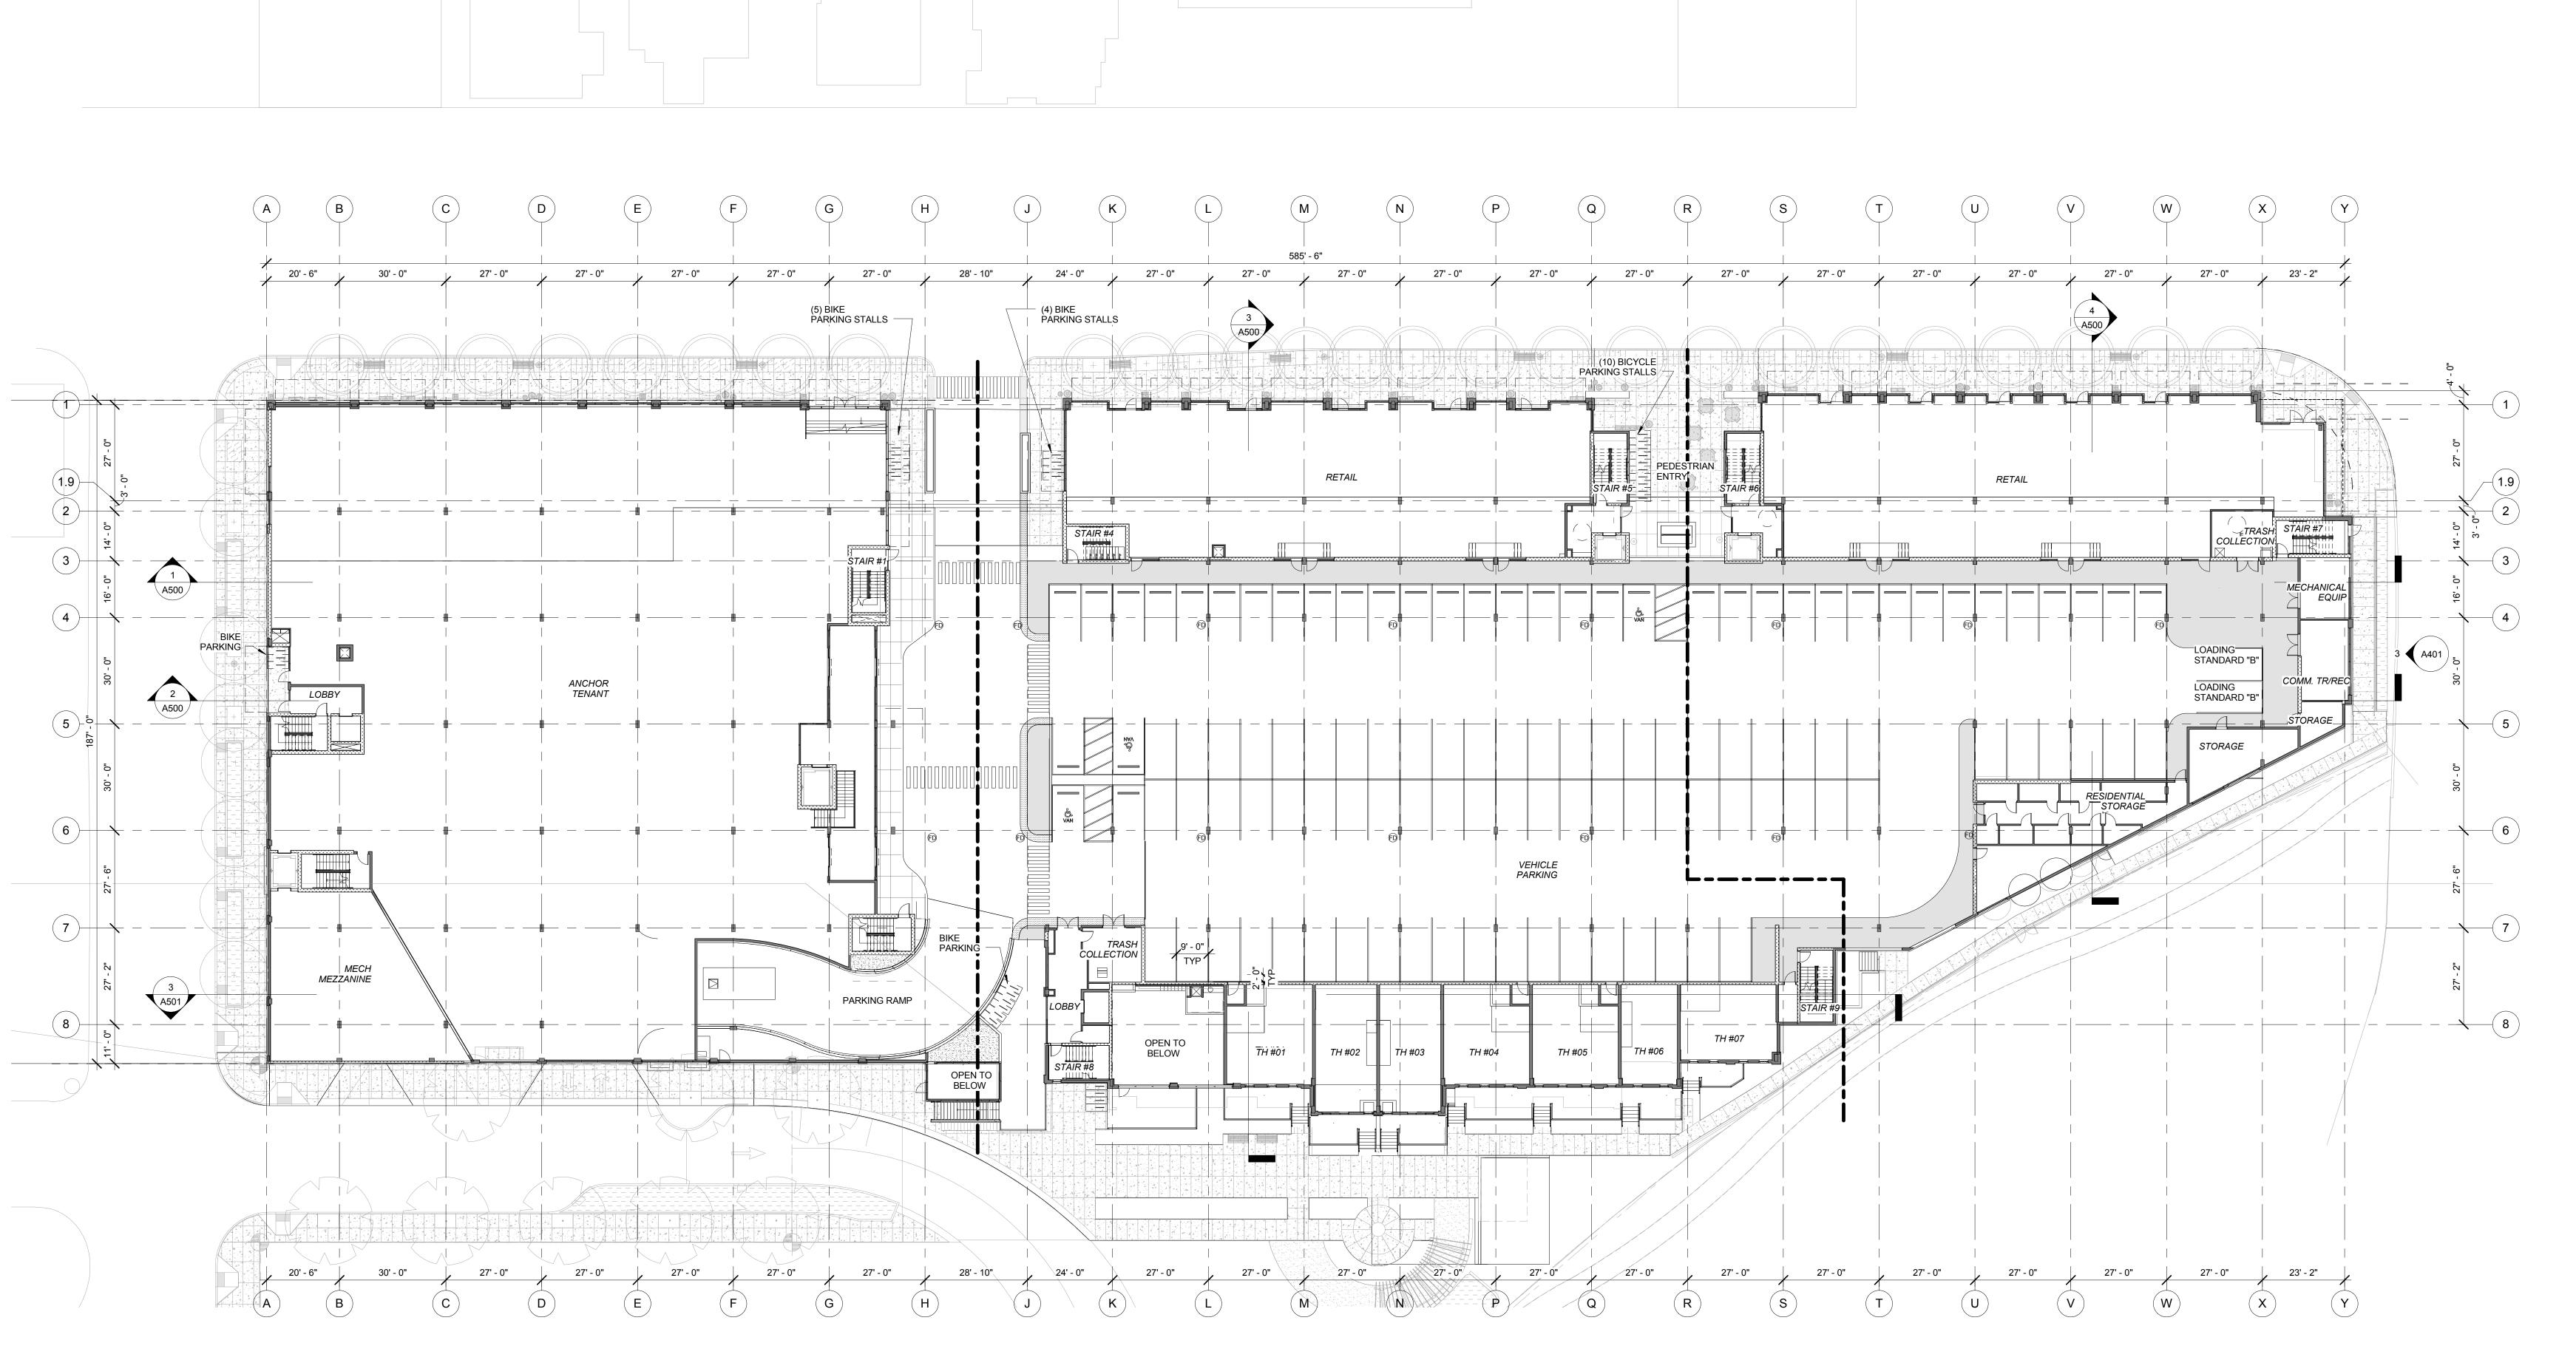

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CONSULTANT:

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RUNBERG ARCHITECTURE GROUP

PROJECT NUMBER: 211

GRANT PARK VILLAGE

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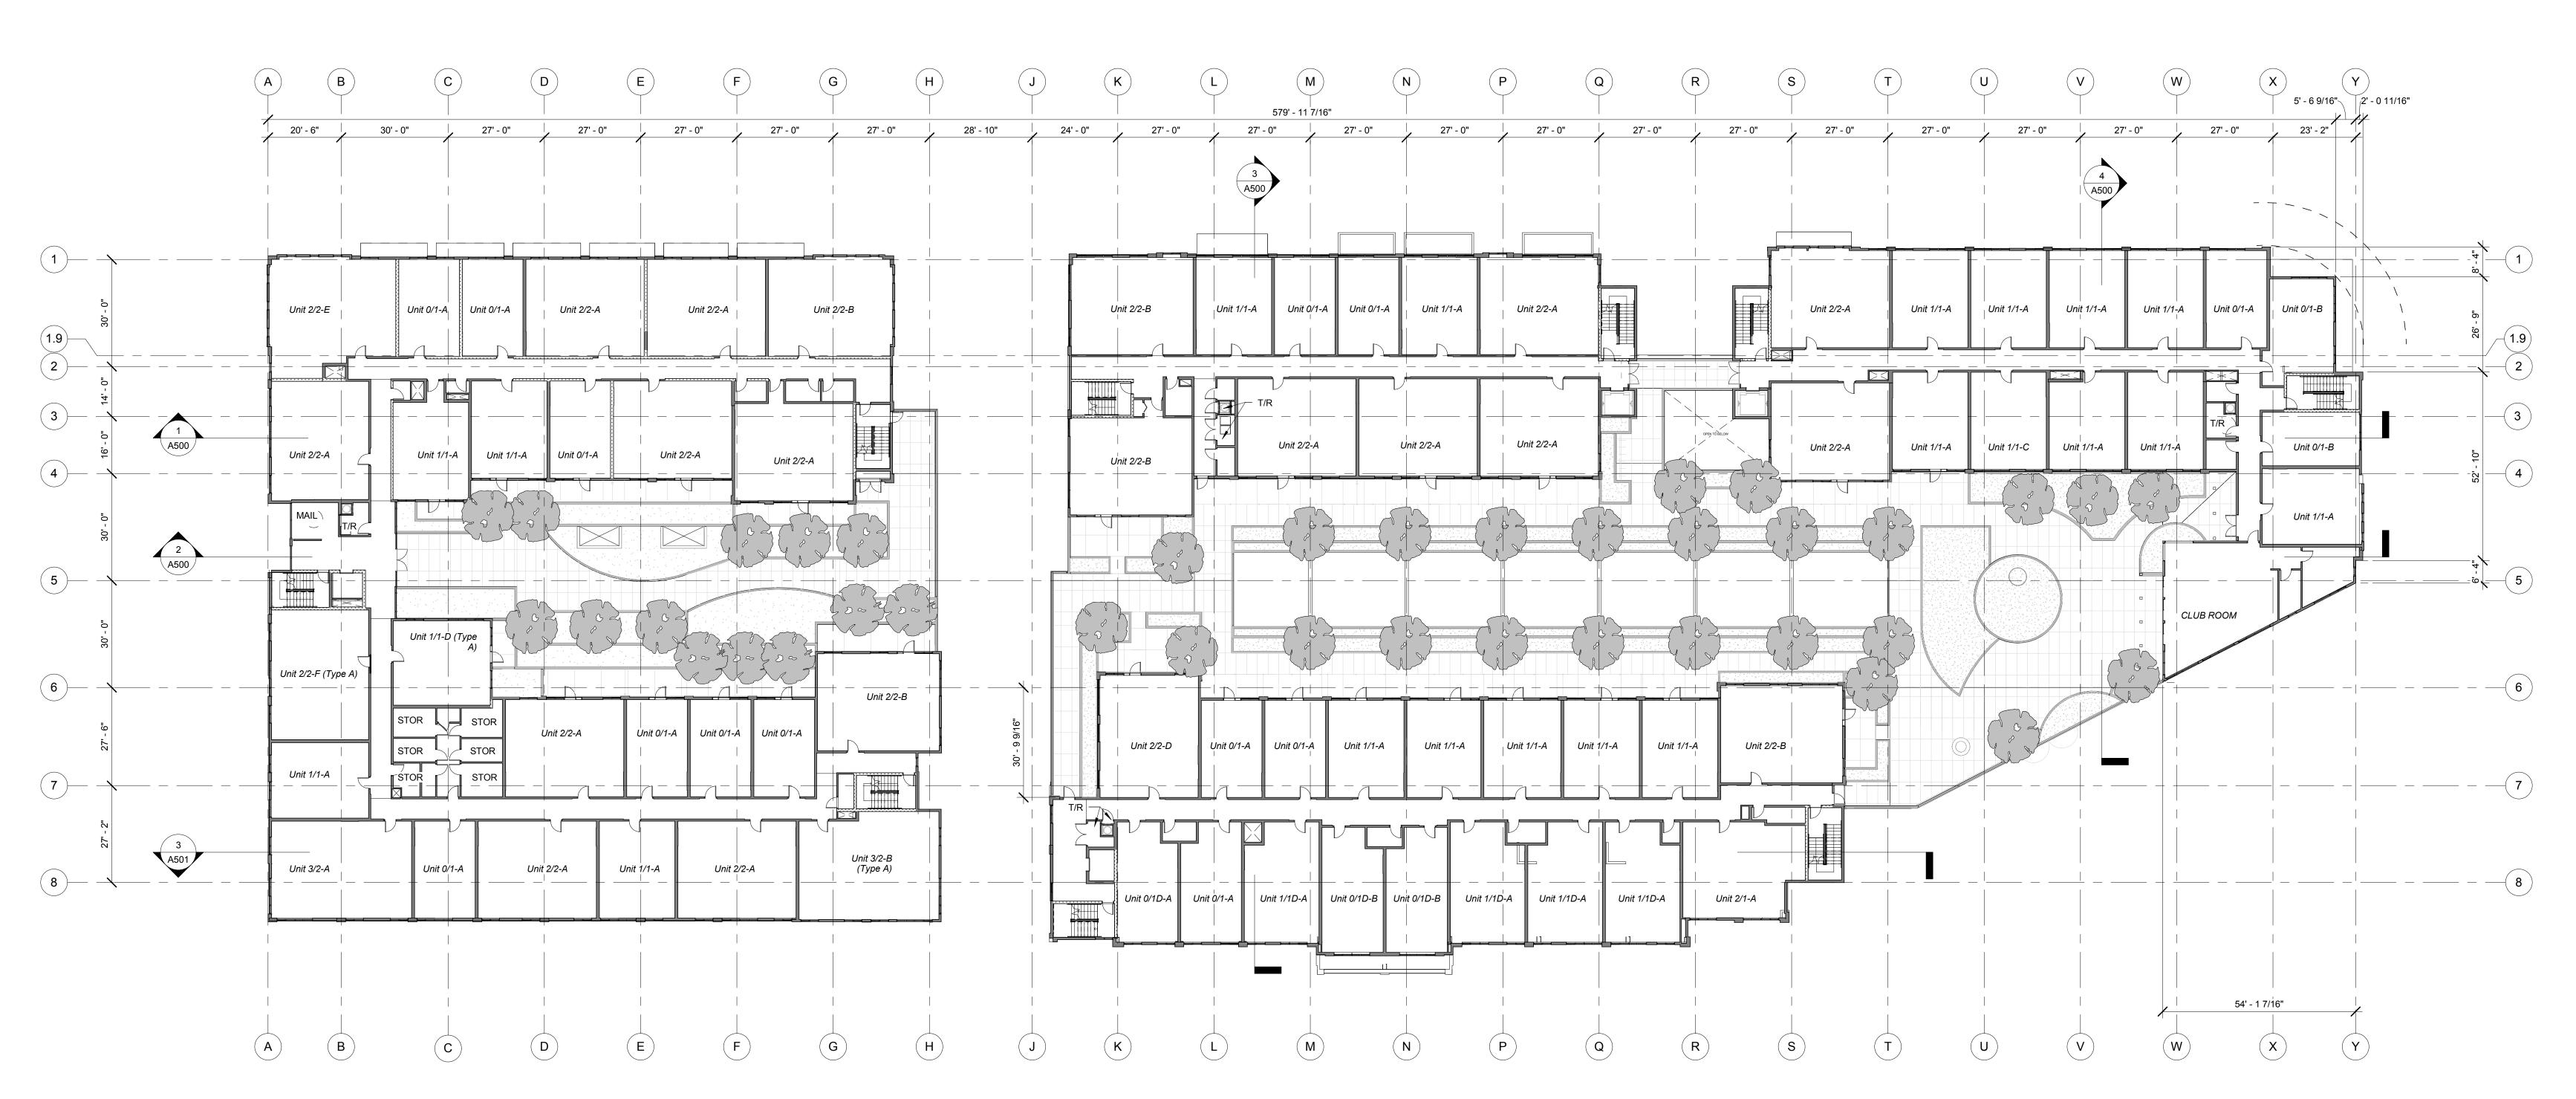
SHEET TITLE:

LEVEL 1 FLOOR

PLAN

DRAWN BY: Author
DATE ISSUED: 1.14.2013





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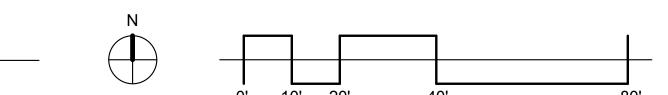
PROJECT NUMBER:

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SHEET TITLE: LEVEL 2 FLOOR PLAN

1.14.2013 DATE ISSUED:



GENERAL NOTES

- 1. SEE 1/8" FLOOR PLAN SHEETS FOR MORE INFORMATION.
- 2. SITE INFO SHOWN FOR REFERENCE ONLY. SEE SITE PLANS
- 3. SEE A0 SHEETS FOR CODE COMPLIANCE INFORMATION



LEGEND

SHEAR WALL DESIGNATION (FOR REFERENCE ONLY) SEE STRUCTURAL FOR SHEAR WALL LOCATIONS.

SIDING LEGEND



PRELIMINARY -NOT FOR CONSTRUCTION

CONSULTANT:

GROUP

RUNBERG

ARCHITECTURE

PROJECT NUMBER:

GRANT PARK VILLAGE


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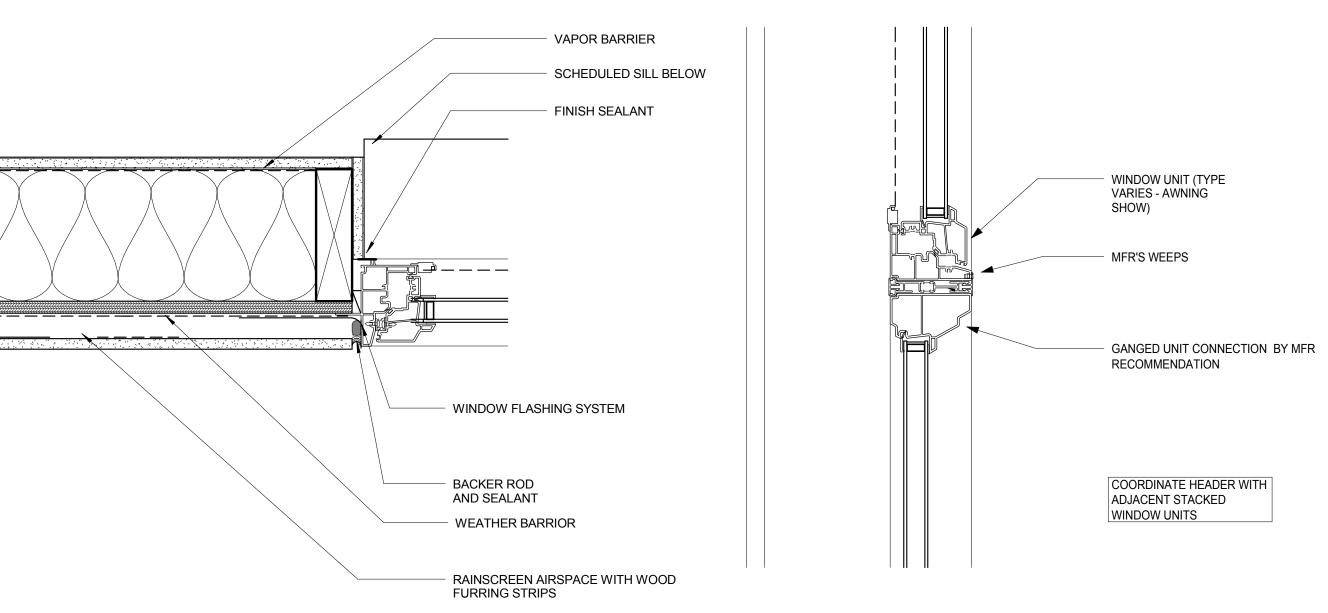
SHEET TITLE: LEVEL 2 FLOOR PLAN SIDING LEGEND

DATE ISSUED:




SCALE: 1" = 20'-0"




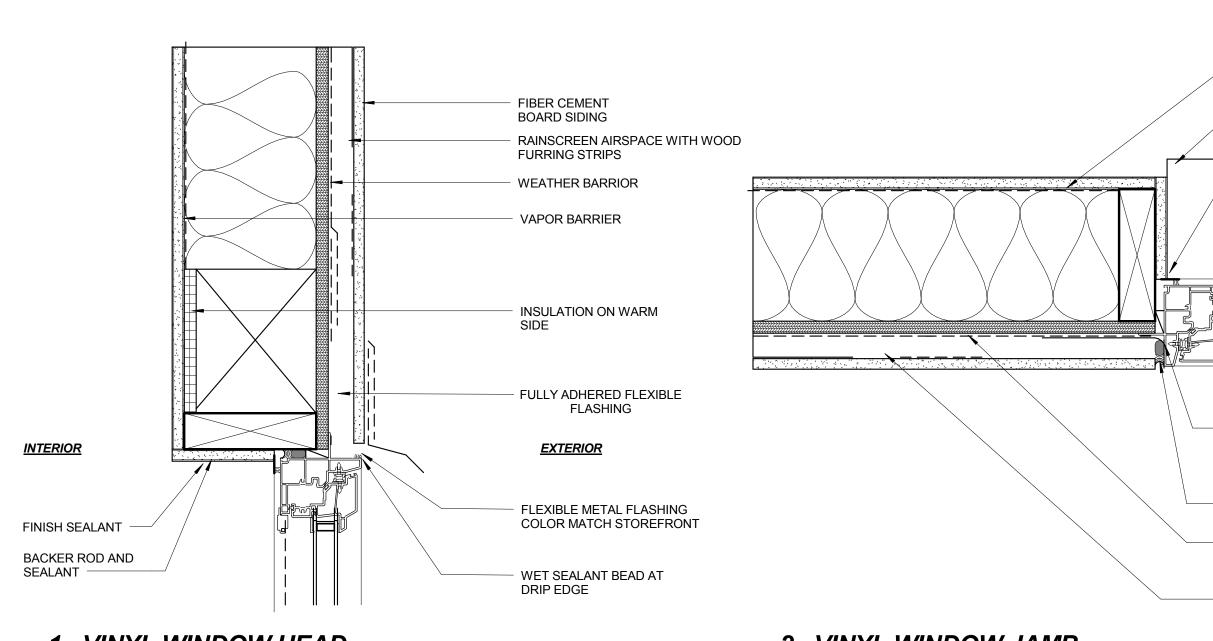

SCALE: 3" = 1'-0"

<u>INTERIOR</u>

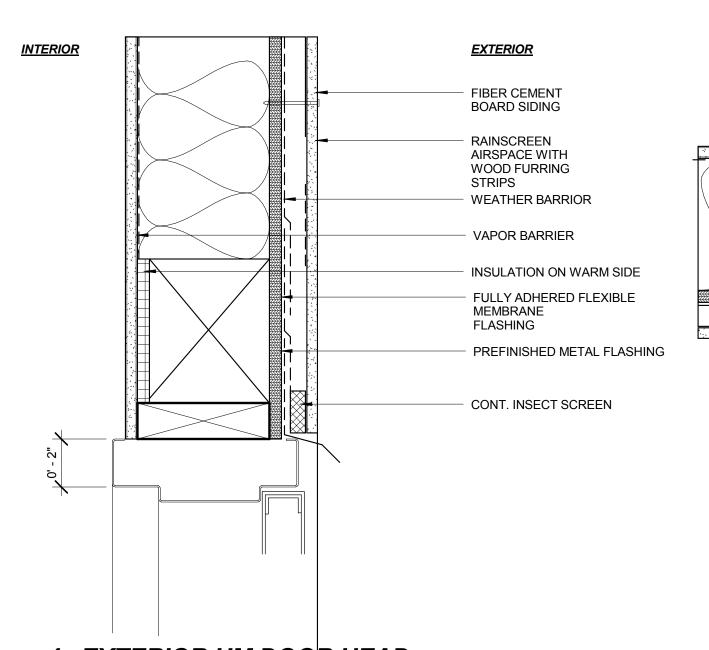

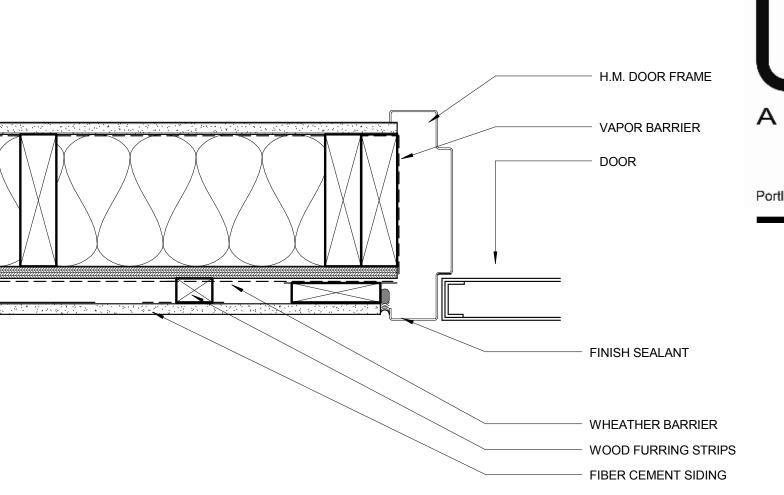

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1. VINYL WINDOW HEAD

SCALE: 3" = 1'-0" - WINDOW UNIT - SEALANT BACKER ROD & SEALANT CASING BEAD - WINDOW FLASHING SYSTEM WD SILL AND 1 X 4 WD APRON RAINSCREEN AIRSPACE WITH WOOD FURRING STRIPS FIBER CEMENT BOARD SIDING

2. VINYL WINDOW JAMB

SCALE: 3" = 1'-0"

0' - 4"

7. VINYL WINDOW JAMB 2

SCALE: 3" = 1'-0"

GANGED UNIT CONNECTION BY MFR'S INSTRUCTIONS (SEE ELEVATIONS FOR

VINYL TRIM TO MATCH FRAME

3. VINYL WINDOW MULLION HORIZ

SCALE: 3" = 1'-0"

EXTERIOR

— THRESHOLD - SET IN FULL BED OF SEALANT

—PREMOLDED EXPANSION JOINT

— FRAME BEYOND

----WEATHERSTRIP

SLOPE @ LANDING

4. EXTERIOR HM DOOR HEAD

5. EXTERIOR HM DOOR JAMB

SCALE: 3" = 1'-0"

PRELIMINARY -NOT FOR CONSTRUCTION

CONSULTANT:


RUNBERG ARCHITECTURE GROUP

PROJECT NUMBER:

GRANT PARK VILLAGE

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6. VINYL WINDOW SILL SCALE: 3" = 1'-0"

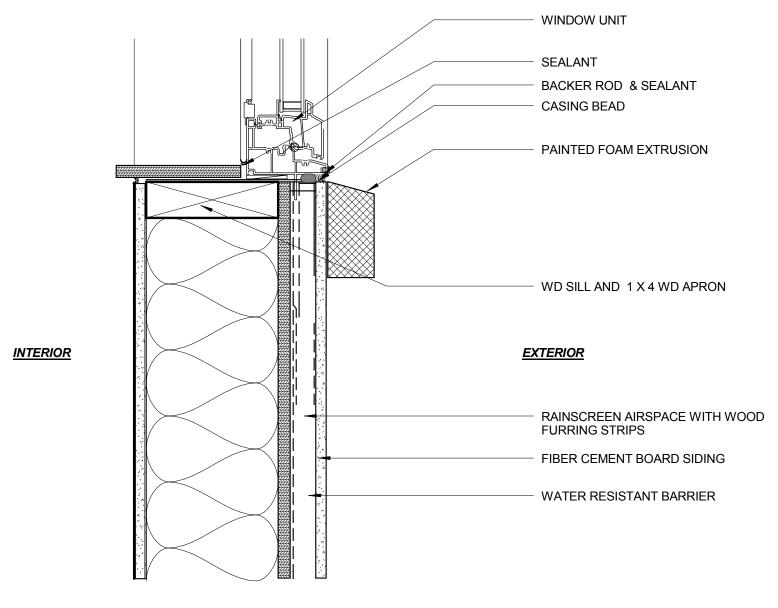

- WATER RESISTANT BARRIER

9. VINYL WINDOW SILL @ TRIM


SCALE: 3" = 1'-0"

8. EXTERIOR HM DOOR SILL SCALE: 3" = 1'-0"

SHEET TITLE:

WINDOW & DOOR DETAILS


DRAWN BY: DATE ISSUED: 1.14.2013

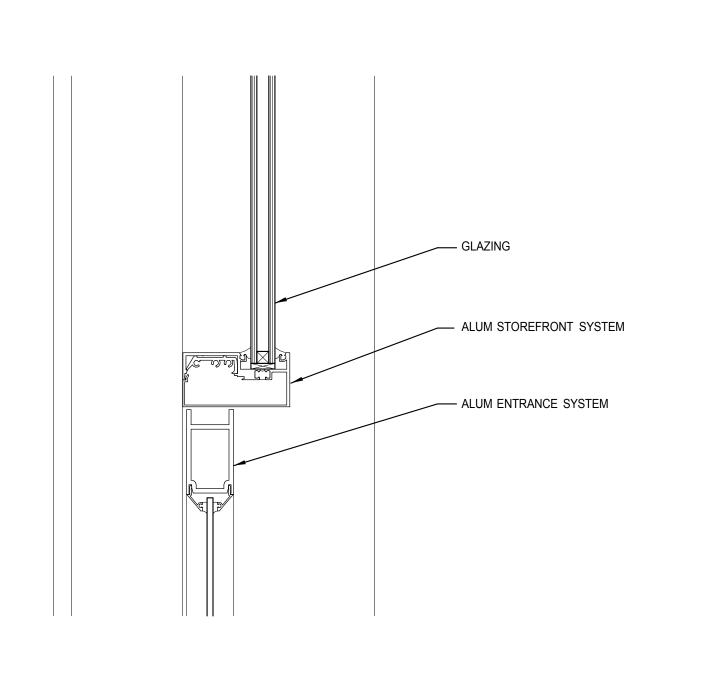

— ALUM ENTRANCE SYSTEM

ALUM STOREFRONT SYSTEM

— GLAZING

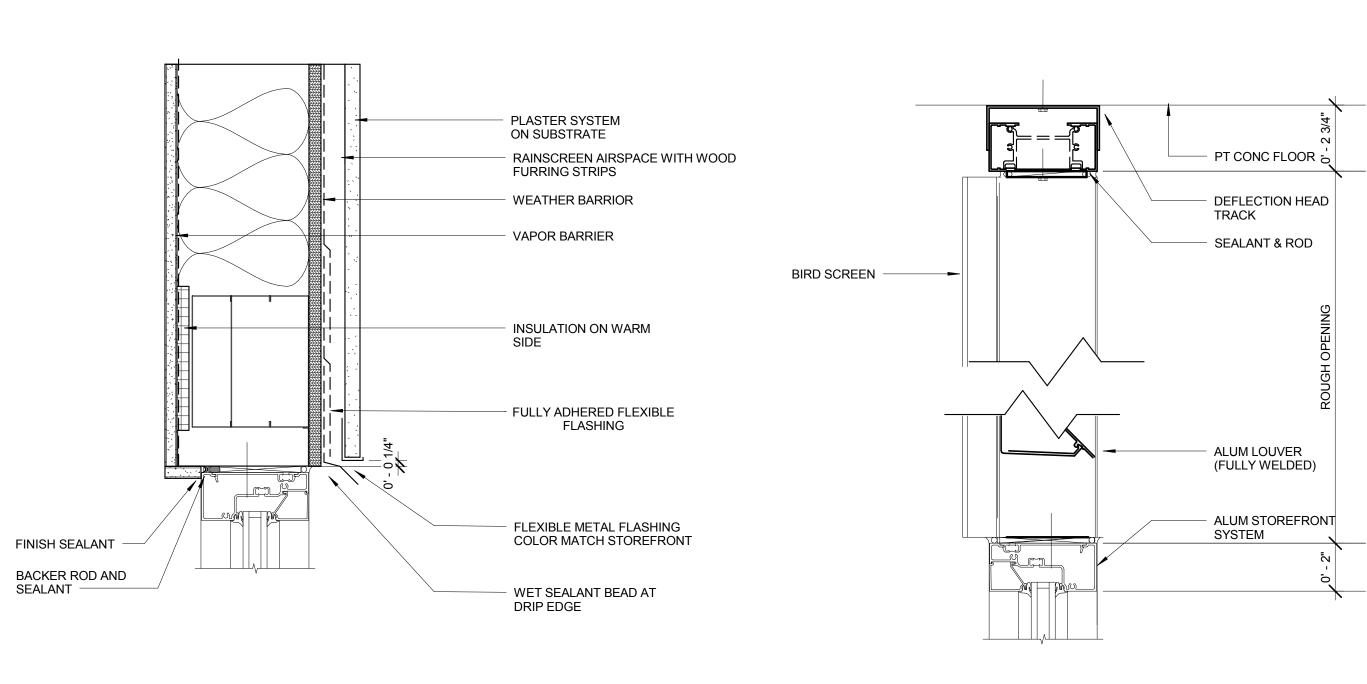

PLASTER SYSTEM ON SUBSTRATE

WEATHER BARRIER

COMPRESSED SEALANT BEAD

- SEALANT AND BACKER ROD


SHIM AS REQUIRED

GYP BOARD RETURN

VAPOR BARRIER

SEALANT

RAINSCREEN AIRSPACE WITH WOOD FURRING STRIPS

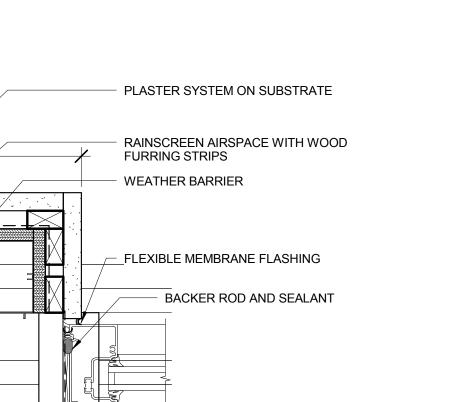

EXTERIOR

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1. STOREFRONT DOOR HEAD

SCALE: 3" = 1'-0"

SCALE: 3" = 1'-0"

2. STOREFRONT WINDOW HEAD SCALE: 3" = 1'-0"

3. LOUVER HEAD/ SILL

SCALE: 3" = 1'-0"

EXTERIOR

SCALE: 3" = 1'-0"

4. PLAN DETAIL @ STOREFRONT

2' - 6"



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STOREFRONT WINDOW SYSTEM

STOREFRONT JAMB BEYOND 1/4" HIGH ALUM THRESHOLD
 TYP- SET IN FULL BED OF MASTIC EXTERIOR CONCRETE SLAB EXPANSION JOINT EXTERIOR CONCRETE

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6. STOREFRONT DOOR JAMB

7. STOREFRONT WINDOW JAMB-GARAGE SCALE: 3" = 1'-0"

8. STOREFRONT WINDOW MULLION HORIZ SCALE: 3" = 1'-0"

STOREFRONT WINDOW SYSTEM

<u>INTERIOR</u>

SCALE: 3" = 1'-0"

9. STOREFRONT WINDOW MULLION VERTICAL

10. STOREFRONT DOOR SILL1 SCALE: 3" = 1'-0"

INTERIOR

SHEET TITLE: STOREFRONT **DETAILS**

DATE ISSUED: 1.14.2013

 PLASTER SYSTEM ON SUBSTRATE RAINSCREEN AIRSPACE WITH WOOD FURRING STRIPS - WEATHER BARRIER SEALANT AND BACKER ROD -PLY SHEATHING METAL FLASHING ON CONT. BEAD OF SEALANT FRAMING AS NEEDED CONCRETE STEM WALL **EXTERIOR** SEALANT AND BACKER ROD FUTURE TI FINISH FLEXIBLE MEMBRANE FLASHING SEALANT AND BACKER ROD — GYP RETURN


11. STOREFRONT WINDOWSILL 2

SCALE: 3" = 1'-0"

12. PLAN DETAIL @ STOREFRONT ENTRY

SCALE: 3" = 1'-0"



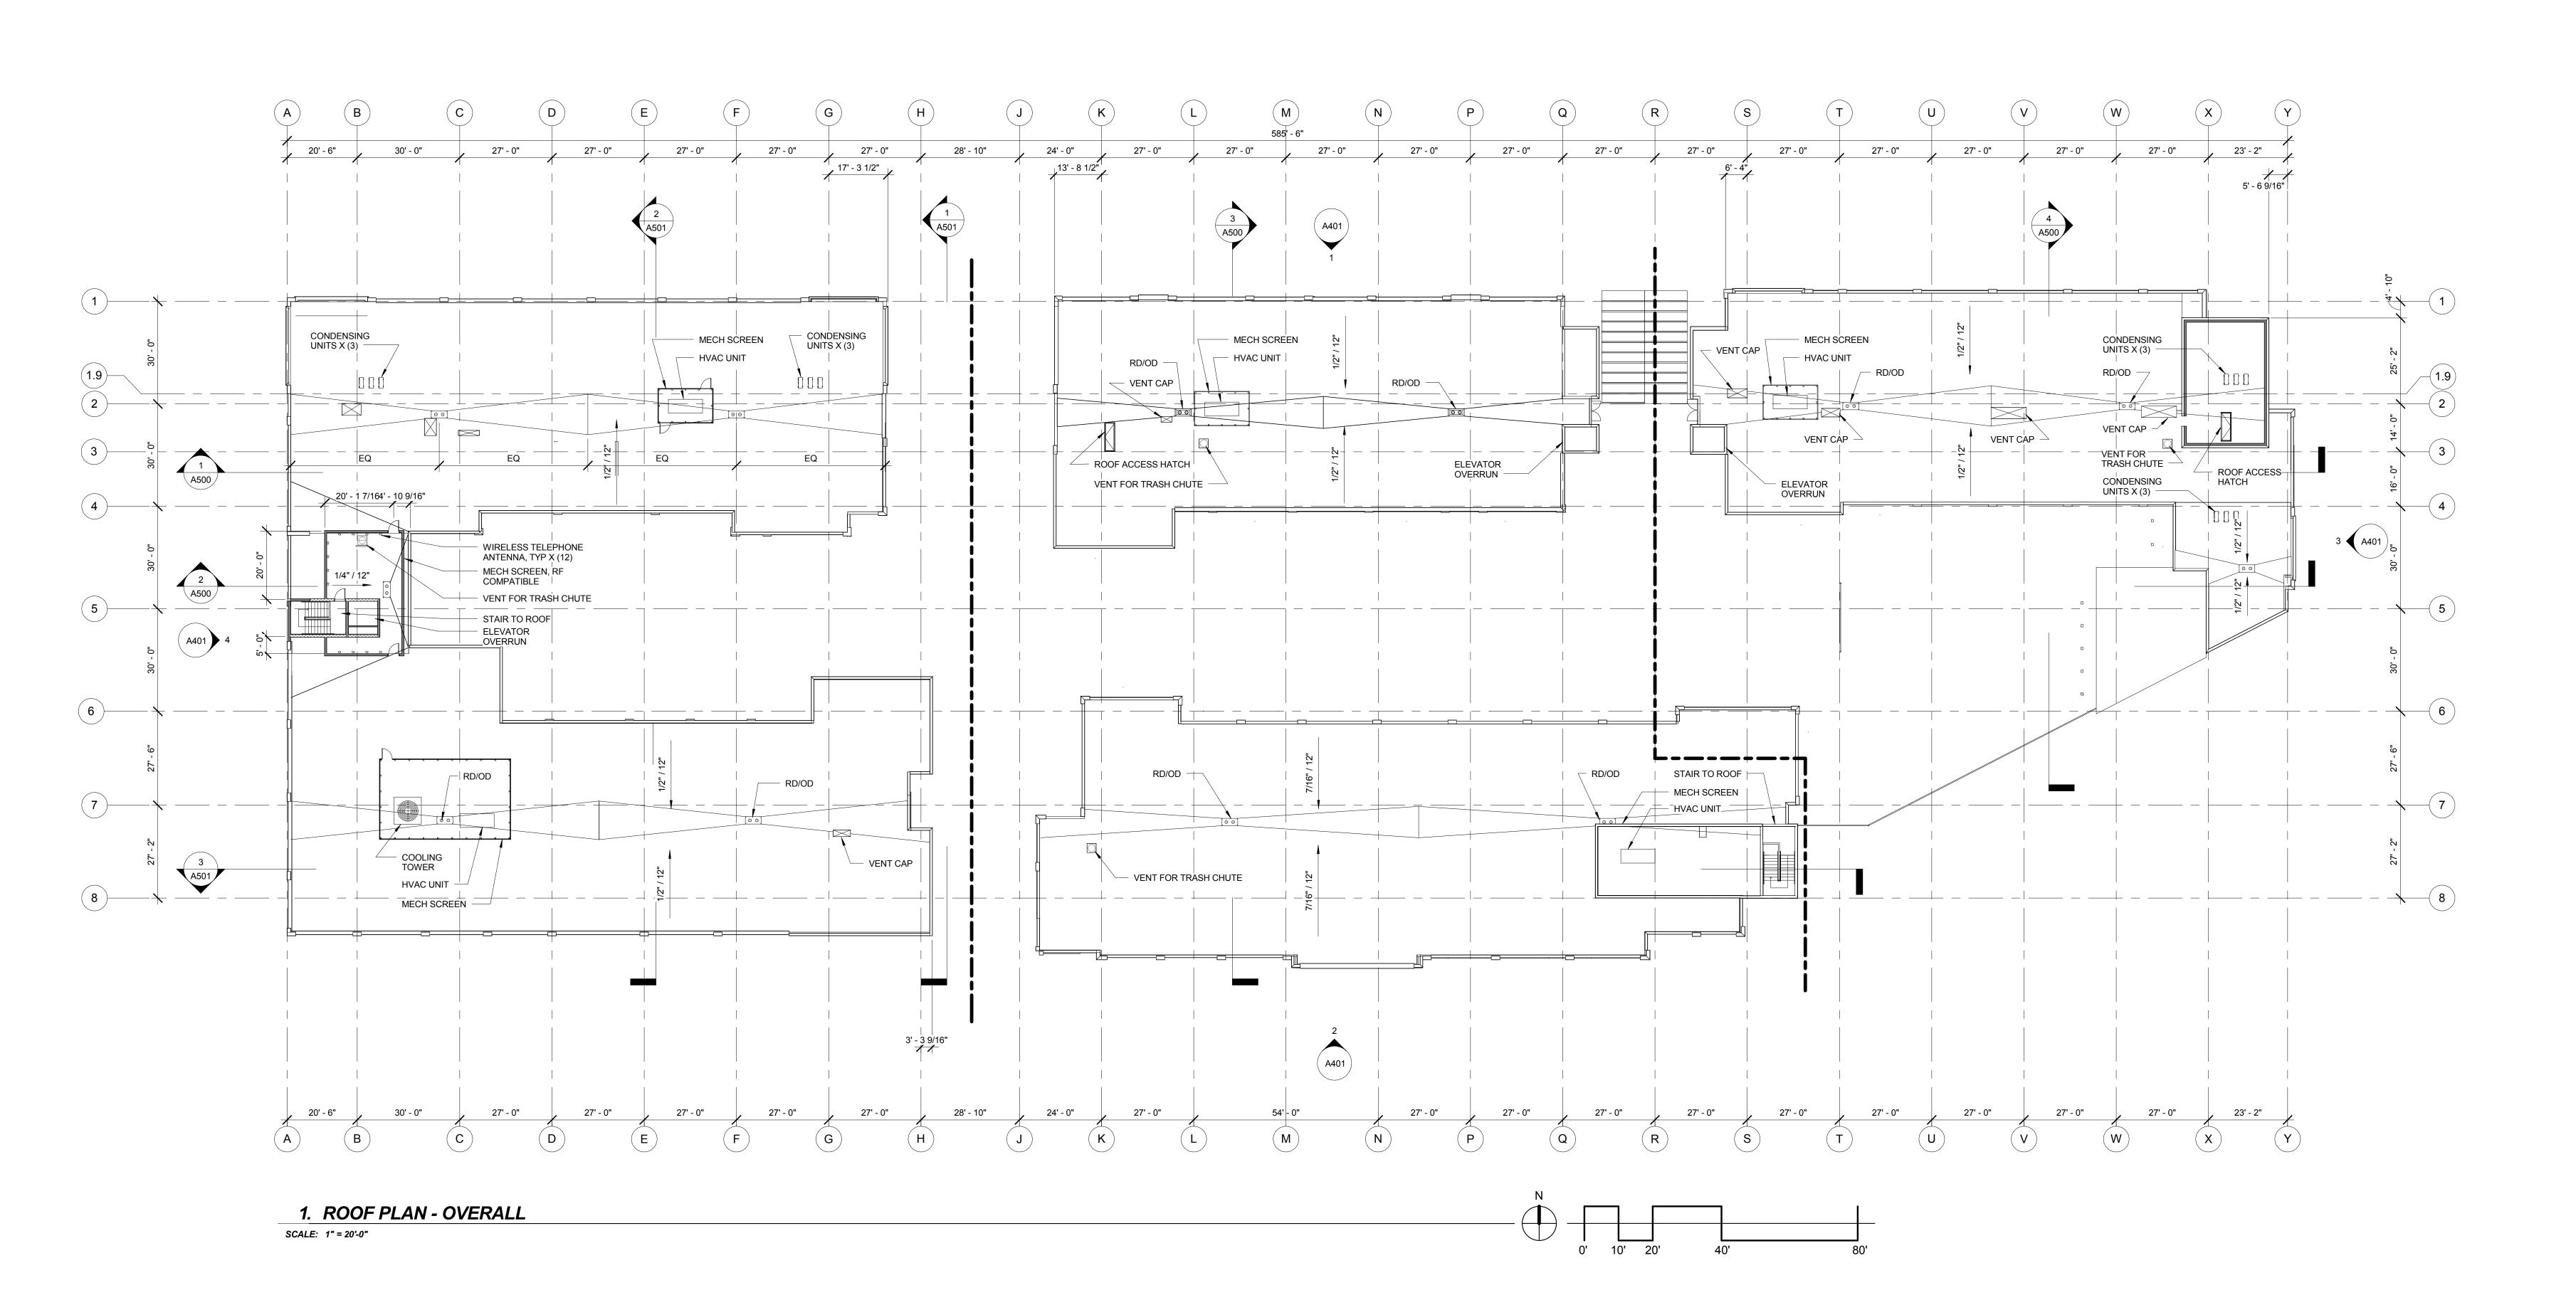

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CONSULTANT:

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ARCHITECTURE

PROJECT NUMBER:

GROUP

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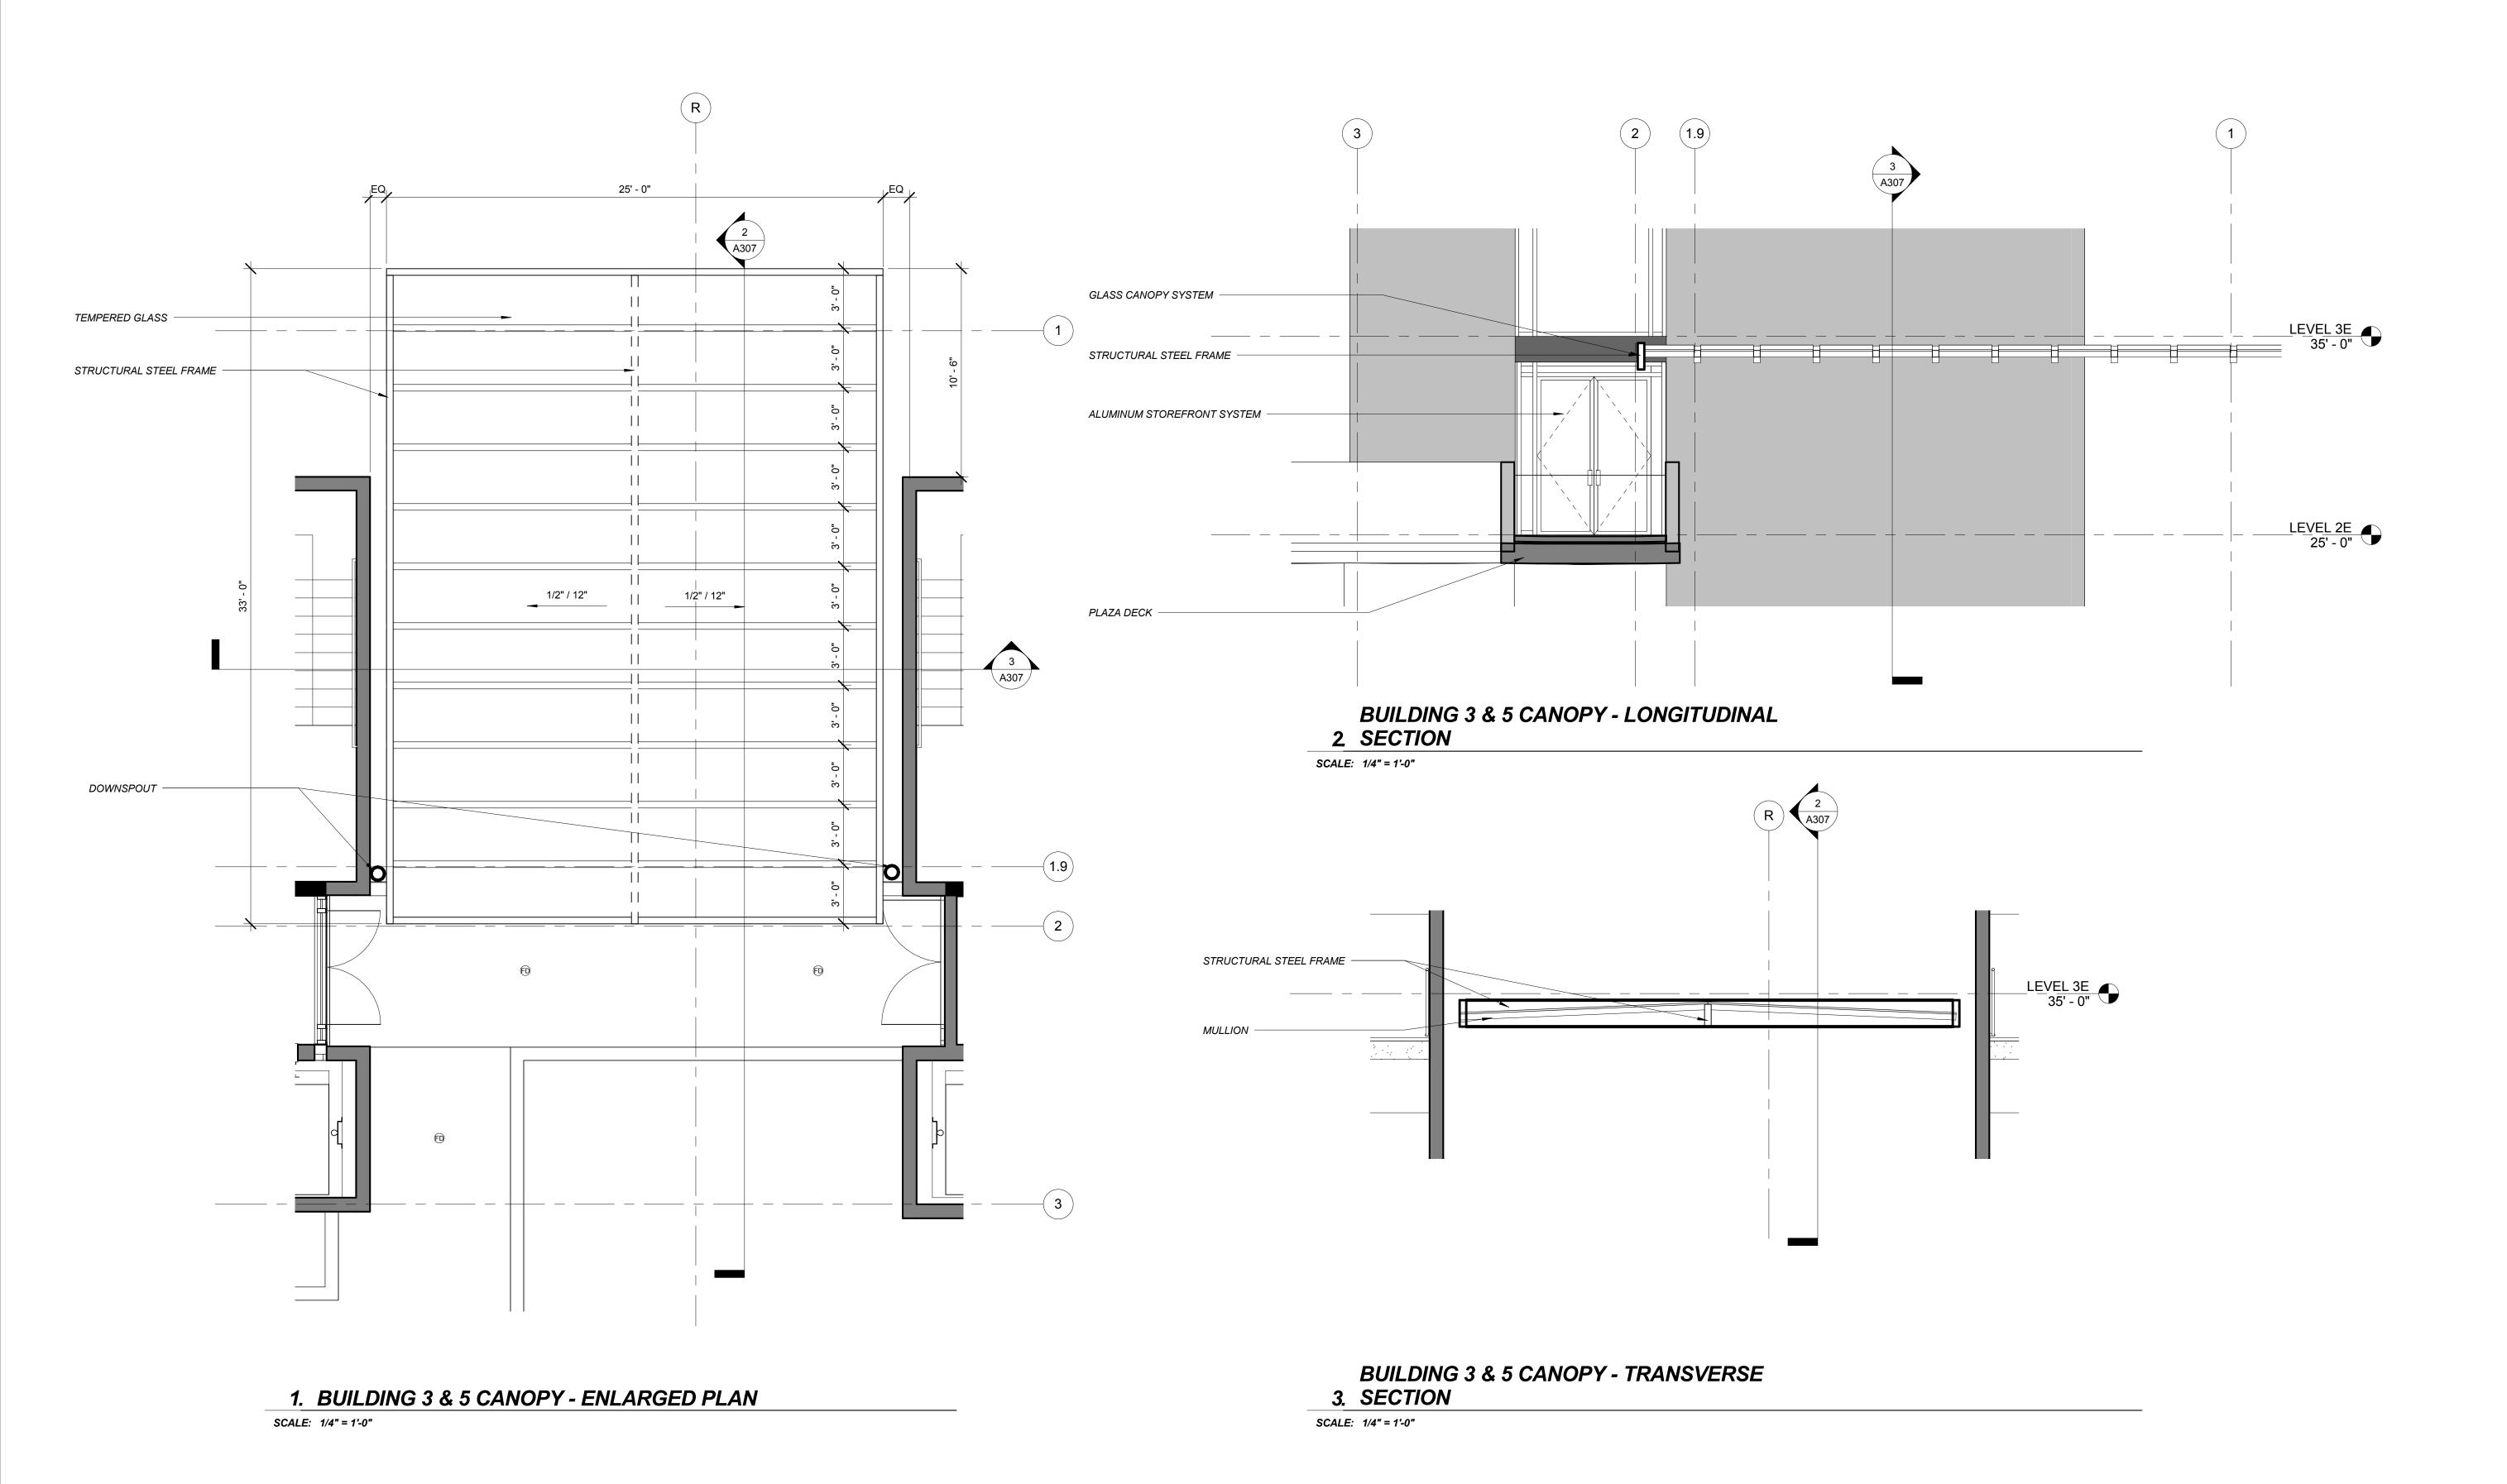
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SHEET TITLE:

ROOF PLAN

DRAWN BY: DMJ
DATE ISSUED: 1.07.2013

A301



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PROJECT NUMBER:

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SHEET TITLE:

CANOPY PLANS

AND DETAILS

DRAWN BY: Author
DATE ISSUED: 1.14.2013





OVERALL NORTH ELEVATION PERSPECTIVE

PROJECT NUMBER:

GRANT PARK VILLAGE

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EXTERIOR
OVERALL
ELEVATION
PERSPECTIVES

OVERALL SOUTH ELEVATION PERSPECTIVE

DRAWN BY: Author
DATE ISSUED: 1.14.2013

DR400



2. BUILDING 3 - NORTH


SCALE: 1/8" = 1'-0"

SHEET: DR401

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SCALE: 1/8" = 1'-0"

SCALE: 1/8" = 1'-0"

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PROJECT NUMBER:
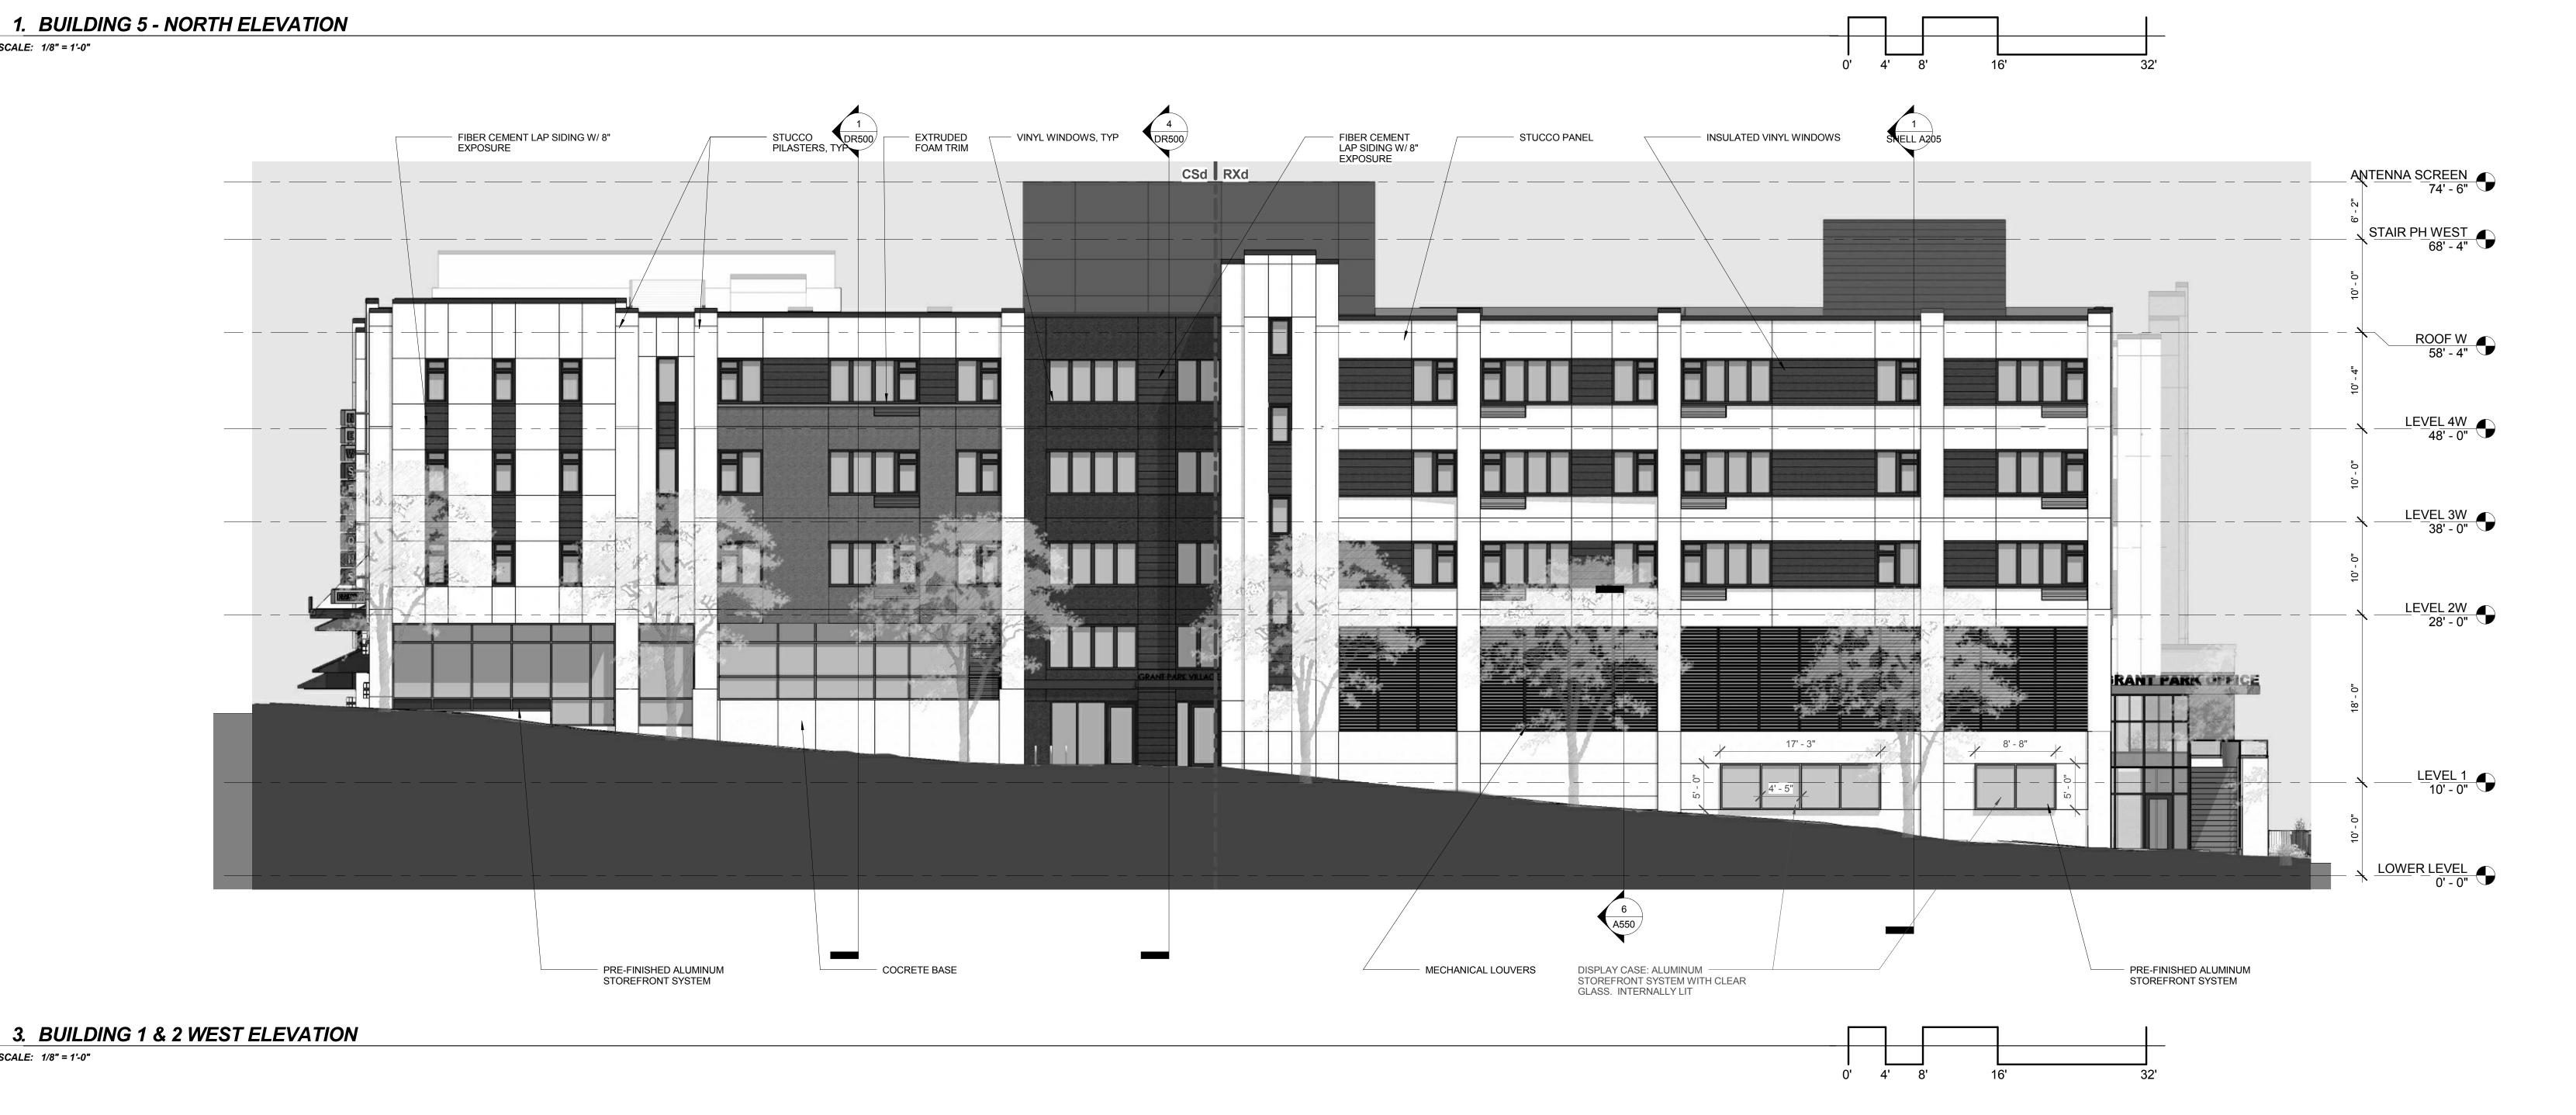
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SHEET TITLE: **EXTERIOR ELEVATIONS**

1.14.2013 DATE ISSUED:



INSULATED VINYL WINDOWS



PRELIMINARY -NOT FOR CONSTRUCTION

CONSULTANT:

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PROJECT NUMBER: 2113

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EXTERIOR ELEVATIONS

- STUCCO PANEL

STUCCO PILASTER

VINYL WINDOWS

CONCRETE BASE

LOWER LEVEL. 0' - 0"

LEVEL 1 10' - 0"

DRAWN BY: Author

DATE ISSUED: 1.14.2013

STAR PHEAST STAR P

- LOUVERS

SPANDREL GLASS

FIBER CEMENT LAP SIDING W/ 8"
EXPOSURE

SCALE: 1/8" = 1'-0"

2 BUILDING 5 EAST ELEVATION

SCALE: 1/8" = 1'-0"

PREFINISHED ALUMINUM STOREFRONT SYSTEM


3. ENLARGED ELEVATION BLDG 4 SOUTH

SCALE: 1/4" = 1'-0"

PAINTED METAL RAILING@ PRIVATE STOOPS

DR403



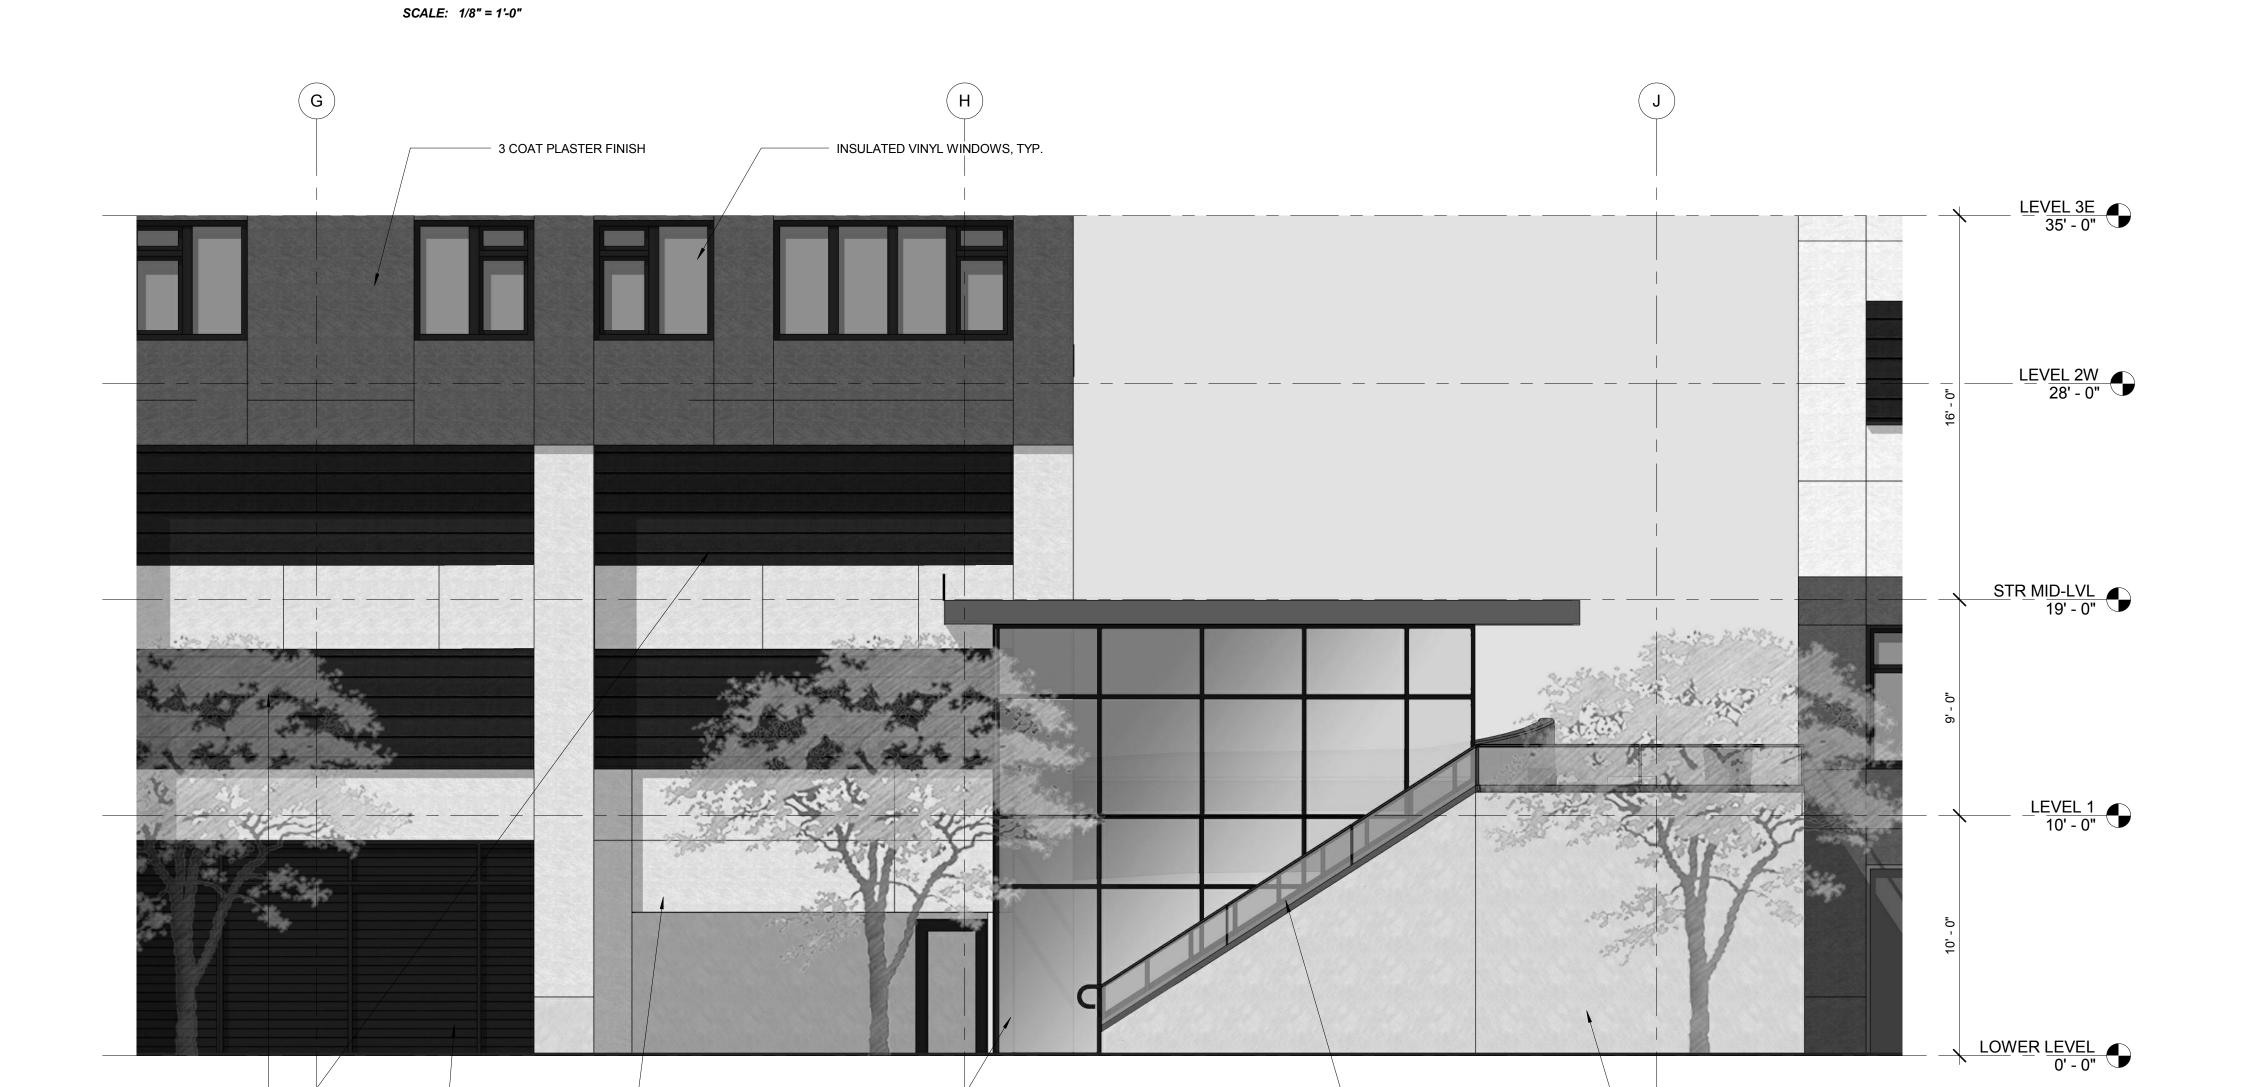

- ALUMINUM STORE FRONT SYSTEM

GLASS RAILING

CONCRETE


1. BUILDING 2 SOUTH ELEVATION

3 COAT PLASTER FINISH

FIBER CEMENT LAP SIDING W/ 8" EXPOSURE

2. Elevation 1 - a

SCALE: 1/4" = 1'-0"

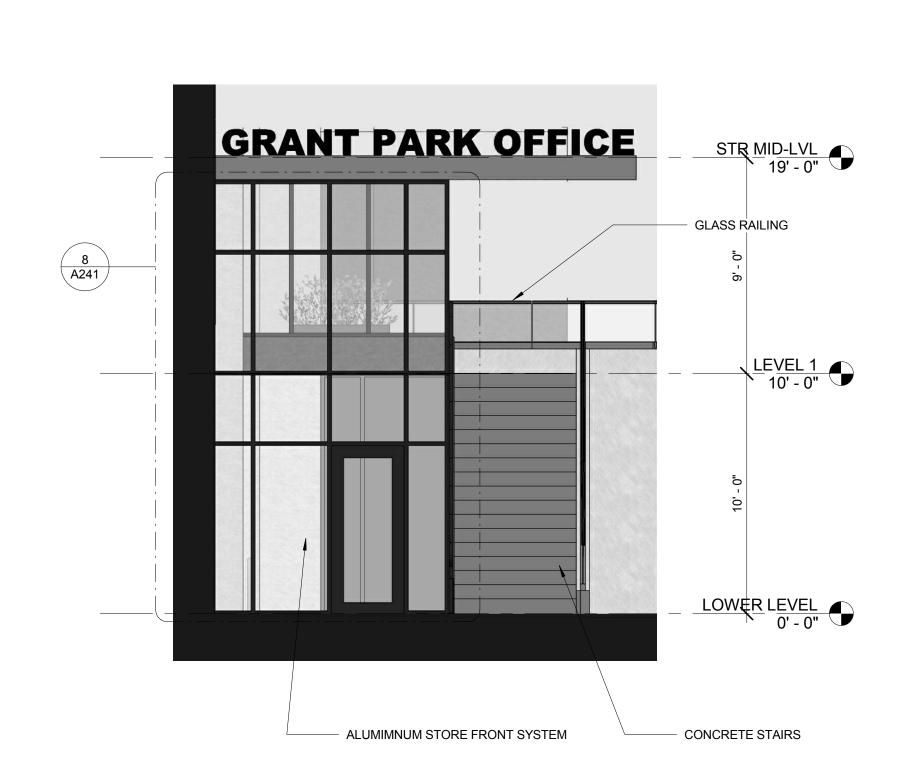

3. Elevation 2 - a

SCALE: 1/4" = 1'-0"

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CONSULTANT:

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PROJECT NUMBER:


GRANT PARK VILLAGE


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EXTERIOR
ELEVATIONS

DRAWN BY: DMJ
DATE ISSUED: 1.14.2013

DR404



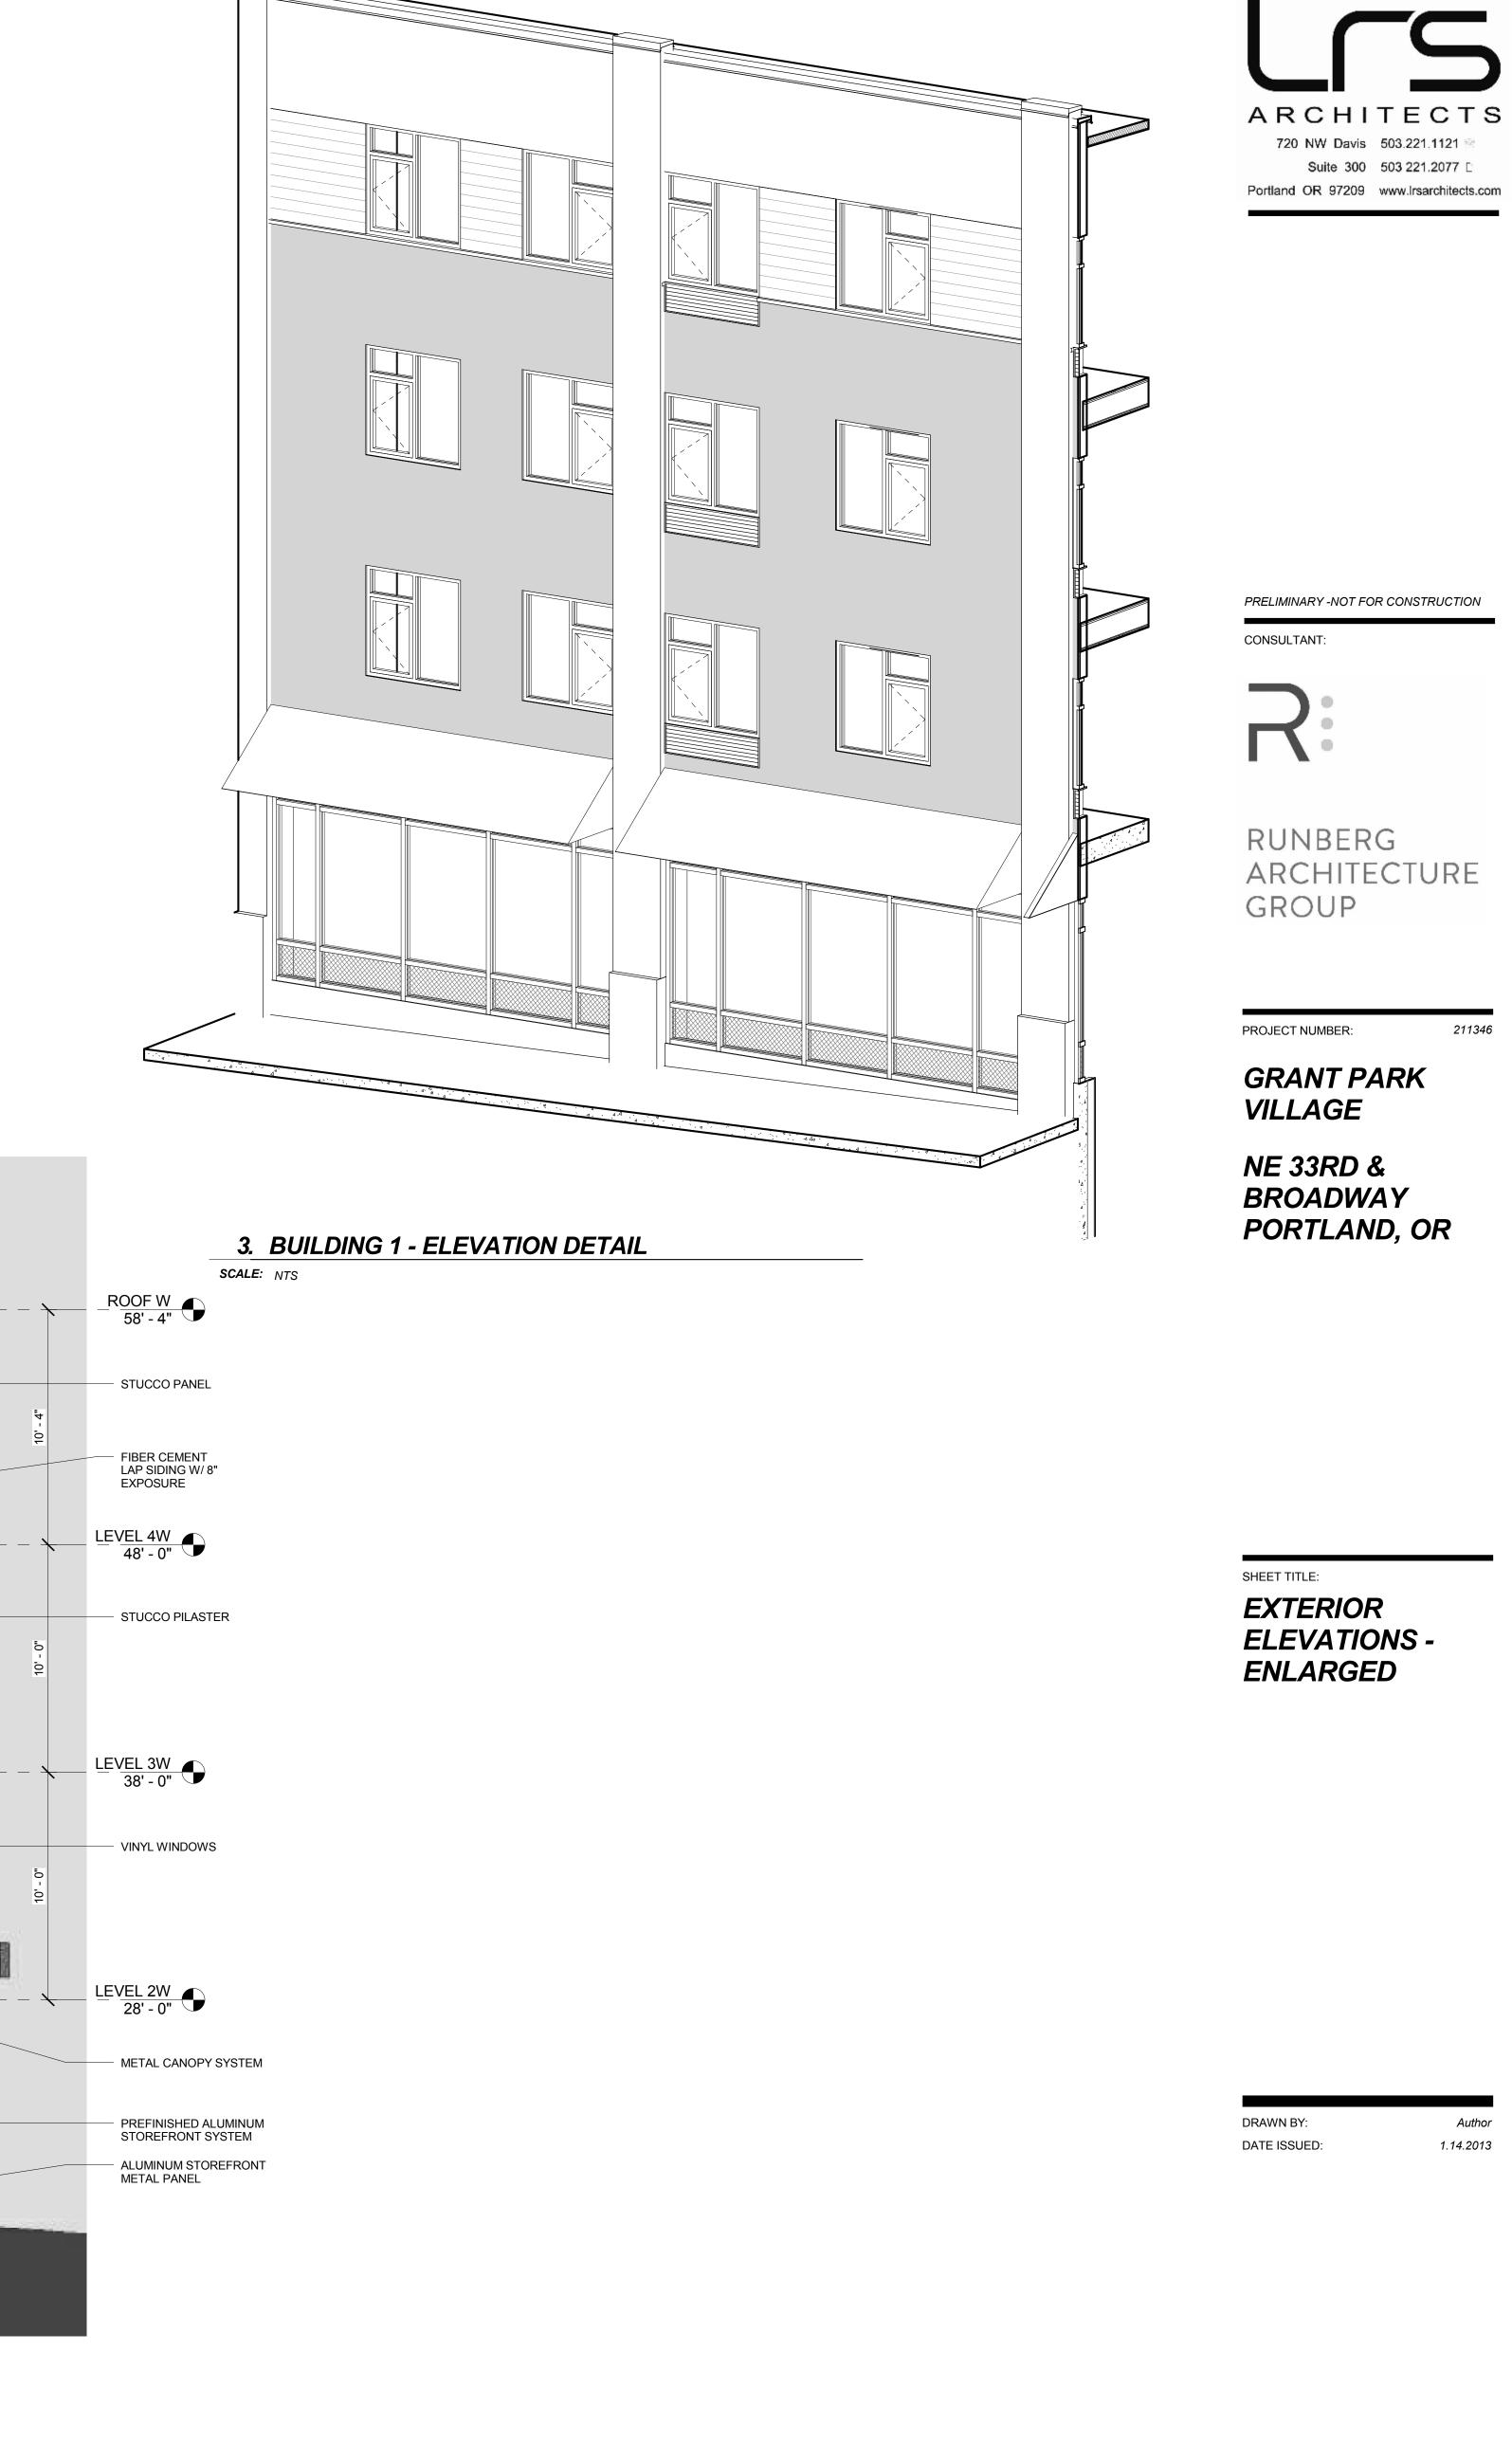

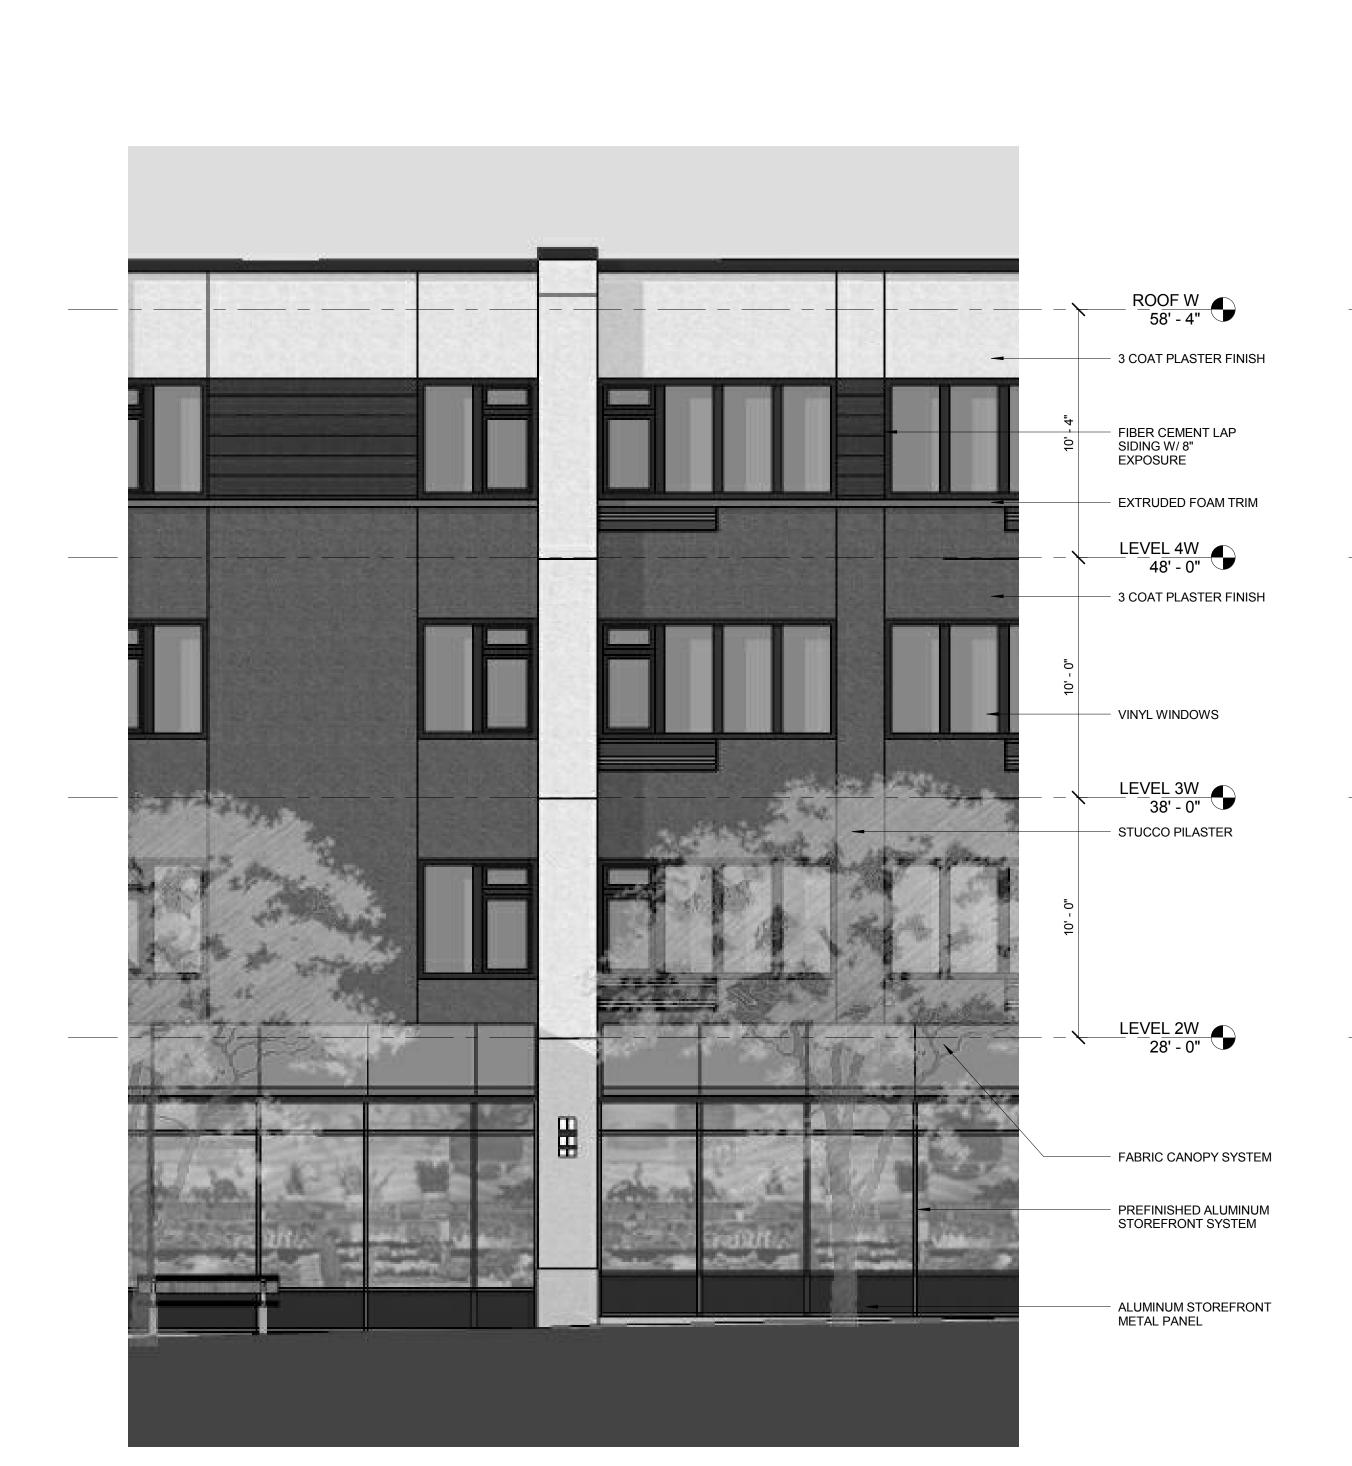1. BUILDING 1 - ENLARGED NORTH ELEVATION

SCALE: 1/4" = 1'-0"

Locally Owned and Operated


2. BUILDING 1 - ENLARGED NORTH ELEVATION SCALE: 1/4" = 1'-0"

DR405

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PARAPET E 57' - 8"

LEVEL 4E 45' - 0"

LEVEL 3E 35' - 0"

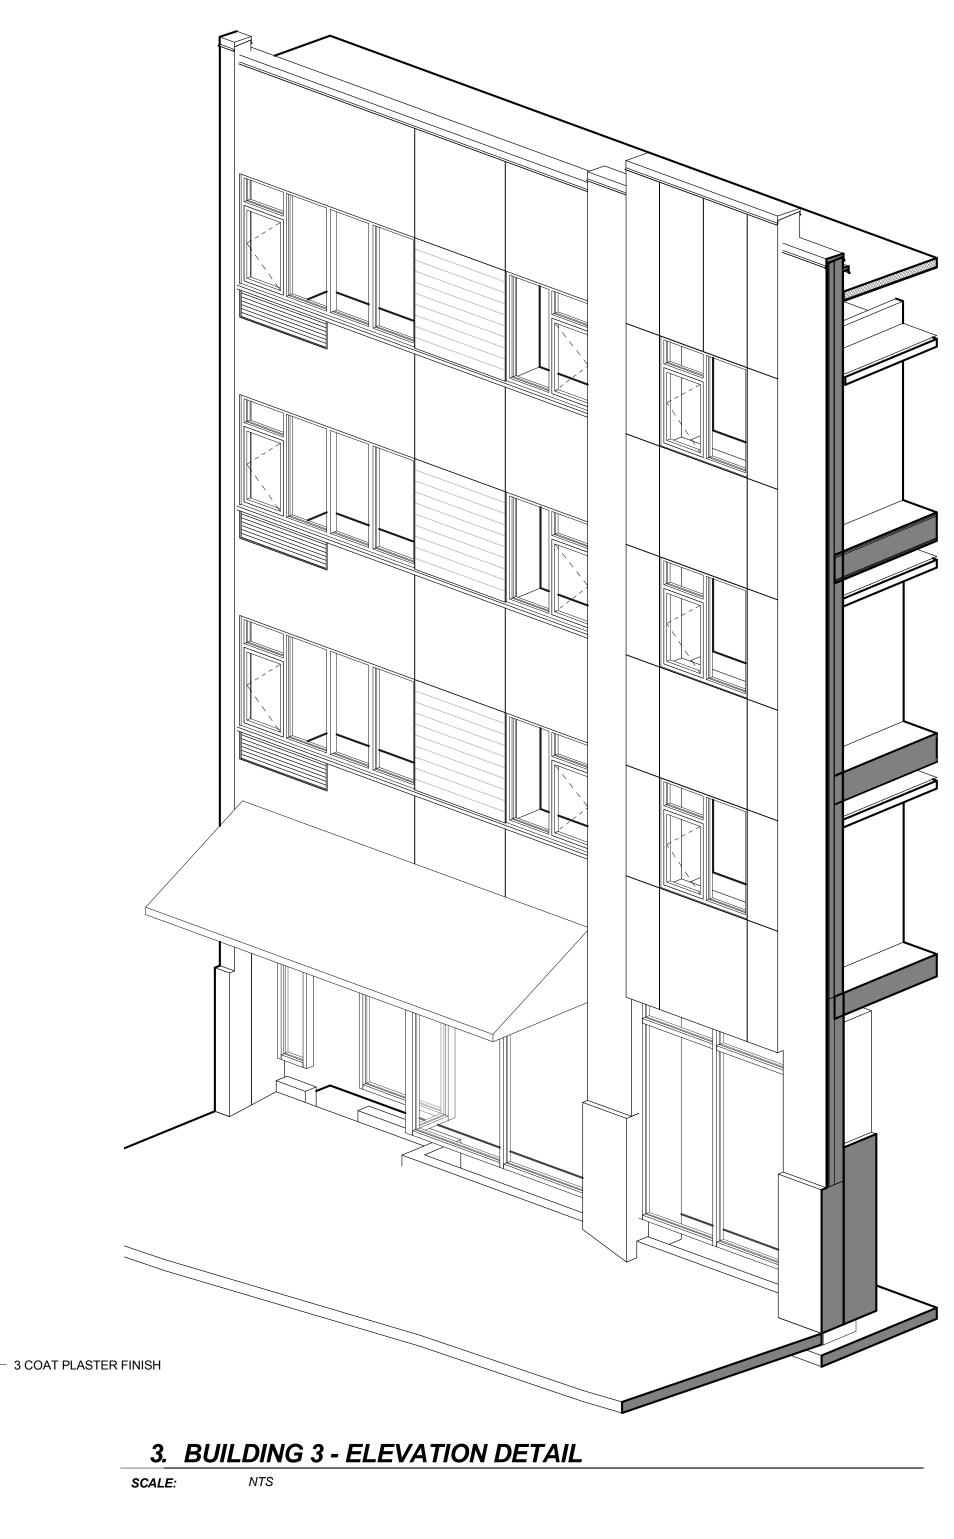LEVEL 2E 25' - 0"

ALUMINUM CANOPY SYSTEM
WITH STRUCTURALLY GLAZED
GLASS SUPPORTED BY PAINTED
STEEL STRUCTURE

EXTRUDED FOAM TRIM

- VINYL WINDOWS, TYP

- FABRIC CANOPY SYSTEM

- GLASS WATER VEIL IN PAINTED METAL FRAME

PREFINISHED ALUMINUM STOREFRONT SYSTEM

LANDSCAPE SEAT
 WALL-BRICK VENEER
 WITH PRECAST
 CONCRET CAP

CONCRETE BASE

FIBER CEMENT LAP SIDING W/ 8" EXPOSURE

- 3 COAT PLASTER FINISH PILASTER

ROOF E 55' - 4"



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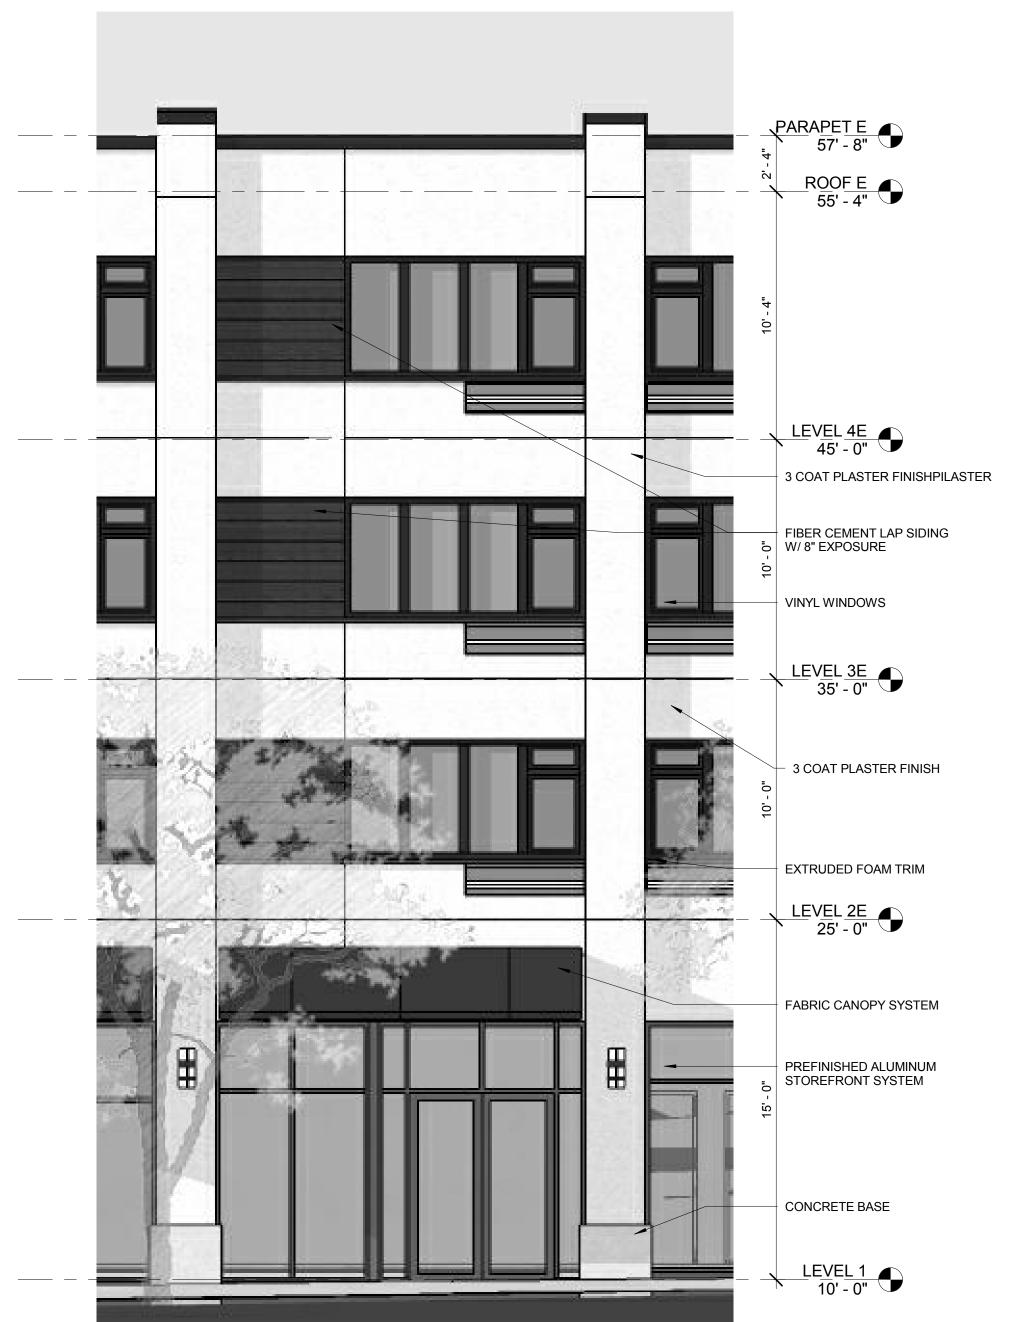
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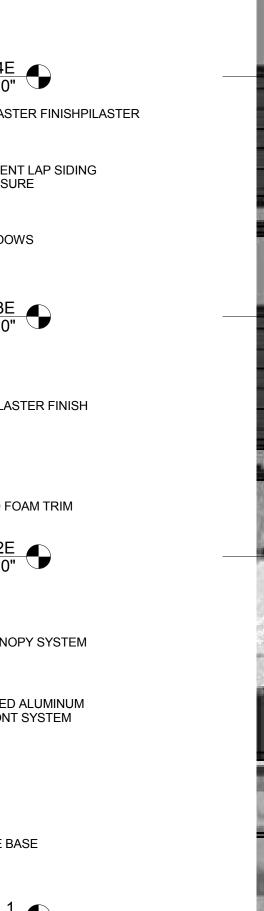
SHEET TITLE: **EXTERIOR ELEVATIONS** -

ENLARGED

DATE ISSUED: 1.14.2013

2. BUILDING 3 & 5 - ENLARGED ELEVATION





1. BUILDING 3 - ENLARGED NORTH ELEVATION

SCALE: 1/4" = 1'-0"

DR406





CONSULTANT:



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PROJECT NUMBER:

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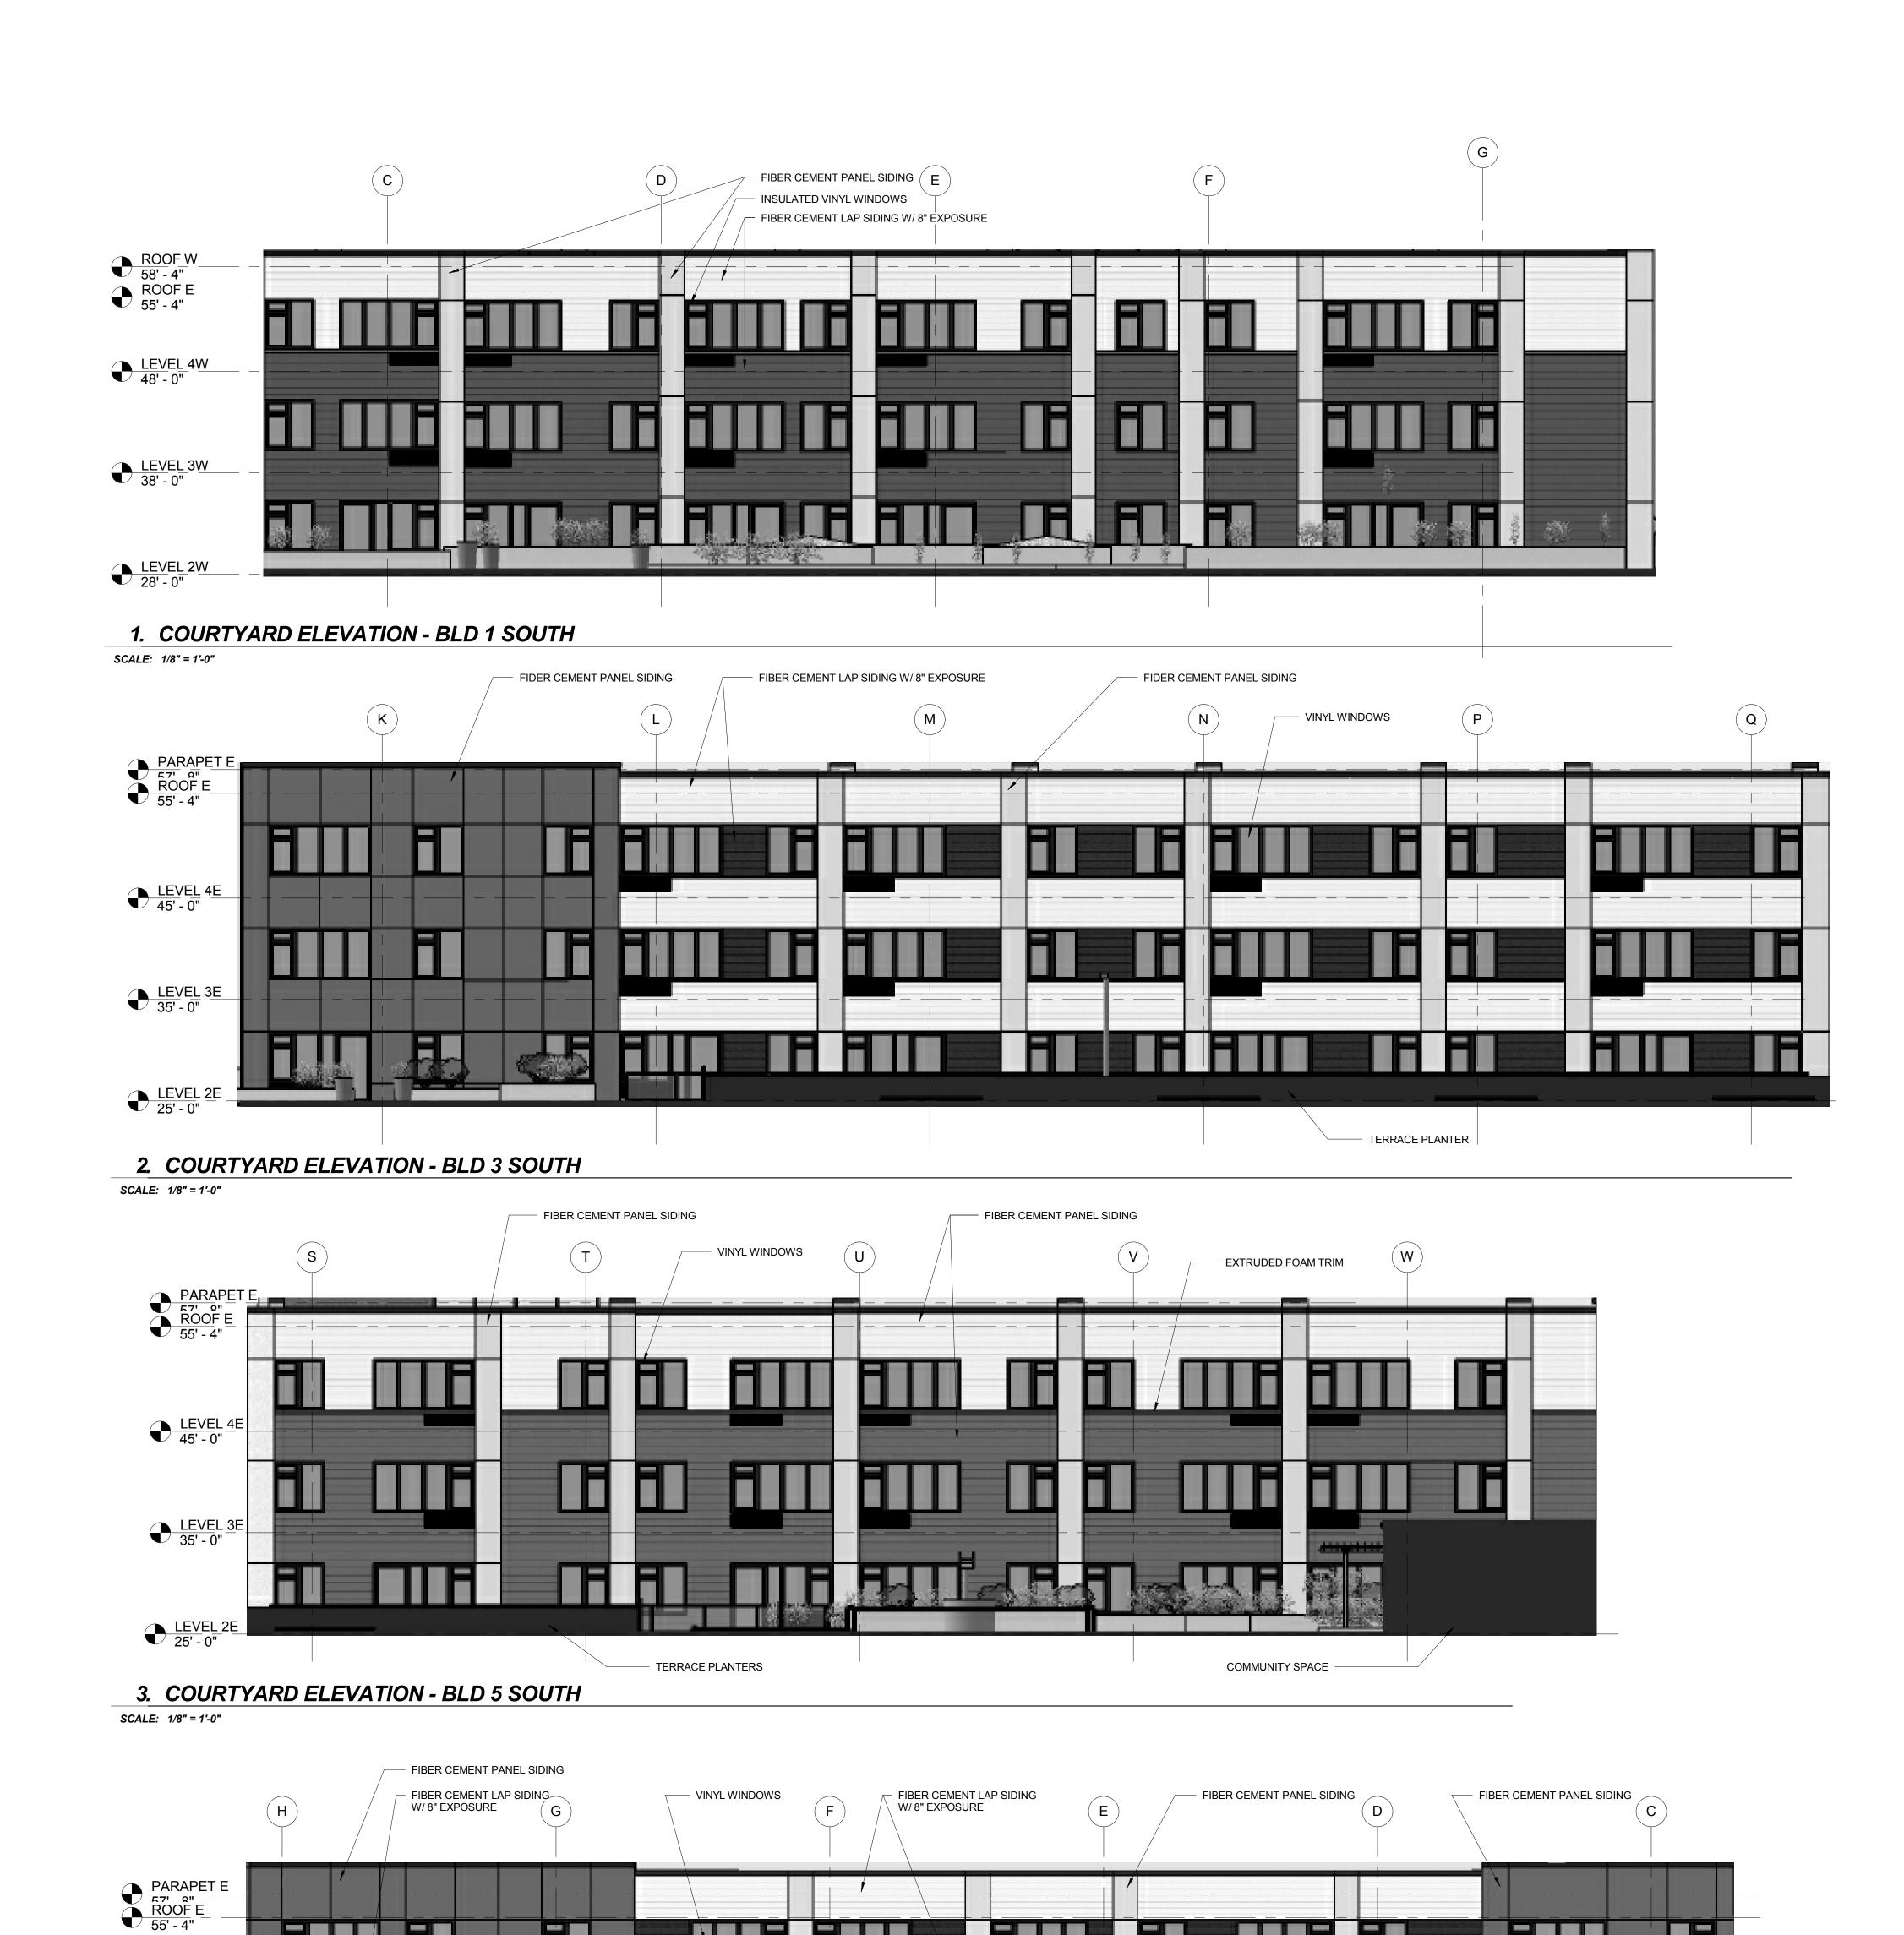
SHEET TITLE:

COURTYARD ELEVATIONS

DRAWN BY:
DATE ISSUED:

1.14.2013

DR407



4. COURTYARD ELEVATION - BLD 2 NORTH

SCALE: 1/8" = 1'-0"

LEVEL 4W _

LEVEL 3W ______





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GROUP

PROJECT NUMBER:

GRANT PARK VILLAGE

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SHEET TITLE: COURTYARD

ELEVATIONS

DATE ISSUED:

DR408

CELL TOWER ENCLOSURE BEYOND FIBER CEMENT PANEL FIBER CEMENT LAP **EXPOSURE** INSULATED VINYL WINDOWS, TYP LEVEL 4W 48' - 0" LEVEL 3W 38' - 0" LEVEL 2W _ 28' - 0"


2 COURTYARD ELEVATION BLD 1-2 EAST

5. COURTYARD ELEVATION - BLD 3 WEST

SCALE: 1/8" = 1'-0"

SCALE: 1/8" = 1'-0"



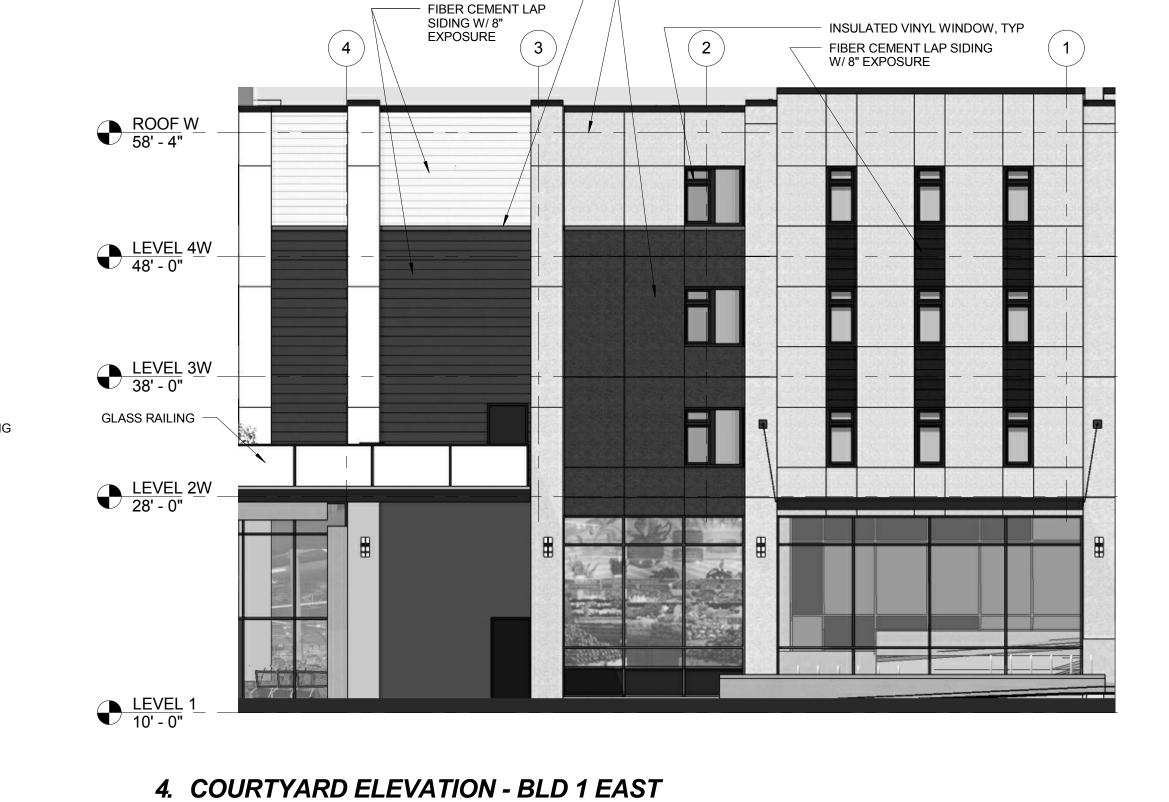


SCALE: 1/8" = 1'-0"

- EXTRUDED FOAM TRIM

- 3 COAT PLASTER FINISH

3. COURTYARD ELEVATION - BLD 2 EAST SCALE: 1/8" = 1'-0"

- INSULATED VINYL WINDOW, TYP 4 FIBER CEMENT LAP SIDING W/8" EXPOSURE FIBER CEMENT PANEL PARAPET E 57' 9" ROOF E 55' - 4" LEVEL 4E 45' - 0" LEVEL 3E 35' - 0" LEVEL 2E 25' - 0"

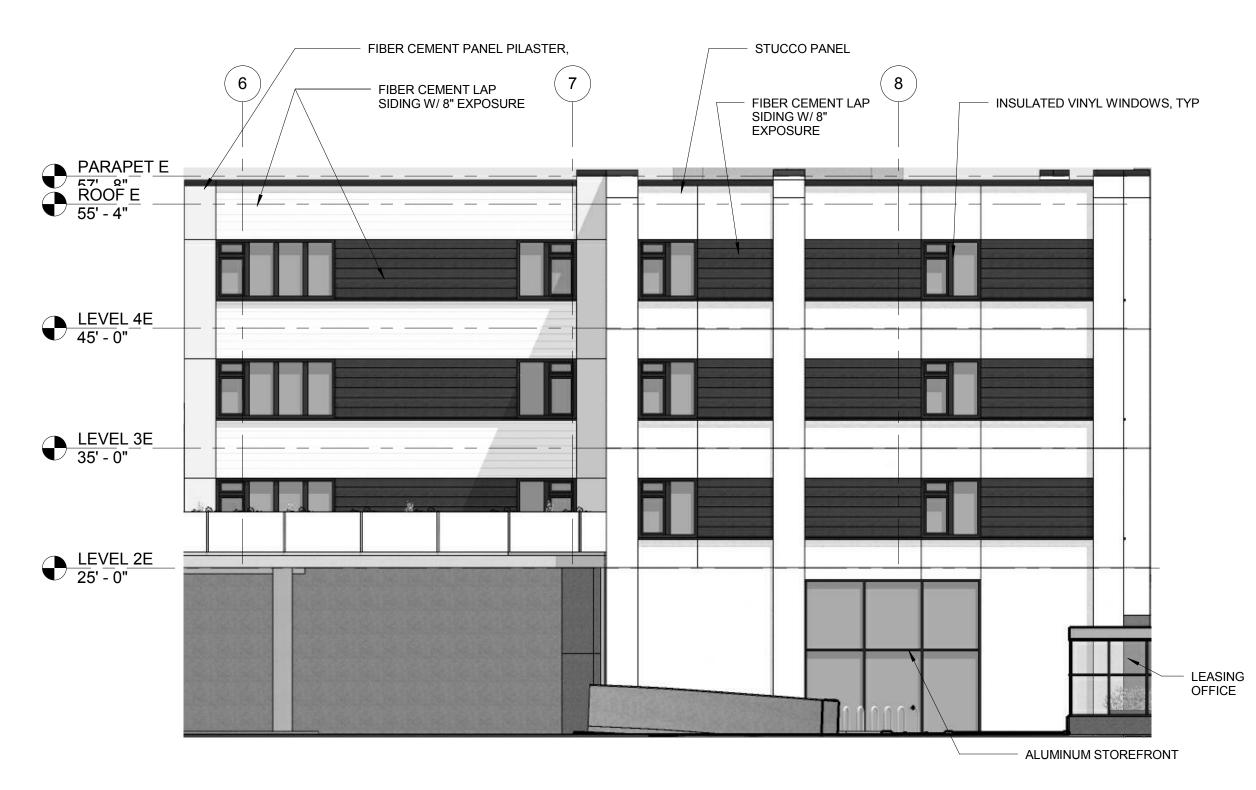


 3 COAT PLASTER
 SYSTEM INSULATED VINYL WINDOW, TYP PARAPET E 57' - 8" ROOF E 55' - 4" LEVEL 4E 45' - 0" TIMBER TRELLIS LEVEL 3E 35' - 0"


6. COURTYARD ELEVATION - BLD 4 WEST


SCALE: 1/8" = 1'-0"


7. COURTYARD ELEVATION - BLD 5 WEST SCALE: 1/8" = 1'-0"

1.14.2013

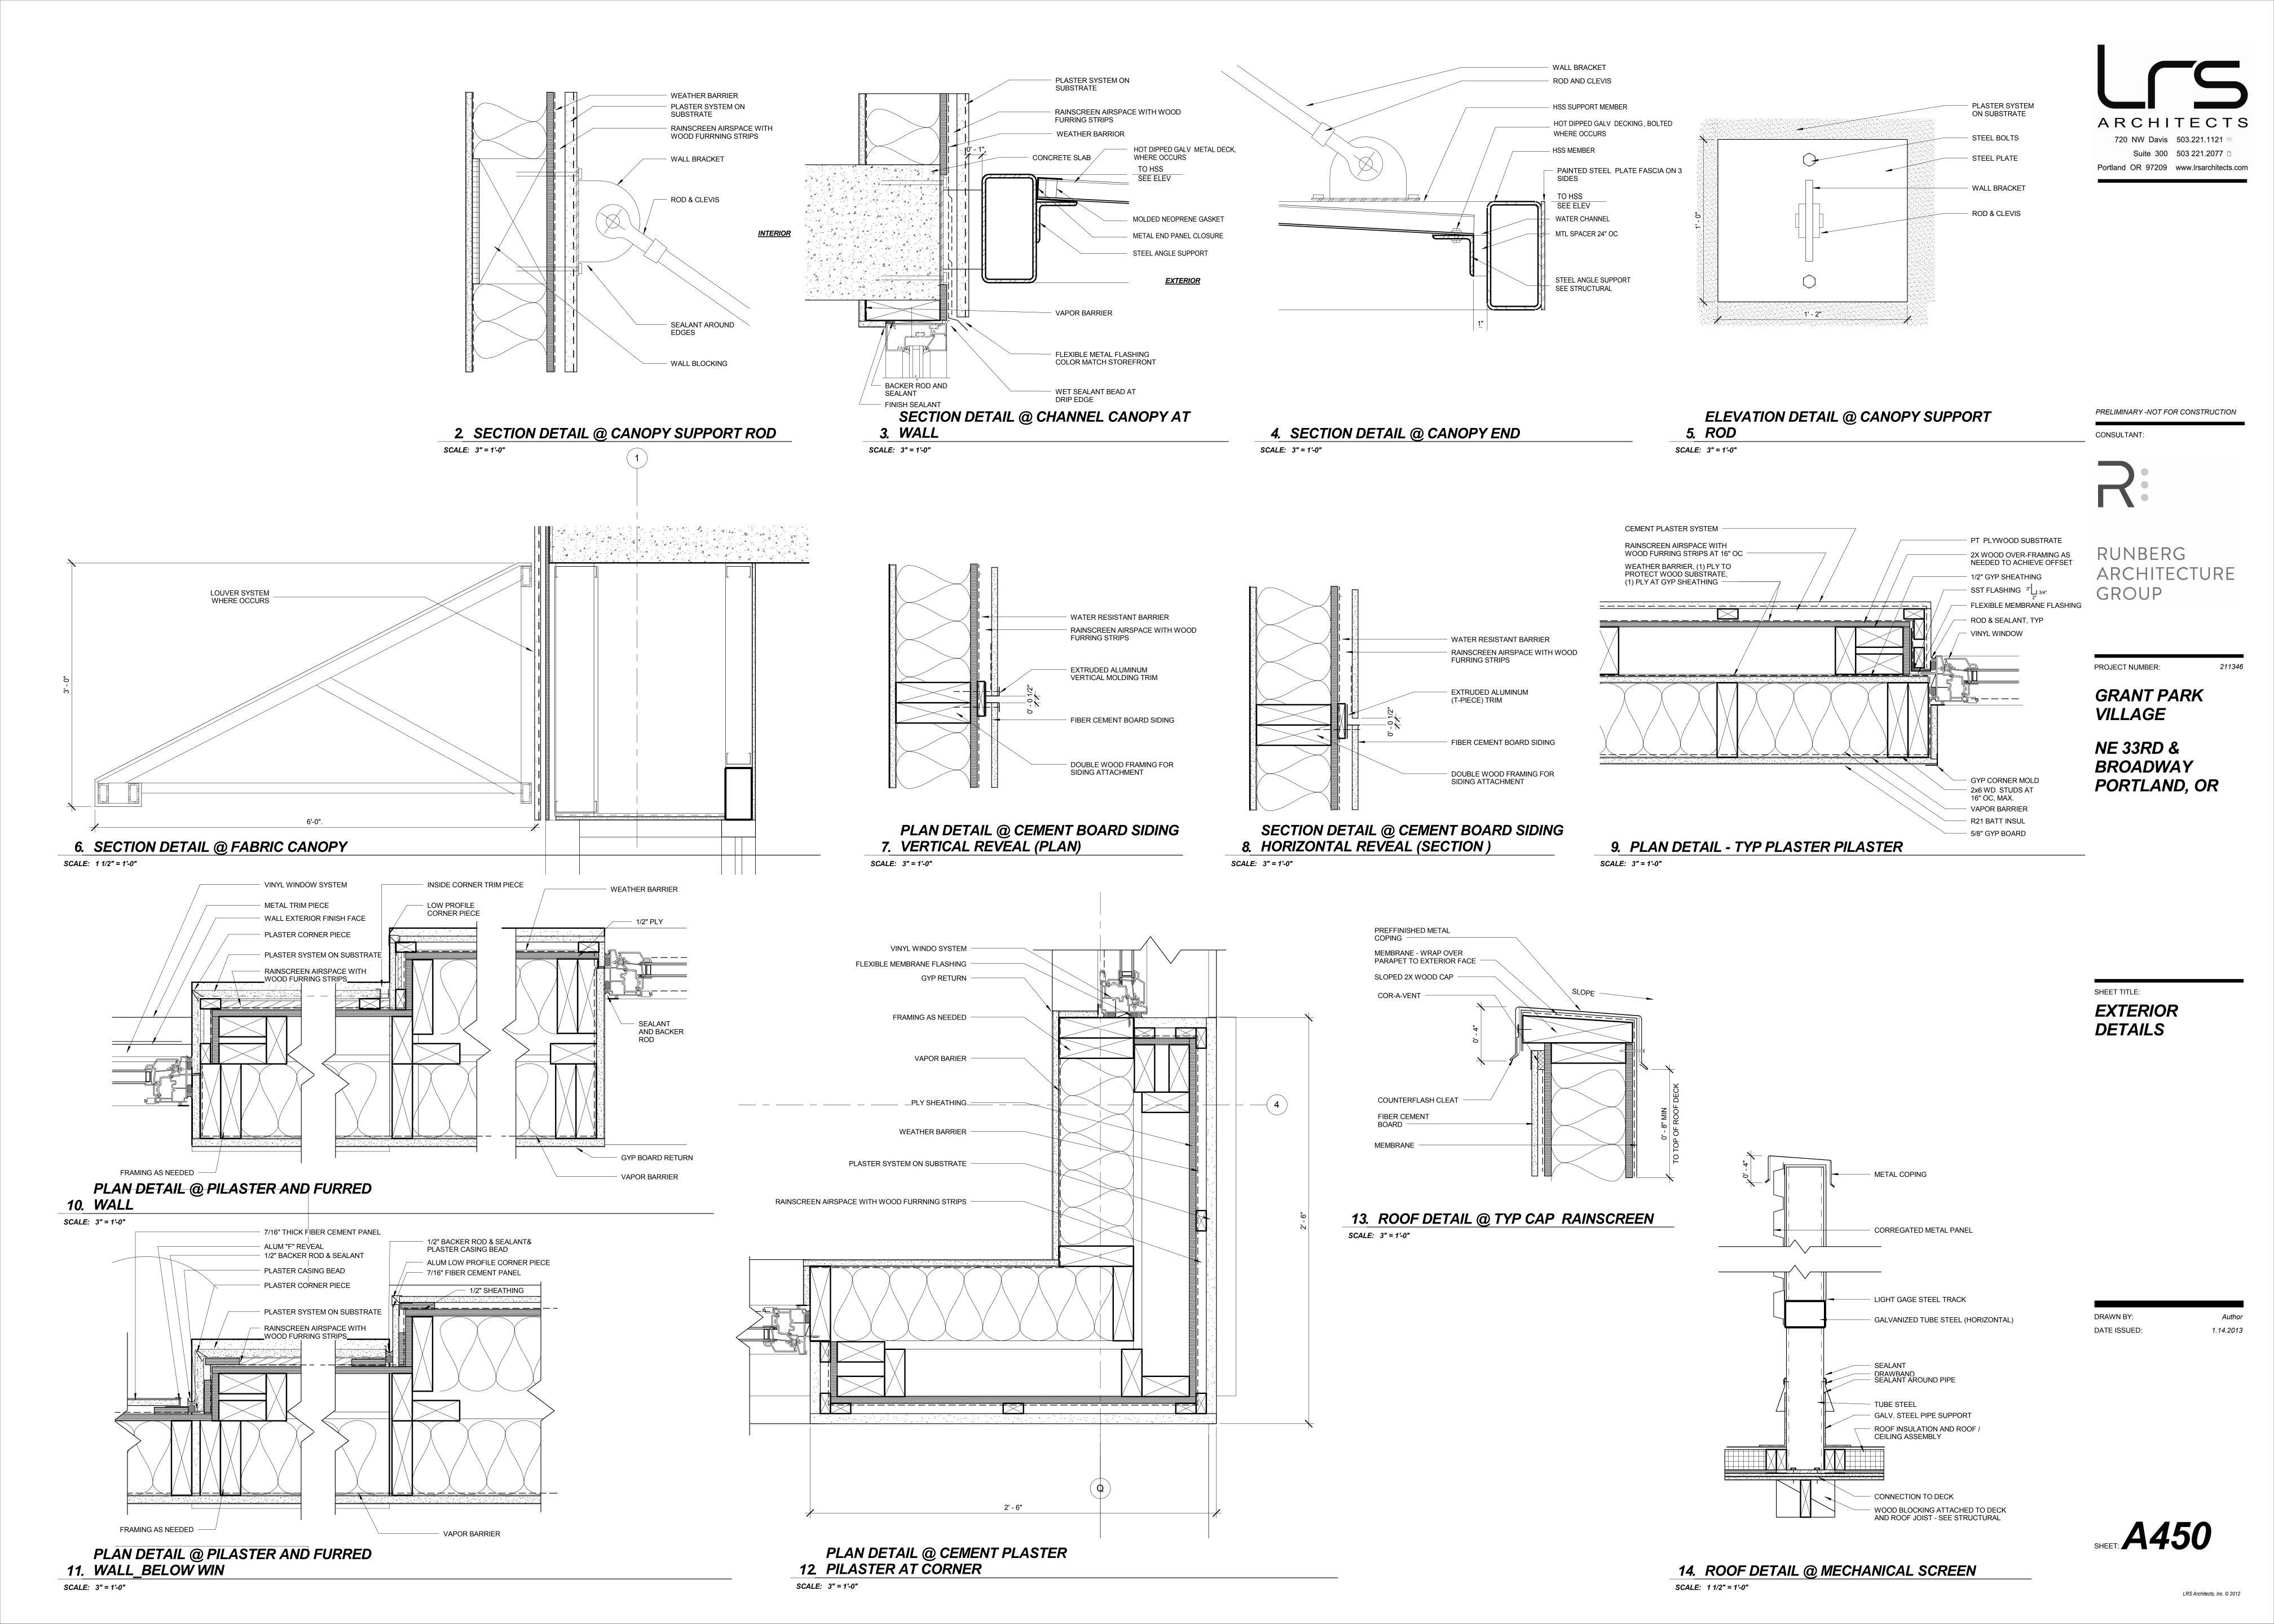

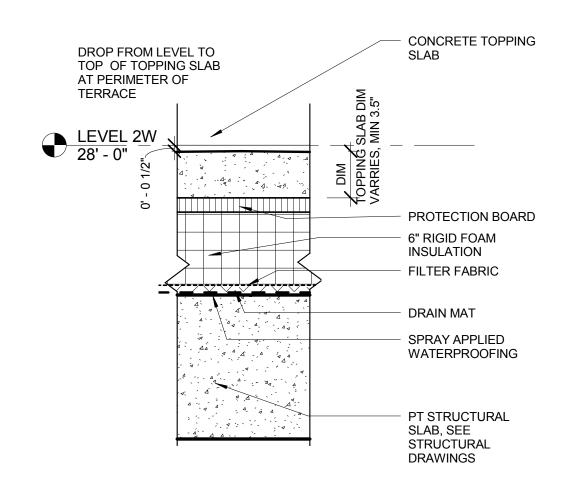


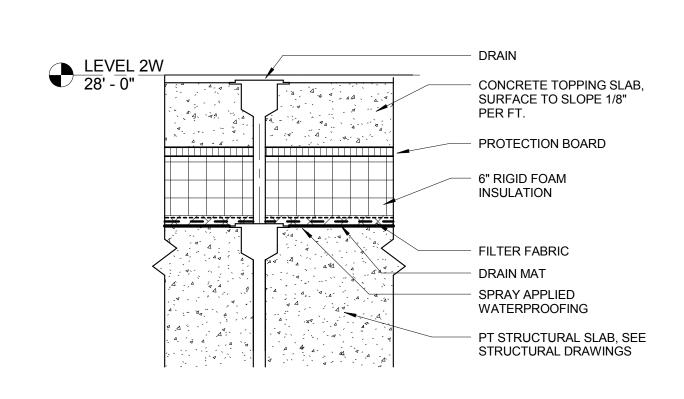

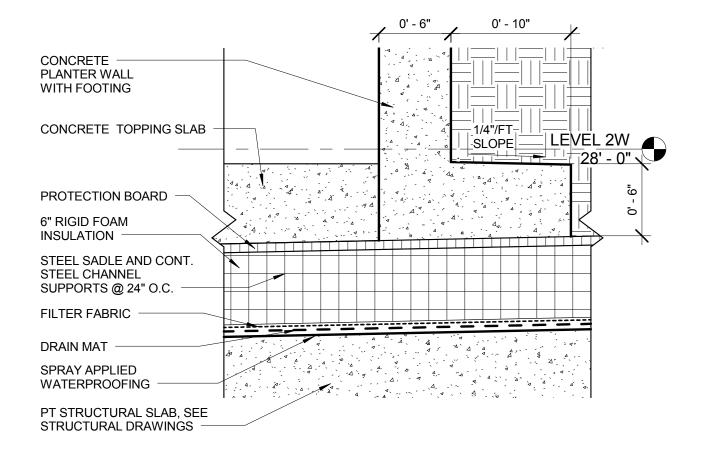




SCALE: 1 1/2" = 1'-0"

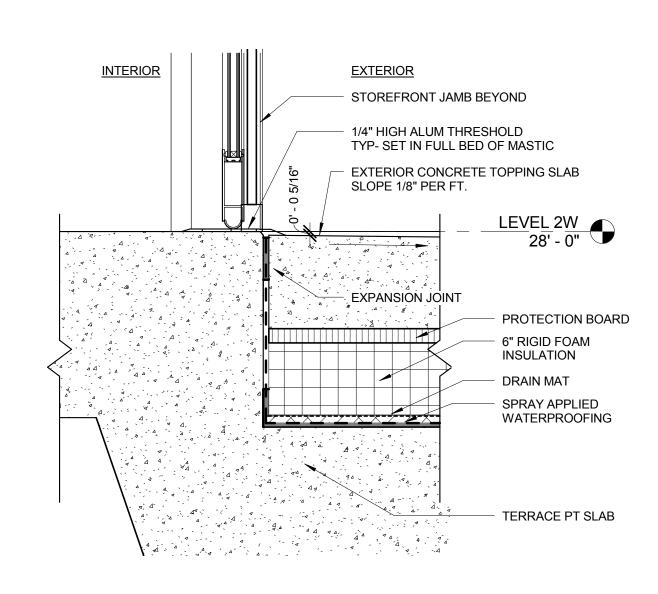





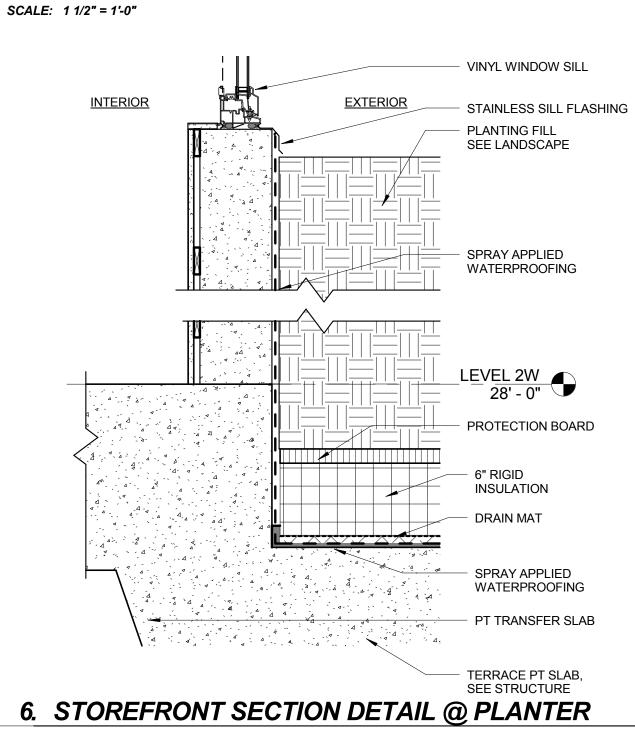



3. EDGE

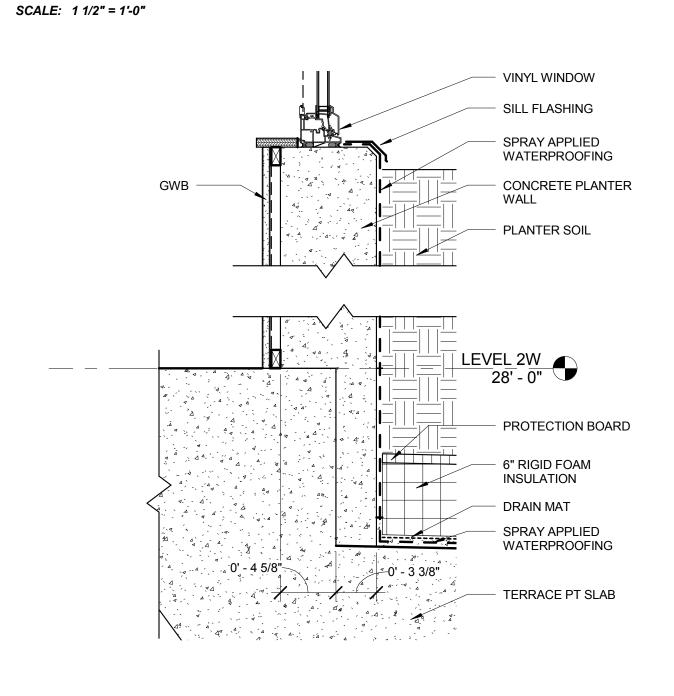

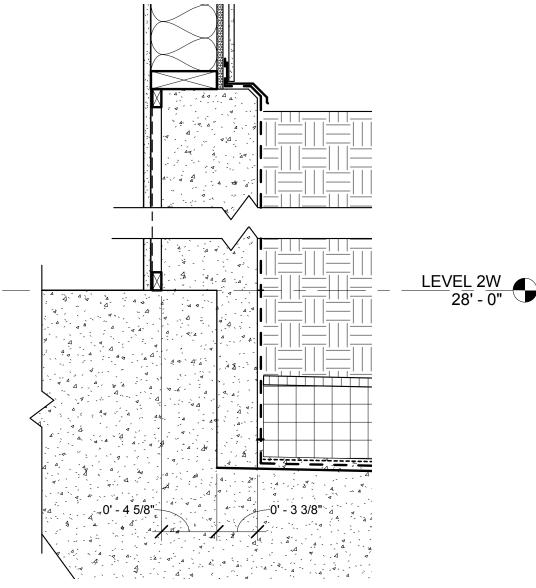


SCALE: 1 1/2" = 1'-0"



SCALE: 1 1/2" = 1'-0"

7. EXTERIOR WALL @ PLANTER & WINDOW

8. EXTERIOR WALL @ PLANTER

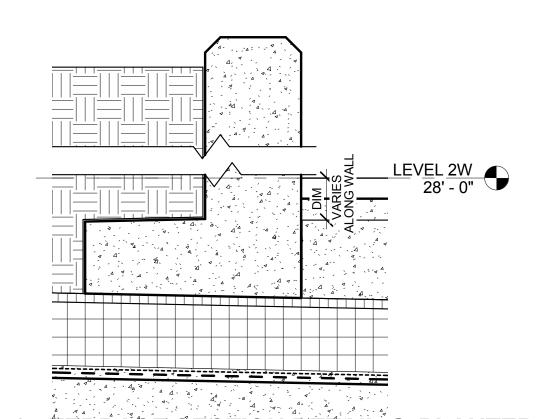

9. TERRACE SECTION DETAIL @ PLANTER

SCALE: 1 1/2" = 1'-0"

RUNBERG ARCHITECTURE GROUP LEVEL 2W 28' - 0" PROJECT NUMBER: **GRANT PARK VILLAGE**

> SHEET TITLE: **EXTERIOR DETAILS**

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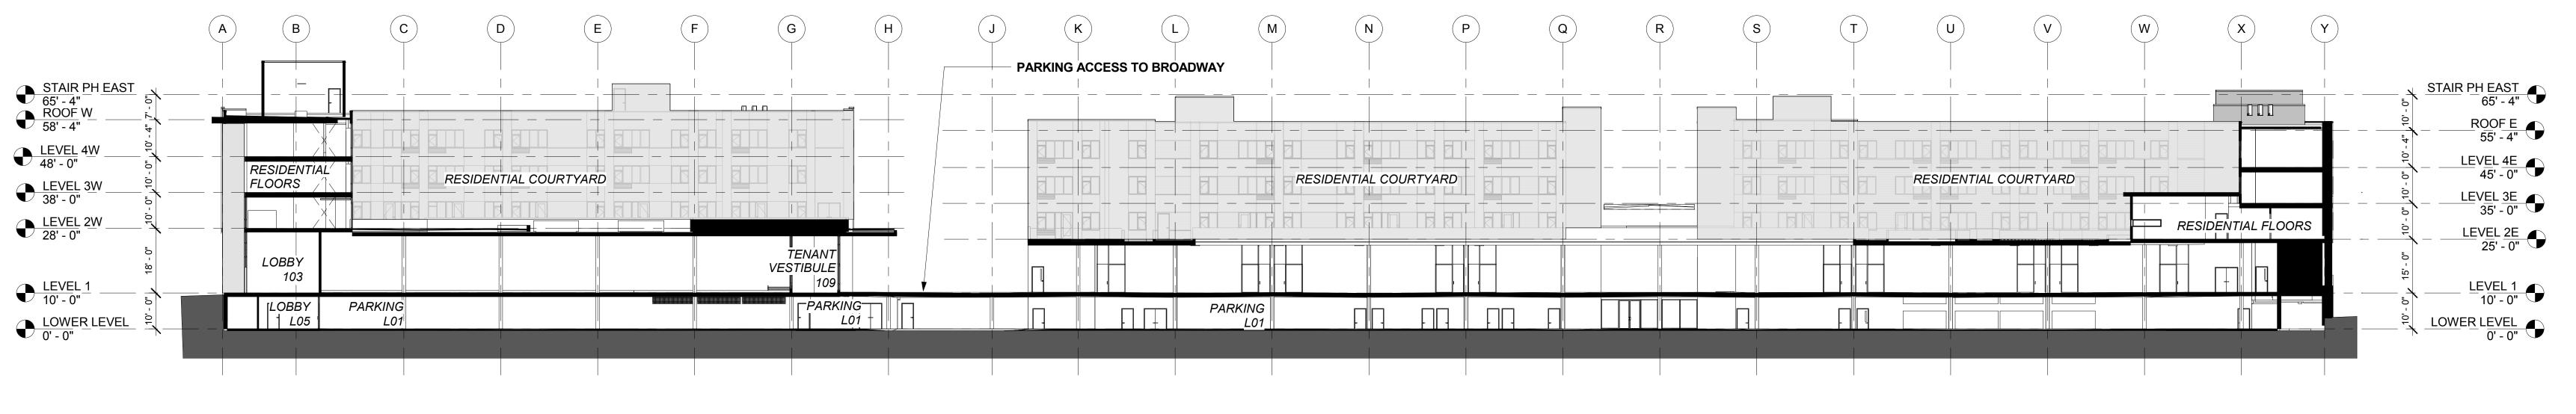
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CONSULTANT:


Suite 300 503 221.2077 D

DATE ISSUED: 1.14.2013








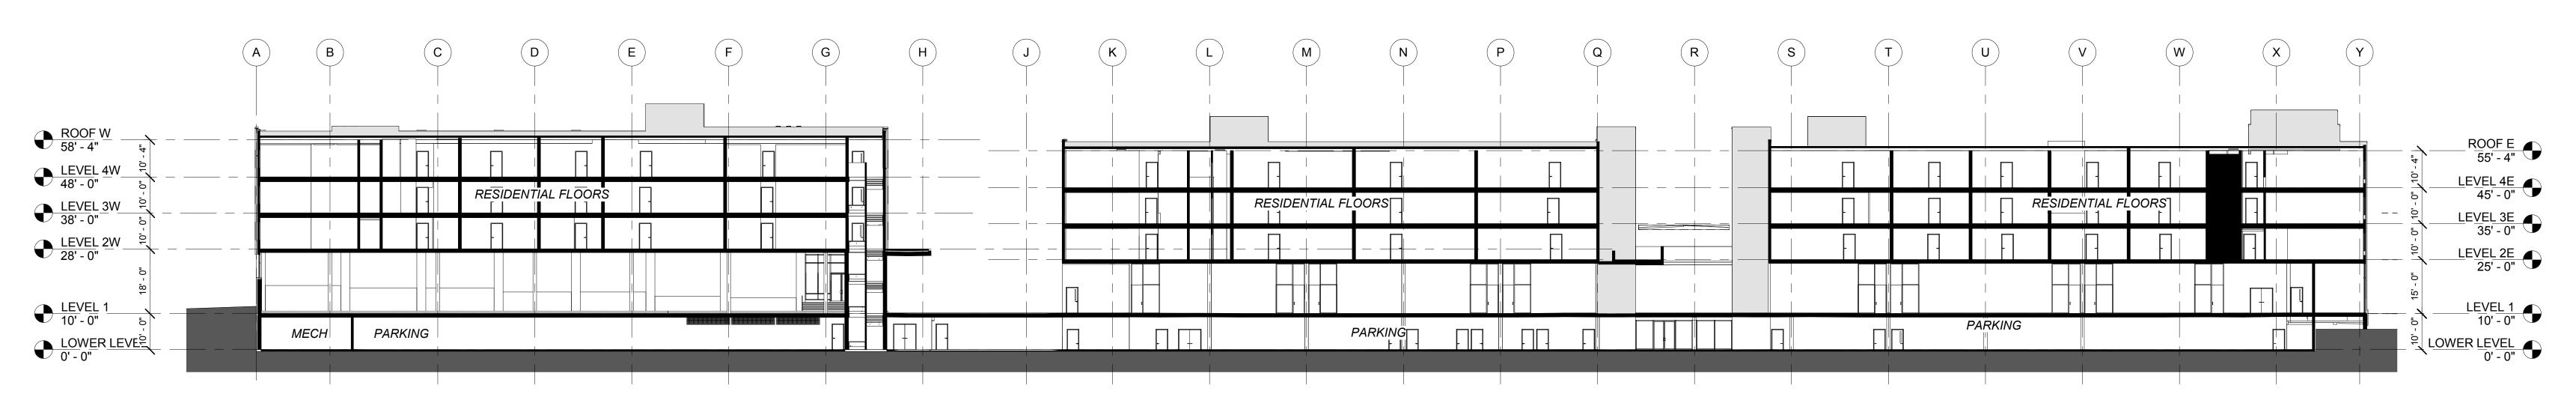




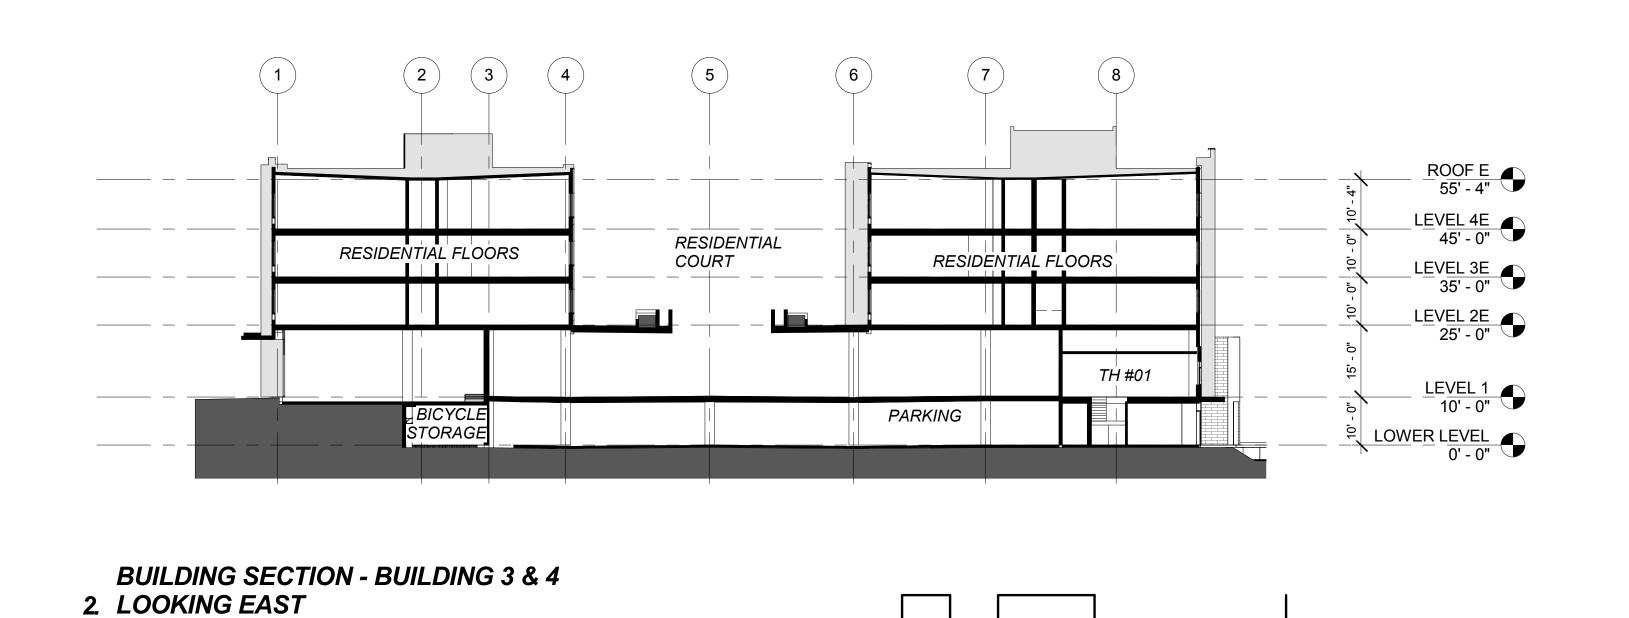

4. BUILDING SECTION LOOKING NORTH

SCALE: 1" = 20'-0"

SCALE: 1" = 20'-0"

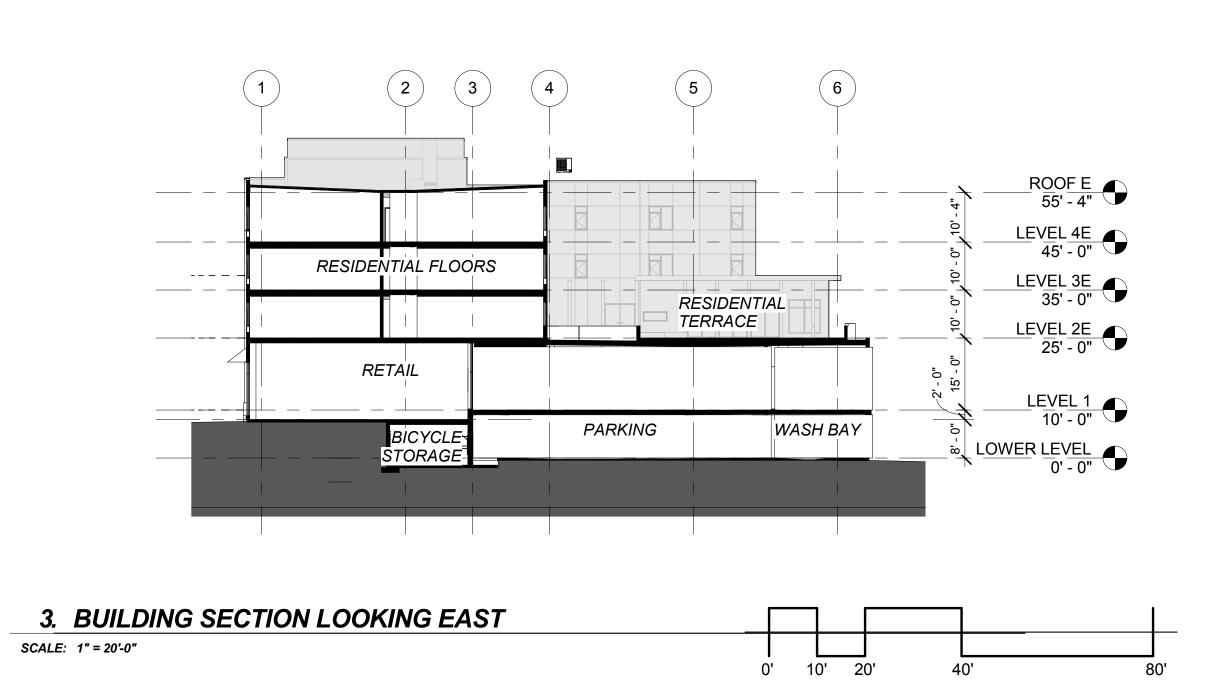

PRELIMINARY -NOT FOR CONSTRUCTION

CONSULTANT:

RUNBERG ARCHITECTURE GROUP

PROJECT NUMBER: 211346

GRANT PARK VILLAGE


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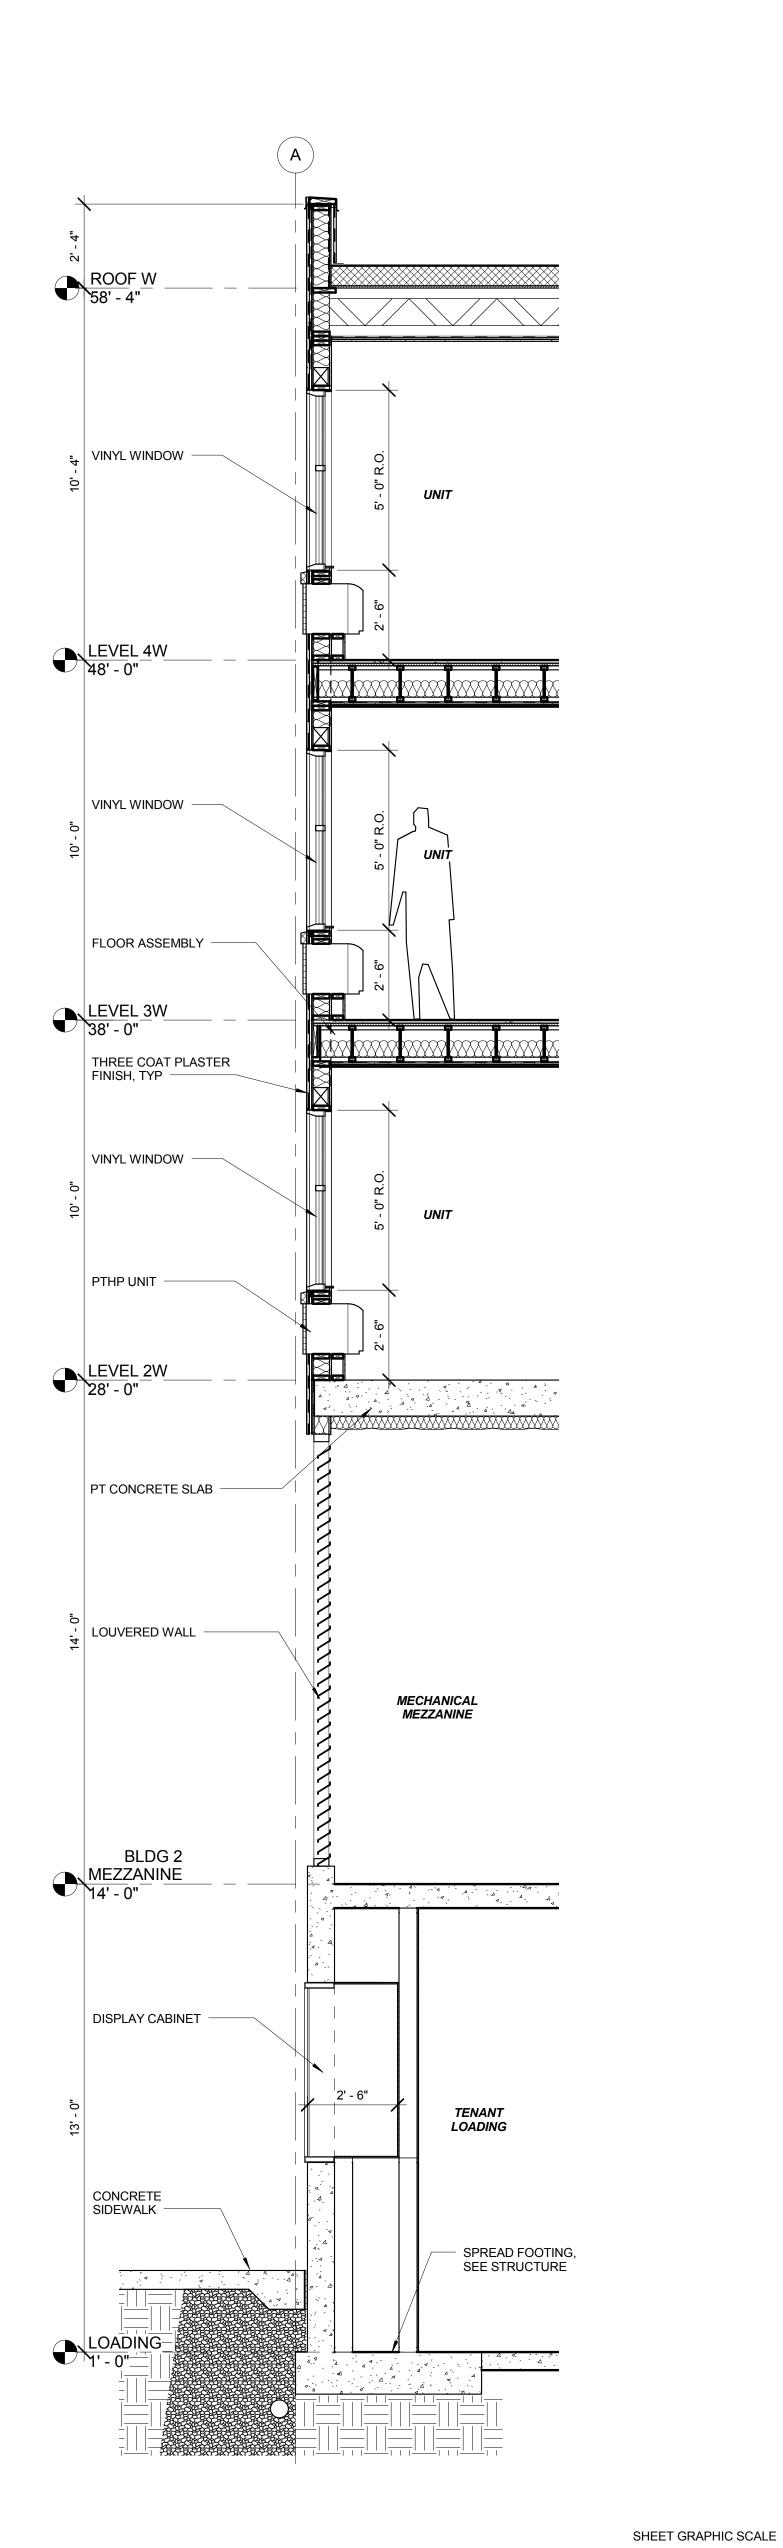
SHEET TITLE:


BUILDING SECTIONS

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DATE ISSUED: 1.07.2013

DR500



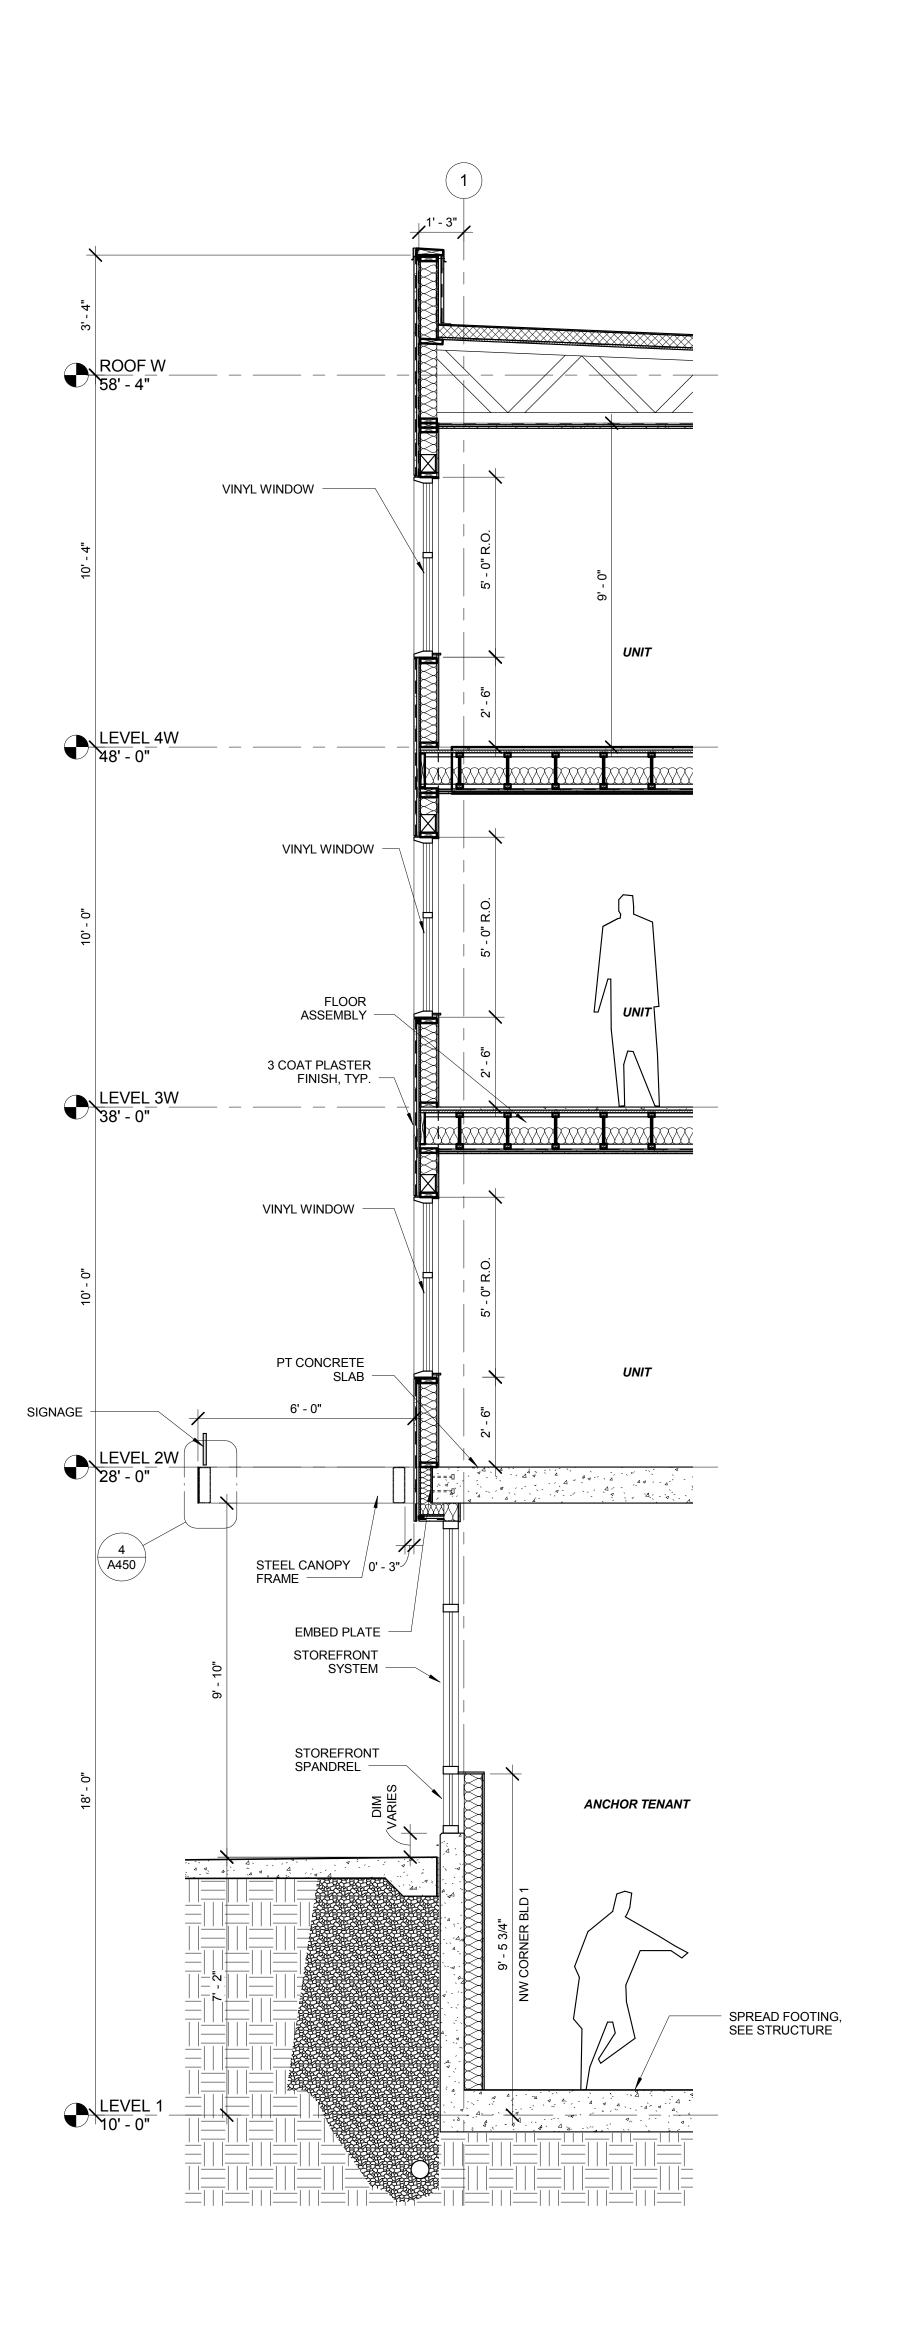

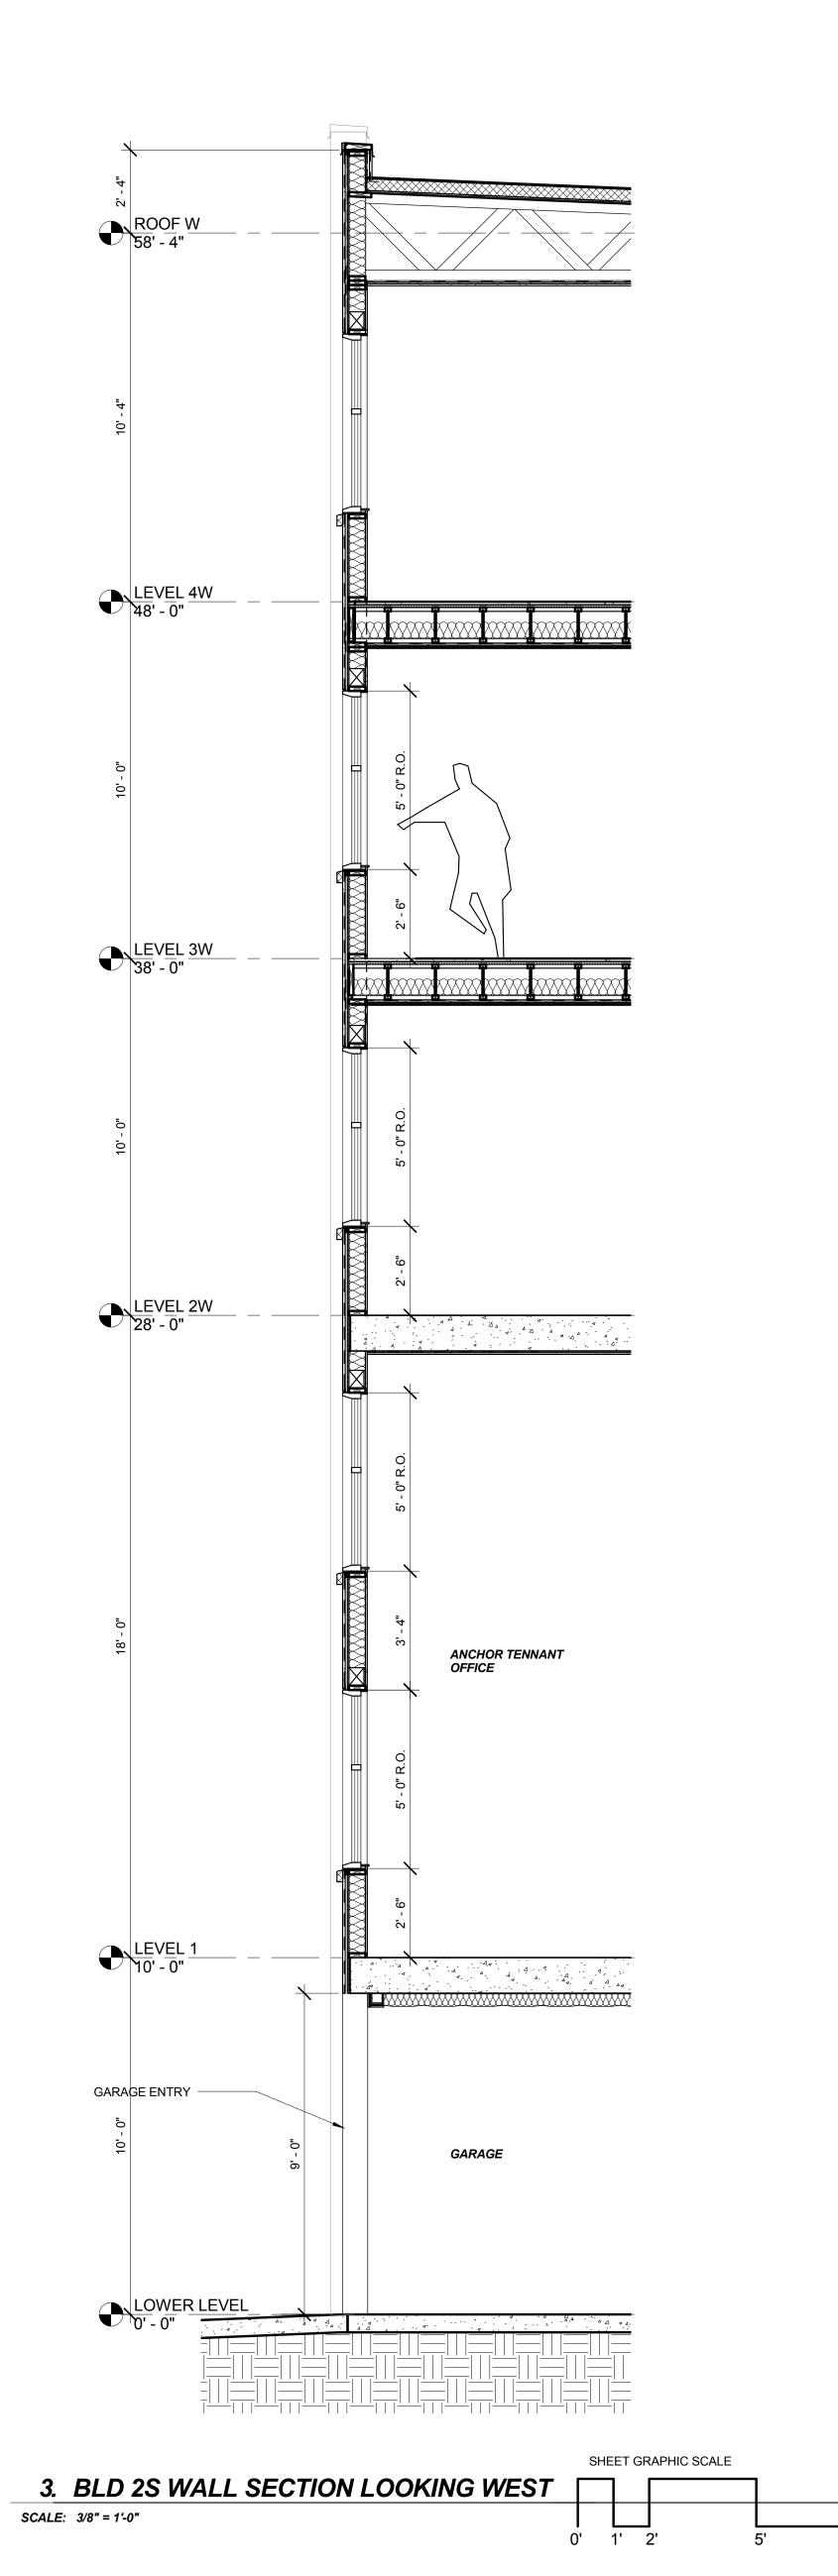



2:

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PROJECT NUMBER: 211

GRANT PARK VILLAGE

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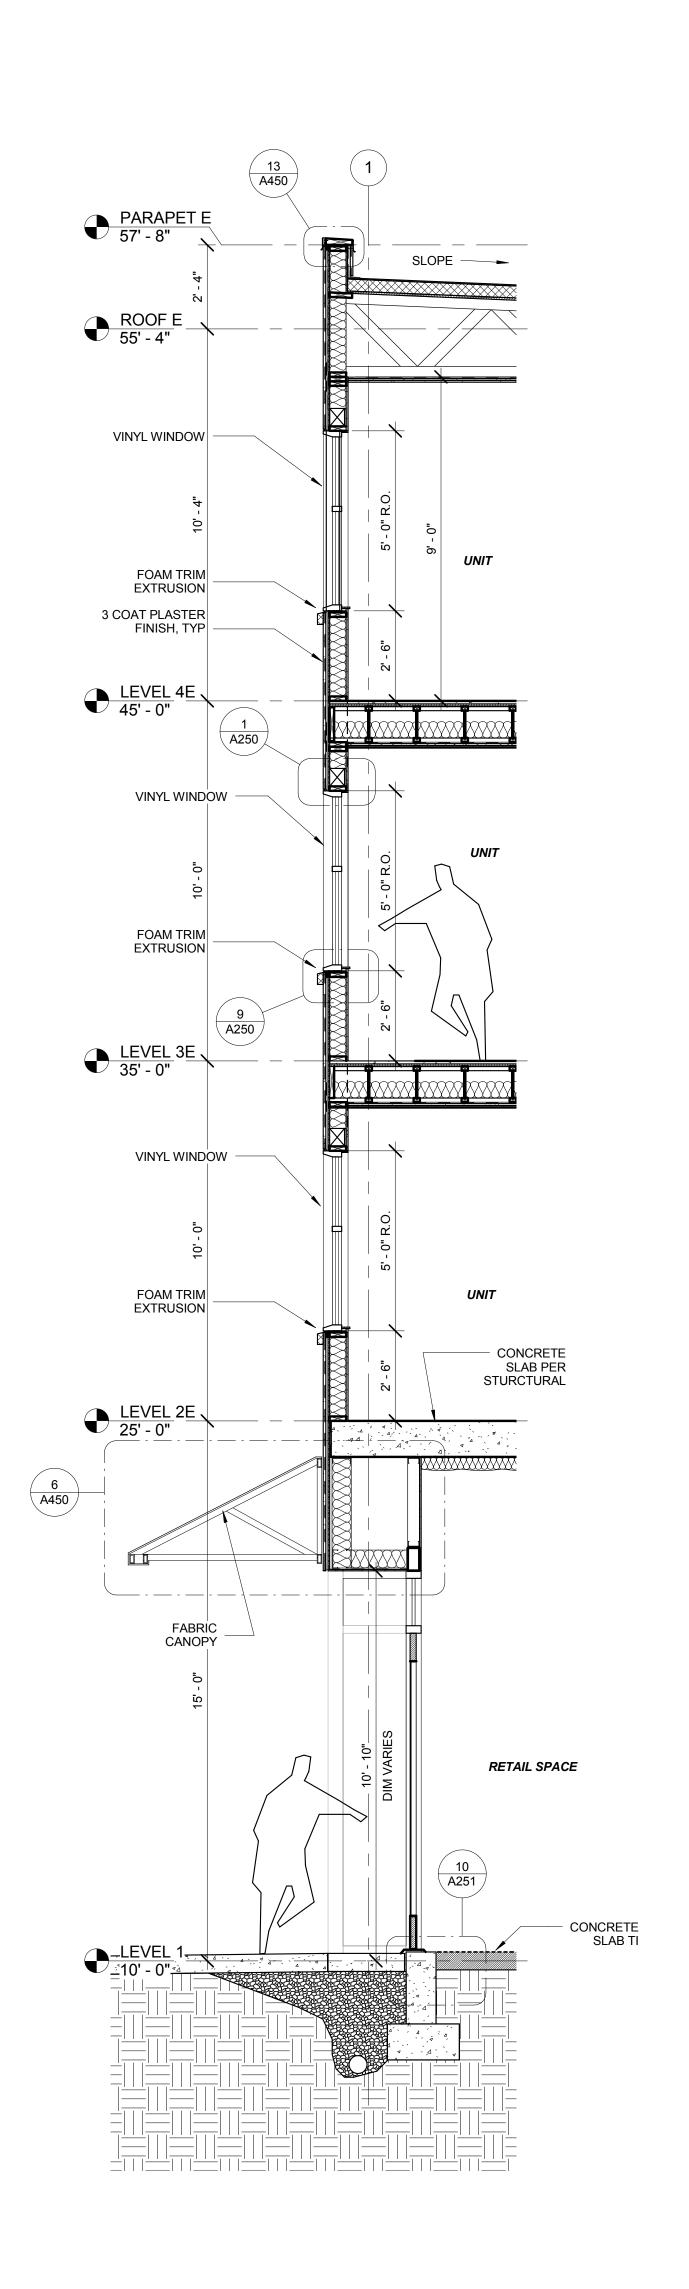
SHEET TITLE:


WALL SECTIONS


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SHEET GRAPHIC SCALE







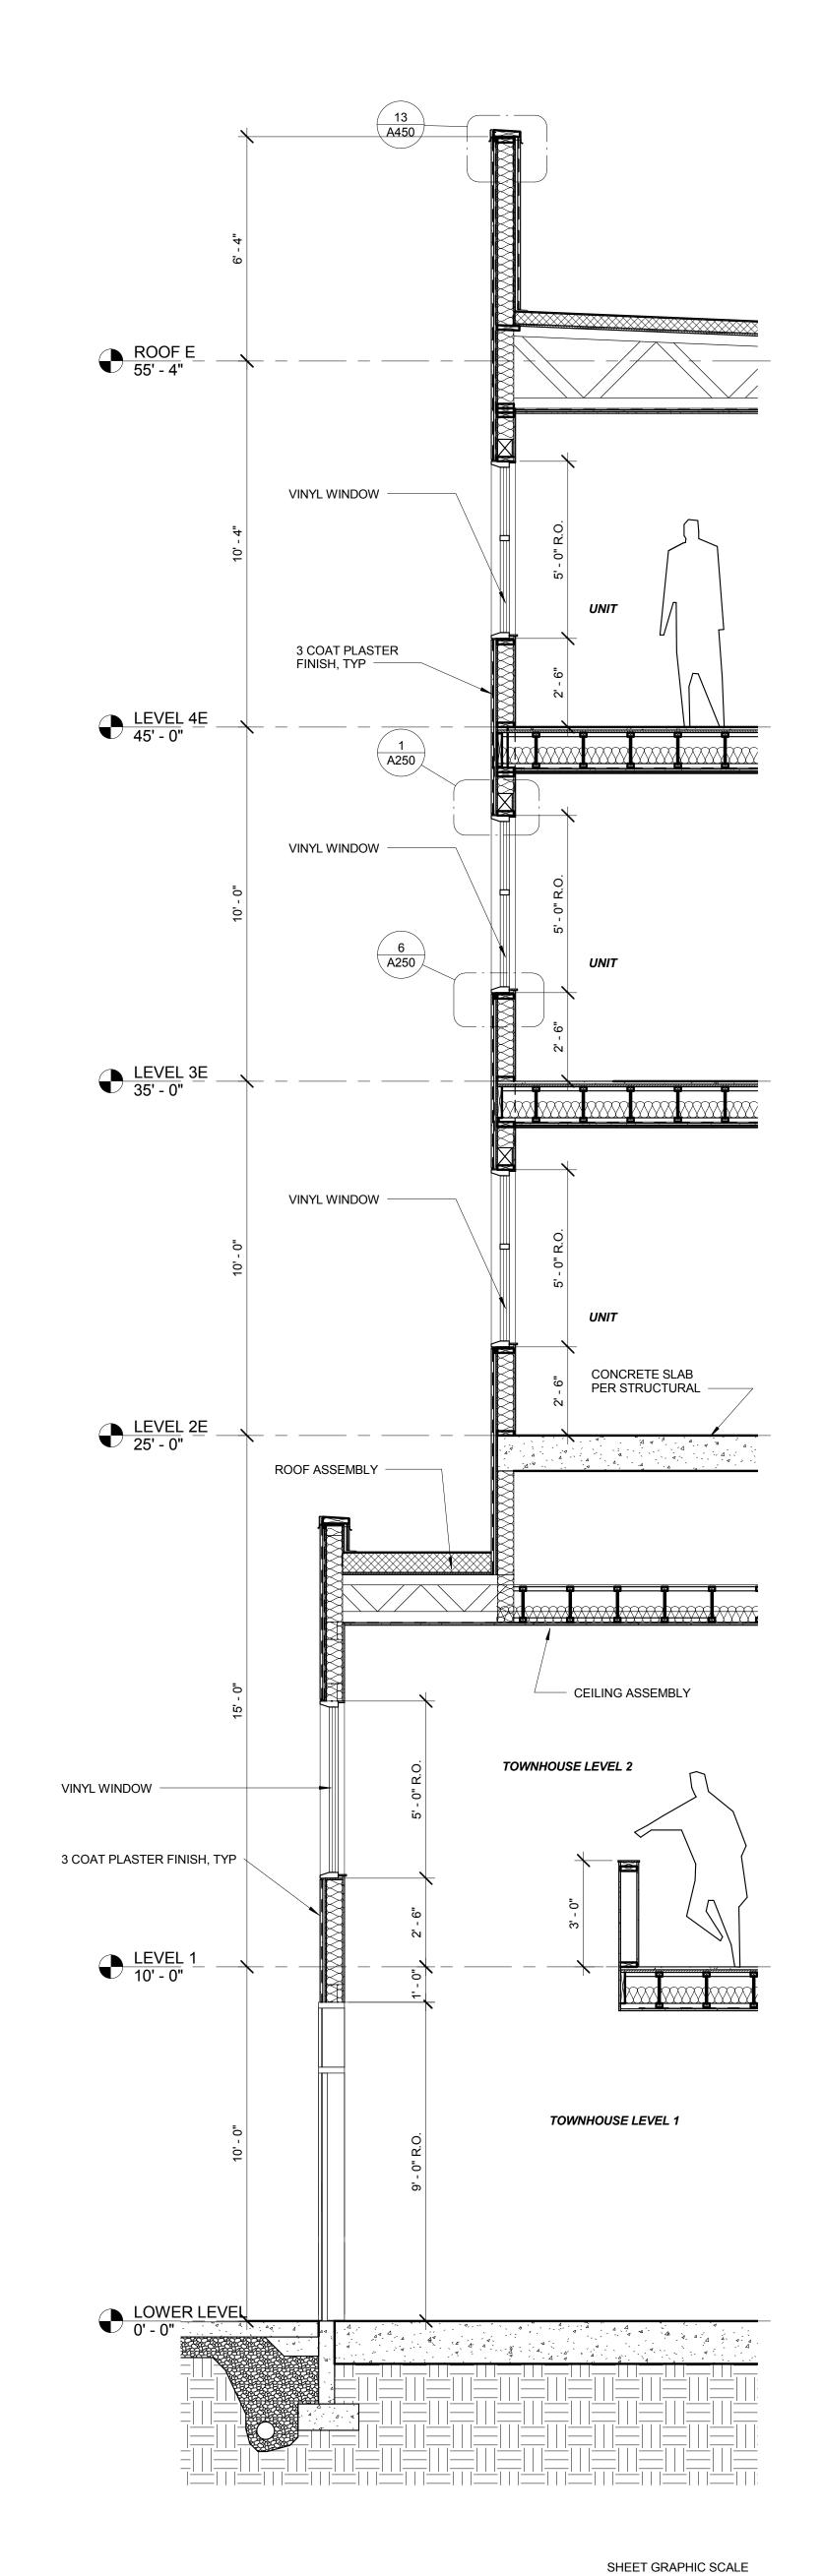
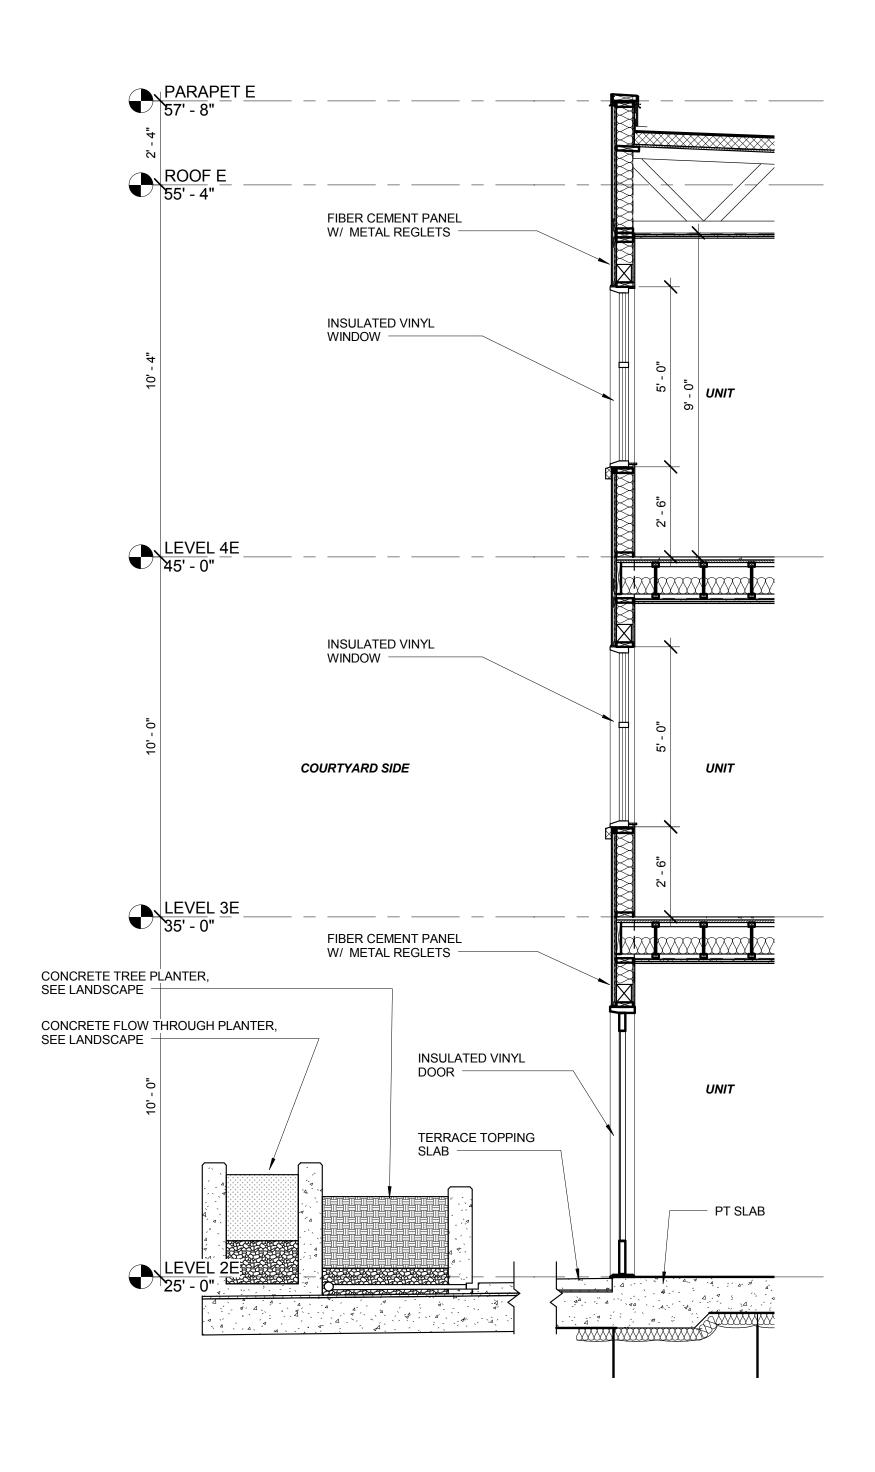
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SHEET TITLE:

WALL SECTIONS

DRAWN BY:

DATE ISSUED:

2. BLD 4N - WALL SECTION LOOKING EAST

SCALE: 3/8" = 1'-0"

SHEET GRAPHIC SCALE

0' 1' 2' 5' 10'







RUNBERG ARCHITECTURE GROUP

GRANT PARK *VILLAGE*

NE 33RD & BROADWAY PORTLAND, OR

SHEET TITLE:

RENDERINGS







CONSULTAN

RUNBERG ARCHITECTURE GROUP

PROJECT NUMBER:

GRANT PARK VILLAGE

NE 33RD & BROADWAY PORTLAND, OR

SHEET TITLE:

RENDERING

VIEW FROM CORNER OF NE BROADWAY AND NE 33RD

> DRAWN BY: DATE ISSUED:

XXX 1.14.1





RUNBERG ARCHITECTURE GROUP

PROJECT NUMBER:

GRANT PARK VILLAGE

NE 33RD & BROADWAY PORTLAND, OR

SHEET TITLE: RENDERING

VIEW FROM CORNER OF NE BROADWAY AND

DATE ISSUED:





CONSULTANT:

RUNBERG ARCHITECTURE GROUP

PROJECT NUMBER:

GRANT PARK VILLAGE

NE 33RD & BROADWAY PORTLAND, OR

SHEET TITLE:

RENDERING

VIEW OF NE 32ND COURT FROM NE BROADWAY

> DRAWN BY: DATE ISSUED:

-CLEAR GLAZING

STEEL STRUCTURE



_GLASS RAILING-SEE EXHIBIT "K"

ALUMINUM CANOPY SYSTEM

GLASS SUPPORTED BY PAINTED

WITH STRUCTURALY GLAZED

GLASS WATER VEIL IN PAINTED METAL FRAME-SEE EXHIBITS FOR SIMILAR IMAGES

EXPOSED PT CONCRETE DECK

-CONCRETE SEAT WALLS



PRELIMINARY NOT FOR CONSTRUCTION

CONSULTANT:

RUNBERG ARCHITECTURE GROUP

PROJECT NUMBER:

GRANT PARK VILLAGE

NE 33RD & BROADWAY PORTLAND, OR

SHEET TITLE:

RENDERING

DRAWN BY:



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PROJECT NUMBER:

GRANT PARK VILLAGE

NE 33RD & BROADWAY PORTLAND, OR


SHEET TITLE:

RENDERING

VIEW OF CORNER OF NE 32ND AND NE WEIDLER

> DRAWN BY: DATE ISSUED:

) 1.14

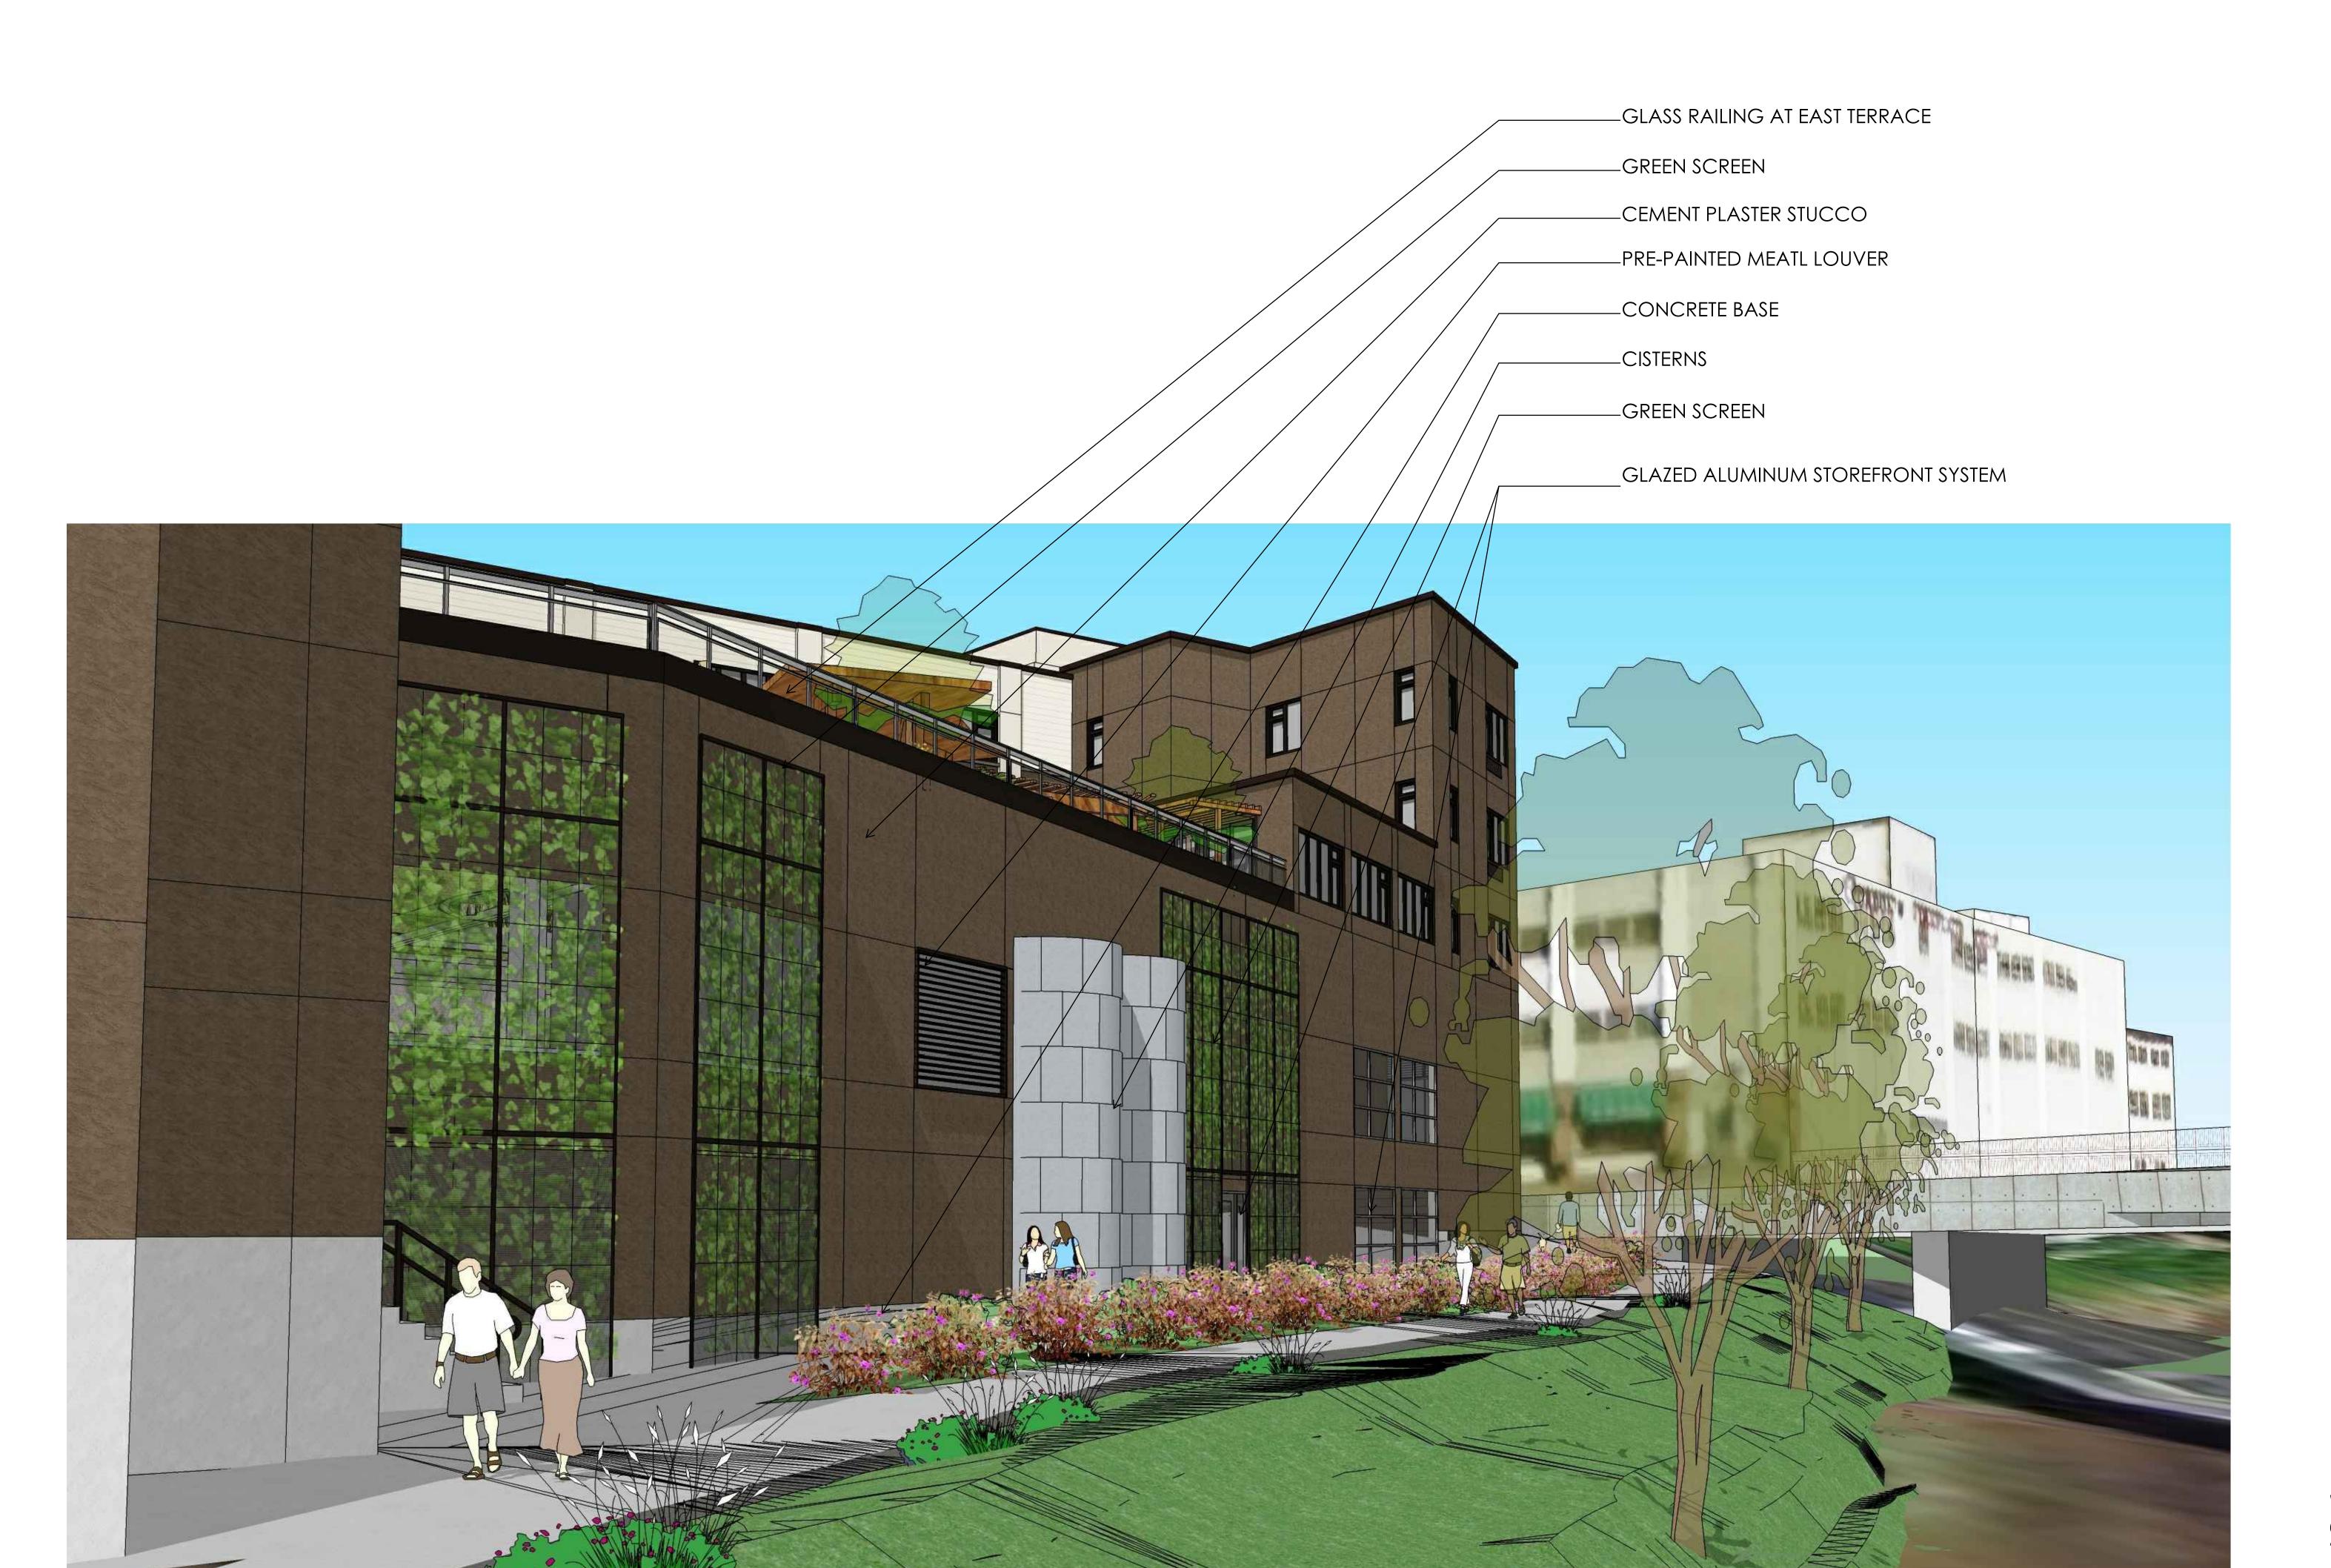



CONSULTANT:

RUNBERG ARCHITECTURE GROUP

PROJECT NUMBER:

GRANT PARK VILLAGE


NE 33RD & BROADWAY PORTLAND, OR

SHEET TITLE:

RENDERING

VIEW OF SE CORNER TOWARDS NE 33RD

DRAWN BY:
DATE ISSUED:

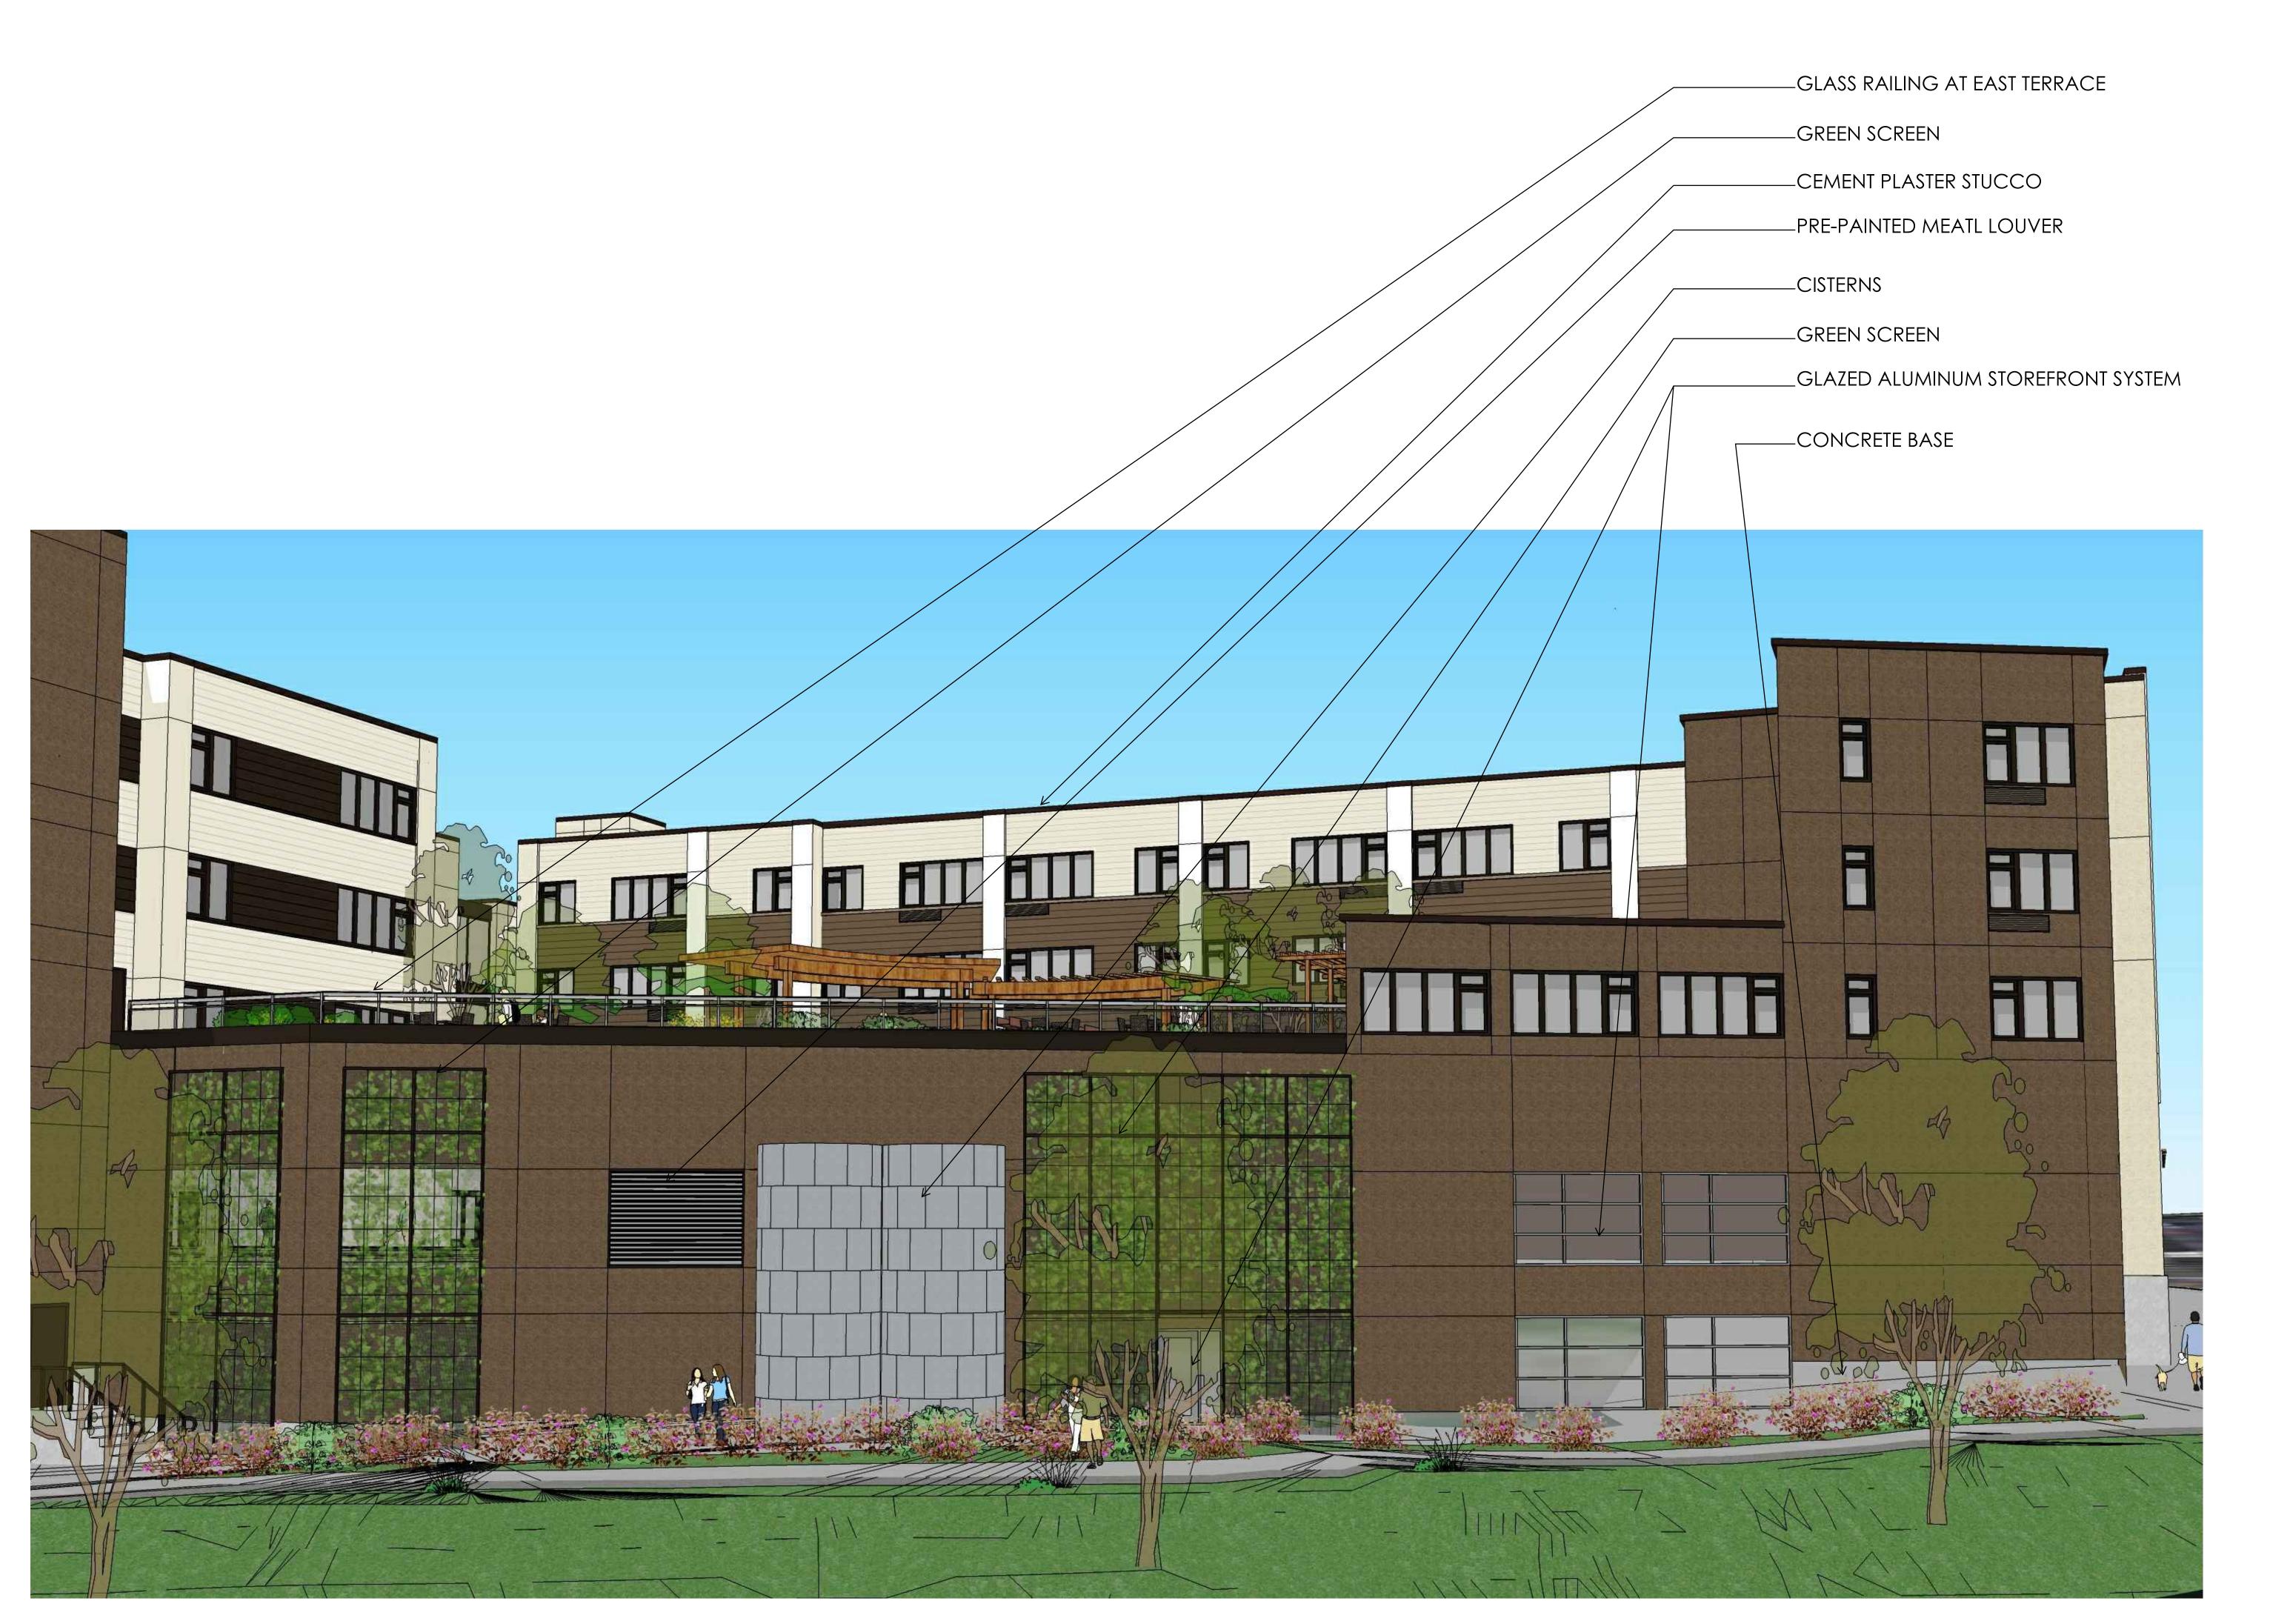



CONSULTANT:

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GRANT PARK VILLAGE

NE 33RD & BROADWAY PORTLAND, OR

PERSPECTIVE ELEVATION

VIEW OF ANGLED FACADE FACING SE

> DRAWN BY: DATE ISSUED:



-CEMENT PLASTER STUCCO

—CONCRETE BASE.

3'-7" HIGH PAINTED METAL RAILING SURFACE

MOUNTED TO CONCRETE.

-CAST IN PLACE CONCRETE STOOPS, TYP.

—FIBER CEMENT LAP SIDING



PRELIMINARY NOT FOR CONSTRUCTION

ARCHITECTS

Suite 300 503 221.2077 🗅

720 NW Davis 503.221.1121 🕾

CONSULTA

RUNBERG ARCHITECTURE GROUP

PROJECT NUMBER:

GRANT PARK VILLAGE

NE 33RD & BROADWAY PORTLAND, OR

SHEET TITLE:

RENDERINGS

VIEW OF TOWNHOUSE STOOPS

DRAWN BY:

Exterior North Elevation

MOTE: SILNAGE DETAILS ARK CORRECT. SEE EVENTIONS + PENDERINGS FOR UPDATED BUILDING DESIGN.



Scale: 1/16" = 1'-0"

DETAIL REMAINS THE SAME

MOVE LOCATION. BETAIL REMAINS THE SAME





NORTHWEST SIGN COUNCIL

PROJECT MANAGER Dylan Martin **DESIGNER** J. Ford

PROJECT NAME



PAGE DESCRIPTION **Building Elevation**

REVISIONS

♠ NA

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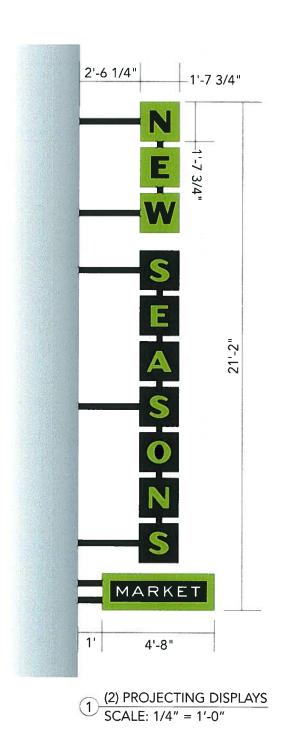
Landlord Signature


DATE: 11/09/12

PAGE #: 1 of 11

DRAWING #: 12-JF366r4

Exterior SA Projecting Display



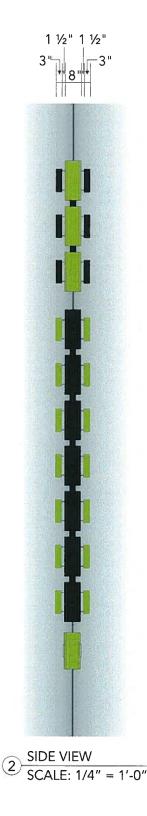



Projecting Display

Illuminated

Manufacture and install two (2) D/F Projecting Displays

Cabinet

Construction: fabricated aluminum, 8" deep with 1" hidden retainers, painted Pantone 583C Green and Satin Black

Faces: .090 aluminum hinged on sides for access (no visible fasteners on face) painted Pantone 583C Green and Satin Black, add matte white PSV or painted letters to reflect illumination

NEW SEASONS (Halo-Letters)

Faces: .090 aluminum painted Pantone 583C

Green and Satin Black

Returns: .040 aluminum paint TM faces

Backs: 177 clear polycarb

Interior: painted white

Illumination: Sloan White LEDs, facing out

Power Supplies: mount inside cabinets

MARKET

Construction: fabricated aluminum 8" deep with 1" hidden retainers, painted Pantone 583C Green

Faces: .090 routed aluminum painted Pantone 583C Green and Satin Black with 3/4" clear push-thru acrylic, 3M White 230-20 1st surface and white diffuser 2nd surface

Installation

Wall Type: verify

Supports: 4x4 sq tubes painted Satin Black

Mounting: plate mount to corner of building as required per engineering

Colors







Satin Black

DATE: 11/09/12

PAGE #: 2 of 11

Landlord Signature

SECURITY

SIGNS

Portland, Oregon 97202 503-232-4172 fax 503-230-186

NORTHWEST SIGN COUNCIL

PROJECT MANAGER Dylan Martin

DESIGNER J. Ford

SEASONS

NEW

PAGE DESCRIPTION

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APPROVALS Client Signature

Projecting Display

REVISIONS

◆ NA

PROJECT NAME

DRAWING #: 12-JF366r4

D/F PROJECTING DISPLAY (QTY. 2) - 98.78 SF AREA EA.
Scale: 1/4" = 1'-0"


Green

Pantone 583C

Exterior SB Under Canopy Display - Option 1



UNDER CANOPY DISPLAY SCALE: 3/4" = 1'-0"

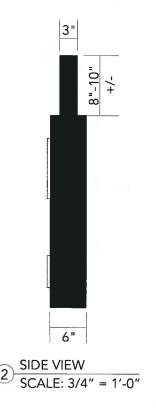

Under Canopy Display

Illuminated Manufacture and install one (1) S/F Under Canopy Display

Cabinet

Construction: fabricated aluminum, 6" deep painted Pantone 583C Green and Satin Black

Faces: .090 routed aluminum painted Pantone 583C Green and Satin Black with 3/4" clear push-thru acrylic, 3M Black 230-22 & digitally printed Pantone 583C Green 1st surface and white diffuser 2nd surface. Add block-out PSV behind Green digitally printed letters

Installation

Canopy Type: verify

Supports: 3x3 sq tubes painted Satin Black

Mounting: verify canopy structure for attachment method

Colors

Satin Black/ 3M 230-22





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NORTHWEST SIGN COUNCIL PROJECT MANAGER Dylan Martin

PROJECT NAME

DESIGNER

J. Ford



PAGE DESCRIPTION

Under Canopy Display - Option 1

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APPROVALS

Client Signature

Landlord Signature


1.14.13 DATE: 11/09/12

PAGE #: 3 of 11


DRAWING #: 12-JF366r4

S/F UNDER CANOPY DISPLAY - 29.93 SF AREA (OPTION 1)
Scale: 3/4" = 1'-0"

Exterior SC | Canopy Display - Tag-Lines

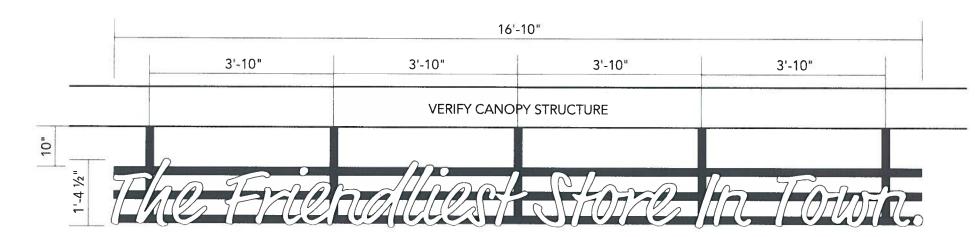

CANOPY DISPLAY - 23.15 SF SCALE: ½" = 1'-0"

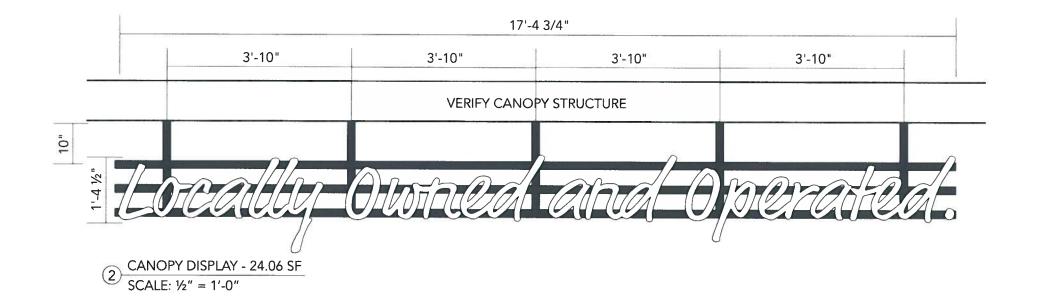

UNDER CANOPY DISPLAYS Scale: ½" = 1'-0"

Under Canopy Displays

Non-Illuminated

Manufacture and install two (2) Under Canopy Display Tag-Lines

Construction: Channel letters on a sq tube frame

Frame: 2" sq tube frame painted TM canopy

Tag-Line

Faces: 3/16" White acrylic

Trim Cap: 1" Black Jewelite

Returns: .040 aluminum, 3" deep, stock Black

Backs: .040 aluminum, pre-coat white

Illumination: White LEDs

Installation

Canopy Type: verify

Mounting: verify canopy structure for mounting

specifications

Transformers: remote mounted, run electrical

through sq tube

Primary: 120V

Colors

White Acrylic

Paint TM

VERIFY CANOPY STRUCTURE



1.14,13

SECTION VIEW

MOTE SHEET



INTERNATIONAL SIGN ASSOCIATION.

NORTHWEST SIGN COUNCIL (UL)

PROJECT MANAGER Dylan Martin DESIGNER J. Ford

PROJECT NAME



PAGE DESCRIPTION Canopy Display Tag-Lines

REVISIONS

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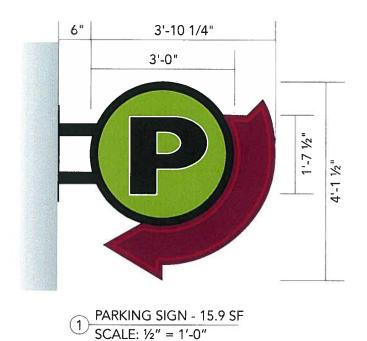
Landlord Signature

DATE: 11/09/12


PAGE #: 5 of 11

DRAWING #: 12-JF366r4

Exterior SF Projecting Parking Display



10"

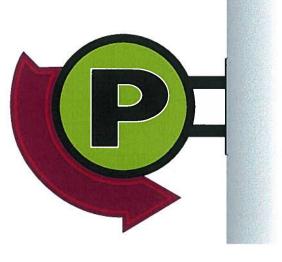

OPPOSITE SIDE

SCALE: ½" = 1'-0"

Projecting Parking Display

Illuminated

Manufacture and install one (1) D/F Parking Projecting Display

Cabinet

Construction: fabricated aluminum, 10" deep painted Satin Black

Faces: .090 routed aluminum painted Pantone 583C Green and Satin Black with 3/4" clear push-thru acrylic, 3M Black 230-22 PSV applied 1st surface and white diffuser 2nd surface

Installation


Wall Type: verify

Mounting: plate mount w/appropriate fasteners

Colors

Satin Black/3M 230-22

Pantone 583C

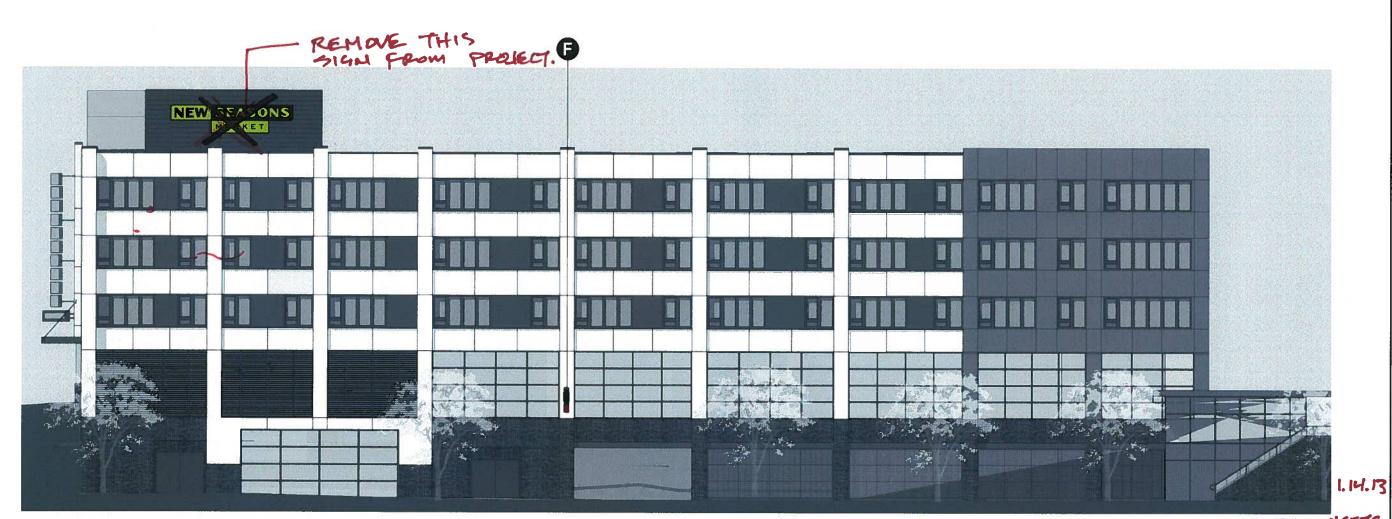

SOUTH ELEVATION - BUILDING #2

Scale: 1/16" = 1'-0"

SECURITY SIGNS



NORTHWEST SIGN COUNCIL

PROJECT MANAGER Dylan Martin **DESIGNER** J. Ford

PROJECT NAME



PAGE DESCRIPTION

REVISIONS

Projecting Parking Display

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APPROVALS

Client Signature

Landlord Signature

DATE: 11/09/12

PAGE #: 8 of 11

DRAWING #: 12-JF366r4

Exterior SG Water Tank Graphics

WATER TANK GRAPHICS SCALE: 3/4" = 1'-0"



Water Tank Graphics

Non-Illuminated Manufacture and install one (1) painted Water Tank graphics

Scope: painted graphics in Satin Black and Pantone 583C Green directly to water tank

Colors

Satin Black

Pantone 583C Green



PROJECT MANAGER Dylan Martin DESIGNER J. Ford

PROJECT NAME



PAGE DESCRIPTION Projecting Parking Display

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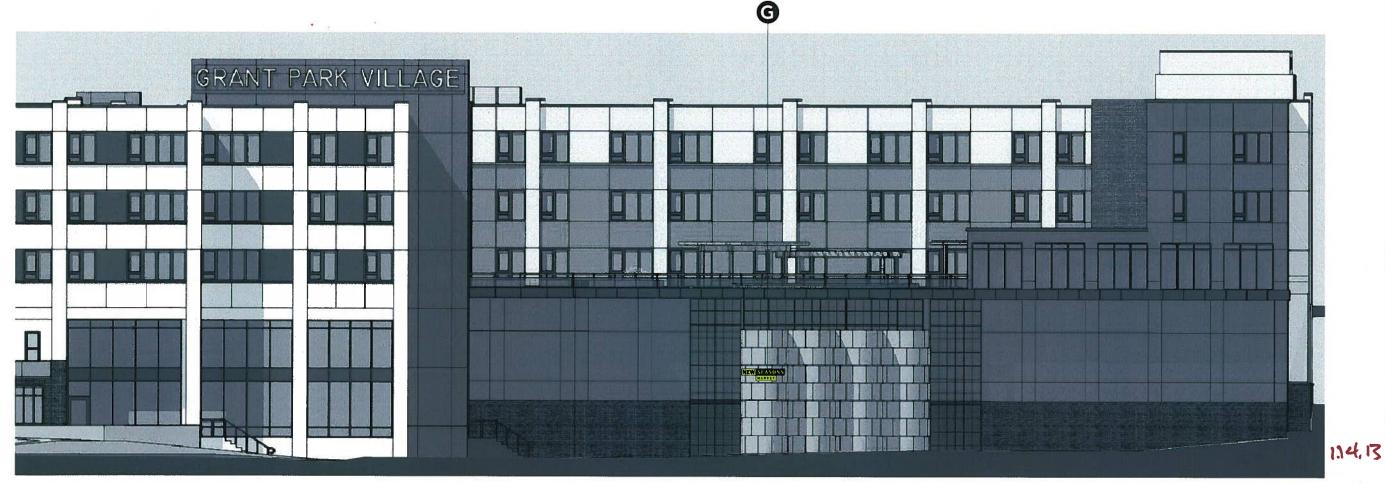
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SOUTH ELEVATION - BUILDING #4 (PARTIAL)

Scale: 1/16" = 1'-0"

Exterior Night Views




SIGN TYPE A & D (OPTION 1)



SIGN TYPE B & D (OPTION 2)



SIGN TYPE E

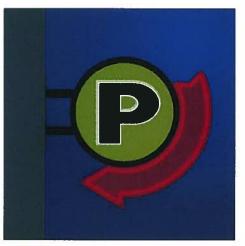

SIGN TYPE F

IS DELETED





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PROJECT MANAGER Dylan Martin **DESIGNER**

PROJECT NAME

J. Ford



PAGE DESCRIPTION

REVISIONS

Projecting Parking Display

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APPROVALS

Client Signature

Landlord Signature

DATE 11/09/12

PAGE #: 10 of 11

DRAWING #: 12-JF366r4