

Home / Appeals

APPEAL SUMMARY

Status: PENDING - Held Over from 27667 (4/13/23) for more information.

Appeal ID: 32296	Project Address: 2525 NW Lovejoy St
Hearing Date: 5/22/24	Appellant Name: Meaghan Bullard
Case No.: B-005	Appellant Phone: (503) 477 9165
Appeal Type: Building	Plans Examiner/Inspector: Jeff Rago
Project Type: commercial	Stories: 4 Occupancy: S-2, B Construction Type: III-B
Building/Business Name: 25th and Lovejoy Medical Building	Fire Sprinklers: Yes - throughout
Appeal Involves: Reconsideration of appeal	LUR or Permit Application No.: 17-201098-FA
Plan Submitted Option: pdf [File 1] [File 2] [File 3] [File 4]	Proposed use: Existing medical office use to remain

APPEAL INFORMATION SHEET

Appeal item 1

Code Section	602
Requires	602.1 General. Buildings or structures erected or to be erected, altered or extended in height or area shall be classified in one of the five construction types defined in Sections 602.2 through 602.5. The building elements shall have a fire-resistance rating not less than that specified in Table 601.
Code Modification or Alternate Requested	Due to extraordinary circumstances and undue hardship as an on-going and cumulative result of COVID-19, and the City's slow recovery, the owner is requesting a 2-year extension to the sprinkler phasing plan — extending the completion deadline from May 17, 2024 to May 17, 2026. Of the 29 original suites, 5 remain vacant and will need to be sprinklered as part of a future TI to bring the building into full compliance. A summary of the suites and phasing plan is attached for your reference, along with a PDF of the original appeal and the related exhibit.
Proposed Design	The proposed design will consider the existing building to be Type III-B construction instead of Type III-A as currently permitted. An automatic NFPA 13 sprinkler system will be installed throughout the building.

The installation of the sprinkler system will be phased. The first phase will extend the system into the corridors, lobbies, exit stairs, elevators, parking garage and currently vacant tenant suites. The remaining tenant suites will become sprinklered as they become vacant. An occupant safety plan will be submitted at the time of permit application to outline the phasing in detail.

Reconsideration Text:

No change to the parameters of the previous appeal requested at this time. We only seek to extend the sprinkler phasing plan outlined above.

Reason for alternative

The building is a medical office building currently classified as a Type III-A structure, which requires a 1-Hour structural frame and 1-Hour floor assemblies. Not all the existing structural framing members are currently protected, and the existing floor-ceiling assemblies do not all achieve a 1-Hour rating. To address these deficiencies, we propose to re-classify the construction type as a Type III-B structure, which eliminates the rating requirements for the primary frame and floor-ceilings. The building will comply with the allowable height and area requirements for Type III-B construction with the addition of the sprinkler system. See attached G002 for allowable height and area calculations.

The automatic sprinkler system will have the added benefit of allowing for non-rated corridor construction per Table 1018.1.

The addition of a sprinkler system throughout in lieu of rated assemblies will also allow the medical office tenants more flexibility to relocate light fixtures, mechanical components, etc. as necessary. Additionally, a non-rated corridor will support the need and desire for glazed entrances and transaction windows along the corridor walls, which are common features in medical office occupancies.

Additionally, the automatic sprinkler system will provide greater overall building safety than current conditions.


Reconsideration Text:

No change to the parameters of the previous appeal requested at this time. We only seek to extend the sprinkler phasing plan outlined above.

The administrative staff has not yet reviewed this appeal.

Development Services

From Concept to Construction

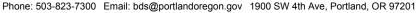

More Contact Info (http://www.portlandoregon.gov//bds/article/519984)



APPEAL SUMMARY

Status:	Decision	Rend	lered
Otatus.	DCGISIOII	1 10110	

Appeal ID: 15093 Project Address: 2525 NW Lovejoy St	
Hearing Date: 5/17/17	Appellant Name: Kathy Johnson
Case No.: B-011	Appellant Phone: 503.477.9165
Appeal Type: Building	Plans Examiner/Inspector: Jeff Rago
Project Type: commercial	Stories: 5 Occupancy: (E) S-2 and B to remain
	Construction Type: (E) III-A, Proposed III-B
Building/Business Name:	Fire Sprinklers: Yes - Proposed throughout
Appeal Involves: Alteration of an existing structure	LUR or Permit Application No.:
Plan Submitted Option: pdf [File 1]	Proposed use: Existing medical office use to remain

APPEAL INFORMATION SHEET

Appeal item 1

$C \wedge d \wedge$	Section	

Section 602 Construction Classification

Requires

602.1 General. Buildings and structured erected or to be erected, altered or extended in height or area shall be classified in on of the five construction types defined in Sections 602.2 through 602.5. The building elements shall have a fire-resistance rating not less than that specified in Table 601.

Code Modification or Alternate Requested

Proposed Design

The proposed design will consider the existing building to be Type III-B construction instead of Type III-A as currently permitted. An automatic NFPA 13 sprinkler system will be installed throughout the building.

The installation of the sprinkler system will be phased. The first phase will extend the system into the corridors, lobbies, exit stairs, elevators, parking garage and currently vacant tenant suites. The remaining tenant suites will become sprinklered as they become vacant. An occupant safety plan will be submitted at the time of permit application to outline the phasing in detail.

Reason for alternative The building is a medical office building currently classified as a Type III-A structure, which requires a 1-Hour structural frame and 1-Hour floor assemblies. Not all the existing structural framing members are currently protected, and the existing floor-ceiling assemblies do not all achieve a 1-Hour rating. To address these deficiencies, we propose to re-classify the construction type as a Type III-B structure, which eliminates the rating requirements for the primary frame and floor-ceilings. The building will comply with the allowable height and area requirements for Type III-B construction with the addition of the sprinkler system. See attached G002 for allowable height and area calculations.

The automatic sprinkler system will have the added benefit of allowing for non-rated corridor construction per Table 1018.1.

The addition of a sprinkler system throughout in lieu of rated assemblies will also allow the medical office tenants more flexibility to relocate light fixtures, mechanical components, etc. as necessary. Additionally, a non-rated corridor will allow for glazed tenant suite entrances and transaction windows along the corridor walls, which are common features in medical office occupancies.

Additionally, the automatic sprinkler system will provide greater overall building safety than current conditions.

APPEAL DECISION

Construction classification from IIIA to IIIB with full building Type 13 sprinkler installation within 5 years: Granted as proposed provided all OSSC provisions for construction Type IIIB are met and 2nd phase of sprinkler installation is completed before May 17, 2022.

The phased sprinkler agreement must be reviewed and approved by the Fire Marshal's Office. Please contact Gary Boyles (503 823-3778) for more information.

The Administrative Appeal Board finds with the conditions noted, that the information submitted by the appellant demonstrates that the approved modifications or alternate methods are consistent with the intent of the code; do not lessen health, safety, accessibility, life, fire safety or structural requirements; and that special conditions unique to this project make strict application of those code sections impractical.

Pursuant to City Code Chapter 24.10, you may appeal this decision to the Building Code Board of Appeal within 180 calendar days of the date this decision is published. For information on the appeals process and costs, including forms, appeal fee, payment methods and fee waivers, go to www.portlandoregon.gov/bds/appealsinfo, call (503) 823-7300 or come in to the Development Services Center.



Home / Appeals

APPEAL SUMMARY

Status: Decision Rendered - Reconsideration of ID 15093

Appeal ID: 27667	Project Address: 2525 NW Lovejoy St
Hearing Date: 4/13/22	Appellant Name: Meaghan Bullard
Case No.: B-007	
Appeal Type: Building	Plans Examiner/Inspector: Jeff Rago
Project Type: commercial	Stories: 5 Occupancy: S-2, B Construction Type: III-B
Building/Business Name: 25th and Lovejoy Medical Building	Fire Sprinklers: Yes - Throughout (see below)
Appeal Involves: Reconsideration of appeal	LUR or Permit Application No.: 17-201098-FA
Plan Submitted Option: pdf [File 1] [File 2] [File 3]	Proposed use: Existing medical office use to remain

APPEAL INFORMATION SHEET

Appeal item 1

Code Section	602
Requires	602.1 General. Buildings or structures erected or to be erected, altered or extended in height or area shall be classified in one of the five construction types defined in Sections 602.2 through 602.5. The building elements shall have a fire-resistance rating not less than that specified in Table 601.
Code Modification or Alternate Requested	Due to extraordinary circumstances and undue hardship as a result of COVID-19, the owner would like to request a 2-year extension to the sprinkler phasing plan — extending the completion deadline from May 17, 2022 to May 17, 2024. Of the 29 original suites, 8 remain vacant and will need to be sprinklered as part of a future TI to bring the building into full compliance. A summary of the suites and phasing plan is attached for your reference, along with a PDF of the original appeal and the related exhibit.
Proposed Design	The proposed design will consider the existing building to be Type III-B construction instead of Type III-A as currently permitted. An automatic NFPA 13 sprinkler system will be installed throughout the building. The installation of the sprinkler system will be phased. The first phase will extend the system into the corridors, lobbies, exit stairs, elevators, parking garage and currently vacant tenant suites. The remaining tenant suites will

become sprinklered as they become vacant. An occupant safety plan will be submitted at the time of permit application to outline the phasing in detail.

Reconsideration Text:

No change to the parameters of the previous appeal requested at this time. We only seek to extend the sprinkler phasing plan outlined above.

Reason for alternative

The building is a medical office building currently classified as a Type III-A structure, which requires a 1-Hour structural frame and 1-Hour floor assemblies. Not all the existing structural framing members are currently protected, and the existing floor-ceiling assemblies do not all achieve a 1-Hour rating. To address these deficiencies, we propose to re-classify the construction type as a Type III-B structure, which eliminates the rating requirements for the primary frame and floor-ceilings. The building will comply with the allowable height and area requirements for Type III-B construction with the addition of the sprinkler system. See attached G002 for allowable height and area calculations.

The automatic sprinkler system will have the added benefit of allowing for non-rated corridor construction per Table 1018.1.

The addition of a sprinkler system throughout in lieu of rated assemblies will also allow the medical office tenants more flexibility to relocate light fixtures, mechanical components, etc. as necessary. Additionally, a non-rated corridor will support the need and desire for glazed entrances and transaction windows along the corridor walls, which are common features in medical office occupancies.

Additionally, the automatic sprinkler system will provide greater overall building safety than current conditions.

Reconsideration Text:

No change to the parameters of the previous appeal requested at this time. We only seek to extend the sprinkler phasing plan outlined above.

APPEAL DECISION

Proposal for a two year extension until 05-17-2024 for full Type 13 sprinkler installation as required by Appeal 15093 decision language: Granted as proposed.

The Administrative Appeal Board finds that the information submitted by the appellant demonstrates that the approved modifications or alternate methods are consistent with the intent of the code; do not lessen health, safety, accessibility, life, fire safety or structural requirements; and that special conditions unique to this project make strict application of those code sections impractical.

Pursuant to City Code Chapter 24.10, you may appeal this decision to the Building Code Board of Appeal within 90 calendar days of the date this decision is published. For information on the appeals process, go to www.portlandoregon.gov/bds/appealsinfo, call (503) 823-7300 or come in to the Development Services Center.

JONES ARCHITECTURE | LOVEJOY MEDICAL BASED ON MELVIN MARK LEASING SUMMARY SENT ON 5/7/24 UPDATED: May 7, 2024

REVISIONS IN RED

LOVEJOY MED	ICAL PHASED SPRINKLER UPGRADE:	PHASE I / early 2018	PHASE II-A / mid 2018	PHASE II-B / mid-2022	PHASE II-C / mid-2024	PHASE II-D / mid-2026*
SUITE	STATUS					
100	OCCUPIED					
101	OCCUPIED					
103	OCCUPIED					
105	OCCUPIED					
200	VACANT					
202	OCCUPIED					
204	OCCUPIED					
205	VACANT					
207	VACANT					
208	OCCUPIED					
209	VACANT					
211A	OCCUPIED					
211B	OCCUPIED					
300	OCCUPIED					
301	OCCUPIED					
305	VACANT					
306	OCCUPIED					
307	OCCUPIED					
309	OCCUPIED					
311	OCCUPIED					
400	OOOLIDIED					
400	OCCUPIED					
401 402	OCCUPIED OCCUPIED					
403 404	OCCUPIED OCCUPIED					
404	OCCUPIED					
405	OCCUPIED					
407	OCCUPIED					
407	OCCUPIED					
400	OCCUPIED					
		è	88.0 88.0 88.0	8	%22	833%

^{* 2-}year extension request related to Appeal ID 15093. This request is being made due to extraordinary circumstances related to COVID-19.

83% of the the suites have been upgrades (24 of 29), however it is worth noting that all of the coll on areas / corridors have been upgraded so the overall percentage of the gross building are that has been upgraded is more than 83% (likely closer to 90% +/-) please let me know if it would be helpful to have that metric as well, and I would be happy to make the calc and provide it. there are 5 suites that remain vacant and not yet upgraded with sprinklers

BUILDING CODE SUMMARY

APPLICABLE CODES

-2014 OREGON STRUCTURAL SPECIALTY CODE (BASED ON 2012 IBC)

-2016 PORTLAND FIRE CODE (BASED ON 2014 OREGON FIRE CODE)

-2014 OREGON MECHANICAL SPECIALTY CODE (BASED ON 2012 IMC)

-2014 OREGON ELECTRICAL SPECIALTY CODE (BASED ON 2014 NFPA 70 National Electrical Code)

-2014 OREGON PLUMBING SPECIALTY CODE (BASED ON 2009 UPC)

-2014 OREGON ENERGY EFFICIENCY SPECIALTY CODE (BASED ON 2009 IECC)

-PORTLAND ZONING CODE

-2014 OSSC ACCESSIBILITY REFERENCED STANDARD: ICC/ANSI A117.1-2009

ALLOWABLE HEIGHT AND AREA -TABLE 503				
CONSTRUCTION TYPE	ALLOWABLE HEIGHT			
TYPE III-B	55			
OCCUPANCY GROUP	ALLOWABLE STORIES	ALLOWABLE AREA (SF)	ALLOWABLE AREA INCLUDING FRONTAGE INCREASE (506.2)	
S-2	3	26,000	37,180	
В	3	19,000	N/A	

FRONTAGE INCREASE - EQUATION 506.2
If = [F/P - 0.25]W/30
If = AREA INCREASED DUE TO FRONTAGE (%)
F = BUILDING PERIMETER FRONTING ON A PUBLIC WAY OR OPEN SPACE HAVING A 20' MINIMUM OPEN WIDTH
P = PERIMETER OF ENTIRE BUILDING
W = WIDTH OF PUBLIC WAY OR OPEN SPACE IN ACCORDANCE W/ SECTION 506.2.7
If = [370/796 - 0.25] 60/30
If = 0.42964 = 43%

ACTUAL HEIGHT	AND AREA		
AUTOMATIC SPRINKLER SYSTEM HEIGHT INCREASE = 20'-0" AND ONE STORY PER SECTION 504.2 AREA INCREASE DUE TO FRONTAGE = 43% = 11,180 SF FOR S-2			
OCCUPANCY GROUP EXISTING HEIGHT EXISTING AREA			
S-2	2 STORIES	27,000 SF	
В	4 STORIES	11,521 SF	

SEPARATED OCCUPANCIES - TABLE 508.4		
BUILDING WILL BE EQUIPPED THROUGHOUT WITH AN AUTOMATIC SPRINKLER SYSTEM		
SEPARATION REQUIRED	RATING	
S-2 TO B	1-HOUR	

CONS	TRUCTION	I TYP	E - T	ABLE 601			
TYPE	STRUCTURAL	WALLO O DADT					
	FRAME	Ext.	Int.	WALLS-EXT.	INT.		
III-B	0	2 HR	0 HR	0	0	0	0

EXTERIO	R WALL FIF	RE RATIN	G				
BASED ON FIRE SE	EPARATION DISTANC	E (TABLE 602) AND	MAX. OPENINGS	(TABLE 705.8)			
BUILDING FACE	CONSTRUCTION TYPE	OCCUPANCY	DIST. TO PROPERTY LINE	REQ. FIRE RESISTANCE RATING (TABLE 602)	MAX OPENING % ALLOWED (TABLE 705.8)	OPENING % PROVIDED	EXCEPTION 1: STREET FACING
NORTH 1	III-B	S-2	0'-0"	1	0%		
NORTH 2	III-B	S-2	1'-0"	1	0%		
NORTH 3	III-B	В	11'-0"	1	15%		
NORTH 4	III-B	В	45'-9"	0	NL		
NORTH 5	III-B	В	106'-4"	0	NL		
NORTH 6	III-B	В	136'-0"	0	NL		
EAST 1	III-B	S-2	0'-0"	1	0%		
EAST 2	III-B	S-2	1'-0"	1	0%		
EAST 3	III-B	В	10'-0"	1	15%		
EAST 4	III-B	В	61'-2"	0	NL		
SOUTH 1	III-B	S-2	0'-0"	1	0%		
SOUTH 2	III-B	В	19'-6"	1	25%		
SOUTH 3	III-B	В	24'-6"	1	45%		
SOUTH 4	III-B	В	28'-0'	1	70%		
WEST 1	III-B	S-2	9'-0"	1	10%		
WEST 2	III-B	В	60'-0"	0	NL		
WEST 3	III-B	В	78'-0"	0	NL		
WEST 4	III-B	В	103'-7"	0	NL		
WEST 5	III-B	В	112'-2"	0	NL		

NL= NO LIMIT

INTERIOR WALL AND CEILING FINISH FIRE/SMOKE CLASSIFICATION REQUIREMENTS/PROVIDED (NON SPRINKLERED) TABLE 803.9

OCCUPANCY	EXIT ENCLOSURES/PASSAGEWAYS	CORRIDORS	ROOMS AND ENCLOSED SPACES
В	В	С	С
S-2	С	С	С

BUILDING FIRE D	BUILDING FIRE DETECTION & SUPPRESSION									
PROVIDED: Y OR N		TYPE / CLASS	REQUIRED OR OPTIONAL	AREAS OF COVERAGE						
SPRINKLER SYSTEM:	Y	NFPA 13	REQUIRED FOR S-2	THROUGHOUT						
FIRE ALARM SYSTEM:	Υ	AUTOMATIC	REQUIRED	THROUGHOUT						
STANDPIPE SYSTEM:	Υ	CLASS 1	REQUIRED							
SMOKE DETECTION SYSTEM:	N									
NOTES & PROVISIONS: 1.										
2. 3.										


STORY		AREA (SF)	OCC. TYPE	AREA / OCC.	OCC. LOAD**	STAIRWA	Y WIDTH	DOORWAY / C	THER WIDTH	EX	ITS	TRAVEL I	DISTANCE
			SEC	TION 1004.1.1	SECTION 1004	4 SECTION 100	05 (.3" PER OC	C.) SECTION 1	005 (.2" PER O	CC.) SECTIO	N 1015/1021.1	SECTION	ON 1016
						REQUIRED	PROVIDED	REQUIRED	PROVIDED	REQUIRED	PROVIDED	REQUIRED	PROVIDE
GARAGE		25,448	S-2	200	131	39.3"	XX	26.2"	36"	2	1 (E)	200' MAX	XX' MAX
		14,364	S-2	200	71	N/A	N/A	14.2"	36"	2	1 (E)	200' MAX	XX' MAX
PLAZA		2,180	В	100	40	N/A	N/A	8"	72"	1	1 (E)	200' MAX	XX' MAX
	TOTAL AREA (SF)	16,544		TOTAL OCC.	111								
SECOND		9,055	В	100	91	27.3"	XX"	18.2"	XX"	2	2	200' MAX	
THIRD		9,183	В	100	92	27.6"		18.4"		2	2	200' MAX	
FOURTH		9,259	В	100	93	27.9"		18.6"		2	2	200' MAX	
BUILDING	TOTAL AREA (SF)	69,489		TOTAL OCC.	<u>518</u>								

PLU	MBIN	IG FIXT	URES	3														
GROUP	OCC	PER	W.C. F		W.C.		LAV FACTOR	LAVI				VIDED		O REMAIN	T	OTAL W	/C	(E) WC IN SUITES
Ortool		GENDER	M	W	M	W	Littinoioit	M	W	M	W	U	M	W	M	W	U	
В	324	162	1:25/50*	1:25/50*	5	5	1:40/80**	4	4	2	2	1	2	2	4	4	1	21
TOTAL					1	0		8	8		5		4	4		9		21
*:1 PER	25 FOR T	HE FIRST 50 A	ND 1 PER	50 FOR TH	IE REMAIN	DER EXC	EEDING 50			NEW L	AV PRO	OVIDED	(E) LAV T	O REMAIN	Т	OTAL LA	٩V	(E) LAV IN SUITES
** : 1 PEF	R 40 FOR	THE FIRST 80 A	AND 1 PER	80 FOR TI	HE REMAI	NDER EX	CEEDING 80			M	W	U	M	W	M	W	U	
										2	2	1	2	2	4	4	1	21
											5		4	4		9		21

ACCESSIBILITY UPGRADES		

ENERGY CODE SUMMARY

ENVELOPE REQUIREMENTS	
NO CHANGE TO EXISTING ENVELOPE	

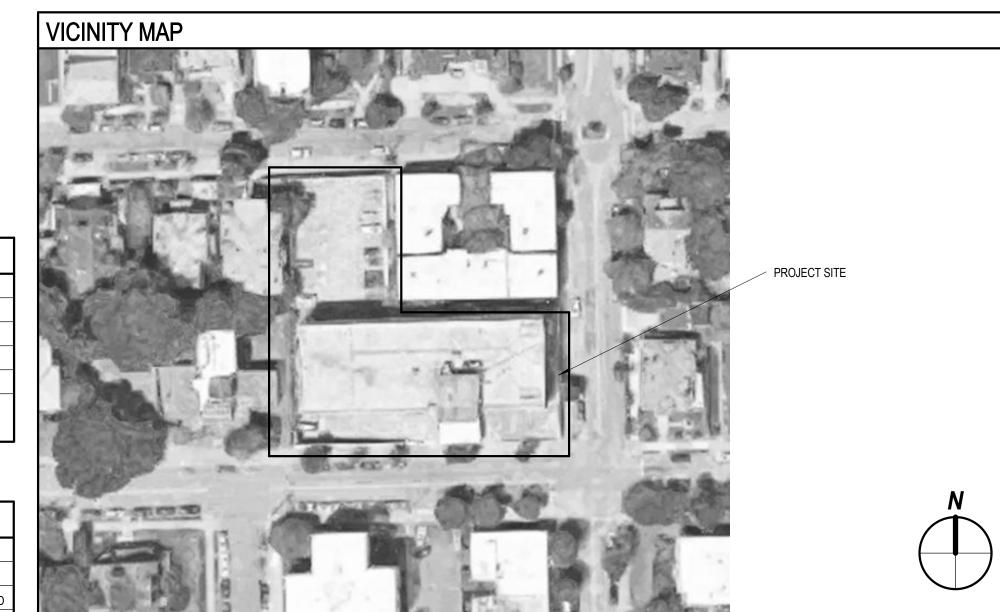

SUMMARY OF WORK

PROJECT SCOPE INCLUDES EXTENDING THE EXISTING GARAGE LEVEL SPRINKLER SYSTEM THROUGHOUT THE BUILDING, A NEW MECHANICAL SHAFT, REPLACEMENT OF EXTERIOR STOREFRONT AT PLAZA LEVEL ENTRIES, NEW ACCESSIBLE TOILET ROOMS, ACCESSIBILITY UPGRADES TO EXISTING GARAGE LEVEL PARKING, AND LOBBY/CORRIDOR LIGHTING AND INTERIOR FINISH UPGRADES.

PROJECT DESCRIPTION	
PROJECT NAME: LOVEJOY MEDICAL	PROJECT ADDRESS: 2525 NW LOVEJOY ST, PORTLAND OR 97210
NEW CONSTRUCTION OR ALTERATION: ALTERATION	CHANGE OF USE OR OCCUPANCY:

SITE INFORMATION							
SITE ADDRESS: 2525 NW LOVEJOY ST, PORTLAND OR	97210	SITE AREA: 0	63 ACRE, 27,500 S	F			
TAX LOT NUMBER: GOLDSMITHS ADDITION, BLOCK 19	5, LOT 200	TAX ROLL: R	171493				
BASE ZONE: RH		OVERLAY(S):	N/A				
PLAN DISTRICT: N/A							
BASE ZONE REGULATIONS		<u>'</u>					
FAR: 2:1 ALLOWED (2.5:1 EXISTING)							
MAXIMUM SETBACKS:	FRONT: 0' ALLOWED			BACK: TABLE	120-4		
	STREET: 0' ALLOWED		SIDE: TABLE 120-4				
PROPOSED USES	EXISTING NONCONFO	RMING OFFICE USE TO F	REMAIN				
BASE ZONE MODIFICATIONS / BONUSES							
FAR		MAX HEIGHT	MAX HEIGHT				
PARKING & LOADING REGULATIONS: N/A		·					
DISTANCE FROM TRANSIT STOP		LOADING REC	LOADING REQ'D: 1 LOADING SPACE (20,000=50,000 NET SF OF BUILDING AREA)				
VEHICLE PARKING MAX. SPACES ALLOWED: 198 (1:20	4 NET SF OF BUILDING AREA)	VEHICLE PAR	VEHICLE PARKING MIN. SPACES ALLOWED: 81 (1:500 NET SF OF BUILDING AREA)				
CENTRAL CITY PARKING REQUIREMENTS: N/A							
BIKE PARKING:		SPACES REQ	JIRED	SPACES PROV	/IDED		
USE	SF	LONG TERM	SHORT TERM	LONG TERM	SHORT TERM		
OFFICE	40,361	4	2	XX	XX		
DESIGN REVIEW REQ'D: N/A		CASE FILE #:	•	•			

DEFERRED SUBMITTALS & TRADE PERMITS

THE FOLLOWING SYSTEMS ARE SUBJECT TO DEFERRED SUBMITTALS IN ACCORDANCE WITH IBC 107:

ELECTRICAL MODIFICATIONS

MECHANICAL MODIFICATIONS PLUMBING MODIFICATIONS

STOREFRONT SYSTEM

FIRE SPRINKLERS FIRE ALARM

JONES

JONES ARCHITECTURE

1231 NW Hoyt St. Ste. 404 Portland, OR 97209 T 503 477 9165

LOVEJOY MEDICAL

2525 N.W. LOVEJOY ST. PORTLAND, OR. 97210

NOT FOR CONSTRUCTION

DRAFT APPEAL

Issue Date: 05/05/17


COPYRIGHT:

THESE PLANS ARE AN INSTRUMENT OF THE SERVICE AND ARE THE PROPERTY OF THE ARCHITECT, AND MAY NOT BE DUPLICATED, DISCLOSED, OR REPRODUCED WITHOUT THE WRITTEN CONSENT OF THE ARCHITECT. COPYRIGHTS AND INFRINGMENTS WILL BE ENFORCED AND PROSECUTED.

REVISIONS:

CODE SUMMARY

Sheet Name

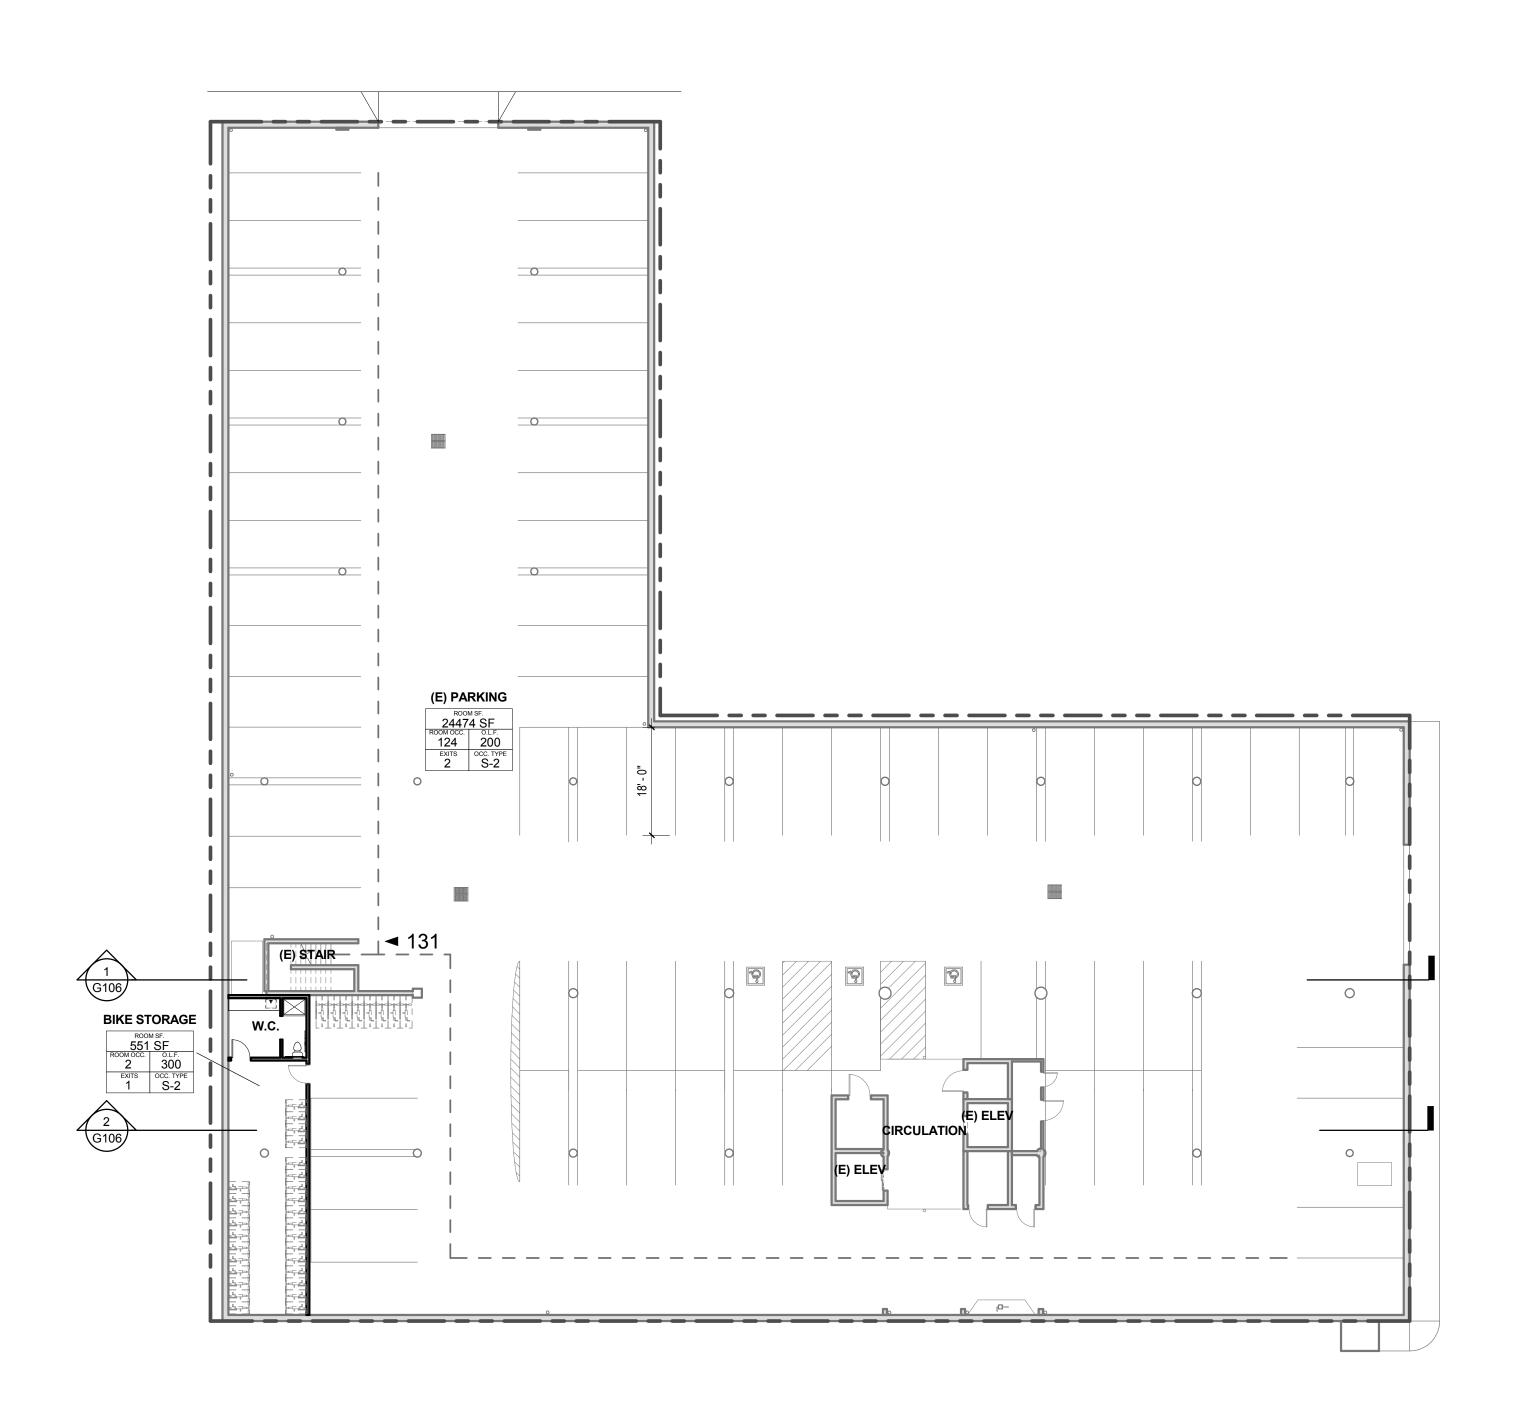


GARAGE LIFE SAFETY PLAN

G100 1/16" = 1'-0"

LEGEND:

LIGHTED EXIT PATH (MIN. 44" WIDE) W/MIN 1FC

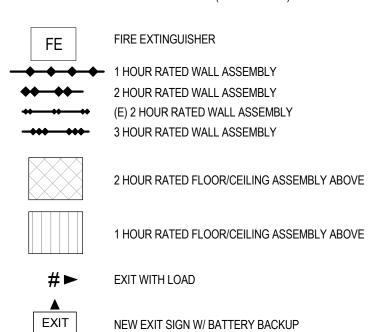

RATED OPENING (MINUTES)

ROOM AREA

OCC OCC FACTOR
EXITS OCC
TYPE

ROOM OCCUPANCY TAG

4. ALL EXIT SIGNAGE IS NEW

NOTES:

1. PROVIDE 1 FOOT CANDLE OF LIGHT ALONG EGRESS PATH.

2. SERVICE TO BE BY BACKUP POWER VIA UPS BATTERY BACKUP SYSTEM.

3. EMERGENCY EGRESS LIGHTING TO BE PROVIDED AT BOTH EGRESS STAIRS ON ALL LEVELS.

JONES

JONES ARCHITECTURE

1231 NW Hoyt St. Ste. 404 Portland, OR 97209 T 503 477 9165

jonesarc.com

LOVEJOY MEDICAL

2525 N.W. LOVEJOY ST. PORTLAND, OR. 97210

NOT FOR CONSTRUCTION

DRAFT APPEAL

Issue Date: 05/05/17

COPYRIGHT:


THESE PLANS ARE AN INSTRUMENT OF THE SERVICE AND ARE THE PROPERTY OF THE ARCHITECT, AND MAY NOT BE DUPLICATED, DISCLOSED, OR REPRODUCED WITHOUT THE WRITTEN CONSENT OF THE ARCHITECT. COPYRIGHTS AND INFRINGMENTS WILL BE ENFORCED AND PROSECUTED.

REVISIONS:

GARAGE LIFE SAFETY PLAN

Sheet Name

G100

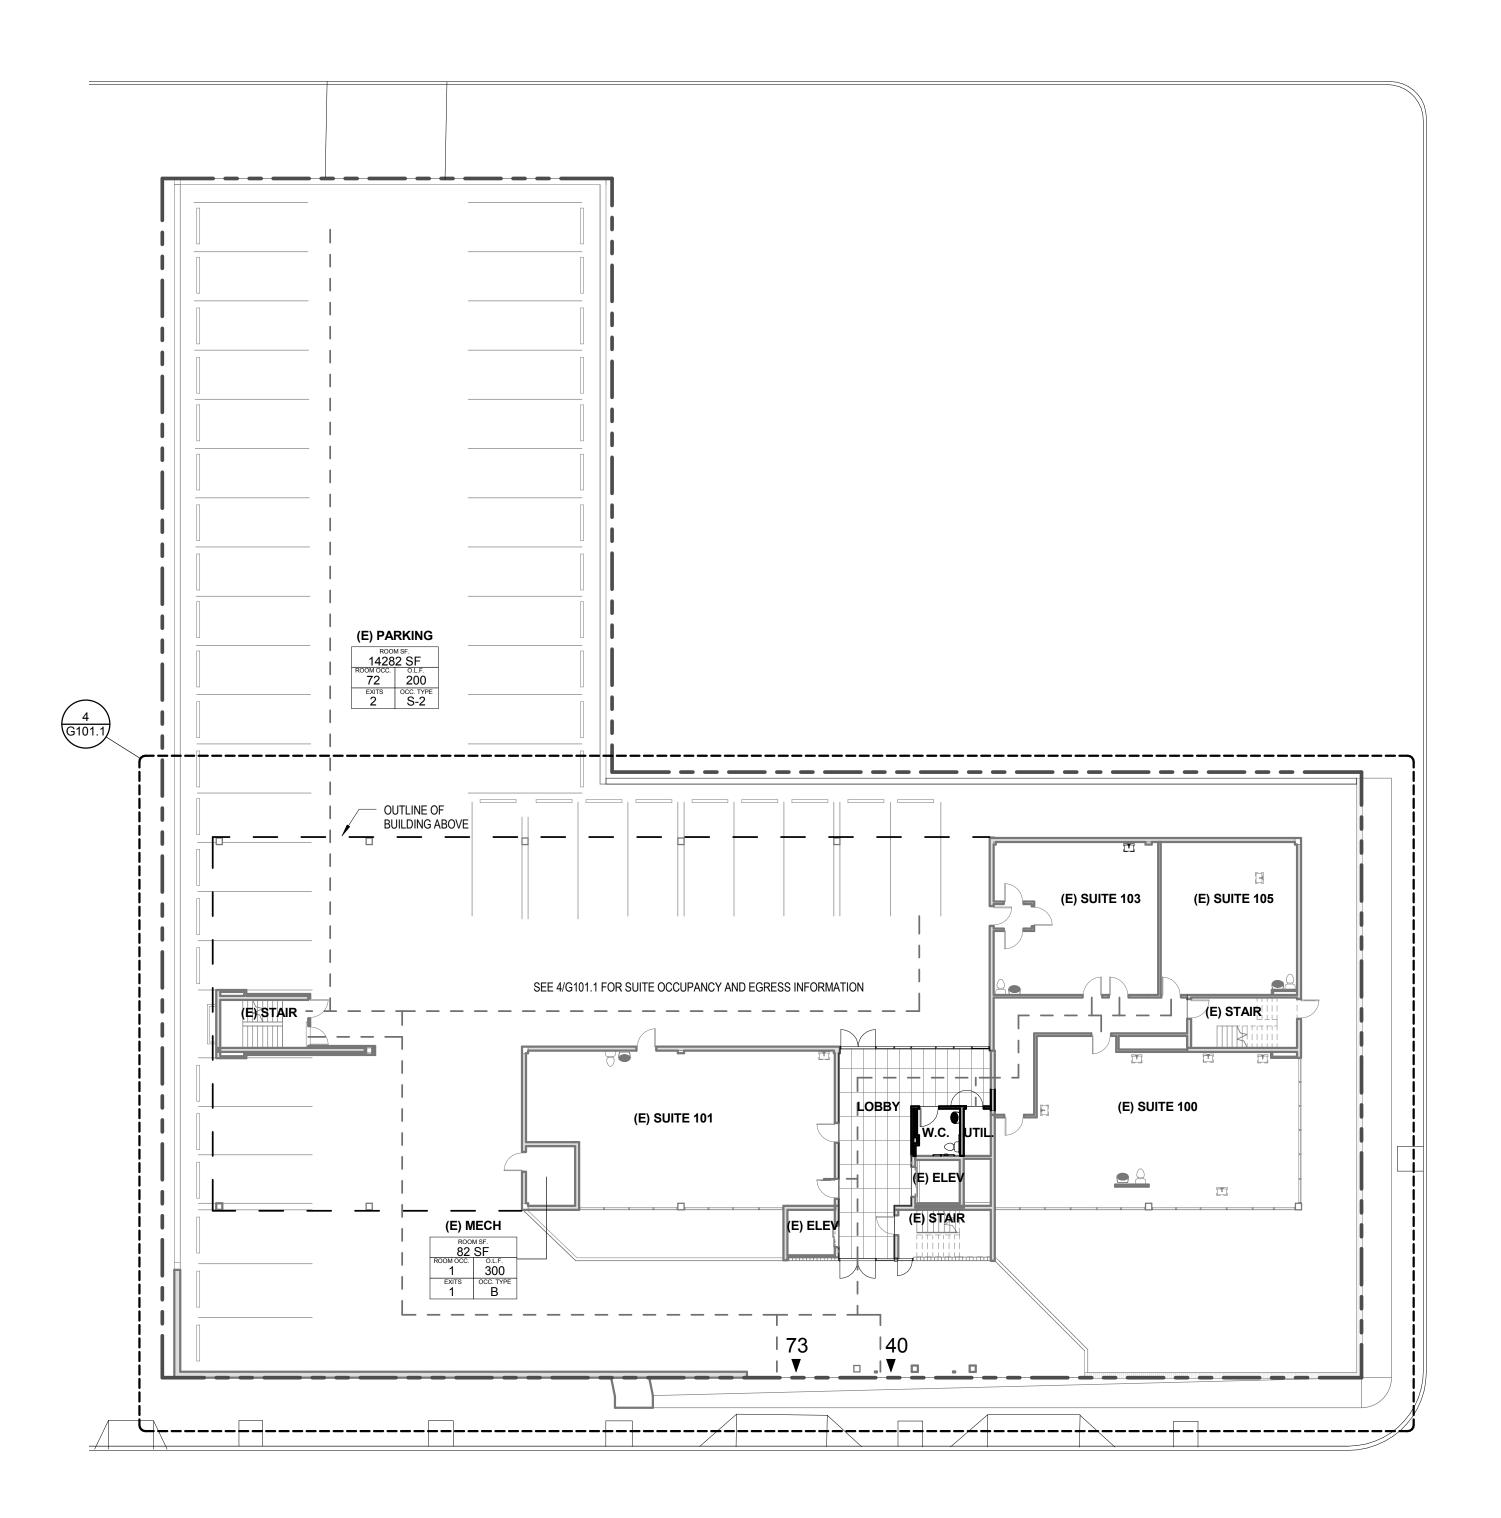

1 PLAZA LIFE SAFETY PLAN G101 1/16" = 1'-0"

LEGEND:

LIGHTED EXIT PATH (MIN. 44" WIDE) W/MIN 1FC

FE FIRE EXTINGUISHER 1 HOUR RATED WALL ASSEMBLY ◆◆ ◆◆ 2 HOUR RATED WALL ASSEMBLY ★ ★ ★ ★ (E) 2 HOUR RATED WALL ASSEMBLY → → → → → 3 HOUR RATED WALL ASSEMBLY

2 HOUR RATED FLOOR/CEILING ASSEMBLY ABOVE

1 HOUR RATED FLOOR/CEILING ASSEMBLY ABOVE

EXIT WITH LOAD

EXIT

NEW EXIT SIGN W/ BATTERY BACKUP RATED OPENING (MINUTES)

OCC LOAD FACTOR ROOM OCCUPANCY TAG

EXITS OCC TYPE

1. PROVIDE 1 FOOT CANDLE OF LIGHT ALONG EGRESS PATH.
2. SERVICE TO BE BY BACKUP POWER VIA UPS BATTERY BACKUP SYSTEM.
3. EMERGENCY EGRESS LIGHTING TO BE PROVIDED AT BOTH EGRESS STAIRS ON ALL LEVELS.

4. ALL EXIT SIGNAGE IS NEW

JONES

JONES ARCHITECTURE

1231 NW Hoyt St. Ste. 404 Portland, OR 97209 T 503 477 9165

jonesarc.com

LOVEJOY MEDICAL

2525 N.W. LOVEJOY ST. PORTLAND, OR. 97210

NOT FOR CONSTRUCTION

DRAFT APPEAL

Issue Date: 05/05/17

COPYRIGHT:

THESE PLANS ARE AN INSTRUMENT OF THE SERVICE AND ARE THE PROPERTY OF THE ARCHITECT, AND MAY NOT BE DUPLICATED, DISCLOSED, OR REPRODUCED WITHOUT THE WRITTEN CONSENT OF THE ARCHITECT.

COPYRIGHTS AND INFRINGMENTS WILL BE ENEODEED AND PROSECULTED.

ENFORCED AND PROSECUTED.

REVISIONS:

PLAZA LIFE SAFETY PLAN

Sheet Name

LEGEND:

LIGHTED EXIT PATH (MIN. 44" WIDE) W/MIN 1FC

FIRE EXTINGUISHER 1 HOUR RATED WALL ASSEMBLY ◆◆ ◆◆ 2 HOUR RATED WALL ASSEMBLY **★ ★ ★ ★ (E)** 2 HOUR RATED WALL ASSEMBLY → → → → → → 3 HOUR RATED WALL ASSEMBLY

2 HOUR RATED FLOOR/CEILING ASSEMBLY ABOVE



EXIT WITH LOAD



NEW EXIT SIGN W/ BATTERY BACKUP

1. PROVIDE 1 FOOT CANDLE OF LIGHT ALONG EGRESS PATH.
2. SERVICE TO BE BY BACKUP POWER VIA UPS BATTERY BACKUP SYSTEM.
3. EMERGENCY EGRESS LIGHTING TO BE PROVIDED AT BOTH EGRESS STAIRS ON

DRAFT APPEAL

Issue Date: 05/05/17

JONES

JONES ARCHITECTURE

LOVEJOY MEDICAL

2525 N.W. LOVEJOY ST.

NOT FOR CONSTRUCTION

PORTLAND, OR. 97210

1231 NW Hoyt St. Ste. 404 Portland, OR 97209 T 503 477 9165

jonesarc.com

COPYRIGHT:

THESE PLANS ARE AN INSTRUMENT OF THE SERVICE AND ARE THE PROPERTY OF THE ARCHITECT, AND MAY NOT BE DUPLICATED, DISCLOSED, OR REPRODUCED WITHOUT THE WRITTEN CONSENT OF THE ARCHITECT. COPYRIGHTS AND INFRINGMENTS WILL BE ENFORCED AND PROSECUTED.

REVISIONS:

PLAZA LIFE SAFETY PLAN - BASE

Sheet Name

G101.1

LEGEND:

LIGHTED EXIT PATH (MIN. 44" WIDE) W/MIN 1FC

FE FIRE EXTINGUISHER

1 HOUR RATED WALL ASSEMBLY
2 HOUR RATED WALL ASSEMBLY
(E) 2 HOUR RATED WALL ASSEMBLY
3 HOUR RATED WALL ASSEMBLY

2 HOUR RA

2 HOUR RATED FLOOR/CEILING ASSEMBLY ABOVE

1 HOUR RATED FLOOR/CEILING ASSEMBLY ABOVE

#► EXIT WITH LOAD

NEW EXIT SIGN W/ BATTERY BACKUP

RATED OPENING (MINUTES)

ROOM AREA

OCC OCC LOAD FACTOR

EXITS OCC TYPE

ROOM OCCUPANCY TAG

NOTES:

1. PROVIDE 1 FOOT CANDLE OF LIGHT ALONG EGRESS PATH.

2. SERVICE TO BE BY BACKUP POWER VIA UPS BATTERY BACKUP SYSTEM.

3. EMERGENCY EGRESS LIGHTING TO BE PROVIDED AT BOTH EGRESS STAIRS ON ALL LEVELS.

4. ALL EXIT SIGNAGE IS NEW

NOT FOR

CONSTRUCTION

JONES

JONES ARCHITECTURE

LOVEJOY MEDICAL


2525 N.W. LOVEJOY ST.

PORTLAND, OR. 97210

1231 NW Hoyt St. Ste. 404

Portland, OR 97209 T 503 477 9165

jonesarc.com

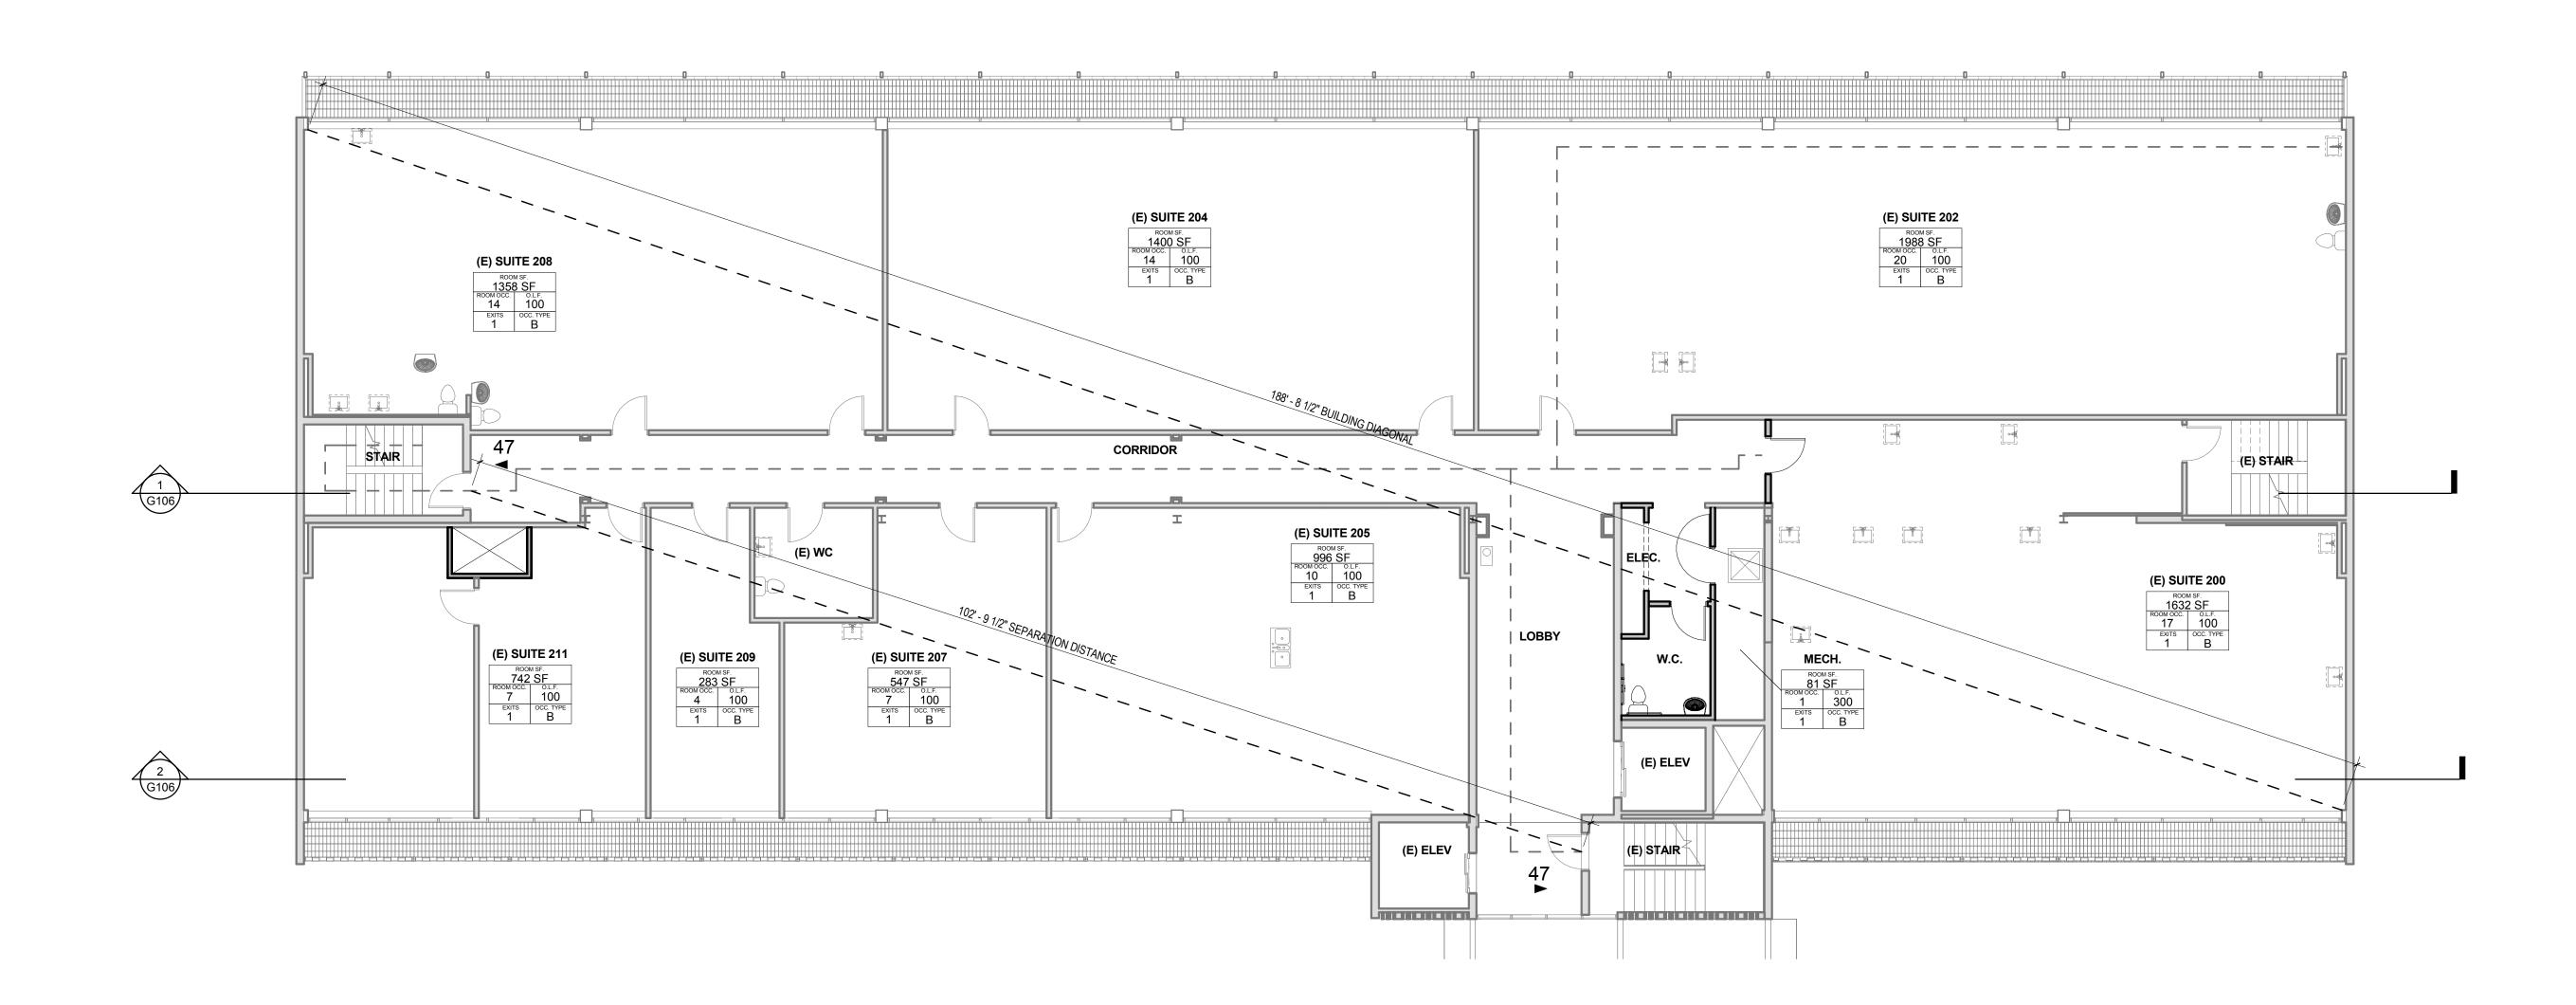

1 SECOND STORY LIFE SAFETY PLAN
1/8" = 1'-0"

SECOND STORY LIFE SAFETY PLAN

Sheet Name

DRAFT APPEAL

Issue Date: 05/05/17

THESE PLANS ARE AN INSTRUMENT OF THE SERVICE AND ARE THE PROPERTY OF THE ARCHITECT, AND MAY NOT BE DUPLICATED, DISCLOSED, OR REPRODUCED WITHOUT THE WRITTEN CONSENT OF THE ARCHITECT. COPYRIGHTS AND INFRINGMENTS WILL BE ENFORCED AND PROSECUTED.

COPYRIGHT:

REVISIONS:

G102

LEGEND:

LIGHTED EXIT PATH (MIN. 44" WIDE) W/MIN 1FC

FIRE EXTINGUISHER 1 HOUR RATED WALL ASSEMBLY ◆◆ ◆◆ 2 HOUR RATED WALL ASSEMBLY **↔ ••** (E) 2 HOUR RATED WALL ASSEMBLY →◆◆ →◆◆ 3 HOUR RATED WALL ASSEMBLY

2 HOUR RATED FLOOR/CEILING ASSEMBLY ABOVE

1 HOUR RATED FLOOR/CEILING ASSEMBLY ABOVE

EXIT WITH LOAD


NEW EXIT SIGN W/ BATTERY BACKUP

RATED OPENING (MINUTES) ROOM AREA EXITS OCC TYPE

OCC OCC PACTOR ROOM OCCUPANCY TAG

1. PROVIDE 1 FOOT CANDLE OF LIGHT ALONG EGRESS PATH. 2. SERVICE TO BE BY BACKUP POWER VIA UPS BATTERY BACKUP SYSTEM.

3. EMERGENCY EGRESS LIGHTING TO BE PROVIDED AT BOTH EGRESS STAIRS ON ALL LEVELS. 4. ALL EXIT SIGNAGE IS NEW

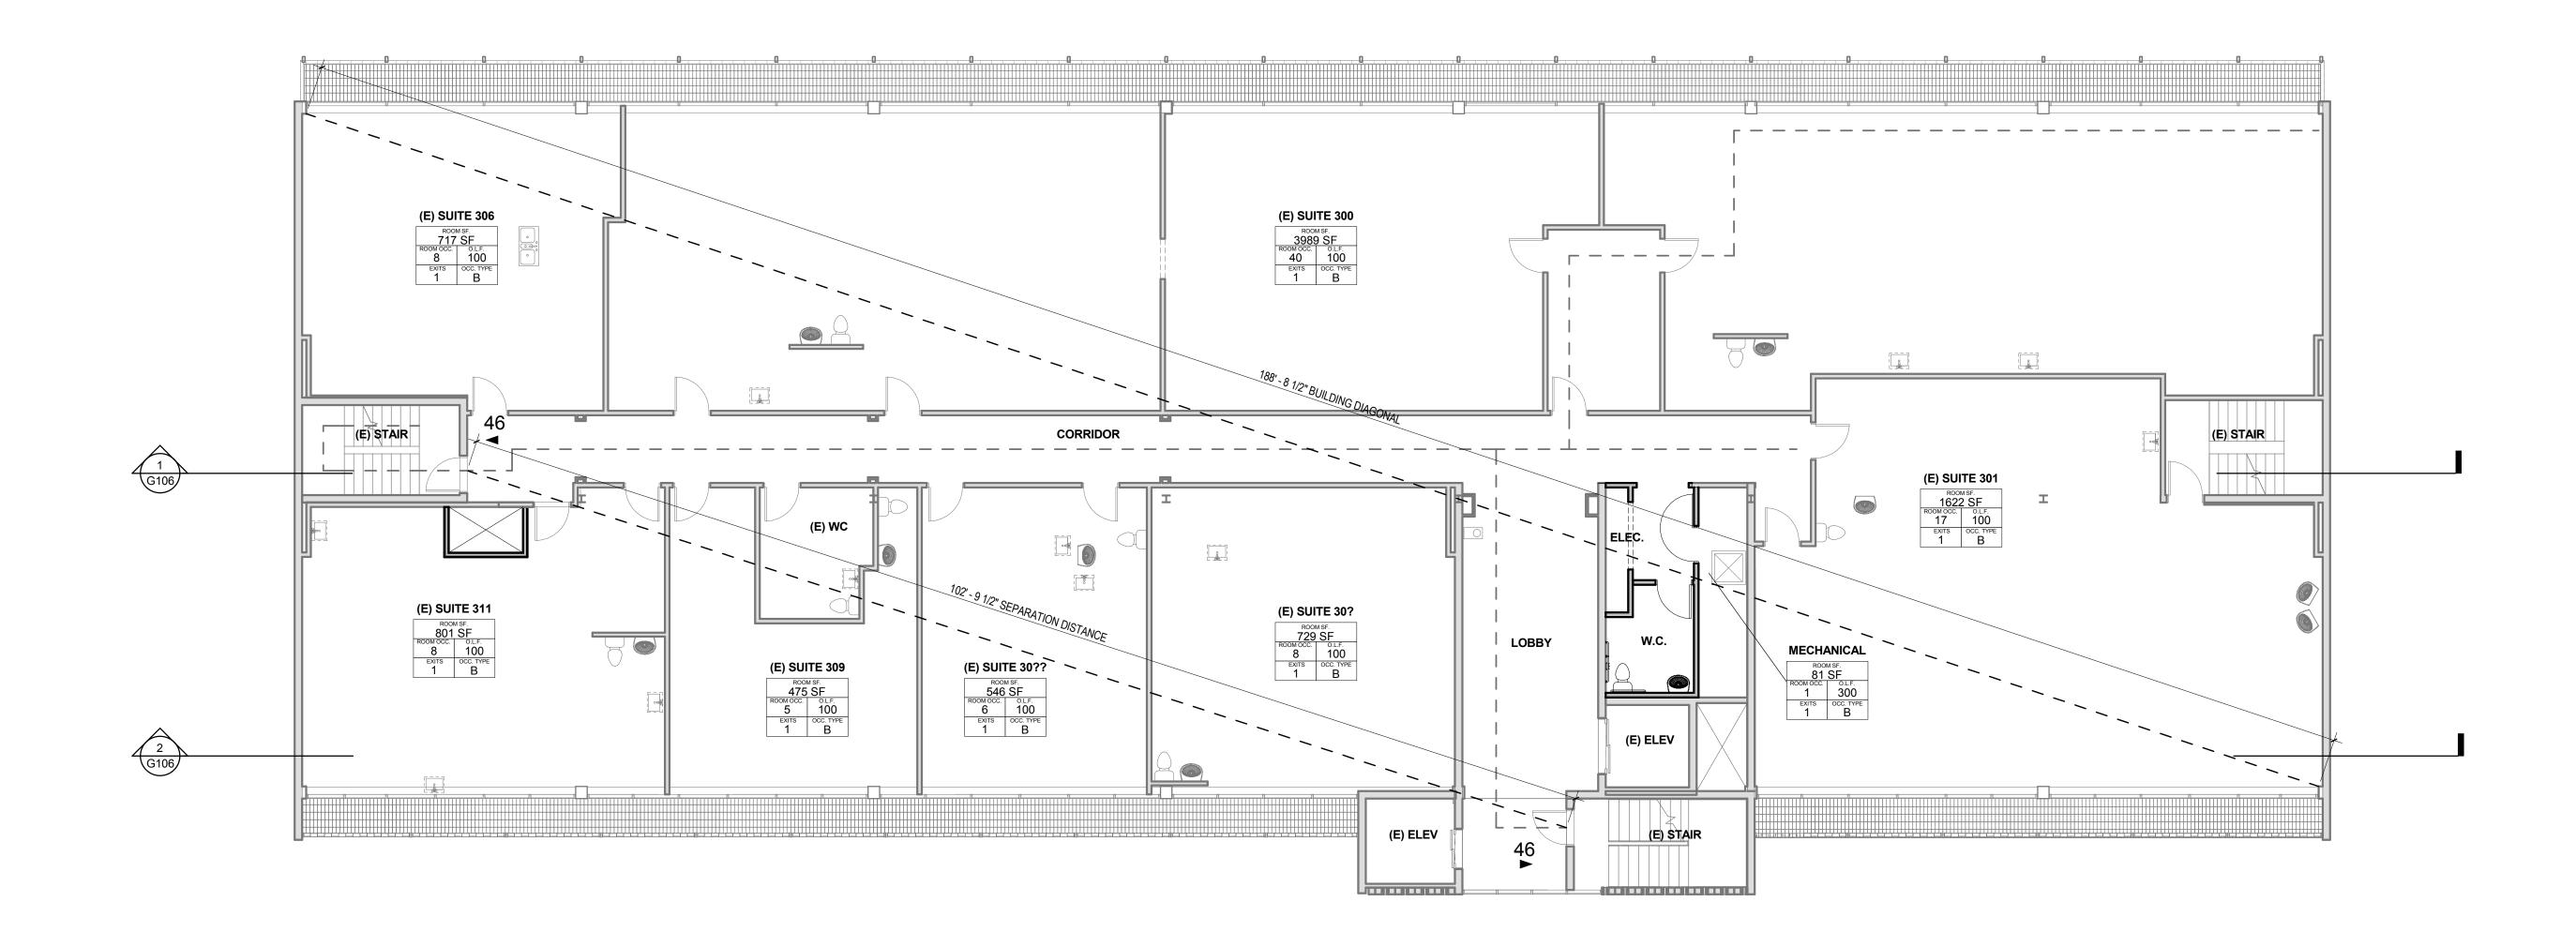

1 THIRD STORY LIFE SAFETY PLAN

G103 1/8" = 1'-0"

THIRD STORY LIFE SAFETY PLAN

JONES

JONES ARCHITECTURE

LOVEJOY MEDICAL

2525 N.W. LOVEJOY ST.

NOT FOR

CONSTRUCTION

PORTLAND, OR. 97210

1231 NW Hoyt St. Ste. 404 Portland, OR 97209 T 503 477 9165

Sheet Name

DRAFT APPEAL

Issue Date: 05/05/17

THESE PLANS ARE AN INSTRUMENT OF THE SERVICE AND ARE THE PROPERTY OF THE ARCHITECT, AND MAY NOT BE DUPLICATED, DISCLOSED, OR REPRODUCED WITHOUT THE WRITTEN CONSENT OF THE ARCHITECT. COPYRIGHTS AND INFRINGMENTS WILL BE ENFORCED AND PROSECUTED.

COPYRIGHT:

REVISIONS:

G103

LIGHTED EXIT PATH (MIN. 44" WIDE) W/MIN 1FC

FIRE EXTINGUISHER → ◆ ◆ ◆ ◆ 1 HOUR RATED WALL ASSEMBLY ◆◆─◆◆ 2 HOUR RATED WALL ASSEMBLY **↔ •• ••** (E) 2 HOUR RATED WALL ASSEMBLY → → → → → 3 HOUR RATED WALL ASSEMBLY

2 HOUR RATED FLOOR/CEILING ASSEMBLY ABOVE

1 HOUR RATED FLOOR/CEILING ASSEMBLY ABOVE

EXIT WITH LOAD


NEW EXIT SIGN W/ BATTERY BACKUP

RATED OPENING (MINUTES)

occ occ ractor ROOM OCCUPANCY TAG EXITS OCC TYPE

4. ALL EXIT SIGNAGE IS NEW

1. PROVIDE 1 FOOT CANDLE OF LIGHT ALONG EGRESS PATH.
2. SERVICE TO BE BY BACKUP POWER VIA UPS BATTERY BACKUP SYSTEM.
3. EMERGENCY EGRESS LIGHTING TO BE PROVIDED AT BOTH EGRESS STAIRS ON ALL LEVELS.

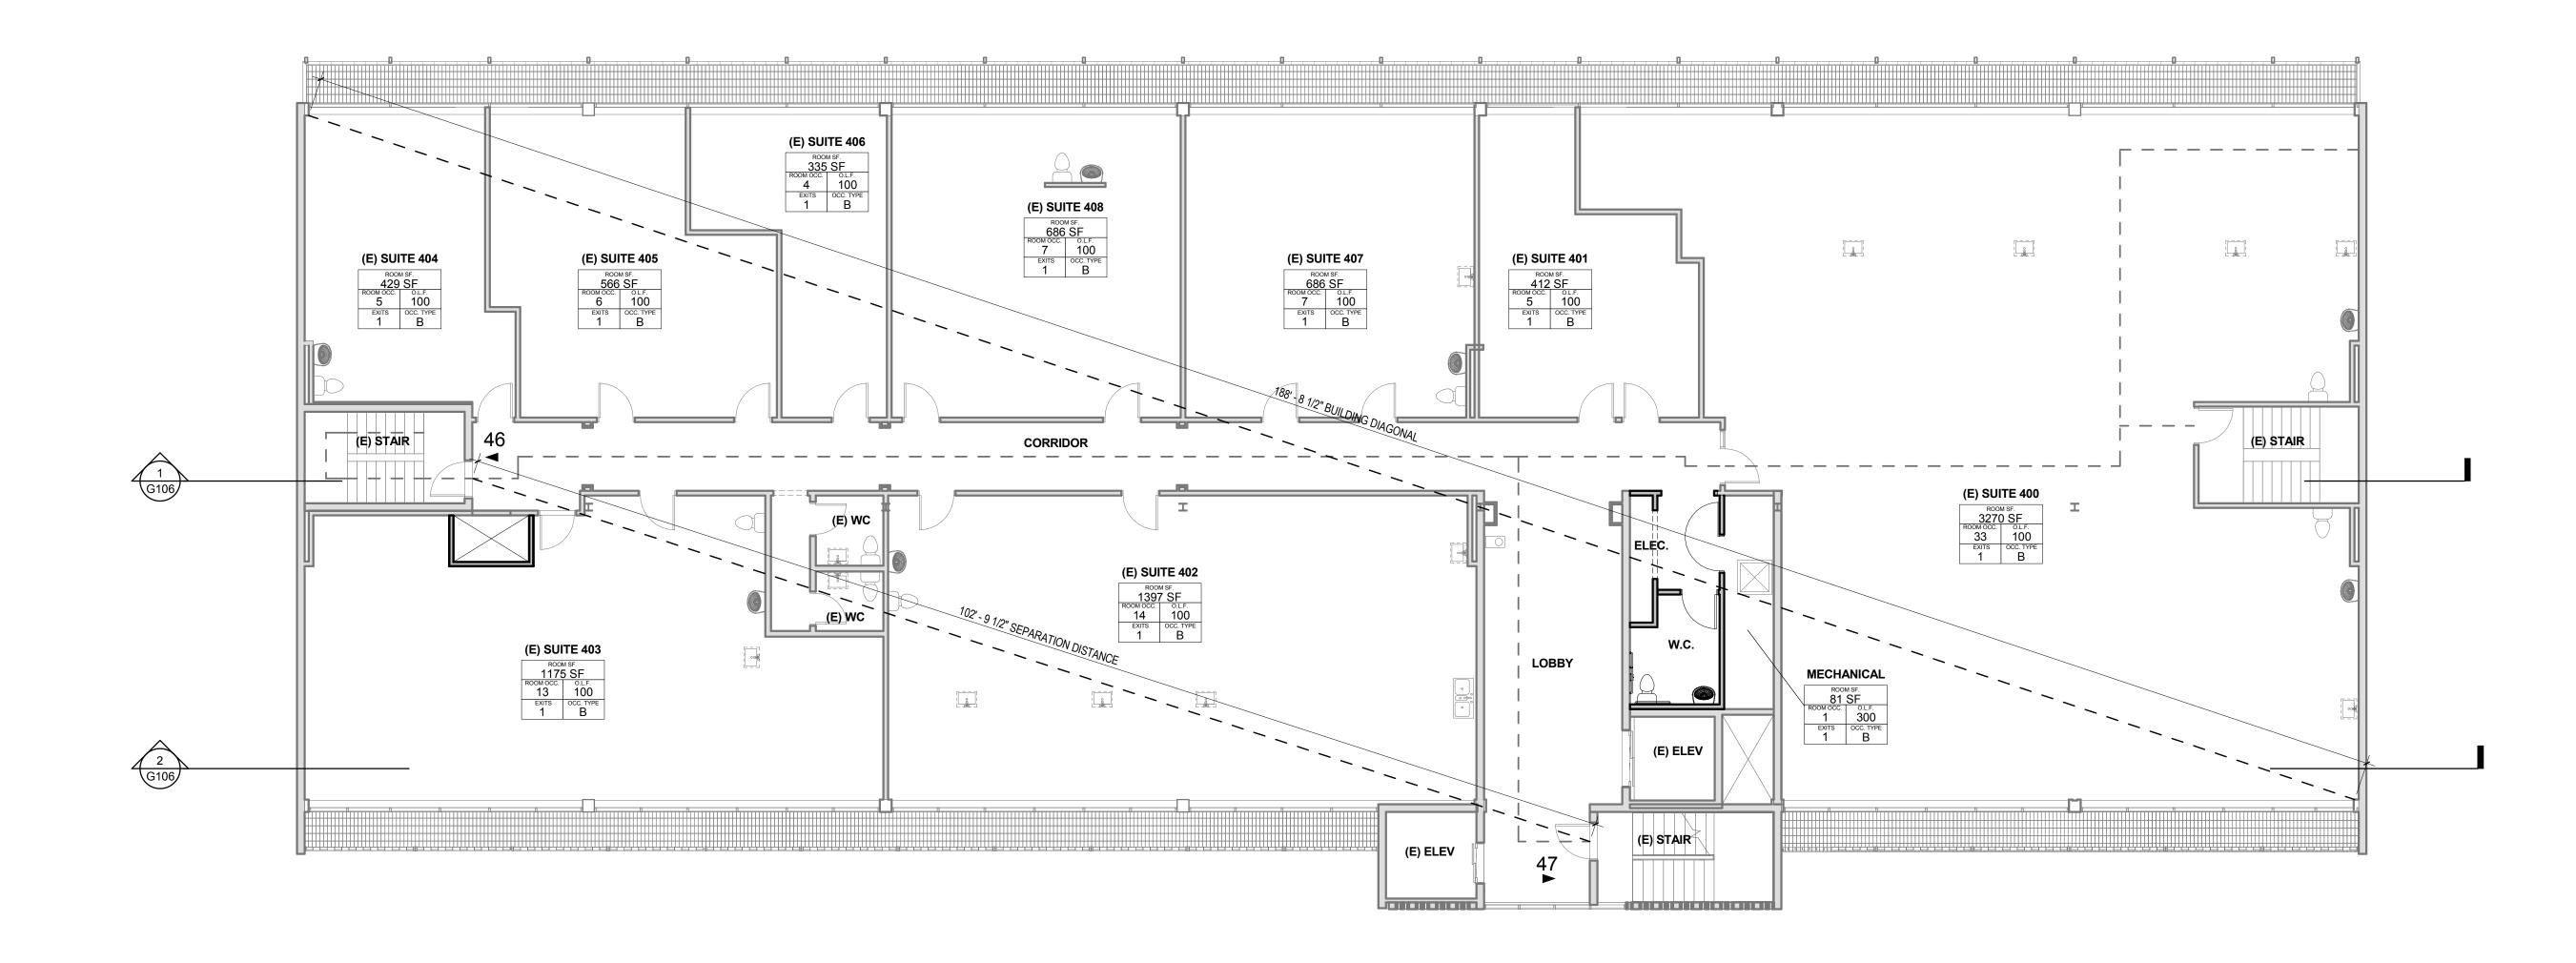

1 FOURTH STORY LIFE SAFETY PLAN G104 1/8" = 1'-0"

DRAFT APPEAL

JONES

JONES ARCHITECTURE

LOVEJOY MEDICAL

2525 N.W. LOVEJOY ST.

NOT FOR CONSTRUCTION

PORTLAND, OR. 97210

1231 NW Hoyt St. Ste. 404

Portland, OR 97209 T 503 477 9165

jonesarc.com

Issue Date: 05/05/17

COPYRIGHT:


THESE PLANS ARE AN INSTRUMENT OF THE SERVICE AND ARE THE PROPERTY OF THE ARCHITECT, AND MAY NOT BE DUPLICATED, DISCLOSED, OR REPRODUCED WITHOUT THE WRITTEN CONSENT OF THE ARCHITECT. COPYRIGHTS AND INFRINGMENTS WILL BE ENFORCED AND PROSECUTED.

REVISIONS:

FOURTH STORY LIFE SAFETY PLAN

Sheet Name

G104

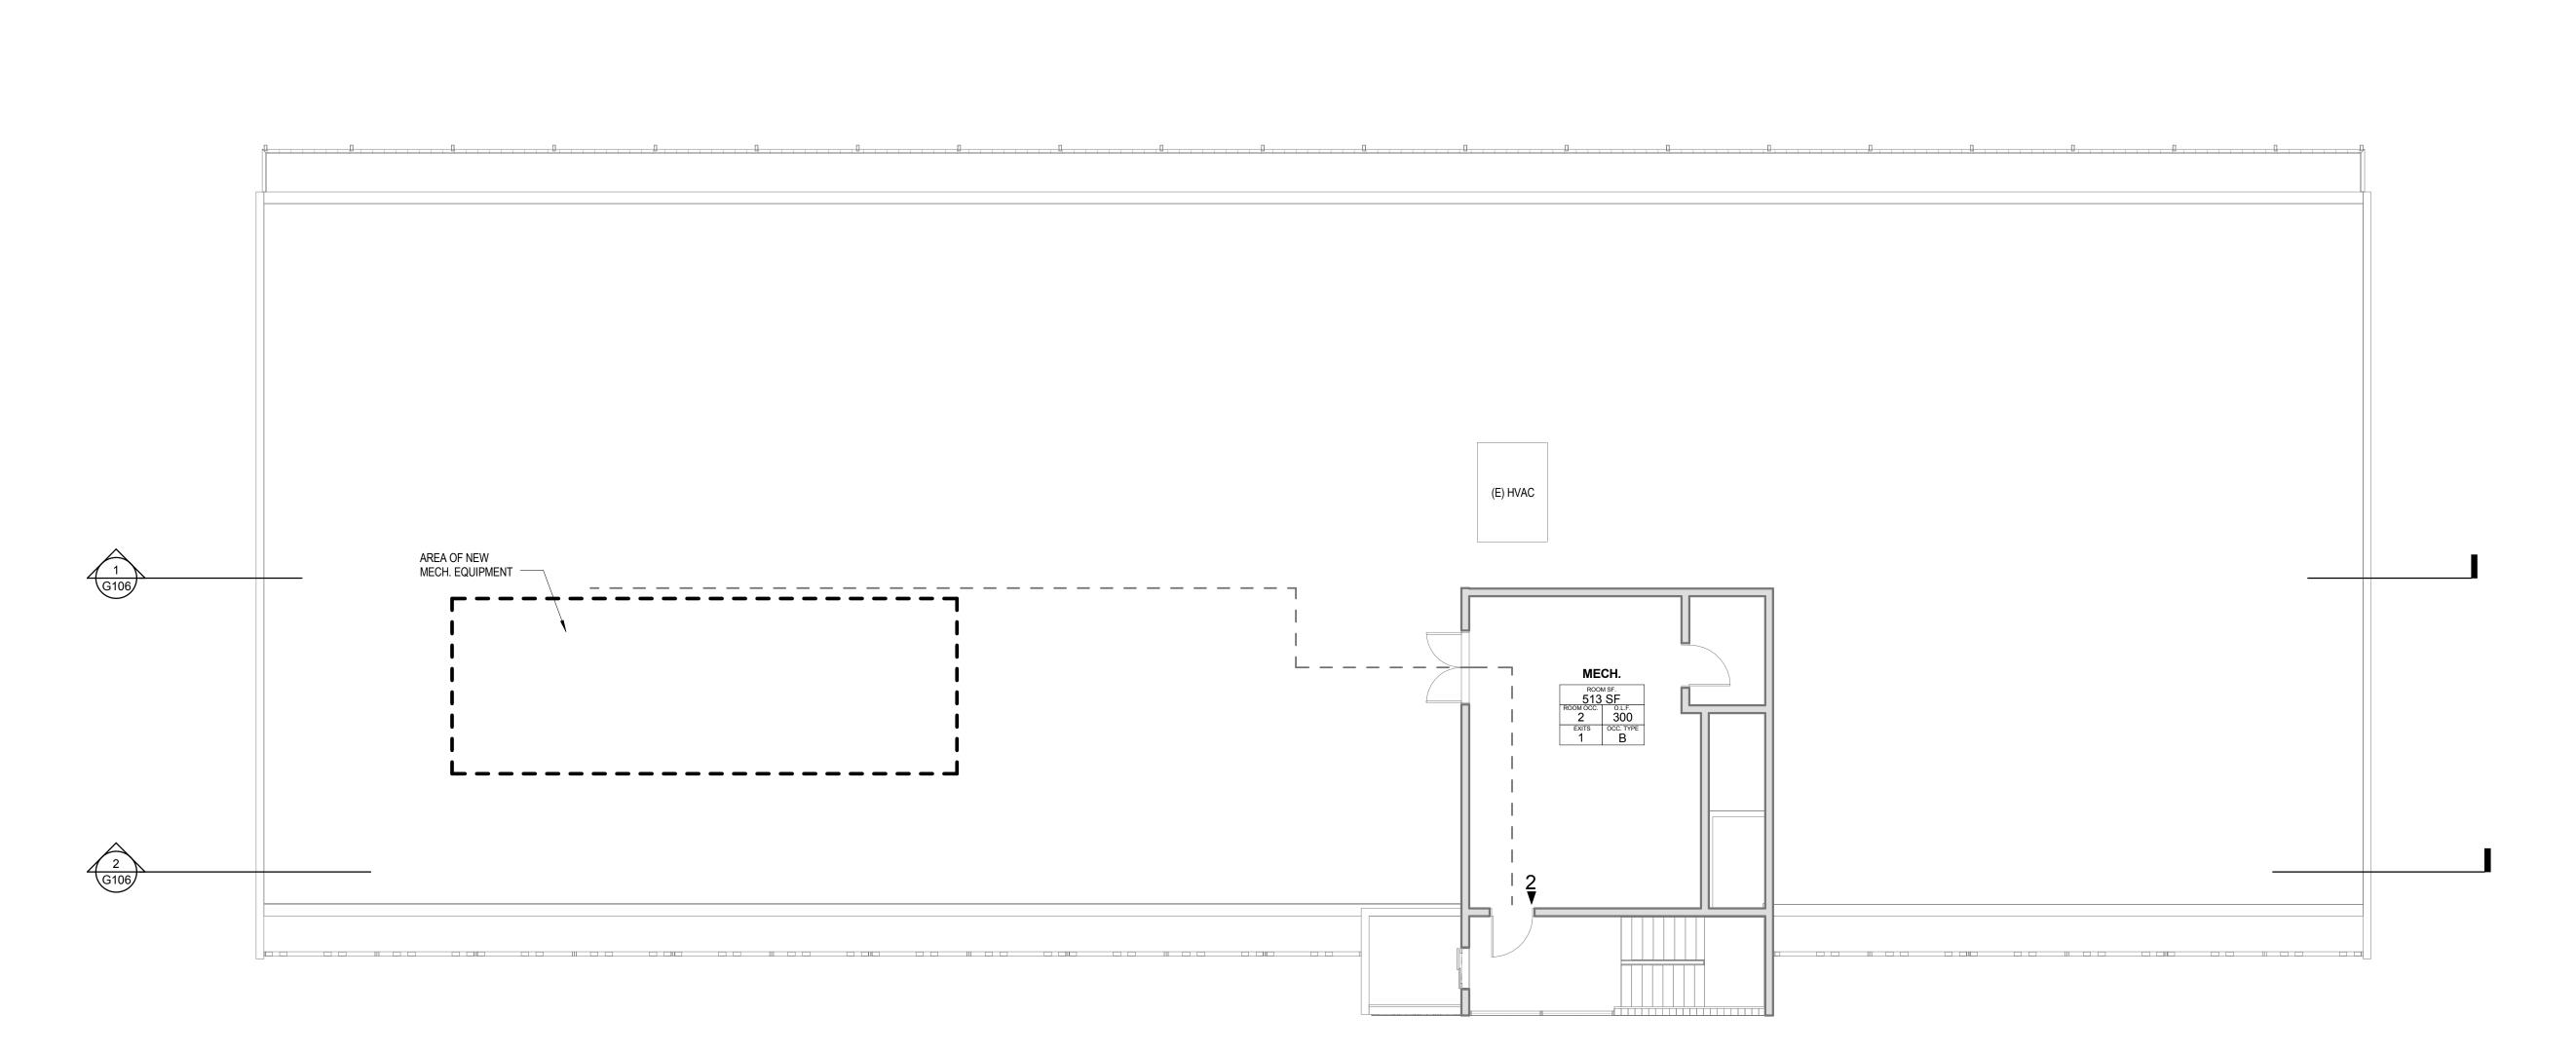

ROOF LIFE SAFETY PLAN

G105 1/8" = 1'-0"

LEGEND:

LIGHTED EXIT PATH (MIN. 44" WIDE) W/MIN 1FC

FIRE EXTINGUISHER 1 HOUR RATED WALL ASSEMBLY ◆◆ ◆◆ 2 HOUR RATED WALL ASSEMBLY **★ ★ ★ ★ (E)** 2 HOUR RATED WALL ASSEMBLY → → → → → → 3 HOUR RATED WALL ASSEMBLY


2 HOUR RATED FLOOR/CEILING ASSEMBLY ABOVE



1 HOUR RATED FLOOR/CEILING ASSEMBLY ABOVE



NEW EXIT SIGN W/ BATTERY BACKUP

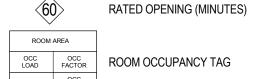

OCC OCC FACTOR ROOM OCCUPANCY TAG EXITS OCC TYPE

1. PROVIDE 1 FOOT CANDLE OF LIGHT ALONG EGRESS PATH. 2. SERVICE TO BE BY BACKUP POWER VIA UPS BATTERY BACKUP SYSTEM.
3. EMERGENCY EGRESS LIGHTING TO BE PROVIDED AT BOTH EGRESS STAIRS ON ALL LEVELS.
4. ALL EXIT SIGNAGE IS NEW

DRAFT APPEAL

Issue Date: 05/05/17

JONES ARCHITECTURE

LOVEJOY MEDICAL

2525 N.W. LOVEJOY ST.

NOT FOR

CONSTRUCTION

PORTLAND, OR. 97210

1231 NW Hoyt St. Ste. 404

Portland, OR 97209 T 503 477 9165

jonesarc.com

COPYRIGHT:


THESE PLANS ARE AN INSTRUMENT OF THE SERVICE AND ARE THE PROPERTY OF THE ARCHITECT, AND MAY NOT BE DUPLICATED, DISCLOSED, OR REPRODUCED WITHOUT THE WRITTEN CONSENT OF THE ARCHITECT. COPYRIGHTS AND INFRINGMENTS WILL BE ENFORCED AND PROSECUTED.

REVISIONS:


ROOF LIFE SAFETY PLAN

Sheet Name



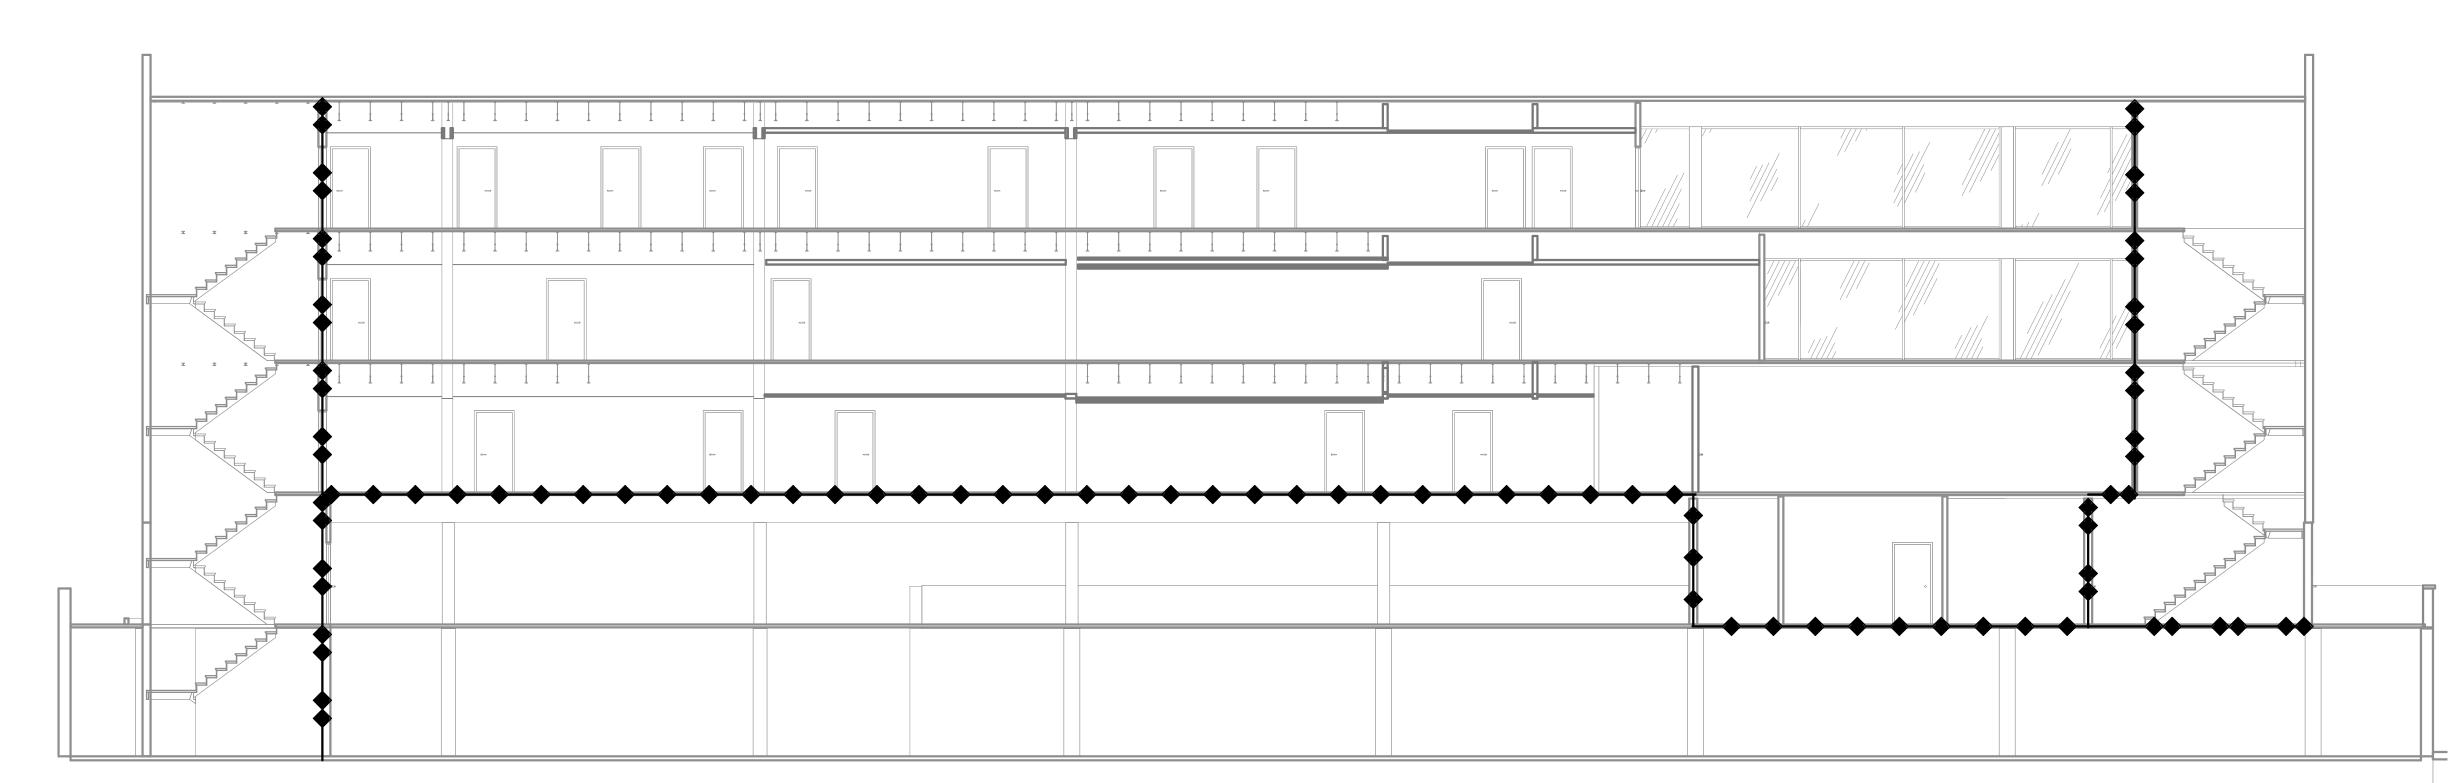

LIFE SAFETY SECTION THROUGH CORRIDOR

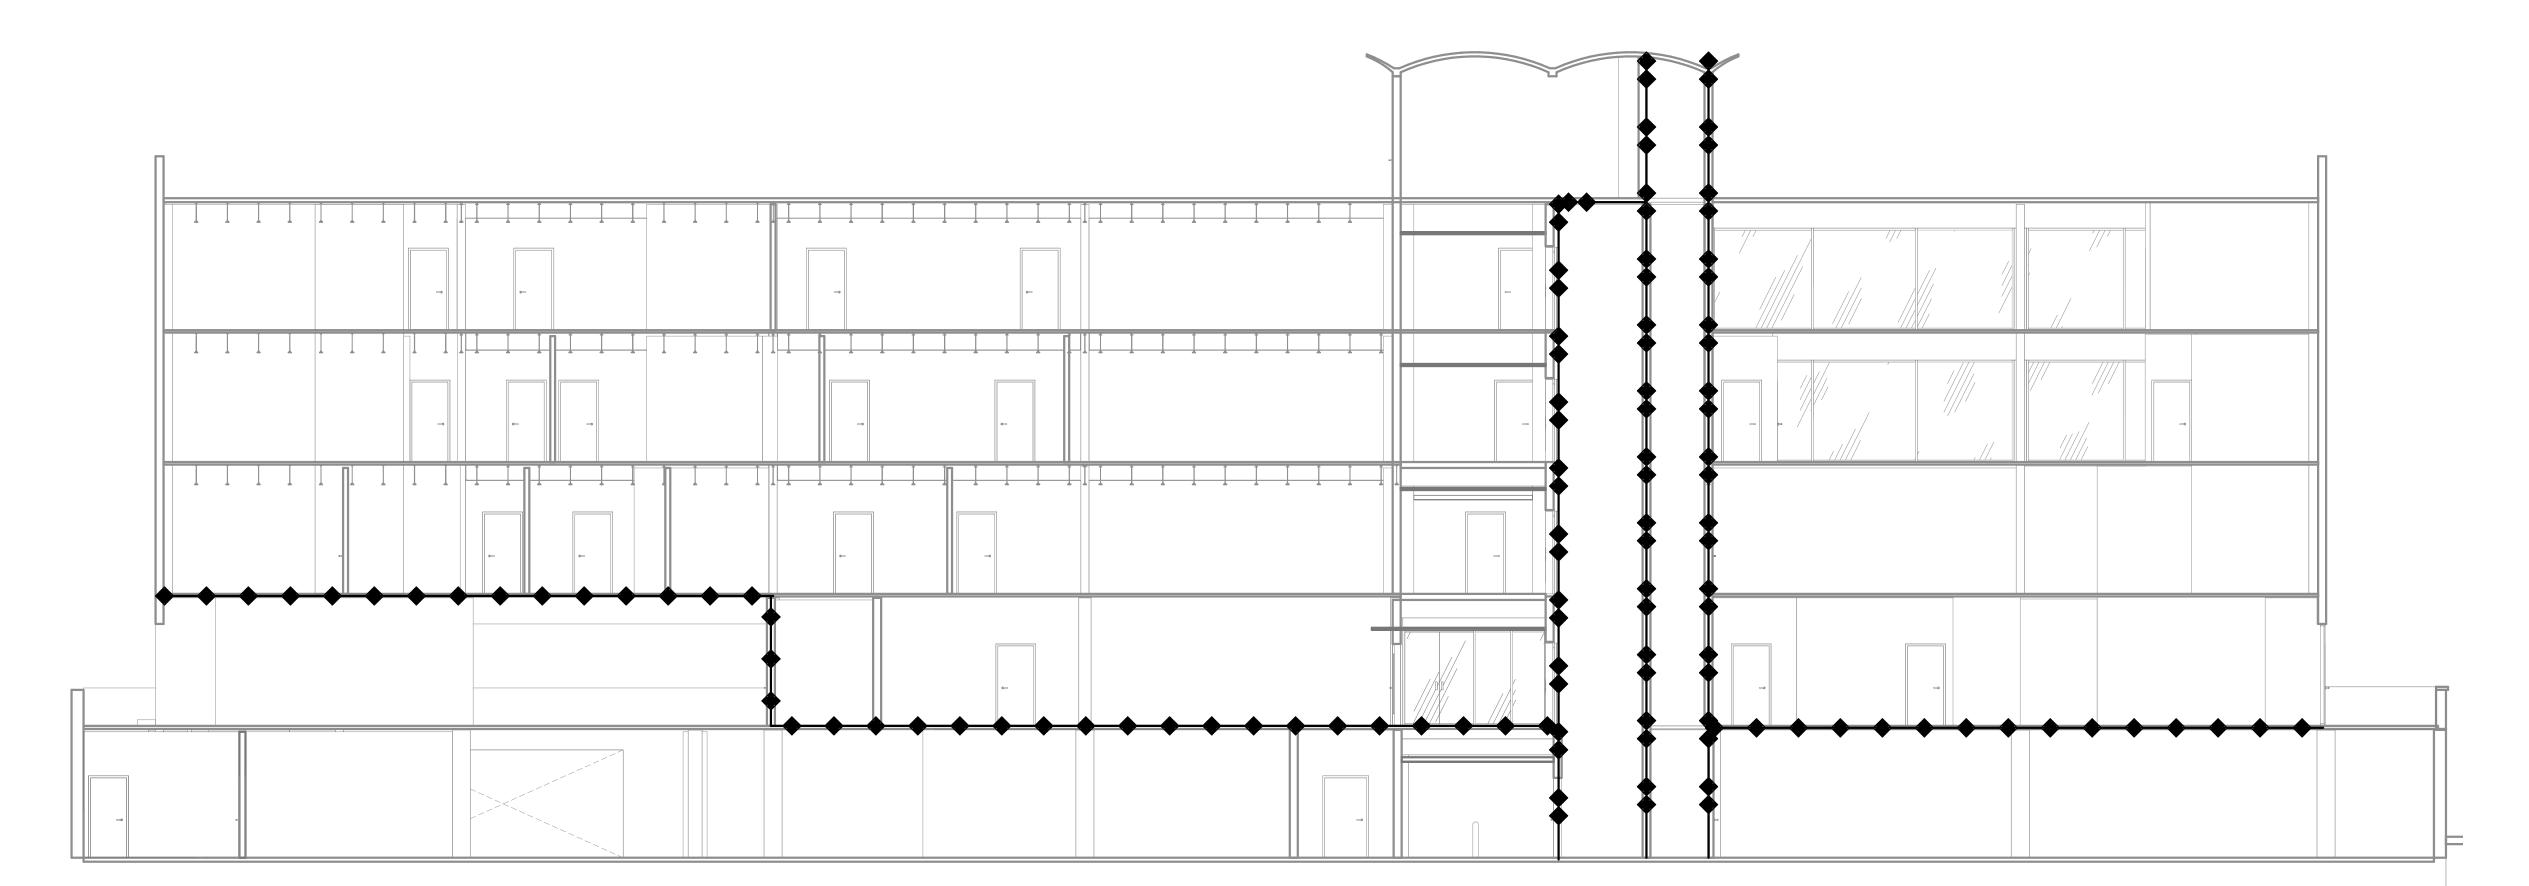

2 LIFE SAFETY SECTION THROUGH SUITES
1/8" = 1'-0"

LEGEND:

LIGHTED EXIT PATH (MIN. 44" WIDE) W/MIN 1FC

FIRE EXTINGUISHER

1 HOUR RATED WALL ASSEMBLY ◆◆─◆◆ 2 HOUR RATED WALL ASSEMBLY ◆ ◆ ◆ ◆ (E) 2 HOUR RATED WALL ASSEMBLY → → → → → → 3 HOUR RATED WALL ASSEMBLY



2 HOUR RATED FLOOR/CEILING ASSEMBLY ABOVE




1 HOUR RATED FLOOR/CEILING ASSEMBLY ABOVE



EXIT WITH LOAD



RATED OPENING (MINUTES)

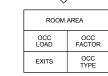

OCC OCC FACTOR ROOM OCCUPANCY TAG

1. PROVIDE 1 FOOT CANDLE OF LIGHT ALONG EGRESS PATH. SERVICE TO BE BY BACKUP POWER VIA UPS BATTERY BACKUP SYSTEM.
 EMERGENCY EGRESS LIGHTING TO BE PROVIDED AT BOTH EGRESS STAIRS ON ALL LEVELS.
4. ALL EXIT SIGNAGE IS NEW

NOT FOR CONSTRUCTION

JONES

JONES ARCHITECTURE

LOVEJOY MEDICAL

2525 N.W. LOVEJOY ST.

PORTLAND, OR. 97210

1231 NW Hoyt St. Ste. 404

Portland, OR 97209 T 503 477 9165

DRAFT APPEAL

Issue Date: 05/05/17

COPYRIGHT:

THESE PLANS ARE AN INSTRUMENT OF THE SERVICE AND ARE THE PROPERTY OF THE ARCHITECT, AND MAY NOT BE DUPLICATED, DISCLOSED, OR REPRODUCED WITHOUT THE WRITTEN CONSENT OF THE ARCHITECT.
COPYRIGHTS AND INFRINGMENTS WILL BE

ENFORCED AND PROSECUTED.

REVISIONS:

LIFE SAFETY SECTIONS

Sheet Name

G106