HDR Pearl West 20137549

1455 NW Irving St, Suite 800 Portland, OR 97209

PERMIT SET 05.06.2025

PROJECT TEAM

CLIENT HDR 1050 SW 6th Ave, Suite 1800 Portland, OR 97204 Tel: 602.575.8907 Contact: Caitlin Blackstock Email: caitlin.blackstock@hdrinc.com

ARCHITECTS GBD Architects Inc. 1120 NW Couch St, Suite 300 Portland, OR 97209 Tel: 503.224.9656 Contact: Aaron Benson Email: aaronb@gbdarchitects.com

CONTRACTOR Howard S. Wright 1455 NW Irving St, Suite 400 Portland, OR 97209 Tel: 503.220.0895 Contact: Dan Weller

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GBD

GBD Architects, Incorporated

1120 NW Couch St.

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HDR Pearl West

1455 NW Irving St, Suite 800 Portland, OR 97209

1050 SW 6th Ave, Suite 1800 Portland, OR 97204

Notice of Extended Payment Provision: The contract will allow the owner to make payment within 30 days after the date a billing or estimate is submitted. Notice of Alternate Billing Cycle: The contract will allow the owner to require the submission of billings or estimates in billing cycles other than 30-day cycles. Billings or estimates for the contract shall be submitted as follows: Each calendar month ending on the last day of the applicable month. REVISIONS

05.06.2025

PROJECT NUMBER 20137549

SCALE

SHEET TITLE

City of Portland COVER SHEET **Reviewed for Code Compliance**

Date:5/22/2025 Permit #: 25-037217-000-00-FA G000

2. DESIGN BUILD SYSTEMS INFORMATION SHOWN IN THESE DOCUMENTS IS FOR INFORMATION ONLY. DESIGN BUILD SYSTEMS CONTRACTORS ARE TO FIELD VERIFY ALL EXISTING CONDITIONS AND PROVIDE ENGINEERED DRAWINGS TO MEET THE DESIGN DEPICTED IN THESE DOCUMENTS. DESIGN BUILD DRAWINGS SHALL BE SUBMITTED AND APPROVED BY THE OWNER'S CONSTRUCTION MANAGER AND ARCHITECT, PRIOR TO THE DESIGN BUILD SUB CONTRACTOR ISSUING TO THE CITY OF PORTLAND FOR PERMIT.

- **MECHANICAL** ELECTRICAL
- **PLUMBING** SPRINKLER SYSTEM
- SMOKE DETECTION, SMOKE EVACUATION, AND EMERGENCY ANNUNCIATION SYSTEMS
- LOW VOLTAGE SECURITY SYSTEMS

GENERAL NOTES

1. ALL WORK SHALL CONFORM TO APPLICABLE BUILDING CODES AND ORDINANCES, AS MODIFIED FOR THIS BUILDING ON RECORD WITH THE AUTHORITY HAVING JURISDICTION. IN CASE OF CONFLICT WHERE THE METHODS OR STANDARDS OF INSTALLATION OF THE MATERIALS SPECIFIED DO NOT EQUAL OR EXCEED THE REQUIREMENTS OF THE LAWS OR ORDINANCES, THE LAW OR ORDINANCE SHALL GOVERN. NOTIFY ARCHITECT IN WRITING OF CONFLICTS.

2. IT IS THE CONTRACTOR'S RESPONSIBILITY TO VERIFY EXISTING CONDITIONS. NO ALLOWANCE WILL BE MADE FOR UNFAVORABLE CONDITIONS OR EVENTS WHICH MIGHT HAVE BEEN DISCOVERED THROUGH A THOROUGH EXAMINATION OF THE SITE. CONTRACTOR SHALL ASSUME FULL RESPONSIBILITY FOR THE CONSEQUENCES OF ACTING ON CONCLUSIONS DRAWN FROM INFORMATION AVAILABLE AT THE TIME. NOTIFY THE ARCHITECT IN WRITING OF ANY DISCREPANCIES PRIOR TO PRECEDING WITH WORK.

3. PROVIDE ALL LABOR, TRANSPORTATION, EQUIPMENT AND SERVICES NECESSARY TO PERFORM WORK SHOWN ON THE DRAWINGS AND DESCRIBED HEREIN.

4. MAINTAIN EXISTING BUILDING FIRE AND LIFE SAFETY SYSTEMS INCLUDING, BUT NOT LIMITED TO SPRINKLER SYSTEMS, SMOKE DETECTION SYSTEMS, SMOKE EVACUATION SYSTEMS, EXITING SYSTEMS AND EMERGENCY ANNUNCIATION SYSTEMS.

5. THE DESIGN OF ALL SEISMIC BRACING AND SUPPORTS FOR CEILING, MECHANICAL AND ELECTRICAL ITEMS, AND PARTITIONS IS THE RESPONSIBILITY OF THE RESPECTIVE CONTRACTOR/VENDOR TO MEET BUILDING CODE.

DEMOLITION

1. EXISTING STRUCTURE TO BE LEFT UNDISTURBED AND INTACT. PERFORM NO DEMOLITION THAT MAY COMPROMISE THE STRUCTURAL INTEGRITY OF THE BUILDING WITHOUT WRITTEN APPROVAL OF THE ARCHITECT / ENGINEER.

2. EXTREME CARE SHALL BE TAKEN BY THE CONTRACTOR TO PROTECT ALL EXISTING AREAS FROM DAMAGES THAT MIGHT OCCUR DURING DEMOLITION. THE CONTRACTOR WILL BE HELD RESPONSIBLE FOR ALL AREAS THAT HAVE BEEN DAMAGED DUE TO INADEQUATE PROTECTION.

3. THE EXISTING SUSPENDED CEILING TRACK WILL BE RE-USED UNLESS NOTED OTHERWISE ON THE DRAWINGS. TAKE EXTREME CARE IN THE REMOVAL OF THE FULL HEIGHT PARTITIONS FROM THE TRACK.

4. MAINTAIN 100% SPRINKLER COVERAGE.

5. SALVAGE/RECYCLE REMOVED MATERIALS PER OWNER'S STANDARD PROCEDURES AND REQUIREMENTS.

6. REMOVE ALL EXISTING SIGNAGE, PICTURES, NAILS, HOOKS, EQUIPMENT, ETC., LEFT BEHIND FROM PRIOR TENANT, FROM ALL WALLS, DOORS, DOOR FRAMES, AND CEILINGS INDICATED ON DRAWINGS.

7. MAINTAIN EXISTING FIRE SEPARATION RATING WHERE ELEMENTS HAVE BEEN REMOVED FROM THE FLOOR STRUCTURE OR RATED WALL ASSEMBLIES.

8. ALL ABANDONED LOW VOLTAGE, ELECTRICAL WIRING AND CONDUIT, PLUMBING, AND CONSTRUCTION ELEMENTS ARE TO BE REMOVED FROM THE CEILING PLENUM.

CONSTRUCTION

1. PERFORM ALL WORK IN ACCORDANCE WITH ESTABLISHED BUILDING STANDARDS FOR TENANT IMPROVEMENTS.

2. ALL DIMENSIONS ARE TO FACE OF FINISHED SURFACE UNLESS NOTED OTHERWISE

3. ALL PARTITIONS TERMINATE AT UNDERSIDE OF SUSPENDED CEILING SYSTEM UNLESS OTHERWISE NOTED

4. MECHANICAL, ELECTRICAL AND FIRE PROTECTION SYSTEMS INDICATED ARE FOR INFORMATION ONLY, THESE SYSTEMS ARE SUB-CONTRACTOR DESIGN/BUILD AND ARE TO BE SUBMITTED UNDER SEPARATE PERMIT. IT IS THE RESPONSIBILITY OF THE DESIGN/BUILD SUB-CONTRACTOR TO OBTAIN THESE PERMITS. CONTRACTORS SHALL VERIFY SIZES AND LOCATIONS OF ALL MECHANICAL AND ELECTRICAL EQUIPMENT, BOTH EXISTING AND NEW.

5. ALL WALLS, WITHIN THE LIMITS OF WORK NOTED ARE TO BE PATCHED, PLASTERED, SANDED AND PREPARED READY FOR THE NEW FINISH SPECIFIED UNLESS OTHERWISE NOTED.

6. DOORS NOTED TO REMAIN SHOULD BE TOUCHED UP AS NEEDED TO "LIKE NEW" CONDITION. DAMAGED DOORS SHOULD BE REVIEWED WITH ARCHITECT AND REPLACED AS NEEDED.

7. ALL CEILINGS SHOWN AS ACT SYSTEM REPRESENTS EXISTING OR NEW GRID AT EXISTING HEIGHT ABOVE FINISH FLOOR. IT IS CONTRACTOR'S RESPONSIBILITY TO PROVIDE ONE UNIFORM GRID. REPLACE DAMAGED GRID AND CEILING TILE AS REQUIRED TO PROVIDE A "LIKE NEW" CEILING. REVIEW WITH ARCHITECT.

8. PROVIDE EXIT SIGNS AND EMERGENCY LIGHTING SYSTEM IN CONFORMANCE WITH FIRE MARSHALL REQUIREMENTS.

9. THE DESIGN OF ALL SEISMIC BRACING AND SUPPORTS FOR CEILING, MECHANICAL AND ELECTRICAL ITEMS AND PARTITIONS IS THE RESPONSIBILITY OF THE RESPECTIVE CONTRACTOR/VENDOR TO MEET APPLICABLE BUILDING CODE REQUIREMENTS.

10. SEAL ALL THROUGH FLOOR/WALL RATED PENETRATIONS WITH APPROVED RATED ASSEMBLIES TO MAINTAIN THE FIRE RATING OF FLOOR / WALL ASSEMBLY.

11. ALL TENANT STANDARD PARTITIONS ARE TO BE METAL STUDS WITH 5/8" TYPE X GYPSUM BOARD EACH SIDE WITH ACOUSTIC INSULATION, UNLESS NOTED OTHERWISE.

MECHANICAL

1. DESIGN/BUILD SUB-CONTRACTORS SHALL BE THE ENGINEER OF RECORD. THE DESIGN/BUILD SUB-CONTRACTOR SHALL BE RESPONSIBLE FOR THE COMPLETE SYSTEM, EXISTING AND NEW, IDENTIFIED IN THE AREA OF WORK. DESIGN/BUILD SUB-CONTRACTOR IS RESPONSIBLE TO SUBMIT COMPLETE DESIGN/BUILD DRAWINGS TO THE ARCHITECT FOR APPROVAL, PRIOR TO SUBMITTING TO THE AUTHORITY HAVING JURISDICTION FOR PERMIT. ONCE APPROVED BY THE ARCHITECT, THE DESIGN/BUILD SUB-CONTRACTOR SHALL SUBMIT DRAWINGS TO THE AUTHORITY HAVING JURISDICTION AS A DEFERRED SUBMITTAL UNDER THE PROJECT PERMIT. IT IS THE RESPONSIBILITY OF THE DESIGN/BUILD SUB-CONTRACTOR TO OBTAIN THESE PERMITS.

2. MECHANICAL DESIGN/BUILD CONTRACTOR TO PROVIDE THE FOLLOWING INFORMATION FOR ALL SPACES WITHIN THE "AREA OF WORK", WHETHER THE ROOM OR EQUIPMENT IS NEW OR EXISTING, FOR ARCHITECTS REVIEW.

- THE BUILDING IS DESIGNED FOR LOW TEMPERATURE SUPPLY VIA SERIES FAN POWERED BOXES, PROVIDE BASIS OF DESIGN FOR SUPPLY AIR TEMPERATURE OF THE BASE BUILDING AHU.
- PROVIDE CALCULATIONS TO INDICATE OCCUPANCY TYPE, SPACE AREA, NUMBER OF OCCUPANTS AND THE PERCENTAGE OF OUTSIDE AIR FROM THE AIR-HANDLING UNIT SERVIING THE SPACE TERMINAL UNITS.
- PROVIDE ENERGY CALCULATIONS FORMS DEMONSTRATING COMPLIANCE FOR THE MECHANICAL SYSTEMS AS
- REQUIRED PER CODE. PROVIDE PLANS AND DOCUMENTATION SHOWING COMPLETE LAYOUT OF ALL SIZES AND LOCATIONS OF EQUIPMENT DUCTING, CFM DELIVERY FOR EACH REGISTER, TRANSFER RETURN BETWEEN SPACES, LOAD CALCULATIONS, SUPPLY
- AIRFLOWS, AND ALL INFORMATION TO DEMONSTRATE A COMPLETE MECHANICAL DESIGN WITHIN THE "AREA OF WORK". OWNER RESERVES THE RIGHT TO PERFORM A PRIOR REVIEW OF THE INFORMATION PROVIDED, CONTRACTOR TO PROVIDE ALL INFORMATION NECESSARY TO COMPLETE THE REVIEW AND NOT DELAY THE PROJECT. PROVIDE ARCHITECT AS BUILT DRAWINGS AND DIGITAL FILE (CAD OR BIM) OF FINAL DESIGN.

3. MECHANICAL SYSTEM WITHIN THE "AREA OF WORK" TO BE SEPARATED FROM ALL ADJACENT TENANTS / SUITES. RETURN AIR PATH ABOVE CEILING IS TO BE MAINTAINED, AND CONTRACTOR SHALL PROVIDE CALCULATIONS TO DEMOSTRATE THAT THE APPROPRIATE RETURN AIRFLOW HAS BEEN MAINTAINED. AT FULL HEIGHT DEMISING WALLS. PROVIDE ACCOUSTICAL "Z" BOOTS ABOVE CEILING TO LIMIT SOUND TRANSMISSION BETWEEN SUITES.

ELECTRICAL

1. ELECTRICAL WORK INDICATED IS FOR INFORMATION ONLY. THE SYSTEM IS SUB-CONTRACTOR DESIGN/BUILD, AND THE DESIGN/BUILD SUB-CONTRACTORS SHALL BE THE ENGINEER OF RECORD. THE DESIGN/BUILD SUB-CONTRACTOR SHALL BE RESPONSIBLE FOR THE COMPLETE SYSTEM, EXISTING AND NEW, IDENTIFIED IN THE AREA OF WORK, DESIGN/BUILD SUB-CONTRACTOR IS RESONSIBLE TO SUBMIT COMPLETE DESIGN/BUILD DRAWINGS TO THE ARCHITECT FOR APPROVAL. PRIOR TO SUBMITTING TO THE AUTHORITY HAVING JURISDICTION FOR PERMIT. ONCE APPROVED BY THE ARCHITECT, THE DESIGN/BUILD SUB-CONTRACTOR SHALL SUBMIT DRAWINGS TO THE AUTHORITY HAVING JURISDICTION AS A DEFERRED SUBMITTAL UNDER THE PROJECT PERMIT. IT IS THE RESPONSIBILITY OF THE DESIGN/BUILD SUB-CONTRACTOR TO OBTAIN THESE PERMITS.

2. ELECTRICAL DESIGN/BUILD CONTRACTOR TO PROVIDE THE FOLLOWING INFORMATION FOR ALL SPACES WITHIN THE "AREA OF WORK", WHETHER THE ROOM OR EQUIPMENT IS NEW OR EXISTING, FOR ARCHITECTS REVIEW.

- PROVIDE CONSTRUCTION DRAWINGS SHOWING ALL REQUIRED LUMINAIRE SCHEDULE(S), LIGHTING CONTROL SCHEDULE, LIGHT SWITCHING, PANEL SCHEDULE(S), AND PLANS SHOWING ELECTRICAL, LIGHTING, FIRE ALARM, DIAGRAMS, AND DETAILS NECESSARY TO SHOW A COMPLETE DESIGN. COORDINATE WITH ARCHITECTURAL DRAWINGS.
- PROVIDE FOOT CANDLE MAP SHOWING THE PROPOSED LIGHTING LAYOUT MEETS THE FOLLOWING LIGHT LEVELS. OFFICES AND OPEN OFFICE AREAS – APPROX. 30 FCS
- HALLWAYS APPROX. 12 FCS
- PROVIDE ARCHITECT AS BUILT DRAWINGS AND DIGITAL FILE (CAD OR BIM) OF FINAL DESIGN.

3. EXIT AND EGRESS LIGHTING SYSTEMS ARE TO BE INSTALLED TO MEET THE APPLICABLE BUILDING CODE REQUIREMENTS AND PRESCRIPTIVE LIGHTING PATH. EGRESS PLAN IS INDICATED IN THESE DOCUMENTS.

4. LOW VOLTAGE OUTLETS SHOWN REPRESENT OUTLET ROUGH-IN ONLY (RING AND STRING). IT THE RESPONSIBILITY OF THE ELECTRICAL SUBCONTRACTOR TO COORDINATE WITH TENANT'S LOW VOLTAGE VENDOR FOR SPECIFIC OUTLET REQUIREMENTS.

5. CONTRACTOR TO GET FIRE LIFE SAFETY DESIGN AND PRICING FROM OWNERS CONSULTANT, AND INCLUDE IN THEIR BID.

6. ALL ELECTRICAL OUTLETS TO BE MOUNTED AT +18" ABOVE FINISHED FLOOR UNLESS NOTED OTHERWISE

7. CONFIRM COLOR OF ELECTRICAL OUTLET COVER PLATES WITH ARCHITECT PRIOR TO PROCUREMENT / INSTALLATION. ALL COVER PLATES AND OUTLET DEVISES TO BE UNIFORM IN COLOR.

8. ELECTRICAL AND LIGHTING SYSTEMS WITHIN THE "AREA OF WORK" TO BE SEPARATED FROM ALL ADJACENT TENANTS / SUITES.

PLUMBING

1. PLUMBING WORK INDICATED IS FOR INFORMATION ONLY. THE SYSTEM IS SUB-CONTRACTOR DESIGN/BUILD. AND THE DESIGN/BUILD SUB-CONTRACTORS SHALL BE THE ENGINEER OF RECORD. THE DESIGN/BUILD SUB-CONTRACTOR SHALL BE RESPONSIBLE FOR THE COMPLETE SYSTEM, EXISTING AND NEW, IDENTIFIED IN THE AREA OF WORK. DESIGN/BUILD SUB-CONTRACTOR IS RESONSIBLE TO SUBMIT COMPLETE DESIGN/BUILD DRAWINGS TO THE ARCHITECT FOR APPROVAL, PRIOR TO SUBMITTING TO THE AUTHORITY HAVING JURISDICTION FOR PERMIT. ONCE APPROVED BY THE ARCHITECT, THE DESIGN/BUILD SUB-CONTRACTOR SHALL SUBMIT DRAWINGS TO THE AUTHORITY HAVING JURISDICTION AS A DEFERRED SUBMITTAL UNDER THE PROJECT PERMIT. IT IS THE RESPONSIBILITY OF THE DESIGN/BUILD SUB-CONTRACTOR TO OBTAIN THESE PERMITS.

2. UNLESS OTHERWISE NOTED, NEW PLUMBING FIXTURES ARE TO MATCH BUILDING STANDARD

3. FLOOR DRAINS TO BE INSTALLED WITH AUTOMATIC TRAP PRIMER.

FIRE PROTECTION

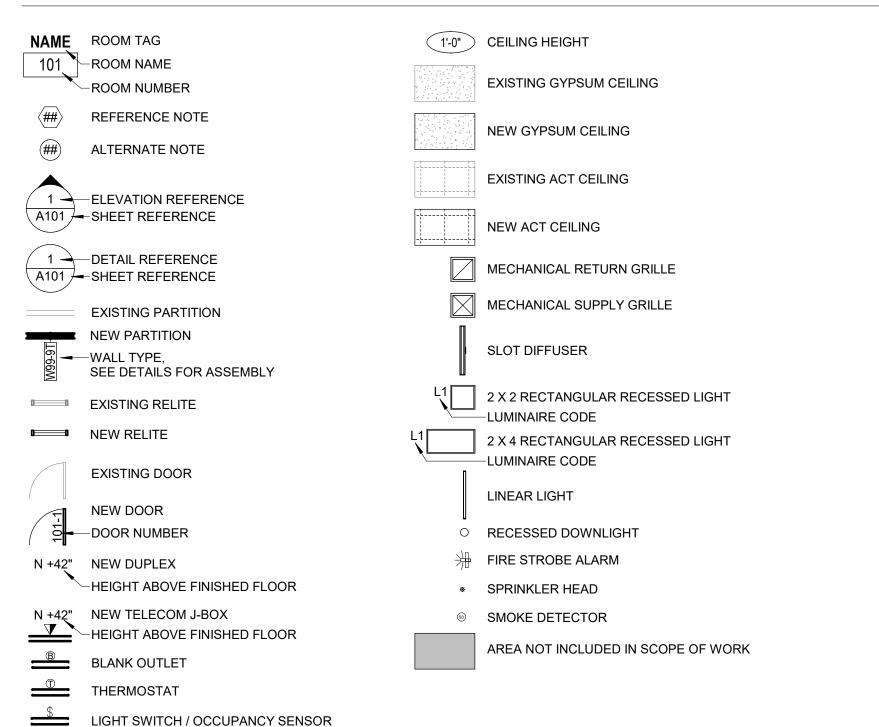
1. FIRE ALARM / FIRE SPRINKLER WORK INDICATED IS FOR INFORMATION ONLY. THE SYSTEM IS SUB-CONTRACTOR DESIGN/BUILD, AND THE DESIGN/BUILD SUB-CONTRACTORS SHALL BE THE ENGINEER OF RECORD. THE DESIGN/BUILD SUB-CONTRACTOR SHALL BE RESPONSIBLE FOR THE COMPLETE SYSTEM, EXISTING AND NEW, IDENTIFIED IN THE AREA OF WORK, DESIGN/BUILD SUB-CONTRACTOR IS RESONSIBLE TO SUBMIT COMPLETE DESIGN/BUILD DRAWINGS TO THE ARCHITECT FOR APPROVAL, PRIOR TO SUBMITTING TO THE AUTHORITY HAVING JURISDICTION FOR PERMIT. ONCE APPROVED BY THE ARCHITECT, THE DESIGN/BUILD SUB-CONTRACTOR SHALL SUBMIT DRAWINGS TO THE AUTHORITY HAVING JURISDICTION AS A DEFERRED SUBMITTAL UNDER THE PROJECT PERMIT. IT IS THE RESPONSIBILITY OF THE DESIGN/BUILD SUB-CONTRACTOR TO OBTAIN THESE PERMITS.

2. SUBCONTRACTOR TO COORDINATE WITH BUILDING ENGINEER TO ENSURE FIRE PROTECTION SCOPE IN AREA OF WORK IS PROPERLY CONNECTED TO MAIN FIRE ALARM SYSTEM.

ALL FIRE STROBE DEVICES TO HAVE WHITE HOUSINGS / COVERS.

4. ALL FIRE PROTECTION DEVICES INSTALLED IN CEILING TILES SHOULD BE CENTERED WITHIN THE TILE.


LEGEND



PROJECT DESCRIPTION

FULL FLOOR TENANT IMPROVEMENT BUILD OUT ON FLOORS 8 & 9. SELECTIVE DEMOLITION AND RECONFIGURATION OF OFFICE SPACE FOR NEW TENANT. NEW CONSTRUCTION TO INCLUDE WALLS, CEILINGS AND FINISHES FOR NEW OFFICE SPACE, MEETING ROOMS & BREAK ROOMS.

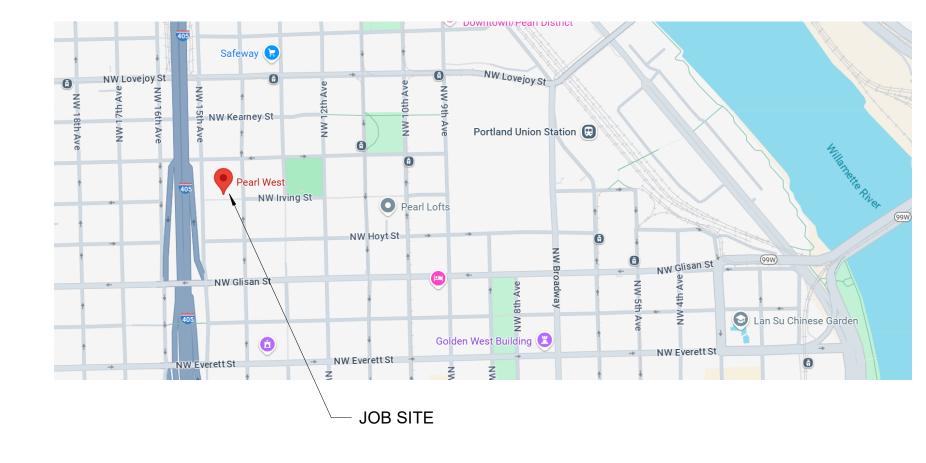VICINITY MAP



SHEET INDEX

G000	COVER SHEET	A108	LEVEL 08 - FLOOR PLAN
G001	PROJECT INFORMATION	A108F	LEVEL 08 - FINISH PLAN
G002	ACCESSIBLE DETAILS (OR)	A109	LEVEL 09 - FLOOR PLAN
G003	ACCESSIBLE DETAILS (OR)	A109F	LEVEL 09 - FINISH PLAN
G010	CODE SHEET - LEVEL 08	A708	LEVEL 08 - RCP
G011	CODE SHEET - LEVEL 09	A709	LEVEL 09 - RCP
G020	SCHEDULES	A800	INTERIOR ELEVATIONS
G021	SCHEDULES	A900	DETAILS
G030	SPECIFICATIONS	A901	DETAILS
G031	SPECIFICATIONS	A902	DETAILS
G032	SPECIFICATIONS		
D108	LEVEL 08 - DEMO FLOOR PLAN	PP-1.0_FURN	SECURITY PLAN
D109	LEVEL 09 - DEMO FLOOR PLAN	PP-1.1_FURN	SECURITY PLAN
D708	LEVEL 08 - DEMO CEILING PLAN		
D709	LEVEL 09 - DEMO CEILING PLAN	AV 3.0	STANDING HUDDLE
		AV 4.0	SMALL CONFERENCE
		AV 5.4	MEDIUM CONFERENCE
		AV 7.0	LARGE CONFERENCE
		AV 9.0	LARGE CONFERENCE

DEFERRED SUBMITTALS

PLUMBING HVAC SPRINKLER SECURITY LOW VOLTAGE ELECTRICAL

GBD Architects Incorporated

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Portland, OR 97209 Tel. (503) 224-9656

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STAMP



PROJECT

HDR Pearl West

1455 NW Irving St, Suite 800 Portland, OR 97209

CLIENT

1050 SW 6th Ave, Suite 1800

Portland, OR 97204 Notice of Extended Paymen

Provision: The contract will allow the owner to make payment within 30 days after the date a billing or estimate is submitted. Notice of Alternate Billing Cycle: The contract will allow the owner to require the submission of billings or estimates in billing cycles other than 30-day cycles. Billings or estimates for the contract shall be submitted as follows: Each calendar month ending on the last day of the applicable month. REVISIONS

1 04/30/2025 ASI 3

05.06.2025

PROJECT NUMBER

20137549

SCALE

1/8" = 1'-0"

PROJECT

INFORMATION


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17 GENERAL ACCESSORIES MOUNTING HEIGHTS


1/2" = 1



NOTE: CLEAR FLOOR SPACE MAY INCLUDE KNEE AND TOE CLEARANCES COMPLYING WITH 2017 ICC 306

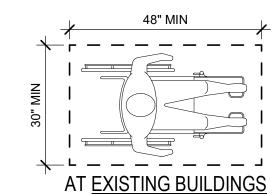18 CLEAR FLOOR SPACE

1/2" = 1'-0"

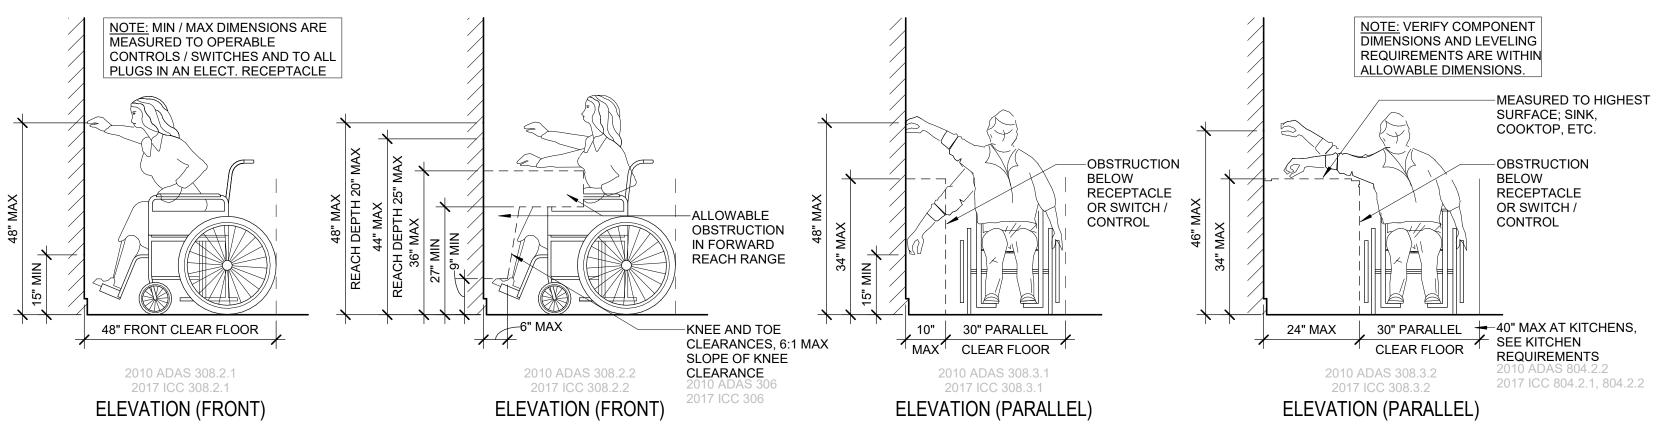

9 OUTLETS, SWITCHES, AND ACCESSORIES HEIGHTS

1/2" = 1'-0

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HDR

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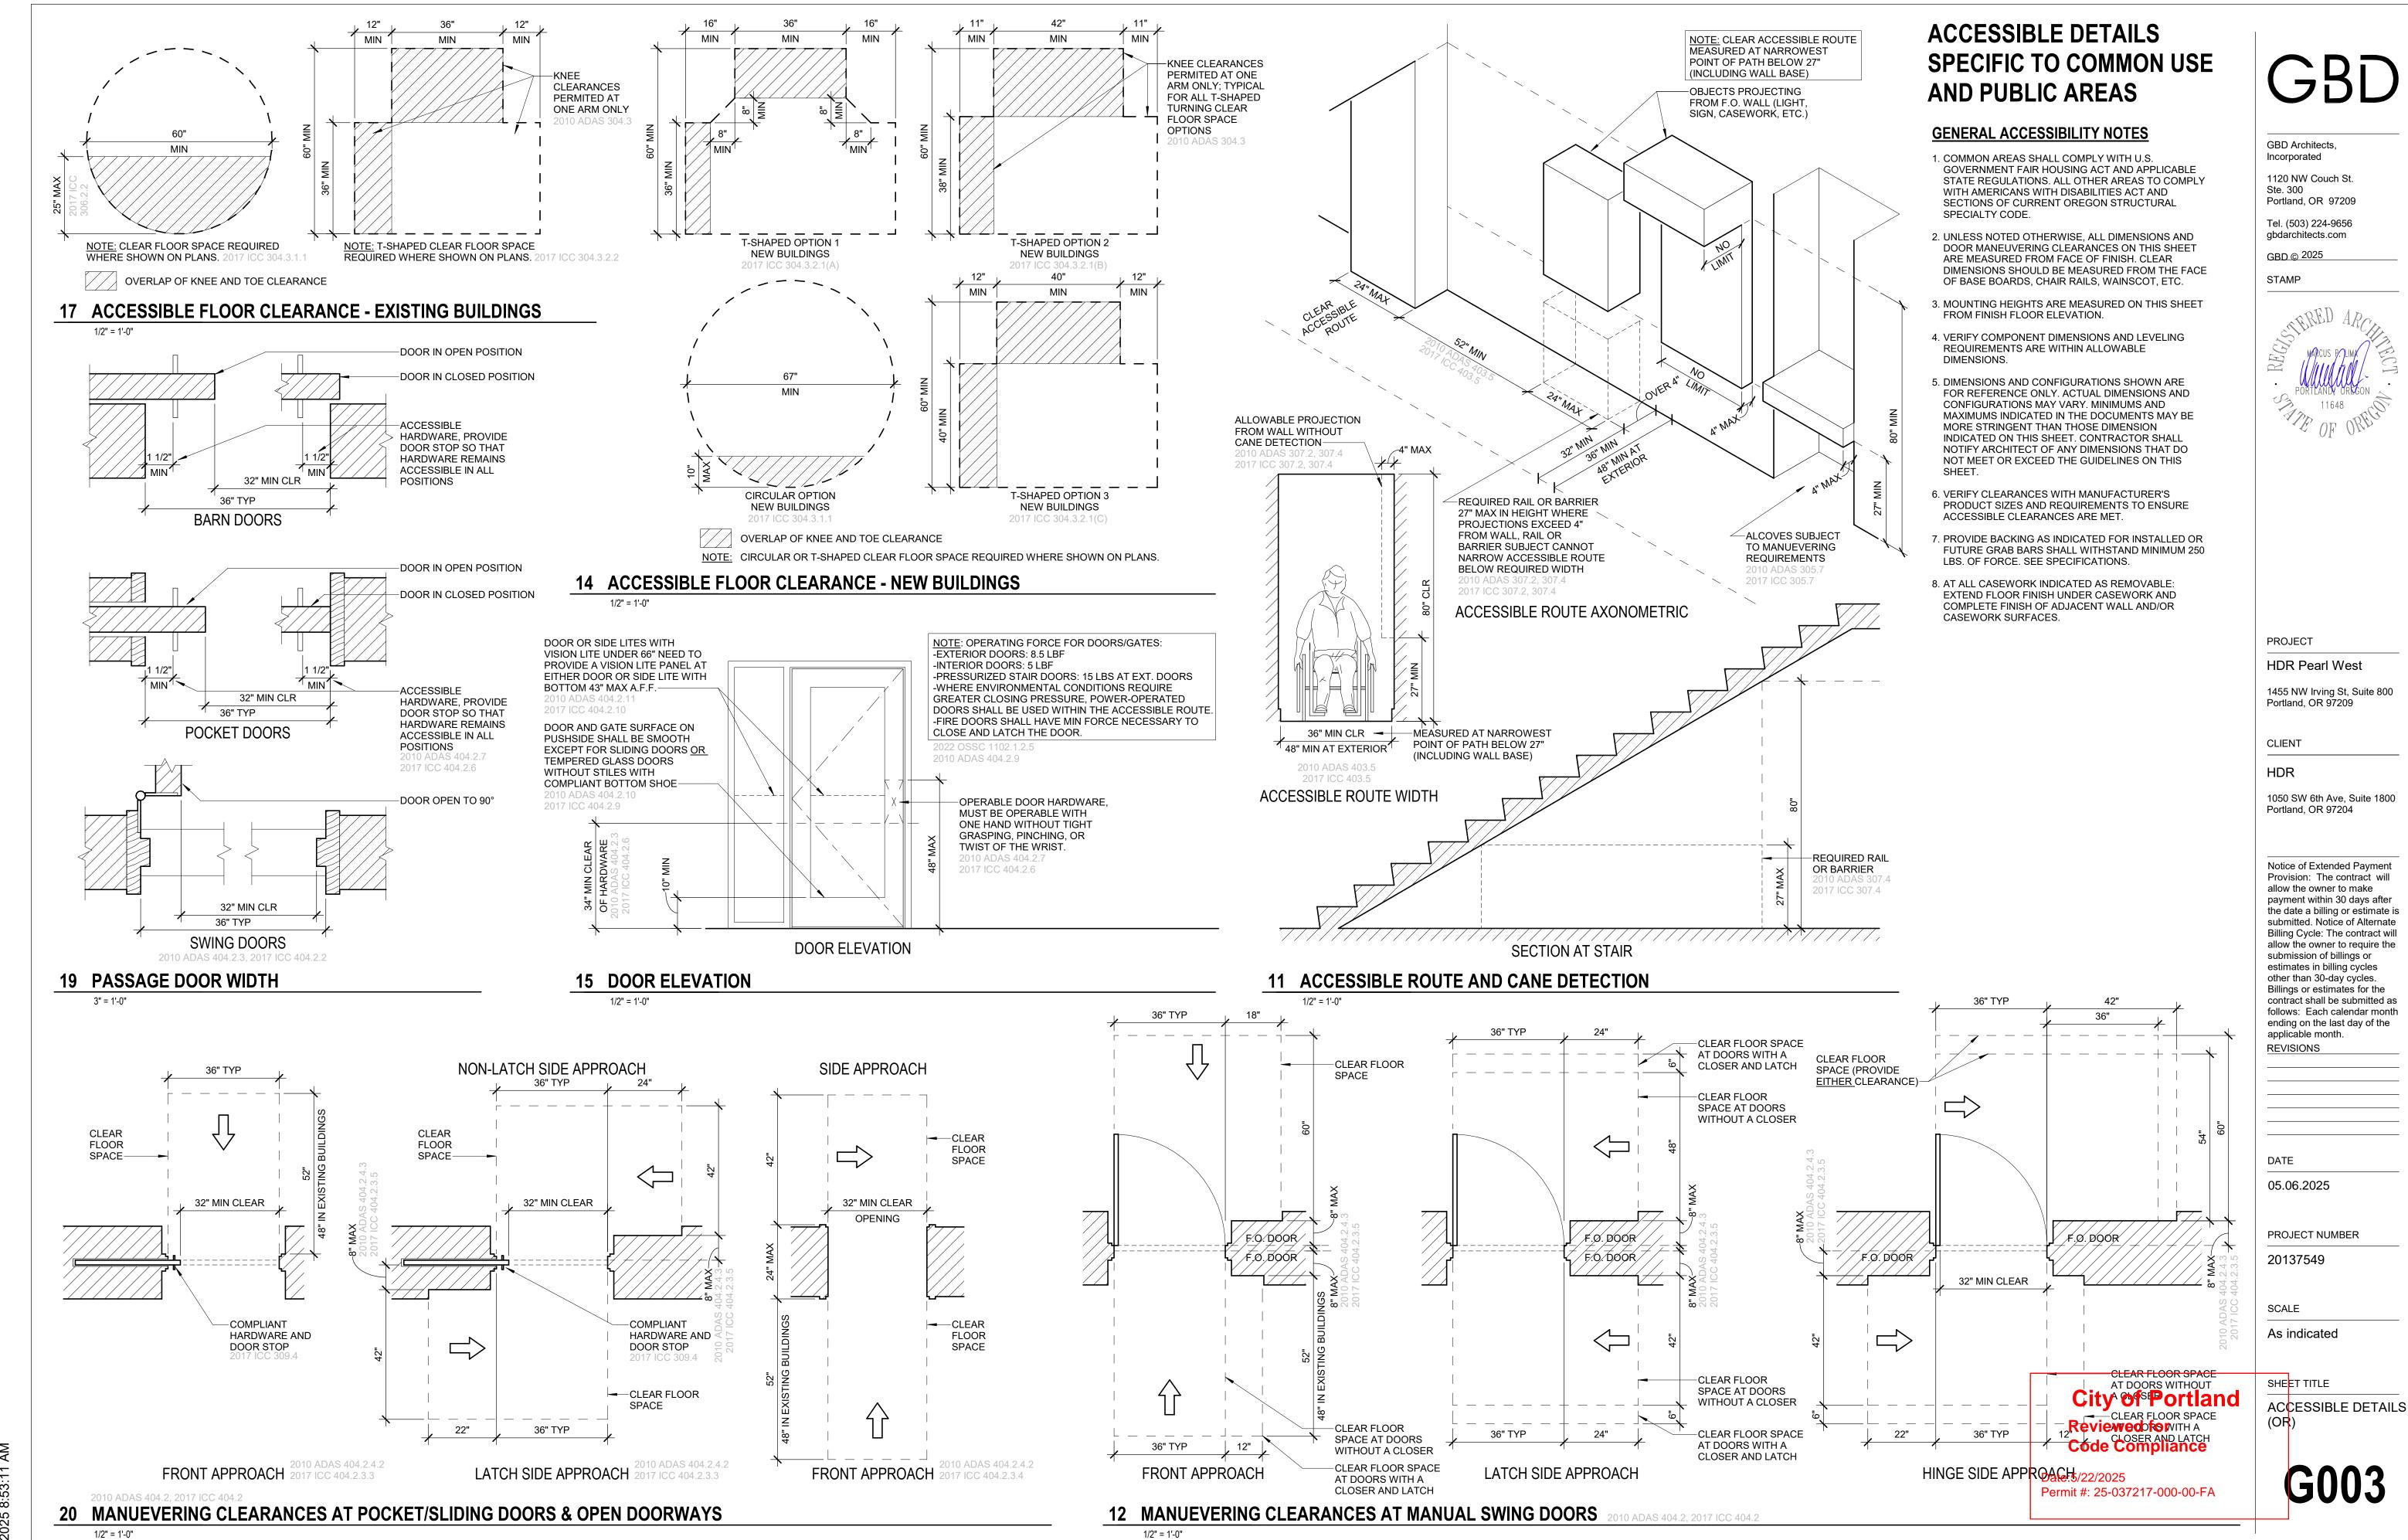
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G002

ACCESSIBLE DETAILS



CODE SUMMARY

OREGON STRUCTURAL SPECIALTY CODE

CONSTRUCTION TYPE: OCCUPANCY TYPE(S): ZONING:

EX

FIRE PROTECTION

100% SPRINKLERED SMOKE DETECTION SYSTEM SMOKE CONTROL SYSTEM

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STAMP

EGRESS PLAN LEGEND

AREA

850 SF

16,568 SF

92 SF

17,510 SF

FACTOR

150

300

TYPE

EXIT SIGN



EGRESS PATH TO BE ILLUMINATED TO AT LEAST CODE MINIMUM LIGHTING LEVELS



OF WORK



OCCUPANT LOAD SIGNAGE

PROJECT

HDR Pearl West 1455 NW Irving St, Suite 800

OCCUPANT TOTAL

57

111

EXIT

DESIGNATED EGRESS PATH (44" MIN. WIDTH)

AREA NOT INCLUDED IN SCOPE



FIRE EXTINGUISHER CABINET

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Portland, OR 97209

Portland, OR 97204

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SHEET TITLE CODE SHEET - LEVEL

G010

LEVEL 08

1/8" = 1'-0"

CODE SUMMARY

OREGON STRUCTURAL SPECIALTY CODE

EX

OCC. LOAD

FACTOR

150

300

OCCUPANT

TOTAL

295

CONSTRUCTION TYPE: OCCUPANCY TYPE(S): ZONING:

FIRE PROTECTION

100% SPRINKLERED SMOKE DETECTION SYSTEM SMOKE CONTROL SYSTEM

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STAMP

AREA

1,358 SF

974 SF

13,804 SF

248 SF

17,245 SF

TYPE

EXIT SIGN EXIT

DESIGNATED EGRESS PATH (44" MIN. WIDTH)

EGRESS PATH TO BE ILLUMINATED TO AT LEAST CODE MINIMUM LIGHTING LEVELS

AREA NOT INCLUDED IN SCOPE OF WORK



FIRE EXTINGUISHER CABINET

OCCUPANT LOAD SIGNAGE

PROJECT

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SHEET TITLE CODE SHEET - LEVEL

G011

LEVEL 09

1/8" = 1'-0"

			FINISH CODE LEGEND	
CODE	NAME	MANUFACTURER	DESCRIPTION	COMMENTS
ACT-1	ACOUSTICAL CEILING TILE	ARMSTRONG	DUNE (OR SIMILAR), 2X2 BUILDING STANDARD CEILING GRID & TILE W/ AXIOM TRIM (4"H, WHITE)	
CONC-1	CAST IN PLACE CONCRETE		EXISTING POLISHED CONCRETE	GC TO RETAIN POLISHED EXPOSED CONCRETE FINISH. PROVIDE LIGHT 2-STEP GRIND FINISH W/ MATTE SEALER. PROVIDE MOCK UP AREA AT PROPOSED CARPET AREA, FOR APPROVAL OF GRIND FINISH & TYPE OF SEALER.
CPT-1	CARPET TILE	SHAW	SPACEWORX-SURROUND TILE 5T125; STORM CLOUD 17597	ASHLAR
CPT-2	CARPET TILE	SHAW	SPACEWORX-CENTRIC TILE 17597; STORM CLOUD 17597	ASHLAR
GF-1	GLAZING FILM	3-M FILM	DUSTED CRYSTAL	
P-1	PAINT	SHERWIN WILLIAMS	EXTRA WHITE SW7006	
P-2	PAINT	SHERWIN WILLIAMS	DORIAN GRAY SW7017	
P-3	PAINT	SHERWIN WILLIAMS	GAUNTLET GREY SW7019	
P-4	PAINT	SHERWIN WILLIAMS	CRUISING SW6782	
P-5	PAINT	SHERWIN WILLIAMS	REAL RED SW6868	
PL-1	PLASTIC LAMINATE	WILSONART	SOLICORE; DESIGNER WHITE D354	COUNTERTOPS
PL-2	PLASTIC LAMINATE	WILSONART	ASIAN SAND 7952	CABINETS
Q-1	QUARTZ	CAESARSTONE	ICE SNOW 9141	
RB-1	RUBBER BASE	ROPPE	700 SERIES, 4" HIGH, COVED, BLACK, P100	
RF-1	RESILIENT FLOORING	SHAW	UNITE COVE 0927V, COLOR: TBD, 9"X48"	
SDT-1	STATIC DISSIPATIVE TILE	ROPPE	ESD TILE, CUMULUS WHITE	
TB-1	TACK BOARD			NIC, OFOI
WB-1	WHITE BOARD			NIC, OFOI
WC-1	WALLCOVERING	ACOUFELT	FRACTURE TWO-TONE THREAD; COLOR: TBD	
WC-2	WALLCOVERING	ACOUFELT	FRACTURE TWO-TONE BARCODE; COLOR: TBD	
WC-3	WALLCOVERING	ACOUFELT	FRACTURE BARCODE 1,2; COLOR: CHARCOAL	
WC-4	WALLCOVERING	ACOUFELT	TBD, COLOR: CLIFFSIDE	
WD-1	WOOD			

						H SCHEDULE - LE WALL	FINISH			CASEWORK		
Room Number	Room Name	Floor Finish	Base Finish	Ceiling Finish	North	East	South	West	Base Cabinets	Countertop	Upper Cabinets	Comments
801	CORRIDOR	CONC-1	RB-1		_					_		
802	MDF	SDT-1	RB-1	ACT-1	-	-	-	-	-	-	-	
803	IT WORKROOM	SDT-1	RB-1	EXISTING	-	-	-	-	-	-	-	
804	LOUNGE	CONC-1	RB-1	-	-	P-3	-	-	-	-	-	
805	PHONE	CPT-2	RB-1	ACT-1	WC-2	-	-	-	-	-	-	
806 807	SMALL CONFERENCE PHONE	CPT-2	RB-1 RB-1	ACT-1	- WC-2	P-3	-	-	-	-	-	
808	OFFICE	CPT-2	RB-1	ACT-1	-	-	-	P-2	-	-	-	
809	OFFICE	CPT-2	RB-1	ACT-1	-	-	-	P-2	-	-	-	
810	CORRIDOR	CONC-1	RB-1	-	P-3	-	-	-	-	-	-	
811	WELLNESS	CPT-2	RB-1	ACT-1	-	-	P-1/P-2	-	-	-	-	
812	OFFICE CORRIDOR	CPT-2 CONC-1	RB-1 RB-1	ACT-1	- P-4	- D 2	P-2	- P-3	-	-	-	
813 814	OFFICE	CONC-1	RB-1	ACT-1	P-4	P-3 P-2	-	P-3	-	-	- -	
815	OFFICE	CPT-2	RB-1	ACT-1	-	P-2	-	-	-	-	-	
816	OFFICE	CPT-2	RB-1	ACT-1	-	-	-	P-2	-	-	-	
817	OFFICE	CPT-2	RB-1	ACT-1	-	-	-	P-2	-	-	-	
818	PHONE	CPT-2	RB-1	ACT-1	-	-	WC-2	-	-	-	-	
819 820	OPEN OFFICE OPEN OFFICE	CPT-1	RB-1	ACT-1/P-3 ACT-1/P-3	-	-	-	P-3	- PL-2	- PL-1	- PL-2	
821	STORAGE	CONC-1	RB-1	ACT-1/P-3	-	-	-	-	-	-	-	
822	OPEN OFFICE	CPT-1	RB-1	ACT-1/P-3	-	-	-	P-3	-	-	-	
823	HUDDLE	CPT-2	RB-1	ACT-1	-	-	-	P-3	-	-	-	
824	OFFICE	CPT-2	RB-1	ACT-1	-	-	-	P-2	-	-	-	
825	OFFICE	CPT-2	RB-1	ACT-1	-	-	-	P-2	-	-	-	
826 827	LARGE CONFERENCE PHONE	CPT-2	RB-1	ACT-1	WC-3/WC-4	-	- WC-2	-	-	-	-	
828	CORRIDOR	CONC-1	RB-1	- AC1-1	-	-	-	-	-	-	-	
829	CORRIDOR	CONC-1	RB-1	_	-	-	-	-	-	-	-	
830	PHONE	CPT-2	RB-1	ACT-1	-	-	WC-2	-	-	-	-	
831	CORRIDOR	CONC-1	RB-1	-	P-3	WC-1	P-3	P-3	-	-	-	
832	STORAGE	CONC-1	RB-1	ACT-1	-	- D 2	-	-	- DI 0	-	-	
833 834	BREAK ROOM RECEPTION	CONC-1 CPT-1	RB-1	-	P-3	P-3 P-3	P-3/P-4	-	PL-2	Q-1	PL-2	
835	ELEVATOR LOBBY	CONC-1	RB-1		-	P-4	-	P-4	-	-	-	
836	STAIRS	CPT-1	RB-1	-	-	P-3	-	P-3	-	-	-	CARPET INSERTS ON OPEN STAIR TO BE REPLACED WITH NEW CPT-1
837	HUDDLE	CPT-2	RB-1	ACT-1	-	WC-4	-	-	-	-	-	
838	OFFICE	CPT-2	RB-1	ACT-1	-	P-2	-	-	-	-	-	
839 840	OFFICE CORRIDOR	CPT-2 CONC-1	RB-1	ACT-1	-	P-2	- P-3	-	-	-	-	
841	OPEN OFFICE	CPT-1	RB-1	ACT-1/P-3	-	P-3	-	-	-	-	- -	
842	OPEN OFFICE	CPT-1	RB-1	ACT-1/P-3	P-3	-	-	-	-	-	-	
843	COAT	CONC-1	RB-1	-	-	-	-	-	-	-	-	
844	STORAGE	CONC-1	RB-1	_	-	-	-	-	-	-	-	
845	CORRIDOR	CONC-1	RB-1	-	-	-	-	-	-	- DI 4	-	
846 847	PRODUCTION OPEN OFFICE	CONC-1 CPT-1	RB-1	- ACT-1/P-3	-	- P-3	-	-	PL-2	PL-1	PL-2	
848	OFFICE	CPT-2	RB-1	ACT-1// -3	-	P-2	-	-	-	-	- -	
849	OFFICE	CPT-2	RB-1	ACT-1	-	P-2	-	-	-	-	-	
850	OFFICE	CPT-2	RB-1	ACT-1	-	-	-	P-2	-	-	-	
851	OFFICE	CPT-2	RB-1	ACT-1	-	-	-	P-2	-	-	-	
852	CORRIDOR	CONC-1	RB-1	- AOT 4	P-4	P-3	-	P-3	-	-	-	
853 854	OFFICE OFFICE	CPT-2	RB-1 RB-1	ACT-1	-	P-2 P-2	-	-	-	-	-	
855	PHONE	CPT-2	RB-1	ACT-1	WC-2	-	-	-	-	-	-	+
856	SMALL CONFERENCE	CPT-2	RB-1	ACT-1	-	-	-	P-3	-	-	-	1
857	PHONE	CPT-2	RB-1	ACT-1	WC-2	-	-	-		-	-	
858	CORRIDOR	CONC-1	RB-1	-	P-3	-	-	-	-	-	-	
859	OFFICE	CPT-2	RB-1	ACT-1	-	-	P-2	-	-	-	-	
860 861	LOUNGE OFFICE	CONC-1 CPT-2	RB-1	- ACT-1	-	-	- P-2	P-3	-	-	-	
862	OFFICE	CPT-2	RB-1	ACT-1	-	-	P-2 P-2	-	-	-	-	
UUZ	OFFICE	OF 1-2	ו -טגו	701-I		-	r-Z	-		<u> </u> -	-	

Norm Number Room Name Ro						FINIS	SH SCHEDULE -	LEVEL 9					
Nome Room Name Profit See See Calleg Fine Colleg Fine Co	WALL FINISH								CASEWORK				
SOCIAL S	Room Number	Room Name	Floor Finish	Base Finish	Ceiling Finish	North			West	Base Cabinets	1	Upper Cabinets	Comments
SOCIAL S	901	CORRIDOR	CONC-1	RR-1		_					_		
STONAGE					ACT-1	-		<u> </u>					
Set OPENOFRICE CPT-1 RB-1 ACT-1 AC						-						<u>-</u>	
956 OFFICE							P-3						
						-						-	
997 OFFICE						_			_				
OFFICE						-	1 -2		P-2			-	
CORRIDOR CONC-1 R8-1 .						_							
WELLINES					-	P-3			-			<u>-</u>	
STATE COLLAB CONC-1 RB-1 ACT-1					ACT-1	-					 -		
STATE COLLAB CONC-1 RB-1 ACT-1 - - P-3 - - - P-3 - - P-3 P						_		WC-1			- -		
STATE STAT													
915 BREAN ROOM CONC-1 RB-1					AG1-1	_		-	D_3		- -	<u>-</u>	+
SBEAK ROOM ONC-1 R8-1 - - - - - - - - -					ACT 1	-		D 3	1 -3	-	-	-	-
TRAINING ROOM CPT-2 RB-1 - P-1WC-1 - - P-3 P-3 P-3 P-2 P-1 P-2 P-2 P-3					ACT-1	-	-	F-3	-	-	-	-	
917 CORRIDOR CONC-1 RB-1 P-3 P-3 P-2 P-1 P-2 9-1 9-1 9-1 9-1 9-1 9-1 9-1 9-1 9-1 9-1					-	D 1/MC 1	-	<u> </u>	- WC 3/MC 4	- DI 2	0.1	- DI 2	
918 OCRRIOGN CONC-1 RB-1					-	F-1/VVC-1	-	- D 2					
919 OFFICE CPT-2 RB-1 ACT-1 - P.2					-	-	-	F-3	F-3	FL-Z	PL-1	FL-Z	
SPI					- ACT 1	-	- D 2	-	-	-	-	-	
SPICE CPT-2						-		-	-	-	-	-	
Second S						-		-	-	-	-	-	
MEDIUR COMPETENCE CPT-2 RB-1 ACT-1 - - P-3 - P-3 - P-3 - P-3 P						-		-	- D 2	-	-	-	
MEDIUM CONFERENCE CPT-2						-	P-3	-		-	-	-	
926 CORRIDOR CONC-1 RB-1 CONC-1 CONC-1 RB-1 CONC-1 RB-1 CONC-1 RB-1 CONC-1 CONC-1 CONC-1 RB-1 CONC-1 CONC-1 CONC-1 CONC-1 RB-1 CONC-1 CONC-						-	-	-	P-3	-	-	-	
STAIRS CONC-1 RB-1 RB-					ACT-T	-	P-3	- D 2	-	-	-	-	
927 STAIRS CPT-1 RB-1					-	-	- D.f.	P-3	- D.	-	-	-	
928 HUDDLE CPT-2 RB-1 ACT-1 - P-3 -						-		-		-	-	-	OARRET INCERTS ON
929 OFFICE CPT-2 RB-1 ACT-1 - P-2 -	921	STAIRS		KD-1	-	-		-	P-5	-	-	-	OPEN STAIR TO BE REPLACED WITH NEW
930 OFFICE CPT-2 RB-1 ACT-1 - P-2	928	HUDDLE	CPT-2	RB-1		-		-	-	-	-	-	
931 CORRIDOR CONC-1 RB-1 P-5 P-5 P-5 P-5 P-5 P-5 P-5 P-5 P-5 P-5 P-5 P-5 P-5 P-5 P-5 - P-5	929	OFFICE	CPT-2	RB-1	ACT-1	-	P-2	-	-	-	-	-	
932 OPEN OFFICE CPT-1 RB-1 ACT-1/P-3 - P-3	930	OFFICE	CPT-2	RB-1	ACT-1	-	P-2	-	-	-	-	-	
933 OPEN OFFICE CPT-1 RB-1 ACT-1/P-3 P-3	931	CORRIDOR	CONC-1	RB-1	-	-	-	P-5	-	-	-	-	
934 COAT CONC-1 RB-1	932	OPEN OFFICE	CPT-1	RB-1	ACT-1/P-3	-	P-3	-	-	-	-	-	
935 STORAGE CONC-1 RB-1	933	OPEN OFFICE	CPT-1	RB-1	ACT-1/P-3	P-3	-	-	-	-	-	-	
936	934	COAT	CONC-1	RB-1	-	-	-	-	-	-	-	-	
937 PRODUCTION CONC-1 RB-1 - - - - - PL-2 PL-2 <td>935</td> <td>STORAGE</td> <td>CONC-1</td> <td>RB-1</td> <td>-</td> <td>-</td> <td>-</td> <td>-</td> <td>-</td> <td>-</td> <td>-</td> <td>-</td> <td></td>	935	STORAGE	CONC-1	RB-1	-	-	-	-	-	-	-	-	
938 OPEN OFFICE CPT-1 RB-1 ACT-1/P-3 - P-3	936	CORRIDOR	CONC-1	RB-1	-	-	-	-	-	-	-	-	
939 OFFICE CPT-2 RB-1 ACT-1 - P-2 940 OFFICE CPT-2 RB-1 ACT-1 - P-2	937	PRODUCTION	CONC-1	RB-1	-	-	-	-	-	PL-2	PL-1	PL-2	
940 OFFICE CPT-2 RB-1 ACT-1 - P-2 941 OFFICE CPT-2 RB-1 ACT-1 P-2 P-2	938	OPEN OFFICE	CPT-1	RB-1	ACT-1/P-3	-	P-3	-	-	-	-	-	
941 OFFICE CPT-2 RB-1 ACT-1 P-2 942 OFFICE CPT-2 RB-1 ACT-1 P-2 943 OPEN OFFICE CPT-1 RB-1 ACT-1/P-3 P-3 944 CORRIDOR CONC-1 RB-1	939	OFFICE	CPT-2	RB-1	ACT-1	-	P-2	-	-	-	-	-	
942 OFFICE CPT-2 RB-1 ACT-1 P-2 943 OPEN OFFICE CPT-1 RB-1 ACT-1/P-3 P-3 944 CORRIDOR CONC-1 RB-1	940	OFFICE	CPT-2	RB-1	ACT-1	-	P-2	-	-	-	-	-	
943 OPEN OFFICE CPT-1 RB-1 ACT-1/P-3 P-3 944 CORRIDOR CONC-1 RB-1	941	OFFICE	CPT-2	RB-1	ACT-1	-	-	-	P-2	-	-	-	
944 CORRIDOR CONC-1 RB-1 -	942	OFFICE	CPT-2	RB-1	ACT-1	-	-	-	P-2	-	-	-	
944 CORRIDOR CONC-1 RB-1 -	943	OPEN OFFICE	CPT-1	RB-1	ACT-1/P-3	-	-	-	P-3	-	-	-	
945 OFFICE CPT-2 RB-1 ACT-1 P-2 946 OFFICE CPT-2 RB-1 ACT-1 P-2			CONC-1	RB-1	-	-	-	-	-	-	-	-	
946 OFFICE CPT-2 RB-1 ACT-1 P-2				RB-1	ACT-1	-	-	P-2	-	-	-	-	
		OFFICE	CPT-2	RB-1	ACT-1	-	-	P-2	-	-	-	-	
	947	OFFICE	CPT-2		ACT-1	-	-	P-2	-	-	-	-	

GENERAL FINISH NOTES (L8 & L9)

1. ALL WALLS TO BE PAINTED P-1, UNO.

2. ALL CEILINGS TO REMAIN EXPOSED, UNO.

3. ALL SOFFITS TO RECEIVE P-1, FLAT FINISH.

4. PROVIDE (1) COAT OF PRIMER - SHERWIN WILLIAMS PREPRITE PROBLOCK LATEX PRIMER (B51W620) OR TINT PRIMER FOR ACCENT LOCATIONS ON ALL WALLS. PROVIDE (2) COATS OF PAINT - SHERWIN WILLIAMS PRO MAR SERIES 200 OR EQUAL (TYP) IN EGGSHELL ON ALL WALLS. PROVIDE ACCENT PAINTS AS INDICATED. NOTE THAT SOME ACCENT PAINTS MAY REQUIRE ADDITIONAL COATS BEYOND TYPICAL. ALL PAINT TO BE LOW VOC & LEED COMPLIANT.

5. AT ALL POLISHED CONCRETE FLOOR LOCATIONS, GRIND AND POLISH THE ENTIRE SCOPE REGARDLESS OF IF EXISTING POLISHED CONCRETE EXISTS.

Number	Product	
BEVI-1	BEVI WATER DISPENSER, OFOI. PROVIDE WATER LINE.	
CB-1	COLD BREW MACHINE, OFOI. NO WATER LINE REQUIRED	
DW-1	DISHWASHER; MANUFACTURER: GE, PRODUCT: 24" STAINLESS STEEL DISHWASHER, MODEL #GDT225SSLSS, ADA HEIGHT	
ICE-1	ICE MAKER; MANUFACTURER: FOLLETT, PRODUCT: SYMPHONY 50 CI SERIES, MODEL # 50CI425A-S, COUNTERTOP	
ICE-2	ICE MAKER; MANUFACTURER: FOLLETT, PRODUCT: SYMPHONY 50 CI SERIES, MODEL # 50FB414A-S, FREESTANDING	
KEG-1	MANUFACTURER: PRODUCT. PRODUCT INFO	
MW-1	MICROWAVE; OFOI	
REF-1	REFRIGERATOR; OFOI	
REF-2	UNDERCAB. REFRIGERATOR; MANUFACTURER: ULINE, PRODUCT. PRODUCT: U-ADA24RS-13B	
	City of Por	ilan

GBD

GBD Architects, Incorporated

1120 NW Couch St. Ste. 300

Portland, OR 97209
Tel. (503) 224-9656

gbdarchitects.com

GBD © 2025

STAMP



PROJECT

HDR Pearl West

1455 NW Irving St, Suite 800 Portland, OR 97209

CLIENT

HDR

1050 SW 6th Ave, Suite 1800 Portland, OR 97204

Notice of Extended Payment Provision: The contract will allow the owner to make payment within 30 days after the date a billing or estimate is submitted. Notice of Alternate Billing Cycle: The contract will allow the owner to require the submission of billings or estimates in billing cycles other than 30-day cycles. Billings or estimates for the contract shall be submitted as follows: Each calendar month ending on the last day of the applicable month.

REVISIONS

1 04/30/2025 ASI 3

DATE

05.06.2025

PROJECT NUMBER

20137549

SCALE

12" = 1'-0"

SHEET TITLE

SCHEDULES

G020

Reviewed for

Code Compliance

DOOR

LEAVES

DOOR

NUMBER

802-1

803-1

805-1

806-1

807-1

808-1

809-1

811-1

812-1

814-1

815-1

816-1

817-1

818-1

821-1

823-1

824-1

825-1

826-1

827-1

828-1

828-2

828-3

HARDWARE

GROUP

NUMBER OF OPENING OPENING

WIDTH

3'-0"

3'-0"

3'-0"

3'-0"

6'-4"

6'-4"

3'-0"

6'-4"

6'-4"

6'-4"

6'-4"

6'-4"

3'-0"

6'-4"

6'-4"

6'-4"

3'-0"

3'-0"

3'-0"

3'-0"

3'-0"

HEIGHT

8'-0"

8'-0"

8'-0"

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8'-0"

8'-0"

8'-0"

MATERIAL

WD

ALG

ALG

ALG

ALG

ALG

ALG

ALG

ALG

WD

ALG

ALG

ALG

ALG

FINISH

PTD

PTD

FFB

FFB

PTD

FFB

FFB

FFB

FFB

FFB

FFB

PTD

FFB

FFB

FFB

DOOR SCHEDULE

AL

 AL

FRAME

FINISH

BK

BK

BK

BK

FFB

BK

BK

NOTES

PAINT: WHITE

PAINT: WHITE

PAINT: WHITE

PAINT: WHITE

EXISTING DOOR TO REMAIN. GC TO REPLACE EXISTING HARDWARE PER INFORMATION IN

HARDWARE GROUP.

EXISTING DOOR TO REMAIN. GC TO CONFIRM HARDWARE IS IN GOOD CONDITION & REPAIR ANY

DAMAGE AS REQUIRED.

EXISTING DOOR TO REMAIN. GC TO CONFIRM HARDWARE IS IN GOOD CONDITION & REPAIR ANY DAMAGE AS REQUIRED

PAINT: WHITE

HARDWARE GROUP.

PAINT: WHITE

PAINT: WHITE

PAINT: WHITE

PAINT: WHITE

PAINT: WHITE

EXISTING.

HARDWARE GROUP.

DAMAGE AS REQUIRED.

DAMAGE AS REQUIRED.

HARDWARE GROUP.

PAINT: WHITE

PAINT: WHITE

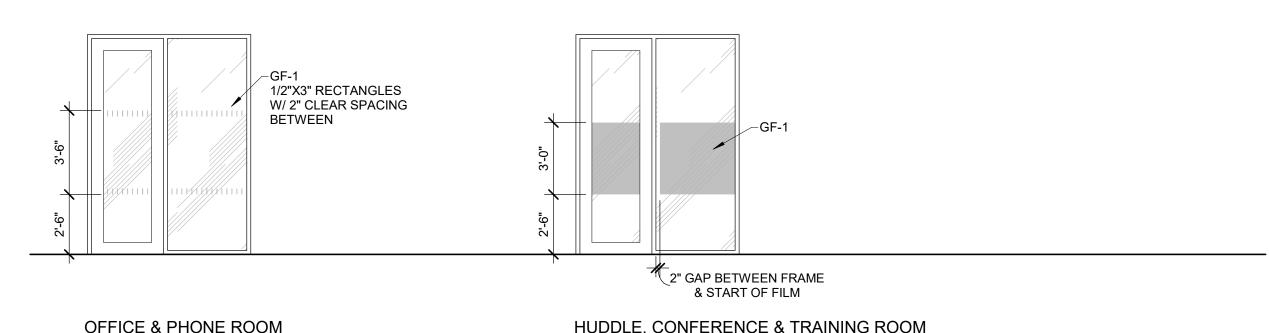
DOOR AND RELITE TYPES 13 A901 \A901 A901 \A901 ∖A901*/* -3/8" GLASS -GLASS RELITES WITH BUTT RELITES WITH ´ 15 ` **BUTT GLAZED** GLAZED A901 INTERMEDIATE INTERMEDIATE **JOINTS** JOINTS (CAULKED) ÈQ PANELS, 48" MAX EA. SEE 34" MIN CLR SEE DOOR SCHEDULE WHEN OPEN PLAN TYPE B TYPE D A901 (AVALON FLUSH GLIDER SYSTEM) A901 A901 -3/8" GLASS **15 RELITES WITH BUTT GLAZED** A901 INTERMEDIATE **JOINTS** (CAULKED) EQ PANELS, 48" MAX EA.

GLAZING FILM TYPES

, EQ, FULL

WIDTH

TYPE E



HARDWARE GROUP

PASSAGE SET

HINGES

SILENCERS

FLOOR STOP

OFFICE & PHONE ROOM

GROUP 3: STORAGE GROUP 5: CARD READER GROUP 1: MEETING STORAGE LOCKSET ELECTRIC STRIKE: HES 1500-C HINGES CARD READER SILENCERS HOLD OPEN FUNCTION FLOOR STOP

EQ, FULL

WIDTH

A901

GROUP 2: OFFICE DOOR PULLS: SS 24" STRAIGHT AVALON SUPPLIED HARDWARE **GROUP 4: CLOSET** RECESSED BYPASS PULL ROLLER TRACK RUBBER STOP IN TRACK

GROUP 6: CARD READER ELECTRIFIED LOCKSET ELECTRIC STRIKE: HES 5300 HINGES SILENCERS

CLOSER

FLOOR STOP

CARD READER

* ALL HARDWARE TO MATCH BUILDING STANDARD

GROUP 7: PRIVACY

THUMBTURN OCC. INDICATOR LOCK W/ PASSAGE SET (SCHLAGE B571 OR FALCON D271 SERIES), OR PRIVACY LOCK W/ OCCUPANCY INDICATOR (VIZILOCK OCCUPANCY INDICATOR LEVERSET)

HINGES SILENCERS FLOOR STOP

DOOR SCHEDULE LEGEND

GLASS TYPE: SEE SECTION 08 8000 "GLAZING" FOR DESCRIPTION

MATERIAL: AL ALUMINUM ALG ALUMINUM - GLASS

WD WOOD

FINISHES: BK BLACK ANODIZED FINISH FFB FACTORY FINISH, BLACK PTD PAINTED

City of Portland Reviewed for Code Compliance

Date:5/22/2025 Permit #: 25-037217-000-00-FA

GBD Architects, Incorporated

1120 NW Couch St. Ste. 300 Portland, OR 97209

Tel. (503) 224-9656 gbdarchitects.com

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PROJECT

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CLIENT

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1 03/26/2025 ASI 1

DATE

05.06.2025

PROJECT NUMBER

20137549

As indicated

SCALE

SHEET TITLE SCHEDULES

SECTION 01 3000 ADMINISTRATIVE REQUIREMENTS PART 1 GENERAL 1.01 SECTION INCLUDES A. Electronic document submittal service. B. Requests for Information. Submittals for Delegated Design and Deferred Submittals Submittals for review, information, and project closeout. Submittal procedures. PART 2 PRODUCTS - NOT USED PART 3 EXECUTION 3.01 ELECTRONIC DOCUMENT SUBMITTAL SERVICE A. All documents transmitted for purposes of administration of the contract are to be in electronic (PDF, MS Word, or MS Excel) format, as appropriate to the document. 3.02 CONSTRUCTION PROGRESS SCHEDULE A. If preliminary schedule requires revision after review, submit revised schedule within 10 days. B. Within 20 days after review of preliminary schedule, submit draft of proposed complete Include written certification that major contractors have reviewed and accepted proposed schedule. C. Within 10 days after joint review, submit complete schedule. D. Submit updated schedule with each Application for Payment. 3.03 REQUESTS FOR INFORMATION (RFI) A. During the Construction Phase the Contractor shall utilize the Request For Information (RFI) process to request clarification or interpretation of the documents... B. Requests For Information (RFI) shall contain the following elements: RFI Number (sequential) Subject: provide adequate detail (e.g. "Entry Door at Unit 255") Reference specific drawings/details and specific specification sections/paragraphs. Description of conflict or information needed. Author's recommended course of action. if applicable.

C. RFI's shall be submitted digitally via email or web-based construction administration software D. Architect will respond to RFI's within 7 working days after receipt of the complete RFI.

3.04 SUBMITTALS FOR REVIEW

A. When the following are specified in individual sections, submit them for review

Product data. Shop drawings. Samples for selection. Samples for verification.

Full product catalogs will not be accepted, Contractor to submit information specific to project. C. Submit to Architect for review for the limited purpose of checking for compliance with information given and the design concept expressed in Contract Documents.

Samples will be reviewed for aesthetic, color, or finish selection. E. After review, provide copies and distribute in accordance with SUBMITTAL PROCEDURES

3.05 SUBMITTALS FOR INFORMATION A. When the following are specified in individual sections, submit them for information: Design data. Certificates.

> Test reports. Inspection reports. Manufacturer's instructions Manufacturer's field reports Other types indicated.

B. Submit for Architect's knowledge as contract administrator or for Owner. 3.06 SUBMITTALS FOR DEFERRED SUBMITTALS A. For the purposes of this section, deferred submittals are defined as those portions of the design that are not submitted at the time of the application and that are to be submitted to the

Chief Building Official within a specified period. B. Submit to Architect for review for the limited purpose of checking for compliance with nformation given and the design concept expressed in the contract documents. C. Submit the reviewed deferred submittal documents to the Authority Having Jurisdiction and

pay all fees required for review and permitting. 3.07 SUBMITTALS FOR PROJECT CLOSEOUT A. Submit Correction Punch List for Substantial Completion.

Submit Final Correction Punch List for Substantial Completion. C. When the following are specified in individual sections, submit them at project closeout in compliance with requirements of Section 01 7800 - Closeout Submittals: Project record documents.

Operation and maintenance data. Warranties. Other types as indicated.

D. Submit for Owner's benefit during and after project completion. 3.08 NUMBER OF COPIES OF SUBMITTALS A. Electronic Documents: Submit one electronic copy in PDF format; an electronically-marked

up file will be returned. Create PDFs at native size and right-side up; illegible files will be B. Samples: Submit two samples of specified material; one of which will be retained by

C. Samples: Submit the number specified in individual specification sections; one of which will be retained by Architect After review, produce duplicates.

2. Retained samples will not be returned to Contractor unless specifically so stated. 3.09 SUBMITTAL PROCEDURES A. Product Data Procedures:

Submit only information required by individual specification sections. Collect required information into a single submittal.

Submit concurrently with related shop drawing submittal. B. Shop Drawing Procedures: Prepare accurate, drawn-to-scale, original shop drawing documentation by interpreting Contract Documents and coordinating related work.

Do not reproduce Contract Documents to create shop drawings. Generic, non-project-specific information submitted as shop drawings do not meet the requirements for shop drawings. C. All submittals that are submitted digitally shall be accompanied by a digital transmittal.

D. Identify Project, Contractor, Subcontractor or supplier; pertinent drawing and detail number, and specification section number, as appropriate on each copy. Apply Contractor's stamp, signed or initialed certifying that review, approval, verification of

Products required, field dimensions, adjacent construction Work, and coordination of nformation is in accordance with the requirements of the Work and Contract Documents. Identify variations from Contract Documents and Product or system limitations that may be detrimental to successful performance of the completed Work.

G. When revised for resubmission, identify all changes made since previous submission.

3.10 CLOSEOUT SUBMITTALS A. Operation and Maintenance Data and Manuals:

 Assembly of Operation and Maintenance Manuals a. Assemble digital operation and maintenance data into digital manual for Owner's personnel use, with data arranged in the same sequence as, and identified by, the specification sections. 2. Source Data: For each product or system, list names, addresses and telephone

numbers of Subcontractors and suppliers, including local source of supplies and replacement parts. 3. For Each Product, Applied Material, and Finish: a. Product data, with catalog number, size, composition, and color and texture

designations.

b. Information for re-ordering custom manufactured products. c. Instructions for Care and Maintenance: Manufacturer's recommendations for cleaning agents and methods, precautions against detrimental cleaning agents and methods, and recommended schedule for cleaning and maintenance

4. For Each Item of Equipment and Each System: Description of unit or system, and component parts. Identify function, normal operating characteristics, and limiting conditions.

Complete nomenclature and model number of replaceable parts. Operating Procedures: Include start-up, break-in, and routine normal operating instructions and sequences. Include regulation, control, stopping, shut-down, and emergency instructions. Include summer, winter, and any special operating

e. Maintenance Requirements: Include routine procedures and guide for preventative maintenance and trouble shooting; disassembly, repair, and reassembly instructions; and alignment, adjusting, balancing, and checking

Owner Stock: Provide additional stock as noted in Building Standards Manual or as directed 3.11 SUBMITTAL REVIEW TIME ALLOCATION

ARCHITECTS FIRST REVIEW Shop Drawings Simple Review 10 Working Days Shop Drawings Multiple Review 20 Working Days

10 Working Days **CONTRACTOR'S REVISION AS REQUIRED** Shop Drawings Simple Review 5 Working Days Shop Drawings Multiple Review 10 Working Days Product Data 5 Working Days

5 Working Days ARCHITECTS SECOND REVIEW Shop Drawings Simple Review 5 Working Days Shop Drawings Multiple Review 10 Working Days Product Data 5 Working Days 5 Working Days Samples

> **SECTION 01 6000** PRODUCT REQUIREMENTS

END OF SECTION

PART 1 GENERAL 1.01 SECTION INCLUDES General product requirements

Re-use of existing products. Product option requirements. Substitution limitations.

1.02 SUBMITTALS A. Product Data Submittals: Submit manufacturer's standard published data. Mark each copy to identify applicable products, models, options, and other data. Supplement manufacturers' standard data to provide information specific to this Project.

Shop Drawing Submittals: Prepared specifically for this Project; indicate utility and electrical characteristics, utility connection requirements, and location of utility outlets for service for functional equipment and appliances. Sample Submittals: Illustrate functional and aesthetic characteristics of the product, with

integral parts and attachment devices. Coordinate sample submittals for interfacing work. 1.03 REFERENCES AND STANDARDS A. For products and workmanship specified by reference to a document or documents not included in the Project Manual, also referred to as reference standards, comply with requirements of the standard, except when more rigid requirements are specified or are

required by applicable codes. PART 2 PRODUCTS 2.01 EXISTING PRODUCTS A. Do not use materials and equipment removed from existing premises unless specifically

required or permitted by Contract Documents. 2.02 NEW PRODUCTS A. Provide new products unless specifically required or permitted by Contract Documents. Where other criteria are met, Contractor shall give preference to products that:

If used on interior, have lower emissions 2. If wet-applied, have lower VOC content. 2.03 PRODUCT OPTIONS

A. Products Specified by Reference Standards or by Description Only: Use any product meeting those standards or description. Products Specified by Naming One or More Manufacturers: Use a product of one of the manufacturers named and meeting specifications, no options or substitutions allowed. Products Specified by Naming One or More Manufacturers with a Provision for Substitutions: Submit a request for substitution for any manufacturer not named.

2.04 SUBSTITUTION PROCEDURES Document each request with complete data substantiating compliance of proposed substitution with Contract Documents. B. Content: Include information necessary for tracking the status of each Substitution Request

and information necessary to provide an actionable response. A request for substitution constitutes a representation that the submitter 1. Has investigated proposed product and determined that it meets or exceeds the quality level of the specified product.

Agrees to provide the same warranty for the substitution as for the specified product. Agrees to coordinate installation and make changes to other Work that may be required for the Work to be complete with no additional cost to Owner.

Waives claims for additional costs or time extension that may subsequently become apparent. PART 3 EXECUTION 3.01 CONTROL OF INSTALLATION

A. Monitor quality control over suppliers, manufacturers, products, services, site conditions, and workmanship, to produce work of specified quality. Comply with manufacturers' instructions, including each step in sequence.

Should manufacturers' instructions conflict with Contract Documents, request clarification from Architect before proceeding.

D. Have work performed by persons qualified to produce required and specified quality. 3.02 DEFECT ASSESSMENT Replace Work or portions of the Work not complying with specified requirements.

B. If, in the opinion of Architect, it is not practical to remove and replace the Work, Owner will direct an appropriate remedy or adjust payment. **END OF SECTION**

> **SECTION 01 7000 EXECUTION AND CLOSEOUT REQUIREMENTS**

1.01 SECTION INCLUDES Cutting and patching. Cleaning and protection

PART 1 GENERAL

Indoor Air Quality Procedures Waste Management

4. Protect existing work to remain.

E. Closeout procedures, including Contractor's Correction Punch List, except payment

1.02 SUBMITTALS A. Cutting and Patching: Submit written request in advance of cutting or alteration that affects:

Structural integrity of any element of Project. Integrity of weather exposed or moisture resistant element.

Efficiency, maintenance, or safety of any operational element. PART 2 PRODUCTS 2.01 PATCHING MATERIALS A. New Materials: As specified in product sections; match existing products and work for

patching and extending work Type and Quality of Existing Products: Determine by inspecting and testing products where necessary, referring to existing work as a standard. PART 3 EXECUTION

3.01 DEMOLITION A. Do not begin removal until built elements to be salvaged or relocated have been removed. B. Perform demolition in a manner that maximizes salvage and recycling of building standard

C. If hazardous materials are discovered during removal operations, stop work and notify Architect and Owner; hazardous materials include regulated asbestos containing materials, lead. PCB's, and mercury.

Protect existing building elements and utilities to remain from damage. Selective Demolition for Alterations 1. Drawings showing existing construction and utilities are based on casual field

observation and existing record documents only. Remove existing work as indicated and as required to accomplish new work. Services (Including but not limited to HVAC, Plumbing, Fire Protection, Electrical, and Felecommunications): Remove existing systems and equipment as indicated.

3.02 LAYING OUT THE WORK Verify locations of survey control points prior to starting work. Promptly notify Architect of any discrepancies discovered. Establish elevations, lines and levels. Locate and lay out by instrumentation and similar

appropriate means: 3.03 GENERAL INSTALLATION REQUIREMENTS A. Install products as specified in individual sections, in accordance with manufacturer's instructions and recommendations, and so as to avoid waste due to necessity for

Make vertical elements plumb and horizontal elements level, unless otherwise indicated. Install equipment and fittings plumb and level, neatly aligned with adjacent vertical and horizontal lines, unless otherwise indicated. Make consistent texture on surfaces, with seamless transitions, unless otherwise indicated.

Make neat transitions between different surfaces, maintaining texture and appearance. 3.04 CUTTING AND PATCHING Whenever possible, execute the work by methods that avoid cutting or patching. B. Perform whatever cutting and patching is necessary to:

> Complete the work. Fit products together to integrate with other work. Provide openings for penetration of mechanical, electrical, and other services. Match work that has been cut to adjacent work.

Repair areas adjacent to cuts to required condition Repair new work damaged by subsequent work. Remove and replace defective and non-complying work. C. Execute work by methods that avoid damage to other work and that will provide appropriate surfaces to receive patching and finishing. In existing work, minimize damage and restore to

D. Patching: 1. Repair all openings in the slab where mechanical, electrical, and plumbing equipment has been removed. Repairs shall match adjacent exisitng structural slab material and shall be engineered to and installed to match the load rating of the adjacent existing

Finish patched surfaces to match finish that existed prior to patching. On continuous

surfaces, refinish to nearest intersection or natural break. For an assembly, refinish

entire unit. 3.05 CONSTRUCTION PROCEDURES - INDOOR AIR QUALITY A. Follow procedures established by building owner to contain and mitigate dust and odors

generated during construction. B. Interior Finishes Installation Schedule: Identify each interior finish that either generates odors, moisture, or vapors or is susceptible to adsorption of odors and vapors, and indicate air handling zone, sequence of application, and curing times. Coordinate the installation or application of these finishes with the building owner.

C. Contractor to take all precautions to contain dust, odors, and debris in the suite and prevent contamination of common spaces and adjoining suites. D. HVAC equipment and supply air ductwork may be used for ventilation during construction:

1. Do not use ductwork that is shared with common spaces or other suites. Ensure that air filters are correctly installed prior to starting use; replace filters when Do not use return air ductwork for ventilation unless absolutely necessary.

Where return air ducts must be used for ventilation, install auxiliary filters at return inlets, sealed to ducts; use filters with at least the equivalent efficiency as those required at supply air side; inspect and replace filters when they lose efficiency. 3.06 PROGRESS CLEANING A. Maintain areas free of waste materials, debris, and rubbish. Maintain site in a clean and

3.07 WASTE MANAGEMENT A. Contractor shall comply with waste management requirements set forth by the local Authority Having Jursidictiopn and as noted as a condition of the Permit.

B. Hazardous Wastes: Separate, store, and dispose of hazardous wastes according to C. Recycling: Separate, store, protect, and handle at the site identified recyclable waste products in order to prevent contamination of materials and to maximize recyclability of

identified materials. Arrange for timely pickups from the site or deliveries to recycling facility in order to prevent contamination of recyclable materials. 3.08 PROTECTION OF INSTALLED WORK A. Protect installed work from damage by construction operations.

Provide special protection where specified in individual specification sections. Remove protective coverings when no longer needed; reuse or recycle coverings if possible. 3.09 FINAL CLEANING A. Use cleaning materials that are nonhazardous.

B. Clean interior and exterior glass, surfaces exposed to view; remove temporary labels, stains

and foreign substances, polish transparent and glossy surfaces, vacuum carpeted and soft C. Remove all labels that are not permanent. Do not paint or otherwise cover fire test labels or nameplates on mechanical and electrical equipment.

D. Clean equipment and fixtures to a sanitary condition with cleaning materials appropriate to the surface and material being cleaned. 3.10 CLOSEOUT PROCEDURES

Make submittals that are required by governing or other authorities. B. Submit written certification containing Contractor's Correction Punch List, that Contract Documents have been reviewed, work has been inspected, and that work is complete in accordance with Contract Documents and ready for Architect's Substantial Completion

C. Notify Architect when work is considered finally complete and ready for Architect's Substantial Completion final inspection. **END OF SECTION**

SECTION 03 3511

CONCRETE FLOOR FINISHES

PART 1 GENERAL 1.01 SECTION INCLUDES Liquid densifiers and hardeners. Clear coatings.

Clear penetrating sealers. Polished concrete.

PART 2 PRODUCTS

1.02 SUBMITTALS A. Product Data: Manufacturer's published data on each finishing product, including information on compatibility of different products and limitations.

B. Product Data: Manufacturer's published data and installation instructions for concrete polishing system and finishing products, including manufacturer's installation instructions, information on compatibility of different products, and limitations.

C. Maintenance Data: Provide data on maintenance and renewal of applied finishes.

2.01 CONCRETE FLOOR FINISH APPLICATIONS Unless otherwise indicated, all concrete floors are to be finished using liquid densifier/hardener.

2.02 DENSIFIERS AND HARDENERS A. Liquid Densifier and Hardener: Penetrating chemical compound that reacts with concrete, filling the pores, hardening, and dustproofing. 2.03 COATINGS

A. Concrete Stain or Dye: Translucent, penetrating compound for interior or exterior use; must be finished with a topical sealer B. Select Sealer sheen based on polish level, or as noted in drawings.

C. High Gloss Clear Coating: Transparent, nonyellowing, acrylic polymer-based coating. Composition: Solvent-based D. Low Gloss Clear Coating: Transparent, nonyellowing, acrylic polymer-based coating. Composition: Solvent-based.

E. Clear, Penetrating, Moisture Vapor-Resistant Coating: Vapor-resistant and pH-reducing coating recommended by manufacturer for new and existing concrete floors and slabs. Type: High solids epoxy; two-component. F. Penetrating Sealer: Transparent, nonyellowing, water- or solvent-based coating.

 Composition: Siloxane. 2.04 POLISHED CONCRETE SYSTEM A. Polished Concrete System: Materials, equipment, and procedures designed and furnished by a single manufacturer to produce dense polished concrete of the specified sheen.

PART 3 EXECUTION 3.01 GENERAL A. Apply materials in accordance with manufacturer's instructions. 3.02 COATING APPLICATION

A. Verify that surface is free of previous coatings, sealers, curing compounds, water repellents, laitance, efflorescence, fats, oils, grease, wax, soluble salts, residues from cleaning agents, and other impediments to adhesion. B. Verify that water vapor emission from concrete and relative humidity in concrete are within

limits established by coating manufacturer. C. Protect adjacent non-coated areas from drips, overflow, and overspray; immediately remove

D. Apply coatings in accordance with manufacturer's instructions, matching approved mock-ups for color, special effects, sealing and workmanship. 3.03 CONCRETE POLISHING Remove all glue/adhesives, grease, oil, dirt, and other surface contamination.

manufacturer approved installer C. Finish in accordance with Concrete Polishing Council (CPC) Standards. 1. Class A - Cream Finish: Polish portland cement paste resulting in little or no

B. Execute using materials, equipment, and procedures specified by manufacturer, using

aggregate exposure. Class B - Fine Aggregate (Salt and Pepper) Finish: Remove not more than 1/16 inch of concrete surface by grinding and polishing resulting in majority of exposure displaying fine aggregate with no, or small amount of, medium aggregate at random

3. Class C - Medium Aggregate Finish: Remove not more than 1/8 inch of concrete surface by grinding and polishing resulting in majority of exposure displaying medium aggregate with no, or small amount of, large aggregate at random locations. Class D - Large Aggregate Finish: Remove not more than 1/4 inch of concrete surface by grinding and polishing resulting in majority of exposure displaying large aggregate with no, or small amount of, fine aggregate at random locations. E. Finished Sheen:

a. Gloss Reading: Not less than 40 according to ASTM E 430 before polish guard 2. Level 2 - Medium Gloss Appearance: a. Gloss Reading: Not less than 55 according to ASTM E 430 before polish guard

Level 1 - Low Gloss Appearance:

3. Level 3 - High Gloss Appearance:

a. Gloss Reading: Not less than 60 according to ASTM E 430 before polish guard application.

4. Level 4 - Very High Gloss Appearance: a. Gloss Reading: Not less than 70 according to ASTM E 430 before polish guard

Slip Resistance: 0.42 DCOF when tested in accordance with ANSI A326.3.

1. Apply non-slip sealer if floor does not meet slip resistance criteria.

END OF SECTION SECTION 06 2000

CARPENTRY

1.01 SECTION INCLUDES A. Finish carpentry items. Rough Carpentry and Construction Panels. Wood Treatment

PART 1 GENERAL

1.02 SUBMITTALS A. Product Data: Provide technical data on framing accessories and application instructions. Provide instructions for attachment hardware and finish hardware. B. Shop Drawings: Indicate materials, component profiles, fastening methods, jointing details,

and accessories 1. Samples: Submit two samples of wood trim 12 inch long. 1.03 QUALITY ASSURANCE

Custom grade. B. Fabricator Qualifications: Company specializing in fabricating the products specified in this section with minimum five years of documented experience.

A. Perform work in accordance with AWI Architectural Woodwork Quality Standards Illustrated,

C. Dimension Lumber: Comply with PS 20 and requirements of specified grading agencies. 1. If no species is specified, provide any species graded by the agency specified; if no grading agency is specified, provide lumber graded by any grading agency meeting the specified requirements.

2. Grading Agency: Any grading agency whose rules are approved by the Board of Review, American Lumber Standard Committee (www.alsc.org) and who provides grading service for the species and grade specified; provide lumber stamped with grade mark unless otherwise indicated.

PART 2 PRODUCTS 2.01 FINISH CARPENTRY ITEMS A. Quality Standard: Custom Grade, in accordance with AWI/AWMAC/WI (AWS) or AWMAC/WI

(NAAWS), unless noted otherwise No woods used in this section shall be harvested from old growth forests. Surface Burning Characteristics: Provide materials having fire and smoke properties as

required by applicable code. 2.02 LUMBER MATERIALS 1. Type 1: Doug Fir species, smooth sawn, maximum moisture content of 6 percent; with grain of quality suitable for transparent finish.

Interior Hardwood Lumber: 1. Type 1: Paint grade clear poplar; maximum moisture content of 6 percent; with mixed 2. Type 2: Paint Grade Ponderosa Pine (finger joining allowed); maximum moisture

content 6% with mixed grain. 2.03 CONSTRUCTION PANELS A. Communications and Electrical Room Mounting Boards: PS 1 A-D plywood, or medium density fiberboard; 3/4 inch thick; flame spread index of 25 or less, smoke developed index of 450 or less, when tested in accordance with ASTM E84

B. Underlayment: APA Underlayment; plywood, Exposure 2, 1/2 inch thick. Fully sanded faces at resilient flooring. C. Other Applications: 1. Plywood Concealed From View But Located Within Exterior Enclosure: PS 1, C-C

Plugged or better, Exterior grade. Plywood Exposed to View But Not Exposed to Weather: PS 1, A-D, or better 3. Other Locations: PS 1, C-D Plugged or better. 2.04 COMPOSITE WOOD MATERIALS

A. Composite Wood Products: Products shall be made without urea formaldehyde. B. Medium Density Fiberboard (MDF): ANSI A208.2, Grade 155. 1. Basis-of-Design Product: Subject to compliance with requirements, provide Roseburg Forest Products; Medite II or comparable product by one of the following:

 Arauco North America. b. Panel Source International, Inc. c. Uniboard, Canada.

Uniboard, Canada.

C. Medium Density Fiberboard - Water Resistant (MDF-WR): ANSI A208.2, Grade 155. 1. Basis-of-Design Product: Subject to compliance with requirements, provide Roseburg Forest Products; Medex or comparable product by one of the following: Arauco North America. b. Panel Source International, Inc.

A. Adhesive: Must conform to limits noted in Section 01 6116 - Volatile Organic Compound (VOC) Content Restrictions, Type recommended by AWI to suit application . 2.06 WOOD TREATMENT A. Factory-Treated Lumber: Comply with requirements of AWPA U1 - Use Category System for pressure impregnated wood treatments determined by use categories, expected service

> conditions, and specific applications. 1. Fire-Retardant Treated Wood: Mark each piece of wood with producer's stamp indicating compliance with specified requirements. 2. Preservative-Treated Wood: Provide lumber and plywood marked or stamped by an ALSC-accredited testing agency, certifying level and type of treatment in accordance

with AWPA standards. Finish work in accordance with AWI/AWMAC/WI (AWS) or AWMAC/WI (NAAWS), Section 5 -Finishing for grade specified. PART 3 EXECUTION

3.01 INSTALLATION A. Install custom fabrications in accordance with AWI/AWMAC/WI (AWS) or AWMAC/WI (NAAWS) requirements for grade indicated. Set and secure materials and components in place, plumb and level. Carefully scribe work abutting other components, with maximum gaps of 1/32 inch. Do not

use additional overlay trim to conceal larger gaps. **END OF SECTION SECTION 06 4100**

ARCHITECTURAL WOOD CASEWORK PART 1 GENERAL

1.01 SECTION INCLUDES Specially fabricated cabinet units Countertops and Backsplashes. Hardware.

b. Uniboard, Canada.

D. Factory finishing. 1.02 SUBMITTALS A. Samples: Submit actual samples of architectural cabinet construction, minimum 12 inches square, illustrating proposed cabinet substrate and finish

Samples: Submit actual sample items of proposed pulls and hinges, demonstrating hardware design, quality, and finish. PART 2 PRODUCTS

2.01 CABINETS Quality Standard: Custom Grade, in accordance with AWI/AWMAC/WI (AWS) or AWMAC/WI 2.02 WOOD-BASED COMPONENTS Wood fabricated from old growth timber is not permitted.

2.03 COMPOSITE WOOD MATERIALS A. Composite Wood Products: Products shall be made without urea formaldehyde. B. Veneer-Faced Panel Products (Hardwood Plywood): HPVA HP-1, Grade AA, Type 2; Basis-of-Design Product: Subject to compliance with requirements, provide Roseburg Forest Products; SkyPly or comparable product by one of the following: Columbia Forest Products "PureBond".

Provide sustainably harvested wood, certified or labeled as specified in Section 01 6000.

b. Timber Products Company. C. Particleboard: ANSI A208.1, Grade M-2. 1. Basis-of-Design Product: Subject to compliance with requirements, provide Roseburg Forest Products; Skyblend or comparable product by one of the following: Arauco North America b. Uniboard, Canada.

D. Melamine-Faced Particleboard: ANSI A208.1, Grade M-2. white low pressure laminate facing (Melamine) both sides Basis-of-Design Product: Subject to compliance with requirements, provide Roseburg Forest Products; Skyblend or comparable product by one of the following: a. Arauco North America.

A. High Pressure Decorative Laminate (HPDL): NEMA LD 3, types as recommended for 2.05 COUNTERTOPS

2.04 LAMINATE MATERIALS

A. Surface Burning Characteristics: Flame spread index of 25, maximum; smoke developed

C. Fabricate in accordance with manufacturer's standard requirements.

index of 450, maximum; when tested in accordance with ASTM E84. B. Fabricate in accordance with AWI/AWMAC/WI (AWS) or AWMAC/WI (NAAWS), Section 11 Countertops, Premium Grade.

D. Natural Quartz and Resin Composite Countertops: Sheet or slab of natural quartz and plastic resin over continuous substrate. 1. Natural Quartz and Resin Composite Sheets, Slabs and Castings: Complying with ISFA 3-01 and NEMA LD 3; orthophthalic polyester resin, mineral filler, and pigments; homogenous, non-porous and capable of being worked and repaired using standard

woodworking tools; no surface coating; color and pattern consistent throughout E. Solid Surfacing Countertops: Solid surfacing sheet or plastic resin casting over continuous

substrate. 1. Solid Surfacing Sheet and Plastic Resin Castings: Complying with ISFA 2-01 and NEMA LD 3; acrylic or polyester resin, mineral filler, and pigments; homogenous, nonporous and capable of being worked and repaired using standard woodworking tools; no surface coating; color and pattern consistent throughout thickness.

F. Plastic Laminate Countertops: Medium density fiberboard substrate covered with HPDL, conventionally fabricated and self-edge banded.

G. Back and End Splashes: Where backsplash is noted in drawings, provide on all sides. Same material as countertop, square top; minimum 4 inches high, or as noted in drawings.

A. Adhesive: Type recommended by fabricator to suit application. Bolts, Nuts, Washers, Lags, Pins, and Screws: Of size and type to suit application. 2.07 HARDWARE

A. Shelf Standards and Rests: recessed metal shelf standards. B. Cabinet Locks: Keyed cylinder, two keys per lock, master keyed, steel with chrome finish. C. Drawer Slides:

Static Load Capacity: Commercial grade. Mounting: Side mounted. D. Hinges: Concealed (fully mortised) (European) type, steel with satin finish; self closing (105

2.08 FABRICATION A. Assembly: Shop assemble cabinets for delivery to site in units easily handled and to permit passage through building openings.

B. Edging: Fit shelves, doors, and exposed edges with edging to match cabinet faces. Do not use more than one piece for any single length. C. Fitting: When necessary to cut and fit on site, provide materials with ample allowance for cutting. Provide matching trim for scribing and site cutting.

D. Plastic Laminate: Apply plastic laminate finish in full uninterrupted sheets consistent with manufactured sizes. Fit corners and joints hairline; secure with concealed fasteners. Slightly bevel arises. Locate counter butt joints minimum 2 feet from sink cut-outs. Apply laminate backing sheet to reverse side of plastic laminate finished surfaces.

Cap exposed plastic laminate finish edges with material of same finish and pattern. E. Adjustable Shelves: at full height upper or lower cabinets scheduled to receive adjustable shelves, provide a minimum of two (2) shelves and hardware, U.N.O. on the drawings. F. Provide cutouts for plumbing fixtures. Verify locations of cutouts from on-site dimensions. Prime paint cut edges.

2.09 SHOP FINISHING A. For opaque finishes, apply wood filler in exposed nail and screw indentations and sand

B. On items to receive transparent finishes, use wood filler matching or blending with surrounding surfaces and of types recommended for applied finishes. C. Finish work in accordance with AWI/AWMAC Architectural Woodwork Quality Standards Illustrated, Section 5, to match building standard or architect's sample. PART 3 EXECUTION

3.01 INSTALLATION

PART 1 GENERAL

1.02 SUBMITTALS

1.01 SECTION INCLUDES

Firestopping systems.

A. Install work in accordance with AWI/AWMAC/WI (AWS) or AWMAC/WI (NAAWS) requirements for grade indicated. B. Set and secure custom cabinets in place, assuring that they are rigid, plumb, and level.

END OF SECTION

C. Use concealed joint fasteners to align and secure adjoining cabinet units.

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STAMP



PROJECT

HDR Pearl West

1455 NW Irving St, Suite 800 Portland, OR 97209

CLIENT

1050 SW 6th Ave, Suite 1800

Portland, OR 97204

Notice of Extended Payment Provision: The contract will allow the owner to make payment within 30 days after the date a billing or estimate is submitted. Notice of Alternate Billing Cycle: The contract will allow the owner to require the submission of billings or estimates in billing cycles other than 30-day cycles. Billings or estimates for the contract shall be submitted as follows: Each calendar month ending on the last day of the applicable month.

DATE

REVISIONS

05.06.2025

20137549

SCALE

PROJECT NUMBER

B. This Section includes items identified by the Architect or Engineer of Record as Delegated Design.

C. Product Data: Provide data on product characteristics of the mace fatings, and finite and C SPECIFICATIONS

1.03 QUALITY ASSURANCE A. Fire Testing: Provide firestopping assemblies of depices the provide he scheduled fire ratings when tested in accordance with methods indicated. B. Firestopping shall not be used to patch or fill holes or difference of the company of the com or plumbing systems have been removed.

SECTION 07 8400

FIRESTOPPING

A. See Section 01 3000 - Administrative Requirements, for submittal procedures.

1. Refer to Section 01 7000 - Execution and Closeout Requirements for procedures for repairing penetrations in structure. Date:5/22/2025 1 04 FIELD CONDITIONS A. Comply with firestopping manufacturer's recommendations for temperature and conditions

during and after installation; maintain minimum temperature before, during, and for three days after installation of materials.

GBD INTERIORS MASTER sheet spec.pdf2023/03/16

PART 2 PRODUCTS 2.01 FIRESTOPPING SYSTEMS A. Firestopping: Any material meeting requirements. 1. Fire Ratings: Use system that is listed by FM (AG), ITS (DIR), or UL (FRD) and tested 2. Contractor to provide a listed firestopping assembly that most closely matches existing PART 3 EXECUTION 3.01 PREPARATION adversely affect bond of firestopping material.

A. Clean substrate surfaces of dirt, dust, grease, oil, loose material, or other materials that could

in accordance with ASTM E814, ASTM E119, or UL 1479 with F Rating equal to fire

firestopping assemblies at similar conditions in the building in appearance, type, and

rating of penetrated assembly and minimum T Rating Equal to F Rating and in

3.02 INSTALLATION A. Install materials in manner described in fire test report and in accordance with manufacturer's

B. Do not cover installed firestopping until inspected by authorities having jurisdiction. C. Install labeling required by code or building standard.

compliance with other specified requirements.

3.03 CLEANING

A. Clean adjacent surfaces of firestopping materials. **END OF SECTION**

> **SECTION 07 9200 JOINT SEALANTS**

PART 1 GENERAL

1.01 SECTION INCLUDES

 A. Interior Joint Sealants B. Joint backings and accessories. 1.02 SUBMITTALS

A. Product Data for Sealants: Submit manufacturer's technical data sheets for each product to

be used, that includes the following. 1. Physical characteristics, including movement capability, VOC content, hardness, cure time, and color availability.

List of backing materials approved for use with the specific product. Substrates that product is known to satisfactorily adhere to and with which it is

Substrates the product should not be used on.

B. Color Cards for Selection: Where sealant color is not specified, submit manufacturer's color cards showing standard colors available for selection.

PART 2 PRODUCTS 2.01 JOINT SEALANT APPLICATIONS

> A. Scope: 1. Interior Joints: Do not seal interior joints unless specifically indicated to be sealed.

Interior joints to be sealed include, but are not limited to, the following items. a. Joints between door, window, and other frames and adjacent construction. b. In sound-rated wall and ceiling assemblies, gaps at electrical outlets, wiring devices, piping, and other openings; between wall/ceiling and other construction; and other flanking sound paths.

Other joints indicated below. 2. Do not seal the following types of joints.

a. Joints between suspended panel ceilings/grid and walls.

B. Interior Joints: Use non-sag polyurethane sealant, ASTM C920, Grade NS, Uses M and A; single or multi-component, unless otherwise indicated. 1. Wall and Ceiling Joints in Non-Wet Areas: Acrylic emulsion latex sealant.

a. Water-based; ASTM C834, single component, non-staining, non-bleeding, non-2. Wall and Ceiling Joints in Wet Areas: Non-sag polyurethane sealant for continuous

liquid immersion a. ASTM C920, Grade NS, Uses M and A; single or multi-component; explicitly approved by manufacturer for continuous water immersion.

3. Joints between Fixtures in Wet Areas and Floors, Walls, and Ceilings: Mildewresistant silicone sealant; color to be selected by architect. a. ASTM C920, Grade NS, Uses M and A; single component.

4. In Sound-Rated Assemblies: non-hardening Acrylic emulsion latex sealant, ASTM

C. Interior Wet Areas: Bathrooms, restrooms, and kitchens; fixtures in wet areas include plumbing fixtures, countertops, and other similar items. D. Sound-Rated Assemblies: Walls and ceilings identified as "STC-rated", "sound-rated", or

"acoustical". 2.02 JOINT SEALANTS - GENERAL

A. Sealant Joints to be paintable wherever possible. Sealants that are not paintable shall be identfied in the submittal.

B. Sealants and Primers: Provide products with levels of volatile organic compound (VOC)

C. Colors: To be selected by Architect.

2.03 ACCESSORIES A. Backer Rod: Cylindrical cellular foam rod with surface that sealant will not adhere to, compatible with specific sealant used, and recommended by backing and sealant

manufacturers for specific application. B. Backing Tape: Self-adhesive polyethylene tape with surface that sealant will not adhere to and recommended by tape and sealant manufacturers for specific application.

PART 3 EXECUTION

3.01 INSTALLATION A. Perform work in accordance with sealant manufacturer's requirements for preparation of

surfaces and material installation instructions

B. Perform installation in accordance with ASTM C1193. C. Perform acoustical sealant application work in accordance with ASTM C919.

D. Install bond breaker backing tape where backer rod cannot be used.

E. Install sealant free of air pockets, foreign embedded matter, ridges, and sags, and without getting sealant on adjacent surfaces.

F. Nonsag Sealants: Tool surface concave, unless otherwise indicated; remove masking tape immediately after tooling sealant surface.

END OF SECTION

PART 1 GENERAL

1.01 SECTION INCLUDES A. Aluminum frames for Doors, Sidelights, or Transoms. 1.02 SUBMITTALS

A. Product Data: Manufacturer's descriptive literature for each type of frame; include information on fabrication methods, hardware preparation, and installation.

B. Shop Drawings: Include elevations of each opening type and details at each wall type.

SECTION 08 1116

ALUMINUM FRAMES

PART 2 PRODUCTS 2.01 FRAMES

> A. Match Building Standard frames, U.N. Aluminum Frames for Doors, Sidelights, or Transoms: Extruded aluminum, non-thermally broken hollow or C-shaped sections; no steel components.

Frame Depth: To fit wall thicknesses as indicated on drawings. Finish: as noted by architect.

Corner Brackets: Extruded aluminum, fastened with stainless steel screws.

Weatherstripping: Replaceable pile type; at jambs and head. Sidelight/Transom Glazing: See Section 08 8000. 2.02 MATERIALS

A. Extruded Aluminum: ASTM B221 (ASTM B221M), alloy 6063, temper T5, or alloy 6463, temper T5. 2.03 ACCESSORIES

A. Fasteners: Aluminum, non-magnetic stainless steel, or other material warranted by manufacturer as non-corrosive and compatible with aluminum components.

Brackets and Reinforcements: Manufacturer's high-strength aluminum units where feasible. otherwise, non-magnetic stainless steel or steel hot-dip galvanized in compliance with ASTM A123/A123M.

PART 3 EXECUTION 3.01 EXAMINATION

A. Verify that wall surfaces and openings are ready to receive frames and are within tolerances

B. If substrate preparation is the responsibility of another installer, notify Architect of unsatisfactory preparation before proceeding. 3.02 INSTALLATION

A. Do not attempt installation in areas where wall thickness exceeds tolerances of specified Install doors and frames in accordance with manufacturer's instructions and approved shop

C. Set frames plumb, square, level, free from warp or twist, and aligned to receive doors. Anchor frames to adjacent construction in strict accordance with manufacturer's recommendations

and within specified tolerances. Maintain dimensional tolerances and alignment with adjacent work. Ensure joints are hairline

tight and surfaces flush with adjacent components. E. Hang doors and adjust hardware to achieve specified clearances and proper door operation.

> **END OF SECTION SECTION 08 1416**

FLUSH WOOD DOORS

PART 1 GENERAL

A. Flush wood doors; flush and building standard configuration; fire rated and non-rated. A. Product Data: Indicate door core materials and construction; veneer species, type and

B. Samples: Submit two samples of door construction, 12 x 12 inch in size cut from top corner 1.03 QUALITY ASSURANCE

A. Manufacturer Qualifications: Company specializing in manufacturing the products specified

in this section, with not less than three years of documented experience.

PART 2 PRODUCTS 2.01 DOORS

A. Doors: See drawings for locations and additional requirements. Quality Standard: Custom Grade, Heavy Duty performance, in accordance with AWI/AWMAC/WI (AWS) or AWMAC/WI (NAAWS), unless noted otherwise.

B. Interior Doors: 1-3/4 inches thick or per building standard. 1. Quality Standard: Custom Grade, Heavy Duty performance, in accordance with AWI/AWMAC/WI (AWS) or AWMAC/WI (NAAWS), unless noted otherwise. Match Building Standard doors in finish, species, size, and thickness, U.N.O.

> Provide solid core doors at each location. Fire Rated Doors: Tested to ratings indicated on drawings in accordance with UL 10C Positive Pressure; Underwriters Laboratories Inc (UL) or Intertek/Warnock Hersey WHI) labeled without any visible seals when door is open.

Wood veneer facing for field transparent finish as indicated on drawings and per Hardboard facing with factory opaque finish as indicated on drawings and per building

A. Match Building Standard. If building standard is unknown, provide per the following: 1. Non-Rated Solid Core and 20 Minute Rated Doors: Type particleboard core (PC) or Agrifiber Cores, plies and faces as indicated above, meeting standard ANSI A208.1

2. Fire-Rated Doors: Mineral core type, with fire resistant composite core (FD), plies and faces as indicated above; with core blocking as required to provide adequate anchorage of hardware without through-bolting.

2.03 DOOR CONSTRUCTION

Fabricate doors in accordance with door quality standard specified. B. Factory machine doors for hardware other than surface-mounted hardware, in accordance with hardware requirements and dimensions.

Factory fit doors for frame opening dimensions identified on shop drawings, with edge clearances in accordance with specified quality standard.

2.04 FINISHES - WOOD VENEER DOORS A. Finish work in accordance with AWI/AWMAC/WI (AWS) or AWMAC/WI (NAAWS), Section 5 -Finishing for grade specified and as follows:

B. Seal door top edge with matching sealer to door facing. PART 3 EXECUTION

3.01 INSTALLATION Install doors in accordance with manufacturer's instructions and AWI Section 1300.

Install fire-rated doors in accordance with NFPA 80 and IBC Section 715 requirements. B. Coordinate installation of doors with installation of frames and hardware.

END OF SECTION SECTION 08 3100 ACCESS DOORS AND PANELS

PART 1 GENERAL 1.01 SECTION INCLUDES

A. Access door and frame units, fire-rated and non-fire-rated, in wall and ceiling locations. A. Product Data: Provide sizes, types, fire ratings, finishes, hardware, scheduled locations, and

2.01 WALL AND CEILING MOUNTED ACCESS UNITS

details of adjoining work.

A. Wall and Ceiling Mounted Units: Factory fabricated door and frame, fully assembled units with corner joints welded, filled and ground flush; square and without rack or warp; coordinate requirements with type of installation assembly being used for each unit. 1. Units in Fire Rated Assemblies: Fire rating equivalent to the fire rated assembly in which they are to be installed.

Material: Steel. Material at wet areas: Steel, hot-dipped zinc, or zinc-aluminum-alloy coated. Type 1: Exposed frame with door surface flush with frame surface. Steel Finish: Primed

5. Type 2: Frame concealed by door panel. Gypsum Board Mounting Criteria: Use drywall bead type frame. Steel Finish: Primed.

6. Type 3: Recessed door panel for infill with wall/ceiling finish. a. Gypsum Board Mounting Criteria: Use drywall bead type frame. Door/Panel: Hinged, standard duty, with tool-operated spring or cam lock and no

PART 3 EXECUTION 3.01 INSTALLATION

A. Install units in accordance with manufacturer's instructions. B. Install frames plumb and level in openings, and secure units rigidly in place.

END OF SECTION

SECTION 08 7100 DOOR HARDWARE

PART 1 GENERAL 1.01 SECTION INCLUDES

Hardware for wood and hollow metal doors. B. Electrically operated and controlled hardware.

1.02 SUBMITTALS A. Product Data: Manufacturer's catalog literature for each type of hardware, marked to clearly show products to be furnished for this project, and includes construction details. material scriptions, finishes, and dimensions and profiles of individual components.

B. Samples for Verification: Submit one (1) sample of hinge, latchset, lockset, and closer illustrating style, color, and finish

C. Maintenance Data: Include data on operating hardware, lubrication requirements, and inspection procedures related to preventative maintenance. D. Hardware Schedule: Detailed listing of each item of hardware to be installed on each door.

Use door numbering scheme as included in the Contract Documents. Identify electrically operated items and include power requirements. Keying Schedule: Submit for approval of Owner.

A. Warranty against defects in material and workmanship for period indicated, from Date of

Substantial Completion Closers: Five years, minimum. Exit Devices: Three years, minimum.

Locksets and Cylinders: Three years, minimum. 4. Other Hardware: Two years, minimum.

PART 2 PRODUCTS

2.01 DESIGN AND PERFORMANCE CRITERIA A. Match Building Standard Hardware manufacturer, model, and finish, U.N.O. B. Provide specified door hardware as required to make doors fully functional, compliant with

applicable codes, and secure to extent indicated. C. Provide door hardware products that comply with the following requirements: Applicable provisions of federal, state, and local codes. Fire-Rated Doors: NFPA 80, listed and labeled by qualified testing agency for fire

protection ratings indicated, based on testing at positive pressure in accordance with NFPA 252 or UL 10C. Hardware on Fire-Rated Doors: Listed and classified by UL (DIR), ITS (DIR), or testing firm acceptable to authorities having jurisdiction as suitable for application

Hardware for Smoke and Draft Control Doors: Provide door hardware that complies with local codes, and requirements of assemblies tested in accordance with UL 1784.

Listed and certified compliant with specified standards by BHMA (CPD). Hardware Preparation for Steel Doors and Steel Frames: BHMA A156.115. Hardware Preparation for Wood Doors with Wood or Steel Frames: BHMA A156.115W.

Products Requiring Electrical Connection: Listed and classified by UL (DIR) as suitable for the purpose specified. D. Electrically Operated and/or Controlled Hardware: Provide necessary power supplies, power

between hardware and control components and to building power connection in compliance Provide fasteners of proper type, size, quantity, and finish that comply with

transfer hinges, relays, and interfaces as required for proper operation; provide wiring

commercially recognized standards for proposed applications. A. Finishes: Provide door hardware of same finish and building standards, unless otherwise

PART 3 EXECUTION 3.01 INSTALLATION A. Install hardware in accordance with manufacturer's instructions and applicable codes. B. Install hardware on fire-rated doors and frames in accordance with applicable codes and

C. Install hardware for smoke and draft control doors in accordance with NFPA 105. D. Use templates provided by hardware item manufacturer.

 A. Adjust hardware for smooth operation. **END OF SECTION**

3.02 ADJUSTING

SECTION 08 8000 GLAZING

PART 1 GENERAL 1.01 SECTION INCLUDES

> A. Glazing units. Mirrors. Plastic films

Glazing compounds 1.02 SUBMITTALS

A. Product Data on Glazing Unit Glazing Types: Provide structural, physical and environmental characteristics, size limitations, special handling and installation requirements. Product Data on Glazing Compounds and Accessories: Provide chemical, functional, and

environmental characteristics, limitations, special application requirements, and identify available colors. 1.03 QUALITY ASSURANCE

A. Perform Work in accordance with GANA (GM), GANA (SM), and GANA (LGRM) for glazing installation methods. 1.04 WARRANTY

A. Laminated Glass: Provide a ten (10) year manufacturer warranty to include coverage for delamination, including replacement of failed units. B. Heat Soaked Tempered Glass: Provide a five (5) year manufacturer warranty to include coverage for spontaneous breakage of fully tempered glass caused by nickel sulfide (NiS)

PART 2 PRODUCTS 2.01 GLASS MATERIALS

A. Float Glass: Provide float glass based glazing unless otherwise indicated. 1. Annealed Type: ASTM C1036, Type I - Transparent Flat, Class 1 - Clear, Quality -Kind HS - Heat-Strengthened Type: Complies with ASTM C1048. Fully Tempered Safety Glass: Complies with ANSI Z97.1 or 16 CFR 1201 criteria for

 Category II criteria. B. Laminated Glass: glass laminated in accordance with ASTM C1172. 1. Laminated Safety Glass: Complies with ANSI Z97.1 - Class B or 16 CFR 1201 -Category I impact test requirements. Ionoplast Interlayer: 0.060 inch thick, minimum.

4. Impact Resistant Safety Glass: Complies with ANSI Z97.1 - Class A, or 16 CFR 1201

2.02 GLAZING UNITS A. Monolithic Interior Vision Glazing:

Applications: Interior glazing unless otherwise indicated. Glass Type: Annealed float glass.

Tint: Clear. Thickness: 1/2 inch, nominal, or as required to meet deflection criteria.

B. Monolithic Interior Vision Safety Glazing: Applications: Interior glazing unless otherwise indicated. Glass Type: Fully tempered float glass.

safety glazing used in hazardous locations.

Tint: Clear. 4. Thickness: 1/2 inch, nominal, or as required to meet deflection criteria.

C. Monolithic Impact-resistant Safety Glazing: Non-fire-rated. Applications: Shower and bathtub enclosures and doors.

2. Glass Type: Impact resistant safety glass as specified.

b. Butt-glazed or uncaptured glazed sidelights, except in fire-rated walls and c. Glazed view windows and panels in partitions enclosing athletic activity rooms,

except in fire-rated walls and partitions d. Other locations required by applicable federal, state, and local codes and e. Other locations indicated on drawings.

4. Thickness: 1/2 inch, nominal, or as required to meet deflection criteria. D. Security Glazing: Laminated glass, 2-Ply.

Float Glass laminated in accordance with ASTM C1172. Complies with ANSI Z97.1 and 16 CFR 1201 test requirements for Category II. Thickness: minimum 9/16 inch, or as required to meet deflection criteria. Outer Lite: Tempered glass

Interlayer: SGP, 0.060 thick, minimum. Inside Lite: Tempered glass. 2.03 MIRRORS

A. Mirror Design Criteria: Select materials and/or provide supports as required to limit mirror material deflection to {CH#142417}, or to the flexure limit of glass, with full recovery of glazing materials, whichever is less.

B. ASTM C1036, Type 1 - Transparent Flat, Class 1 - Clear, Quality - Q1 (high-quality mirrors); lead- and copper-free process, silver nitrate coating, protective coating, and quality requirements in compliance with ASTM C1503.

2.04 PLASTIC FILMS A. Decorative Plastic Film: Vinvl type. Application: Locations as indicated on drawings.

Color: As noted in Drawings. Thickness Without Liner: 0.002 inch. 2.05 ACCESSORIES A. Setting Blocks: Neoprene or silicone per glass manufacturer's recommendations, with 80 to

foot of glazing or minimum 4 inch x width of glazing rabbet space minus 1/16 inch x height to suit glazing method and pane weight and area. Spacer Shims: Neoprene or silicone per glass manufacturer's recommendations, 50 to 60 Shore A durometer hardness; ASTM C864 Option I. Minimum 3 inch long x one half the height of the glazing stop x thickness to suit application, self adhesive on one face. Glazing Tape: Closed cell polyvinyl chloride (PVC) foam, coiled on release paper over

90 Shore A durometer hardness; ASTM C864 Option I. Length of 0.1 inch for each square

adhesive on two sides, maximum water absorption by volume of 2 percent, designed for compression of 25 percent to effect an air barrier and vapor retarder seal; as required inch D. Glazing Gaskets: Resilient silicone extruded shape to suit glazing channel retaining slot;

ASTM C864 Option I; color black. Glazing Clips: Manufacturer's standard type. PART 3 EXECUTION

3.01 INSTALLATION - DRY GLAZING METHOD (GASKET GLAZING) A. Place setting blocks at 1/4 points with edge block no more than 6 inch from corners. B. Rest glazing on setting blocks and push against fixed stop with sufficient pressure on gasket

Install removable stops without displacing glazing gasket; exert pressure for full continuous

END OF SECTION SECTION 09 2116

GYPSUM BOARD ASSEMBLIES PART 1 GENERAL

1.01 SECTION INCLUDES A. Performance criteria for gypsum board assemblies. Metal stud wall framing. Metal ceiling framing system

1.03 QUALITY ASSURANCE

Acoustic framing accessories. Cementitious backing board. Glass mat faced gypsum backing board Gypsum wallboard.

Glass mat faced gypsum board sheathing.

accessories, and joint finishing system

Joint treatment and accessories. 1.02 SUBMITTALS A. Product Data: Provide data on metal framing, gypsum board, glass mat faced gypsum board,

B. Product Data: Provide manufacturer's data on partition head to structure connectors, showing compliance with requirements. Product Data: Provide manufacturer's span tables, noting member sizes and spans to be used, and demonstrating compliance with the performance requirements.

PART 2 PRODUCTS 2.01 GYPSUM BOARD ASSEMBLIES A. Provide completed assemblies complying with ASTM C840 and GA-216. B. Fire-Resistance-Rated Assemblies: Provide completed assemblies complying with

2.02 METAL FRAMING MATERIALS A. Non-structural Framing System Components: ASTM C645; galvanized sheet steel, of size and properties necessary to comply with ASTM C754 for the spacing indicated, with maximum deflection of wall framing of L/240 at 5 psf.

B. Partition Head To Structure Connections: Provide track fastened to structure with legs of sufficient length and slotted for fasteners to accommodate deflection, for friction fit of studs cut short . Anchors are not to exceed 3/4" of penetration into Post Tension Slabs. Non-structural Framing Accessories:

1. Ceiling Hangers: Type and size as specified in ASTM C754 for spacing required.

D. Pre-engineered Ceiling Grid Suspension Systems: Steel grid system of main tees and support bars connected to structure using hanging wire.

2.03 BOARD MATERIALS A. Gypsum Wallboard: Paper-faced gypsum panels as defined in ASTM C1396/C1396M; sizes

to minimize joints in place; ends square cut. Application: Use for vertical surfaces, unless otherwise indicated. At Assemblies Indicated with Fire-Resistance Rating: Use type required by indicated

tested assembly; if no tested assembly is indicated, use Type X board, UL or WH

B. Backing Board For Wet Areas: Application: Surfaces behind tile in wet areas including tub and shower surrounds and shower ceilings.

> Mold Resistance: Score of 10, when tested in accordance with ASTM D3273. ASTM Cement-Based Board: Non-gypsum-based, cementitious board complying with ASTM C1288.

Glass Mat Faced Board: Coated glass mat water-resistant gypsum backing panel as defined in ASTM C1178/C1178M. C. Backing Board For Non-Wet Areas: Water-resistant gypsum backing board as defined in

ASTM C1396/C1396M; sizes to minimum joints in place; ends square cut. Application: Vertical surfaces behind thinset tile, except in wet areas.

Mold Resistance: Score of 10, when tested in accordance with ASTM D3273. D. Ceiling Board: Special sag resistant gypsum ceiling board as defined in ASTM

C1396/C1396M; sizes to minimize joints in place; ends square cut.

2.04 GYPSUM WALLBOARD ACCESSORIES A. Acoustic Insulation: ASTM C665; preformed glass fiber, friction fit type, unfaced. Thickness: 3 1/2 inch.

B. Resilient Furring Channels: Single leg configuration; 1/2 inch channel depth. C. Resilient Sound Isolation Clips: Steel resilient clips with molded rubber isolators, attaches to framing; improves noise isolation performance of wall and floor-ceiling assemblies.

D. Beads, Joint Accessories, and Other Trim: ASTM C1047, galvanized steel or rolled zinc, unless noted otherwise. Corner Beads: Low profile, for 90 degree outside corners.

Application: Ceilings, unless otherwise indicated.

Architectural Reveal Beads: Reveal Depth: 1/2 inch b. Reveal Width: 1/2 inch

for project conditions.

PART 3 EXECUTION

3.04 JOINT TREATMENT

1.01 SECTION INCLUDES

A. Tile for floor applications.

cement grout.

PART 3 EXECUTION

a. V shape with perf flanges and plastic zip tape. E. Joint Materials: ASTM C475/C475M and as recommended by gypsum board manufacturer

Wall Mounted Deflection Beads: Flexible gasket and bead with 1-1/8 inch flange.

3.01 FRAMING INSTALLATION A. Metal Framing: Install in accordance with ASTM C754 and manufacturer's instructions. 3.02 ACOUSTIC ACCESSORIES INSTALLATION

A. Acoustic Insulation: Place tightly within spaces, around cut openings, behind and around electrical and mechanical items within partitions, and tight to items passing through partitions. 3.03 BOARD INSTALLATION A. Comply with ASTM C840, GA-216, and manufacturer's instructions. Install to minimize butt

end joints, especially in highly visible locations. B. Single-Layer Nonrated: Install gypsum board in most economical direction, with ends and edges occurring over firm bearing. C. Double-Layer, Nonrated: Use gypsum board for first layer, placed parallel to framing or

perpendicular to framing or furring members. Offset joints of second layer from joints of first D. Fire-Rated Construction: Install gypsum board in strict compliance with requirements of listing authority or approved assembly.

furring members, with ends and edges occurring over firm bearing. Use glass mat faced

gypsum board at exterior walls and at other locations as indicated. Place second layer

E. Cementitious Backing Board: Install over steel framing members and plywood substrate where indicated, in accordance with ANSI A108.11 and manufacturer's instructions. F. Installation on Metal Framing: Use screws for attachment of gypsum board except face layer of nonrated double-layer assemblies, which may be installed by means of adhesive

A. Paper Faced Gypsum Board: Use paper joint tape, bedded with ready-mixed vinyl-based joint compound and finished with ready-mixed vinyl-based joint compound. B. Finish gypsum board in accordance with levels defined in ASTM C 840 Level 5: Walls and ceilings to receive semi-gloss or gloss paint finish and other areas specifically indicated.

2. Level 4: Walls and ceilings to receive paint finish or wall coverings, unless otherwise 3. Level 2: In utility areas, behind cabinetry, and on backing board to receive tile finish.

Level 1: Fire-resistance-rated wall areas above finished ceilings, whether or not

accessible in the completed construction. **END OF SECTION**

SECTION 09 3000 TILE PART 1 GENERAL

B. Tile for wall applications. C. Setting Beds and Grout D. Crack Isolation and Waterproof Membranes 1.02 SUBMITTALS A. Product Data: Provide manufacturers' data sheets on tile, mortar, grout, and accessories.

Include instructions for using grouts and adhesives. B. Samples: Mount tile and apply grout on two plywood panels, minimum 18 by 18 inches in size illustrating pattern, color variations, and grout joint size variations. 1.03 MOCK-UP

A. See Section 01 4000 - Quality Requirements, for general requirements for mock-up. B. Construct tile mock-up where indicated on drawings, incorporating all components specified 1.04 FIELD CONDITIONS A. Do not install solvent-based products in an unventilated environment.

B. Maintain ambient and substrate temperature above 50 degrees F and below 100 degrees F during installation and curing of setting materials. 1.05 WARRANTY A. Manufacturer's system limited warranty stating that underlayments, waterproofing, setting materials, grout, primers, sealers, and other system components shall be free from defects,

deterioration, cracking, or other failures under normal wear for a period of 10 years. PART 2 PRODUCTS 2.01 TILE: REFER TO FINISH LEGEND FOR TILE PRODUCTS 2.02 MANUFACTURER SYSTEM MATERIALS

2.03 SETTING MATERIALS A. Provide setting and grout materials from same manufacturer. B. Latex-Portland Cement Mortar Bond Coat: ANSI A118.4. Dry-Set Portland Cement Mortar Bond Coat: ANSI A118.1. 2.04 GROUTS

A. Installer shall provide materials from a single manufacturer's system as required to maintain

B. High Performance Polymer Modified Grout: ANSI A118.7 polymer modified cement grout. Use sanded grout for joints 1/8 inch wide and larger; use unsanded grout for joints less 2.05 MAINTENANCE MATERIALS

A. Provide setting and grout materials from same manufacturer.

the manufacturer's system warranty for the specified warranty period.

Composition: Water-based colorless silicone. Approved for use by the grout manufacturer. 2.06 ACCESSORY MATERIALS A. Provide accessory materials from the same manufacturer as the setting and grout materials.

1. If accessory materials are not available by the same manufacturer, provide accessory

A. Grout Sealer: Liquid-applied, moisture and stain protection for existing or new Portland

materials approved for use by the setting and grout manufacturer and which meet specified warranty requirements. B. Concrete Floor Slab Crack Isolation Membrane: Material complying with ANSI A118.12; not intended as waterproofing.

Crack Resistance: No failure at 1/8 inch gap City. of Portland C. Waterproofing Membrane at Floors: Specifically designed for bonding to cementitious substrate under thick mortar bed or thin-set tile; correction with \$15.00.

1. Crack Resistance: No failure at 1/16 inch gap, minimum; comply with ANSI A118.12.

D. Waterproofing Membrane at Showers and Tiled Top period of thin-set tile; complying with ANSI A118.10. E. Underlayment at Floors: Specifically designed for bonding to thin-set setting mortar; not primarily a waterproofing material and having the following 2020 teristics:

Sound Reduction: Comply with ANSI A118.13 bonded membrane, ANSI A118.13 bonded membrane, and ANSI A118.13 bonded membrane. Crack Resistance: No failure at 1/16 inch gap, minimum; comply with ANSI A118.12.

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STAMP



PROJECT

HDR Pearl West

Portland, OR 97209

1455 NW Irving St, Suite 800

CLIENT

1050 SW 6th Ave, Suite 1800

Portland, OR 97204

Notice of Extended Payment Provision: The contract will allow the owner to make payment within 30 days after the date a billing or estimate is submitted. Notice of Alternate Billing Cycle: The contract will allow the owner to require the submission of billings or estimates in billing cycles other than 30-day cycles. Billings or estimates for the contract shall be submitted as follows: Each calendar month ending on the last day of the applicable month.

DATE

05.06.2025

REVISIONS

PROJECT NUMBER

20137549

SCALE

SHEET TITLE SPECIFICATIONS

GBD INTERIORS MASTER sheet spec.pdf2023/03/16

3.01 INSTALLATION - GENERAL 2.02 MATERIALS A. Install tile and thresholds and grout in accordance with applicable requirements of ANSI A. Broadloom Carpeting: Critical Radiant Flux: Minimum of 0.22 watts/sq cm, when tested in accordance with A108.1a through ANSI A108.19 , manufacturer's instructions, and TCNA (HB) ASTM E648 or NFPA 253. B. Lay tile to pattern indicated. Do not interrupt tile pattern through openings. Surface Flammability Ignition: Pass ASTM D2859 (the "pill test"). 3.02 INSTALLATION - FLOORS - THIN-SET METHODS VOC Content: Provide CRI (GLP) certified product; in lieu of labeling, independent A. Over interior concrete substrates, install in accordance with the TCNA (HB) Method best test report showing compliance is acceptable. suited for the substrate and location, with standard grout, unless otherwise indicated. Tile Carpeting: 1. Critical Radiant Flux: Minimum of 0.22 watts/sq cm, when tested in accordance with Use uncoupling membrane under all tile unless other underlayment is indicated. Use waterproofing membrane at wet areas. ASTM E648 or NFPA 253. B. Over wood substrates, install in accordance with the TCNA (HB) Method best suited for the Surface Flammability Ignition: Pass ASTM D2859 (the "pill test"). substrate and location, with standard grout, unless otherwise indicated. VOC Content: Provide CRI (GLP) certified product; in lieu of labeling, independent 3.03 INSTALLATION - SHOWERS AND BATHTUB test report showing compliance is acceptable. 2.03 ACCESSORIES A. At tiled showers and bathtubs install in accordance with the TCNA (HB) Method best suited for the substrate and location. Wall tile shall be thin-set over waterproof membrane on A. Cushion: broadloom carpet locations where indicated on drawings. cementitious backer units. 1. VOC Content: Provide CRI (GL) certified product; in lieu of labeling, independent test B. Grout with standard grout as specified above. eport showing compliance is acceptable 3.04 INSTALLATION - WALL TILE Subfloor Filler: White premix latex; type recommended by flooring material manufacturer. A. Over cementitious backer units on studs, install in accordance with TCNA (HB) Method best Edge Strips: Premium Vinyl or Rubber, color as selected by Architect. Adhesives: Acceptable to carpet tile manufacturer, compatible with materials being adhered; suited to the application, using membrane at toilet rooms. B. Over coated glass mat backer board on studs, install in accordance with TCNA (HB) Method maximum VOC of 50 g/L; CRI Green Label certified; in lieu of labeled product, independent best suited to the application. test report showing compliance is acceptable. PART 3 EXECUTION **END OF SECTION** 3.01 INSTALLATION - BROADLOOM A. Install carpet and cushion in accordance with manufacturer's instructions and CRI 104. **SECTION 09 5100** B. Lay out carpet and locate seams in accordance with shop drawings. **ACOUSTICAL CEILINGS** Locate seams in area of least traffic, out of areas of pivoting traffic, and parallel to PART 1 GENERAL 1.01 SECTION INCLUDES Align run of pile in same direction as anticipated traffic and in same direction on A. Suspended metal grid ceiling system. adjacent pieces. B. Acoustical units. Double cut carpet seams, with accurate pattern match. Make cuts straight, true, and 1.02 SUBMITTALS unfrayed. Apply seam adhesive to cut edges of woven carpet immediately. A. Shop Drawings: Indicate grid layout and related dimensioning. 3.02 INSTALLATION - TILE B. Product Data: Provide data on suspension system components and acoustical units. Install carpet and cushion in accordance with manufacturer's instructions and CRI 104. 1.03 FIELD CONDITIONS Blend carpet from different cartons to ensure minimal variation in color match. A. Maintain uniform temperature of minimum 60 degrees F, and maximum humidity of 40 Cut carpet tile clean. Fit carpet tight to intersection with vertical surfaces without gaps. percent prior to, during, and after acoustical unit installation. Lay carpet tile in square pattern, with pile direction parallel to next unit, set parallel to building 1.04 ADDITIONAL STOCK A. Provide no less than 1 full case of each type of Acoustic Panel to Owner's designated storage **END OF SECTION** PART 2 PRODUCTS **SECTION 09 9123** 2.01 PERFORMANCE REQUIREMENTS **INTERIOR PAINTING** A. Fire-Resistance Rating: Determined in accordance with test procedures in ASTM E119. B. Seismic Performance: Ceiling systems designed to withstand the effects of earthquake PART 1 GENERAL motions determined according to ASCE 7 for Seismic Design Category D, E, or F and 1.01 SECTION INCLUDES complying with the following: Surface preparation 1. Local authorities having jurisdiction. Field application of paints 2.02 ACOUSTICAL UNITS Scope: Finish interior surfaces exposed to view, unless fully factory-finished and unless A. Match Building Standard U.N.O. otherwise indicated 1.02 SUBMITTALS B. Acoustical Units - General: ASTM E1264, Class A. 2.03 SUSPENSION SYSTEM(S) A. Product Data: Provide complete list of products to be used, with the following information for A. Match Building Standard U.N.O. B. Metal Suspension Systems - General: Complying with ASTM C635/C635M; die cut and 1. Manufacturer's name, product name and/or catalog number, and general product interlocking components, with perimeter moldings, hold down clips, stabilizer bars, clips, and category (e.g. "alkyd enamel"). splices as required. Samples: Submit three paper "draw down" samples, 8-1/2 by 11 inches in size, illustrating PART 3 EXECUTION range of colors available for each finishing product specified. 3.01 PREPARATION Where sheen is specified, submit samples in only that sheen. PART 2 PRODUCTS A. Install after major above-ceiling work is complete. 2.01 MANUFACTURERS B. Coordinate the location of hangers with other work. 3.02 INSTALLATION - SUSPENSION SYSTEM A. Provide paints and finishes from the same manufacturer to the greatest extent possible. A. Install suspension system in accordance with ASTM C636/C636M, ASTM C636/C636M, and 2.02 PAINTS AND FINISHES - GENERAL ASTM C636/C636M and as supplemented in this section A. Paints and Finishes: Ready mixed, unless intended to be a field-catalyzed paint. 3.03 INSTALLATION - ACOUSTICAL UNITS 1. Where MPI paint numbers are specified, provide products listed in Master Painters A. Install acoustical units in accordance with manufacturer's instructions. Institute Approved Product List, current edition available at www.paintinfo.com, for B. Fit acoustical units in place, free from damaged edges or other defects detrimental to specified MPI categories, except as otherwise indicated. appearance and function. Supply each paint material in quantity required to complete entire project's work from a single production run. END OF SECTION Do not reduce, thin, or dilute paint or finishes or add materials unless such procedure **SECTION 09 6500** is specifically described in manufacturer's product instructions. Volatile Organic Compound (VOC) Content: **RESILIENT FLOORING** 1. Provide paints and finishes that comply with the most stringent requirements specified PART 1 GENERAL 1.01 SECTION INCLUDES a. 40 CFR 59, Subpart D--National Volatile Organic Compound Emission Standards A. Resilient sheet flooring. for Architectural Coatings. B. Resilient vinyl plank flooring. b. SCAQMD 1113 Rule. C. Resilient base. 2.03 PAINT SYSTEMS - INTERIOR D. Installation accessories A. Interior Surfaces to be Painted, Unless Otherwise Indicated: Including gypsum board, 1.02 SUBMITTALS plaster, and shop primed steel. A. Product Data: Provide data on specified products, describing physical and performance Two top coats and one coat primer Top Coat(s): Institutional Low Odor/VOC Interior Latex; MPI #143, 144, 145, 146, 147. characteristics; including sizes, patterns and colors available; and installation instructions. B. Verification Samples: Submit two samples, 12 by 12 inch in size illustrating color and pattern Primer: As recommended by top coat manufacturer for specific substrate 1.03 FIELD CONDITIONS B. Medium Duty Door/Trim: For surfaces subject to frequent contact by occupants, including A. Maintain temperature in storage area between 55 degrees F and 90 degrees F. PART 2 PRODUCTS Two top coats and one coat primer. 2.01 MATCH BUILDING STANDARD U.N.O. IN FINISH LEGEND Top Coat(s): Interior Alkyd, Water Based; MPI #157, 167, 168, or 169. 2.02 SHEET FLOORING C. Interior Surfaces to be Finished with Dry Erase Coating. A. Vinyl Sheet Flooring: Color and pattern throughout wear layer thickness, with backing. One top coat. 1. Minimum Requirements: Comply with ASTM F1303, Type II, with Class A fibrous Top Coat(s): Dry Erase Coating, Waterbased Polyurethane. 2.04 PRIMERS B. Vinyl Welding Rod: Solid vinyl bead produced by manufacturer of vinyl flooring for heat A. Primers: Provide the following unless other primer is required or recommended by welding seams, in color matching field color. manufacturer of top coats. 2.03 TILE FLOORING 1. Interior Institutional Low Odor/VOC Primer Sealer; MPI #149. A. Vinyl Tile: Printed film type, with transparent or translucent wear layer; acoustic interlayer or PART 3 EXECUTION 3.01 EXAMINATION 1. Minimum Requirements: Comply with ASTM F1700, Class III. A. Measure moisture content of surfaces using an electronic moisture meter. Do not apply 2.04 RESILIENT BASE finishes unless moisture content of surfaces are below the following maximums: A. Resilient Base: ASTM F1861, Type TS rubber, vulcanized thermoset; top set Style B, Cove. Gypsum Wallboard: 12 percent. Critical Radiant Flux (CRF): Minimum 0.45 watt per square centimeter, when tested in Interior Wood: 15 percent, measured in accordance with ASTM D4442. accordance with ASTM E 648 or ASTM E 648. 3.02 PREPARATION 2. Accessories: Premolded external corners and internal corners. A. Clean surfaces thoroughly and correct defects prior to application. 2.05 ACCESSORIES Prepare surfaces using the methods recommended by the manufacturer for achieving the A. Subfloor Filler: White premix latex; type recommended by adhesive material manufacturer. best result for the substrate under the project conditions. B. Primers and Adhesives: Waterproof; types recommended by flooring manufacturer with Remove or repair existing paints or finishes that exhibit surface defects. emission limits of VOC's: 10 mg/sq m/hr; formaldehyde: 0.05 mg/sq m/hr; ethyl/hexanol: 3.0 Remove or mask surface appurtenances, including electrical plates, hardware, light fixture mg/sq. m/hr trim, escutcheons, and fittings, prior to preparing surfaces or finishing. PART 3 EXECUTION Seal surfaces that might cause bleed through or staining of topcoat. 3.01 INSTALLATION - GENERAL Gypsum Board: Fill minor defects with filler compound. Spot prime defects after repair. A. Starting installation constitutes acceptance of subfloor conditions. 3.03 APPLICATION B. Install in accordance with manufacturer's written instructions. Apply products in accordance with manufacturer's written instructions and recommendations Spread only enough adhesive to permit installation of materials before initial set. in "MPI Architectural Painting Specification Manual". Fit all joints tightly. B. Do not apply finishes to surfaces that are not dry. Allow applied coats to dry before next coat Set flooring in place, press with heavy roller to attain full adhesion. is applied. 3.02 INSTALLATION - SHEET FLOORING **END OF SECTION** A. Lay flooring with joints and seams parallel to longer room dimensions, to produce minimum number of seams. Lay out seams to avoid widths less than 1/3 of roll width; match patterns 3.03 INSTALLATION - PLANK FLOORING A. Mix tile from container to ensure shade variations are consistent when tile is placed, unless otherwise indicated in manufacturer's installation instructions. B. Lay flooring with joints and seams parallel to building lines to produce symmetrical pattern. 3.04 INSTALLATION - RESILIENT BASE A. Ensure substrate/background meets the requirements of ASTM F1861. B. Fit joints tightly and make vertical. Maintain minimum dimension of 18 inches between joints.

SECTION 11 3100 RESIDENTIAL APPLIANCES A. Product Data: Manufacturer's data indicating dimensions, capacity, and operating features of each piece of residential equipment specified. 1.03 QUALITY ASSURANCE A. Electric Appliances: Listed and labeled by UL (DIR) and complying with NEMA Standards (National Electrical Manufacturers Association). A. Provide five (5) year manufacturer warranty on refrigeration system of refrigerators. B. Provide ten (10) year manufacturer warranty on magnetron tube of microwave ovens. Provide ten (10) year manufacturer warranty on tub and door liner of dishwashers. 2.01 KITCHEN APPLIANCES A. Provide Equipment Eligible for Energy Star Rating: Energy Star Rated. A. Install in accordance with manufacturer's instructions. **END OF SECTION SECTION 12 2400** WINDOW SHADES

PART 1 GENERAL

1.02 SUBMITTALS

1.04 WARRANTY

PART 2 PRODUCTS

PART 3 EXECUTION

PART 1 GENERAL

1.02 SUBMITTALS

1.01 SECTION INCLUDES

A. Interior roller shades.

3.01 INSTALLATION

1.01 SECTION INCLUDES

A. Kitchen appliances

A. Product Data: Provide manufacturer's standard catalog pages and data sheets, including materials, finishes, fabrication details, dimensions, profiles, mounting requirements, and 1. Motorized Shades: Include power requirements and standard wiring diagrams for specified products. B. Shop Drawings: Include shade schedule indicating size, location and keys to details, head, jamb and sill details, mounting dimension requirements for each product and condition, and operation direction. Selection Samples: Include fabric samples in full range of available colors and patterns. Verification Samples: Minimum size 6 inches square, representing actual materials, color and pattern. 1.03 WARRANTY A. Provide manufacturer's warranty from Date of Substantial Completion, covering the following: 1. Shade Hardware: One yea Electric Motors: One year. Fabric: One year. 4. Aluminum and Steel Coatings: One year. PART 2 PRODUCTS 2.01 ROLLER SHADES A. General: Shade system to match building standard. 2. Motorized Shades: Motor system housed inside roller tube, controlling shade movement via motor controls indicated; listed or recognized to UL 325. Comply with NFPA 70. Motors: Size and configuration as recommended by manufacturer for the type, size, and arrangement of shades to be operated; integrated into shade operating components and concealed from view; fully compatible with controls to be 1. Brackets and Mounting Hardware: As recommended by manufacturer for mounting indicated and to accommodate shade fabric roll-up size and weight. Roller Tubes: As required for type of shade operation. Hembars: Designed to maintain bottom of shade straight and flat. Manual Operation for Interior Shades: a. Clutch Operator: Manufacturer's standard material and design, permanently b. Drive Chain: Continuous loop beaded ball chain, 95 lb minimum breaking strength. Provide upper and lower limit stops. c. Chain Retainer: 1) Chain tensioning device complying with WCMA A100.1. 2.02 SHADE FABRIC A. Fabric: Nonflammable, color-fast, impervious to heat and moisture, and able to retain its shape under normal operation Performance Requirements a. Flammability: Pass NFPA 701 large and small tests. 2.03 MOTOR CONTROLS A. Where motorized shades are scheduled, provide all required equipment, conduit, boxes, wiring, connectors, hardware, supports, accessories, software, system programming, etc. as necessary for a complete operating system that provides the control intent indicated. PART 3 EXECUTION 3.01 INSTALLATION A. Install in accordance with manufacturer's instructions and approved shop drawings, using mounting devices as indicated B. Adjust level, projection, and shade centering from mounting bracket. Verify there is no telescoping of shade fabric. Ensure smooth shade operation. **END OF SECTION SECTION 22 0100** PLUMBING DESIGN-BUILD PART 1 - GENERAL 1.01 CONTRACT CONDITIONS A. The General Contractor shall retain a competent Design-build Plumbing contractor to execute the design-build responsibilities described in this specification. B. Plumbing systems shall be designed by an engineer licensed in the state of the project and drawings and specifications prepared for the Project shall bear the registration stamp of the designing engineer 1.02 CONTRACTOR'S DESIGN RESPONSIBILITIES A. Design-build contractor is responsible for designing a full plumbing system as described in B. Design-build contractor is responsible for preparation of permit drawings, construction drawings, and as-built drawings describing the final plumbing systems installation. C. Design build contractor is responsible for all necessary coordination with other design-build contractors and the General Contractor. D. Design-build contractor shall coordinate layout of plumbing system with Architect. 1.03 DESCRIPTION OF SYSTEM A. Provide Plumbing Work specified herein. All work shall conform to applicable national, state, and local codes. Contractor is responsible for installation of complete and operating Provide U.L. labels for all equipment falling under testing capabilities of U.L. Procure licenses and permits, and pay fees, deposits, assessments and tax charges required D. Arrange for and pay for inspections and tests required by codes and ordinances during 1.04 REFERENCE STANDARDS A. The publications listed below form a minimum part of this specification to the extent referenced. The current editions of the publications are referred to in the text by the basic designation only. Underwriters Laboratories (UL). 2. National Fire Protection Association (NFPA), specifically: a. NFPA 70 - National Electric Code. b NFPA 72 - National Fire Alarm Code c. NFPA 101 - Life Safety Code. d. NFPA 90A - Installation of Air Conditioning and Ventilating Systems. 3. Oregon Plumbing Specialty Code International Building Code (IBC) with State of Oregon Amendments 5. City, County, and State Codes and Ordinances. PART 2 - PRODUCTS (NOT USED) PART 3 - EXECUTION (NOT USED) **END OF SECTION SECTION 22 4000 PLUMBING FIXTURES** PART 1 GENERAL 1.01 SECTION INCLUDES A. Flush valve water closets. B. Bidets. C. Wall hung urinals. D. Lavatories. E. Under-lavatory pipe supply covers. 1.02 SUBMITTALS A. Product Data: Provide catalog illustrations of fixtures, sizes, rough-in dimensions, utility sizes, trim, and finishes PART 2 PRODUCTS 2.01 GENERAL REQUIREMENTS A. Match building standard fixtures U.N.O. Potable Water Systems: Provide plumbing fittings and faucets that comply with NSF 61 and NSF 372 for maximum lead content; label pipe and fittings. 2.02 WATER CLOSETS

A. Water Closets: Vitreous china, ASME A112.19.2, floor mounted or wall hung per building standard, siphon jet flush action, china bolt caps.

Flush Valves where scheduled: ASME A112.18.1, diaphragm type, complete with vacuum

breaker stops and accessories Wall Carrier: ASME A112.6.1M; adjustable cast iron frame, integral drain hub and vent,

adjustable spud, lugs for floor and wall attachment, threaded fixture studs with nuts and

D. Seat: Per Building Standard. If no building standard, then Solid white plastic, open front,

extended back, less cover, complete with self-sustaining hinge.

2.03 WALL HUNG URINALS

B. Flush Valves:

A. Vitreous china, ASME A112.19.2, wall hung with side shields and concealed carrier. C. Urinal Carriers

attachment, threaded fixture studs for fixture hanger, bearing studs. 2.04 LAVATORIES A. Refer to plumbing fixture schedule for lavatory and faucet manufacturer and model, or match

ASME A112.6.1M; cast iron and steel frame with tubular legs, lugs for floor and wall

building standard. B. Vitreous China Counter Top Basin: ASME A112.19.2; vitreous china self-rimming counter top lavatory, size as scheduled with drillings on 4 inch centers, front overflow, seal of putty, calking, or concealed vinyl gasket.

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PROJECT

CLIENT

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Portland, OR 97209

Portland, OR 97204

1455 NW Irving St, Suite 800

1050 SW 6th Ave, Suite 1800

Notice of Extended Payment

Provision: The contract will

payment within 30 days after

the date a billing or estimate is

submitted. Notice of Alternate

Billing Cycle: The contract will

allow the owner to require the

submission of billings or

estimates in billing cycles

other than 30-day cycles.

Billings or estimates for the

contract shall be submitted as

ending on the last day of the

applicable month.

REVISIONS

DATE

05.06.2025

20137549

SCALE

PROJECT NUMBER

follows: Each calendar month

allow the owner to make

Tel. (503) 224-9656

1.01 CONTRACT CONDITIONS

A. General:

PART 3 EXECUTION

PART 1 - GENERAL

3.01 INSTALLATION

2.05 UNDER-LAVATORY PIPE SUPPLY COVERS

A. Install components level and plumb.

A. The General Contractor shall retain a competent Design-build HVAC contractor to execute the design-build responsibilities described in this specification.

1. Insulate exposed drainage piping including hot, cold and tempered water supplies

a. Comply with ASME A112.18.9 for covers on accessible lavatory piping.

Exterior Surfaces: Smooth nonabsorbent with no finger recessed indentations for easy

Construction: 1/8 inch PVC with antimicrobial, antifungal and UV resistant properties.

under lavatories or sinks per ADA Standards.

B. Install and secure fixtures in place with wall supports and bolts.

b. Comply with ICC A117.1.

B. HVAC systems shall be designed by an engineer licensed in the state of the project and drawings and specifications prepared for the Project shall bear the registration stamp of the designing engineer. 1.02 CONTRACTOR'S DESIGN RESPONSIBILITIES

END OF SECTION

SECTION 23 0100

HVAC DESIGN-BUILD

A. Design-build contractor is responsible for designing a full HVAC system as described in 1.03

B. Design-build contractor is responsible for preparation of permit drawings, construction drawings, and as-built drawings describing the final HVAC systems installation. C. Design-build contractor is responsible for all necessary coordination with other design-build

contractors and the General Contractor. D. Design-build contractor shall coordinate layout of HVAC system with Architect. 1.03 DESCRIPTION OF SYSTEM

A. All work shall conform to applicable national, state, and local codes. Contractor is responsible for installation of complete and operating HVAC systems. B. HVAC system shall be limited to the suite under construction; under no circumstances shall equipment, ductwork, sensors, dampers, and controls be located in an adjoining suite or in a

1. Exception: connections to building common supply and return systems or central air handling systems

C. Duct static pressure calculations. Hydronic calculations.

Details of all equipment attached to structure.

Details of all equipment connected to ductwork or piping. Specialty systems

H. Equipment schedules for all equipment connected to power, air, or water sources. Riser diagrams.

Control sequences of operation and diagrams.

K. Ductwork and piping plans. HVAC zoning plans aligned with control sensor placement.

M. Procure licenses and permits, and pay fees, deposits, assessments and tax charges required for Mechanical Work

N. Arrange for and pay for inspections and tests required by codes and ordinances during

construction. 1.04 REFERENCE STANDARDS A. The publications listed below form a minimum part of this specification to the extent

> referenced. The current editions of the publications are referred to in the text by the basic designation only. ASHRAE - American Society of Heating, Refrigeration, and Air Conditioning Engineers

AWS - American Welding Society SMACNA - Sheet Metal and Air Conditioning Design Builders National association

AABC - American Air Balance Council

ASPE - American Society of Plumbing Engineers

NETA - International Electrical Test and Acceptance Association PART 2 - PRODUCTS - NOT USED

PART 3 - EXECUTION - NOT USED END OF SECTION

SECTION 26 0100 ELECTRICAL DESIGN-BUILD

PART 1 - GENERAL 1.01 CONTRACT CONDITIONS

A. The General Contractor shall retain a competent Design-build Electrical contractor to execute

the design-build responsibilities described in this specification. B. Electrical systems shall be designed by an engineer licensed in the state of the project and drawings and specifications prepared for the Project shall bear the registration stamp of the

1.02 CONTRACTOR'S DESIGN RESPONSIBILITIES

A. Design-build contractor is responsible for designing a full electrical system as described in

B. Design-build contractor is responsible for preparation of permit drawings, construction drawings, and as-built drawings describing the final electrical systems installation.

C. Design-build contractor is responsible for all necessary coordination with other design-build contractors and the General Contractor

D. Design-build contractor shall coordinate layout of electrical system with Architect. 1.03 DESCRIPTION OF SYSTEM

A. All work shall conform to applicable national, state, and local codes. Contractor is responsible for installation of complete and operating electrical systems.

B. Electrical system shall be limited to the suite under construction; under no circumstances shall panels, sensors, switches, and other controls dedicated to the suite be located in or shared with an adjoining suite or a building common area.

1. No circuits shall be shared between suites except circuits identified by the building owner and designated as building controlled circuits.

C. Load calculations. D. Lighting plan with photometrics. One-line diagram.

 F. Electrical and lighting floor plans. G. Light fixture schedule Coordination study with breaker settings.

 Fault analysis. Lighting control schematic. K. Panel schedules.

1.04 REFERENCE STANDARDS A. The publications listed below form a minimum part of this specification to the extent referenced. The current editions of the publications are referred to in the text by the basic

ASTM E 329 - Evaluation of Testing and Inspection Agencies as Used in Construction. NETA - International Electrical Test and Acceptance Association.

IESNA - Illuminating Engineering Society of North America.

Date:5/22/2025

Permit #: 25-037217-000-00-FA

IEEE - Institute of Electrical and Electronic Engineers. All other standards as referenced throughout this set of specification.

PART 2 - PRODUCTS - NOT USED

PART 3 - EXECUTION - NOT USED

END OF SECTION

SHEET TITLE SPECIFICATIONS

City of Portland Reviewed for Code Compliance

GBD INTERIORS MASTER sheet spec.pdf2023/03/16

PART 1 GENERAL

1.02 SUBMITTALS

PART 2 PRODUCTS

1.01 SECTION INCLUDES

A. Carpet tile, fully adhered.

B. Broadloom Carpet.

color selected.

2.01 MATCH BUILDING STANDARD U.N.O.

END OF SECTION

SECTION 09 6813

CARPET

A. Product Data: Provide data on specified products, describing physical and performance

C. Samples: Submit two carpet samples illustrating color and pattern design for each carpet

characteristics; sizes, patterns, colors available, and method of installation.

Shop Drawings: Indicate layout of seams and layout of joints.

1. REMOVE ALL ITEMS SHOWN DASHED.

- 2. REMOVE ALL EXISTING CARPET THROUGHOUT SCOPE OF WORK, INCLUDING CARPET INSETS AT THE STAIR TREADS. PATCH & FILL HOLES OR DAMAGED AREAS AS REQUIRED.
- 3. REMOVE ALL EXISTING RUBBER BASE THROUGHOUT SCOPE OF WORK. AT EXISTING WALLS TO REMAIN, PATCH & REPAIR WOOD BASE
- 4. PATCH & REPAIR ANY DISTURBED CONSTRUCTION & FINISHES AT EXISTING SHELL CONSTRUCTION.

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REFERENCE NOTES

- 01 (E) FIRE EQUIPMENT LOCATED ON THIS WALL TO BE ŘÉMOVED.
- 02 REMOVE EXISTING GLASS ENTRY DOORS & ASSOCIATED INFRASTRUCTURE/HARDWARE. PATCH/REPAINT WALLS AS NEEDED.
- 03 REMOVE EXISTING RECEPTION DESK AND WAITING BENCH.

PROJECT

HDR Pearl West

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CLIENT

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Notice of Extended Payment Provision: The contract will allow the owner to make payment within 30 days after the date a billing or estimate is submitted. Notice of Alternate Billing Cycle: The contract will allow the owner to require the submission of billings or estimates in billing cycles other than 30-day cycles.

Billings or estimates for the contract shall be submitted as follows: Each calendar month ending on the last day of the applicable month. REVISIONS

2 04/30/2025 ASI 3 1 04/02/2025 ASI 2

05.06.2025

PROJECT NUMBER

20137549

SCALE

As indicated

City of Portland Reviewed for Code Compliance

Date:5/22/2025 Permit #: 25-037217-000-00-FA

SHEET TITLE LEVEL 08 - DEMO FLOOR PLAN

1. REMOVE ALL ITEMS SHOWN DASHED.

- 2. REMOVE ALL EXISTING CARPET THROUGHOUT SCOPE OF WORK, INCLUDING CARPET INSETS AT THE STAIR TREADS. PATCH & FILL HOLES OR DAMAGED AREAS AS REQUIRED.
- 3. REMOVE ALL EXISTING RUBBER BASE THROUGHOUT SCOPE OF WORK. AT EXISTING WALLS TO REMAIN, PATCH & REPAIR WOOD BASE TO MATCH EXISTING.
- 4. PATCH & REPAIR ANY DISTURBED CONSTRUCTION & FINISHES AT EXISTING SHELL CONSTRUCTION.

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REFERENCE NOTES

- 01 (E) SPECIALTY EQUIPMENT TO BE REMOVED.
- 02 EXISTING WALK OFF MAT TO REMAIN.
- 03 REMOVE EXISTING GLASS ENTRY DOORS & ASSOCIATED INFRASTRUCTURE/HARDWARE. PATCH/REPAINT WALLS AS NEEDED.

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1 04/30/2025 ASI 3

REVISIONS

DATE

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PROJECT NUMBER 20137549

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Code Compliance

Date:5/22/2025 Permit #: 25-037217-000-00-FA SHEET TITLE

LEVEL 09 - DEMO
FLOOR PLAN

D109

- 1. REMOVE ALL ITEMS SHOWN DASHED.
- 2. REMOVE & SALVAGE EXISTING CYLINDER FIXTURES THROUGHOUT CIRCULATION AREA FOR REUSE PER PLAN.

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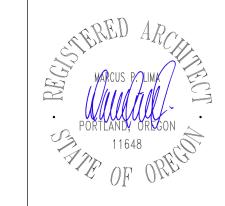
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REFERENCE NOTES

- 01 (E) GLASS DRAFT CURTAIN TO REMAIN
- 02 (E) MEDIUM PRESSURE DUCT TO REMAIN.

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REVISIONS

1 04/02/2025 ASI 2

DATE

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05.06.2025

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Date:5/22/2025 Permit #: 25-037217-000-00-FA SHEET TITLE

LEVEL 08 - DEMO
CEILING PLAN

D708

- 1. REMOVE ALL ITEMS SHOWN DASHED.
- REMOVE & SALVAGE EXISTING CYLINDER
 FIXTURES THROUGHOUT CIRCULATION AREA FOR
 REUSE PER PLAN.

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REFERENCE NOTES

- 01 (E) SPECIALTY EQUIPMENT TO BE REMOVED.
- 02 REMOVE & SALVAGE EXISTING SUSPENDED LINEAR FOR REUSE.
- 03 REMOVE & SALVAGE EXISTING SUSPENDED ACOUSTIC BAFFLES FOR REUSE.
- 04 (E) MEDIUM PRESSURE DUCT TO REMAIN.

PROJECT

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1 04/02/2025 ASI 2

DATE

PROJECT NUMBER

05.06.2025

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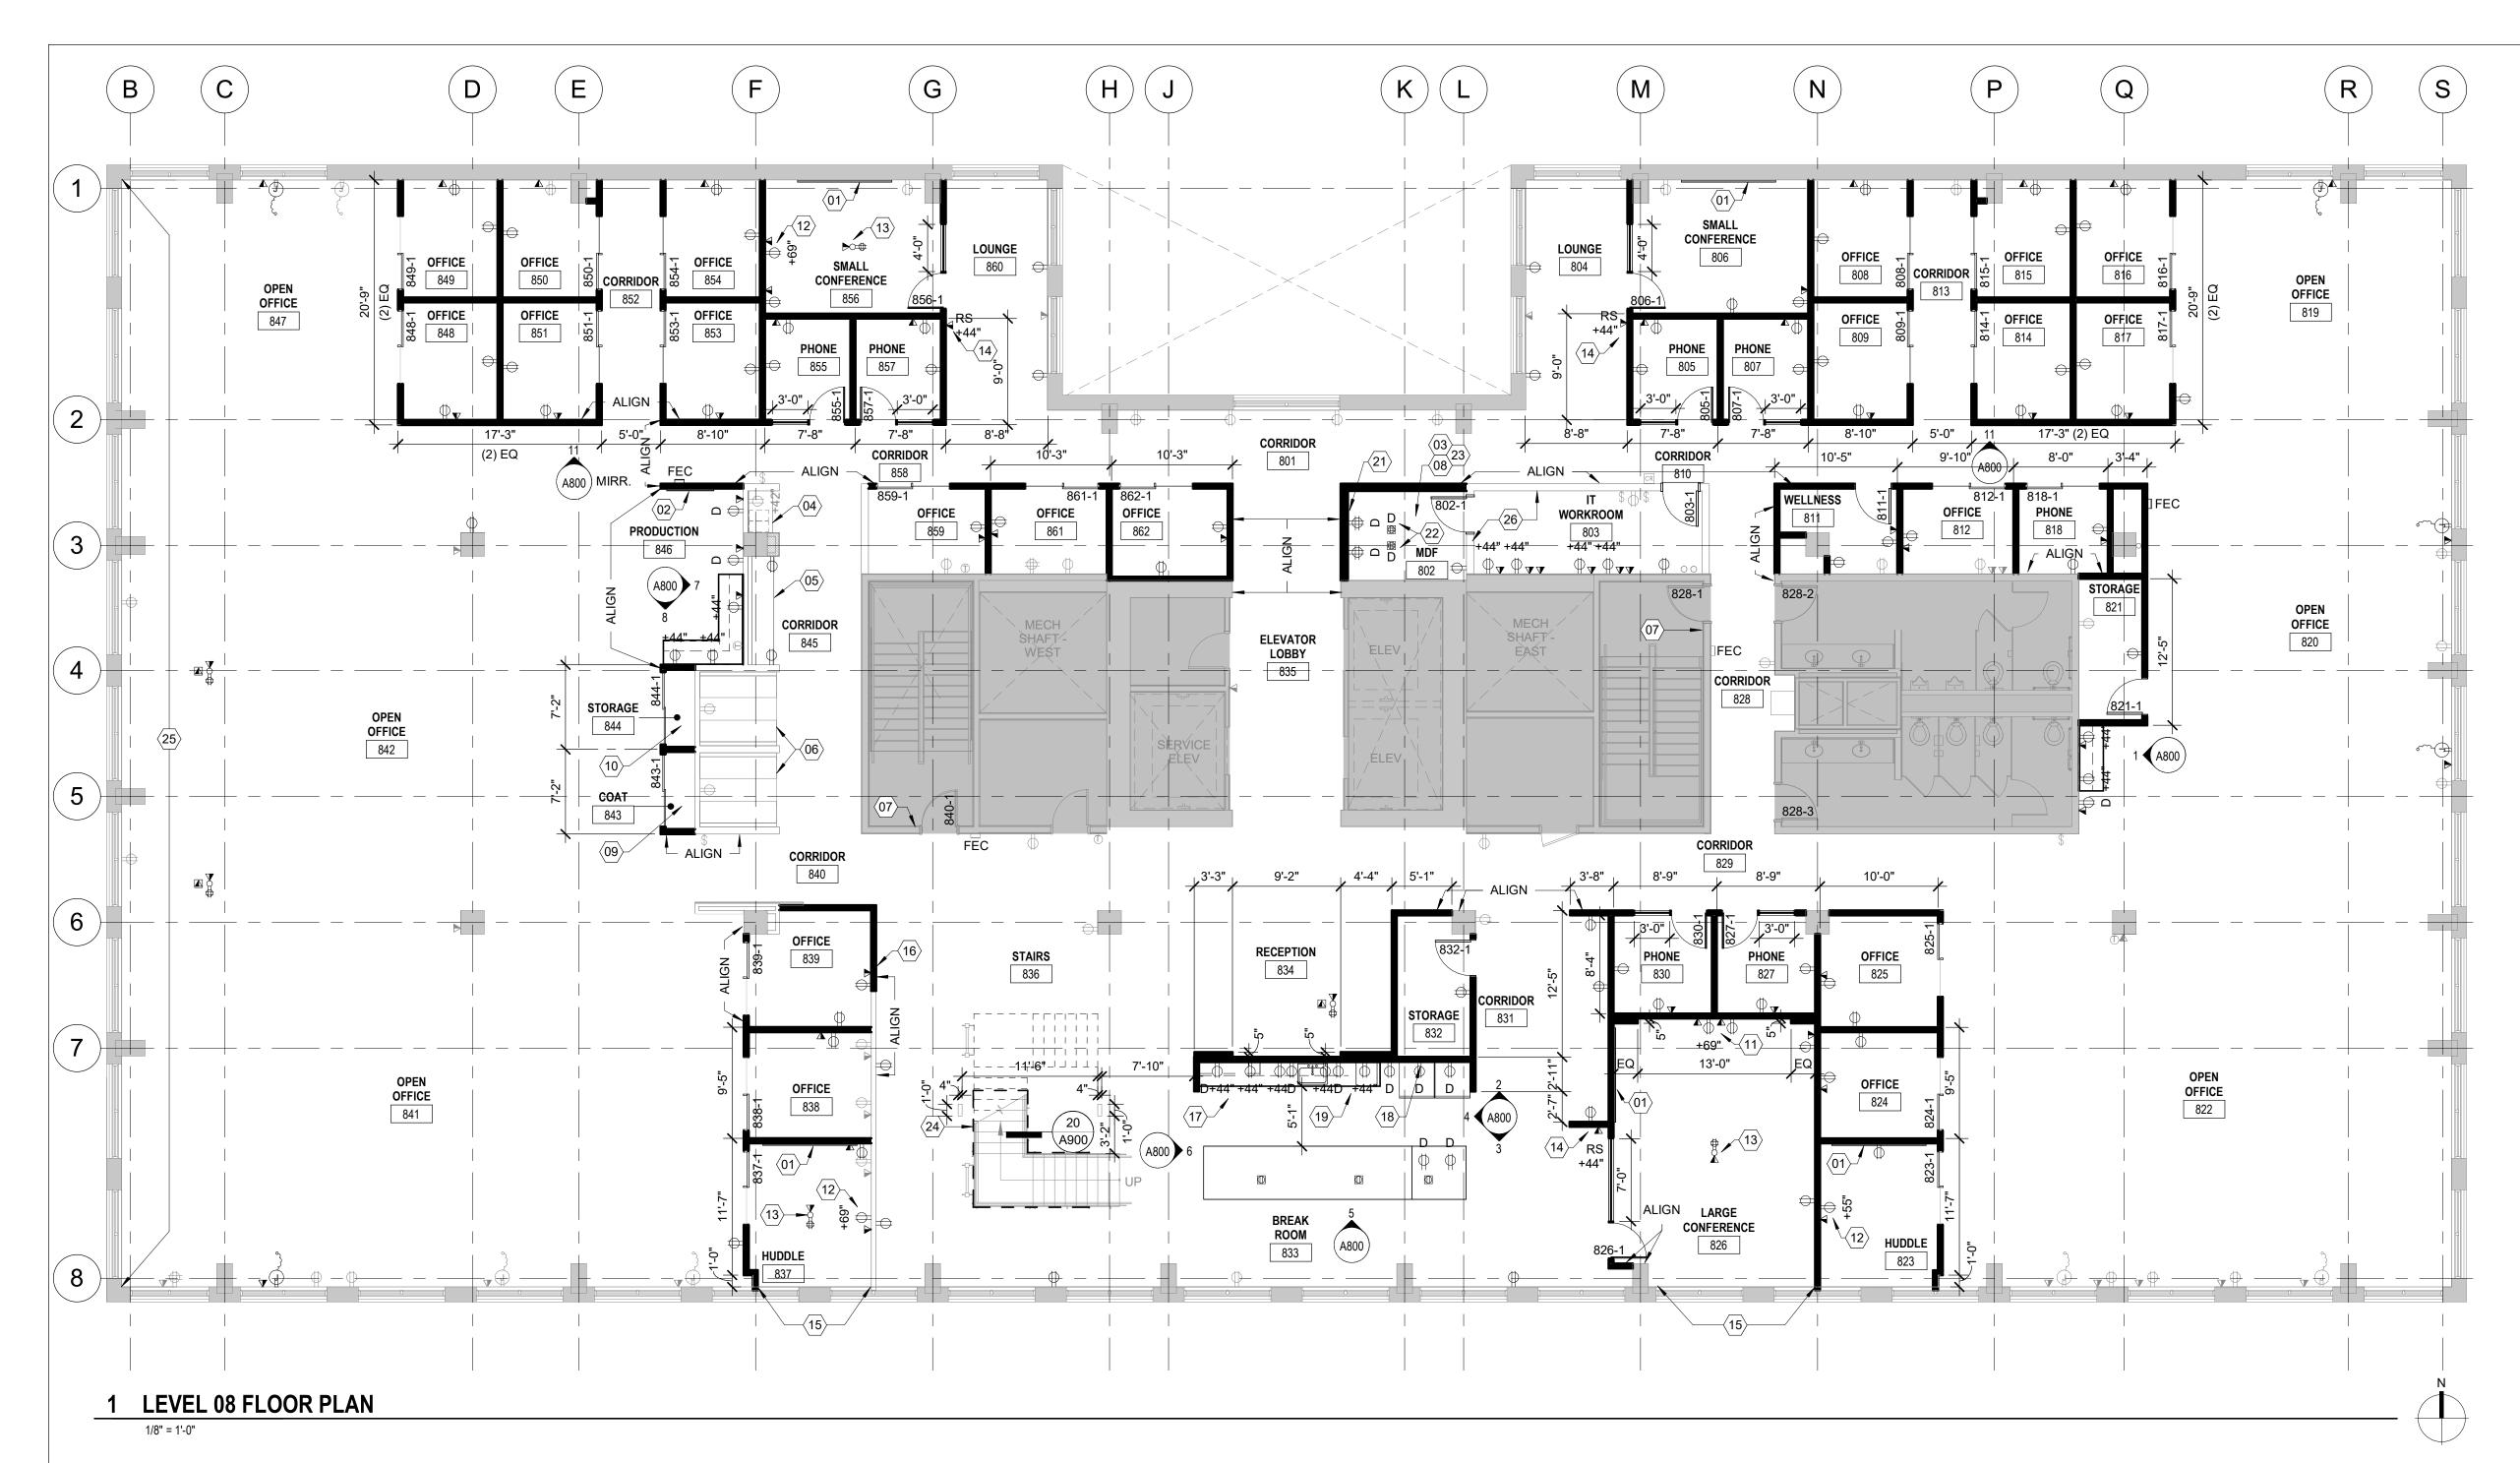
As indicated

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Date:5/22/2025 Permit #: 25-037217-000-00-FA SHEET TITLE

LEVEL 09 - DEMO
CEILING PLAN

D709



- 1. PROVIDE BLOCKING IN WALL FOR ALL WALL MOUNTED MILLWORK SUPPLIED & INSTALLED BY CONTRACTOR AND/OR TENANT.
- 2. PROVIDE NEW BUILDING STANDARD SHADES AT EXTERIOR WINDOWS AS NEEDED TO ACCOMMODATE NEW LAYOUT AND REPAIR DAMAGED SHADES. ALL NEW SHADES TO BE BUILDING STANDARD, CONFIRM WITH LL.
- 3. PROVIDE NEW ELECTRICAL, TELEPHONE & DATA OUTLETS AS INDICATED. ALL DEVICES TO BE
- 4. ANY NEW PENETRATIONS IN CONCRETE DEEPER THAN 3/4" MUST BE GPR SCANNED BEFORE DRILLING.
- 5. ABANDONED FLOOR CORES MUST BE FILLED IN TO LL SATISFACTION, CORES GREATER THAN 2" DIA. TO BE FILLED ACCORDING TO LL'S STRUCTURAL ENGINEER.
- 6. ALL ANGLE STOPS SHALL HAVE WATER SENSORS WITH AUTO SHUTOFF AND LOCAL ENUNCIATION.

- **#** REFERENCE NOTES
- 01 WHITEBOARD, OFOI.
- 02 TACK BOARD, OFOI.
- 03 CONFIRM SPECIALTY OUTLET REQUIREMENTS W/ TENANT IT. GC TO GROUND ONE OF THE QUAD OUTLETS IN THE ROOM.
- 04 EXISTING CASEWORK TO REMAIN. TOUCH UP CABINETRY / REPLACE OR REPAIR HARDWARE AS
- 05 EXISTING BOOTH TO REMAIN. CLEAN EXISTING UPHOLSTERY / REPAIR ANY DAMAGE.
- 06 EXISTING BOOTH TO REMAIN. REMOVE EXISTING UPHOLSTERY & INSTALL NEW UPHOLSTERY PROVIDED BY FURNITURE VENDOR.
- 07 EXISTING DOOR AND HARDWARE TO REMAIN. PROVIDE AND INSTALL NEW CARD READER AT STAIRWELL SIDE.
- 08 PROVIDE FIRE EXTINGUISHER USING DUPONT FE-36 EXTINGUISHING AGENT AT MDF ROOM.
- 09 PROVIDE CLOSET ROD / SHELF W/ 30% PORTION OF SHELF AT 34".

10 PROVIDE 18"D ADJUSTABLE MELAMINE SHELVING (5 SHELVES) ON HEAVY DUTY BRACKETS & STANDARDS. PLACE BRACKETS EVENLY ON BACK WALL & PROVIDE BACKING IN PARTITION AS

REQUIRED.

- 11 PROVIDE A/V BACK BOX CHIEF PAC525F. LOCATE FRAMING AS REQUIRED. PROVIDE BLOCKING AT INTERIOR PARTITION FOR TV MOUNT. PROVIDE POWER DUPLEX AT BOTTOM LEFT KNOCKOUT. PROVIDE (1) 1.25" CONDUIT STUBBED UP TO AN ACCESSIBLE LOCATION ABOVE THE FINISHED CEILING W/ MUD RING AT TOP LEFT KNOCKOUT & PULL-STRING FOR DATA VENDOR DATA. FROM TOP RIGHT KOCKOUT PROVIDE (1) 1.25" CONDUIT STUBBED UP TO AN ACCESSIBLE LOCATION ABOVE THE FINISHED CEILING W/ PULL-STRING FOR AV VENDOR. FROM BOTTOM RIGHT KNOCKOUT PROVIDE (1) 1.25" CONDUIT TO THE FLOORCORE LOCATION IN ROOM (IF APPLICABLE - OR LEAVE BLANK). NO HANDY BOXES TO BE USED, FULL JUNCTION BOXES ONLY. ADDITIONAL POWER AT STD RECEPTICAL HEIGHT TO BE CENTERED W/ TV BACKBOXES. CONFIRM EXACT LOCATION & HEIGHT PRIOR TO INSTALLATION.
- 12 PROVIDE A/V BACK BOX CHIEF PAC525F. LOCATE FRAMING AS REQUIRED. PROVIDE BLOCKING AT INTERIOR PARTITION FOR TV MOUNT. PROVIDE POWER DUPLEX OUTLET AT BOTTOM LEFT KNOCKOUT. PROVIDE JUNCTION BOX AT TOP LEFT KNOCKOUT W/ (1) 1.25" CONDUIT STUBBED UP TO AN ACCESSIBLE LOCATION ABOVE THE FINISHED CEILING W/ MUD RING AT TOP LEFT KNOCKOUT & PULL-STRING FOR DATA VENDOR DATA. FROM TOP RIGHT KNOCKOUT PROVIDE (1) 1.25" CONDUIT STUBBED UP TO AN ACCESSIBLE LOCATION ABOVE FINISHED CEILING W/ PULL-STRING FOR AV VENDOR. FROM BOTTOM RIGHT KNOCKOUT PROVIDE (1) 1.25" CONDUIT TO THE FLOORCORE LOCATION IN ROOM (IF APPLICABLE - OR LEAVE BLANK). NO HANDY BOXES TO BE USED. FULL JUNCTION BOXES ONLY. ADDITIONAL POWER AT STD RECEPTICAL HEIGHT TO BE CENTERED W/ TV BACK BOXES. CONFIRM EXACT LOCATION & HEIGHT PRIOR TO INSTALLATION.
- 13 PROVIDE FLUSH FLOOR ELECTRICAL, DATA & TELEPHONE FLOOR BOX. X-RAY & CORE DRILL SLAB AS REQUIRED. PROVIDE A DEVICE SIMILAR TO A 4" CORE W/ A WIREMOLD EVOLUTION 6ATCFF (INCLUDE SOFT & HARD CONNECTIONS). CONFIRM EXACT SPEC FOR THIS TYPE OF INSTALLATION W/ HDR PRIOR TO CONSTRUCTION. PROVIDE BLACK COVER W/ A BLACK FINISH FLANGE. PROVIDE A SEPARATE 1.25" CONDUIT FROM FLOOR BOX TO ABOVE CEILING W/ PULL STRING FOR TENANT PROVIDED DATA CABLING. DO NOT RUN POWER & DATA CONDUIT THROUGH TV BOXES. CONFIRM EXACT LOCATION W/ HDR PRIOR TO INSTALLATION.
- 14 NEW ROOM SCHEDULER (RS) / WALL PANEL LOCATION (NIC). PROVIDE 2-GANG BOX W/ CONDUIT STUB OUT ABOVE CEILING, W/ PULL STRING AT DRYWALL LOCATIONS. PROVIDE FRAMING TO ALLOW FOR 2-GANG BOX CENTERED BETWEEN ADJOINING WALLS & JOINING WALL. CONFIRM EXACT LOCATIONS PRIOR TO INSTALLATION. REFER TO PLAN FOR GLASS LOCATIONS THAT REQUIRE SIDELITE FRAMING PATHWAYS.
- 15 ALL EXTERIOR WINDOWS AT MEETING ROOMS TO RECEIVE MANUAL BLACKOUT MECHO SHADES WITH SURFACE MOUNTED CLEAR ALUMINUM HOUSING, LOCATED INTERIOR TO BUILDING STANDARD ROLLER-BLINDS (OR EQUAL).
- 16 PROVIDE BACKING FOR TENANT PROVIDED RAKKS SHELVING. CONFIRM LOCATION W/ TENANT PRIOR TO START OF CONSTRUCTION.
- 17 PROVIDE WATERLINE CONNECTIONS IN BASE CABINET W/ CORE DRILL IN CABINET FOR OWNER MACHINES.
- 18 WATERLINE TO BE STUBBED OUT W/ A CONTROL VALVE COPPER WATERLINE. GC TO MAKE ALL PLUMBING CONNECTIONS IF NOT EXISTING.
- 19 BEVI LOCATION (NIC). PROVIDE DEDICATED POWER & WATERLINE AS INDICATED W/ DEDICATED POWER

- 21 PROVIDE 3/4" CDX 5 PLY FIRE RATED PLYWOOD TO ENTIRE BACK WALL BEHIND RACK NON-PAINTED. REFER TO SERVER ROOM PLAN. ON BOARD, PROVIDE GROUND BUS W/#6 STRANDED COPPER WIRE TO ISOLATED BUILDING GROUND. LOCATE NEAR TOP OF MOUNTING BOARD. TAGS TO BE LEFT UNPAINTED.
- 22 NEW NOTE FOR MDF/IDFSGC TO PROVIDE HARDWIRED AND DEDICATED 20 AMP CIRCUIT IN 3/4" CONDUIT FOR TENANT PROVIDED SECURITY SYSTEM PANEL MOUNTED ON GC PROVIDED PLYWOOD. IF THERE IS NOT A DEDICATED CIRCUIT AVAILABLE, THEN THE EXISTING CIRCUIT USED MUST ALSO BE 20 AMP MINIMUM.
- 23 PROVIDE BUILDING STANDARD AIRFLOW TO ROOM. DO NOT LOCATE WATER CONNECTIONS ABOVE SERVER EQUIPMENT. ROOM TO HAVE HIGH TEMPERATURE SPRINKLER HEADS. PROVIDE THERMOSTAT IN SERVER ROOM TO MAINTAIN BUILDING SET POINT. PROVIDE EXHAUST FAN THAT IS HARDWIRED TO A T-STAT SET TO PULL AIR OUT AT 80 DEGREES. FAN TO BE LOCATED IN CEILING BEHIND SERVER RACK, 400CFM MINIMUM EXHAUST. PROVIDE LOUVER, PAINTED TO MATCH DOOR, IN SERVER ROOM DOOR.
- 24 DASHED LINE REPRESENTS LOCATION OF NEW CANE DETECTION RAIL BELOW EXISTING STAIR. VERIFY REQUIRED EXTENTS IN FIELD: REFERENCE VIEWS 20/A900 AND 11/G003.

- 25 ADD ALTERNATE: PROVIDE AND INSTALL AUTOMATIC MOTORIZED SHADES AT WEST EXPOSURE.
- 26 EXTEND INDICATED WALLS TO UNDERSIDE OF

PROJECT NUMBER

DATE

20137549

05.06.2025

GBD Architects

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Portland, OR 97209

Tel. (503) 224-9656

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STAMP

REC

PROJECT

CLIENT

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Portland, OR 97204

1455 NW Irving St, Suite 800

1050 SW 6th Ave, Suite 1800

Notice of Extended Payment Provision: The contract will allow the owner to make payment within 30 days after the date a billing or estimate is

submitted. Notice of Alternate

Billing Cycle: The contract will

allow the owner to require the

follows: Each calendar month ending on the last day of the

submission of billings or

applicable month. REVISIONS

2 04/30/2025 ASI 3

1 03/26/2025 ASI 1

estimates in billing cycles other than 30-day cycles. Billings or estimates for the contract shall be submitted as

Incorporated

Ste. 300

SCALE

As indicated

City of Portland Reviewed for Code Compliance

Date:5/22/2025 Permit #: 25-037217-000-00-FA SHEET TITLE LEVEL 08 - FLOOR PLAN

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PROJECT

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1455 NW Irving St, Suite 800 Portland, OR 97209

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HDR

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Notice of Extended Payment Provision: The contract will allow the owner to make payment within 30 days after the date a billing or estimate is submitted. Notice of Alternate Billing Cycle: The contract will allow the owner to require the submission of billings or estimates in billing cycles other than 30-day cycles. Billings or estimates for the contract shall be submitted as follows: Each calendar month ending on the last day of the applicable month.

REVISIONS

1 04/30/2025 ASI 3

DATE

05.06.2025

PROJECT NUMBER

SCALE

20137549

1/8" = 1'-0"


SHEET TITLE

City of Portland
Reviewed for

Code Compliance

Date:5/22/2025
Permit #: 25-037217-000-00-FA

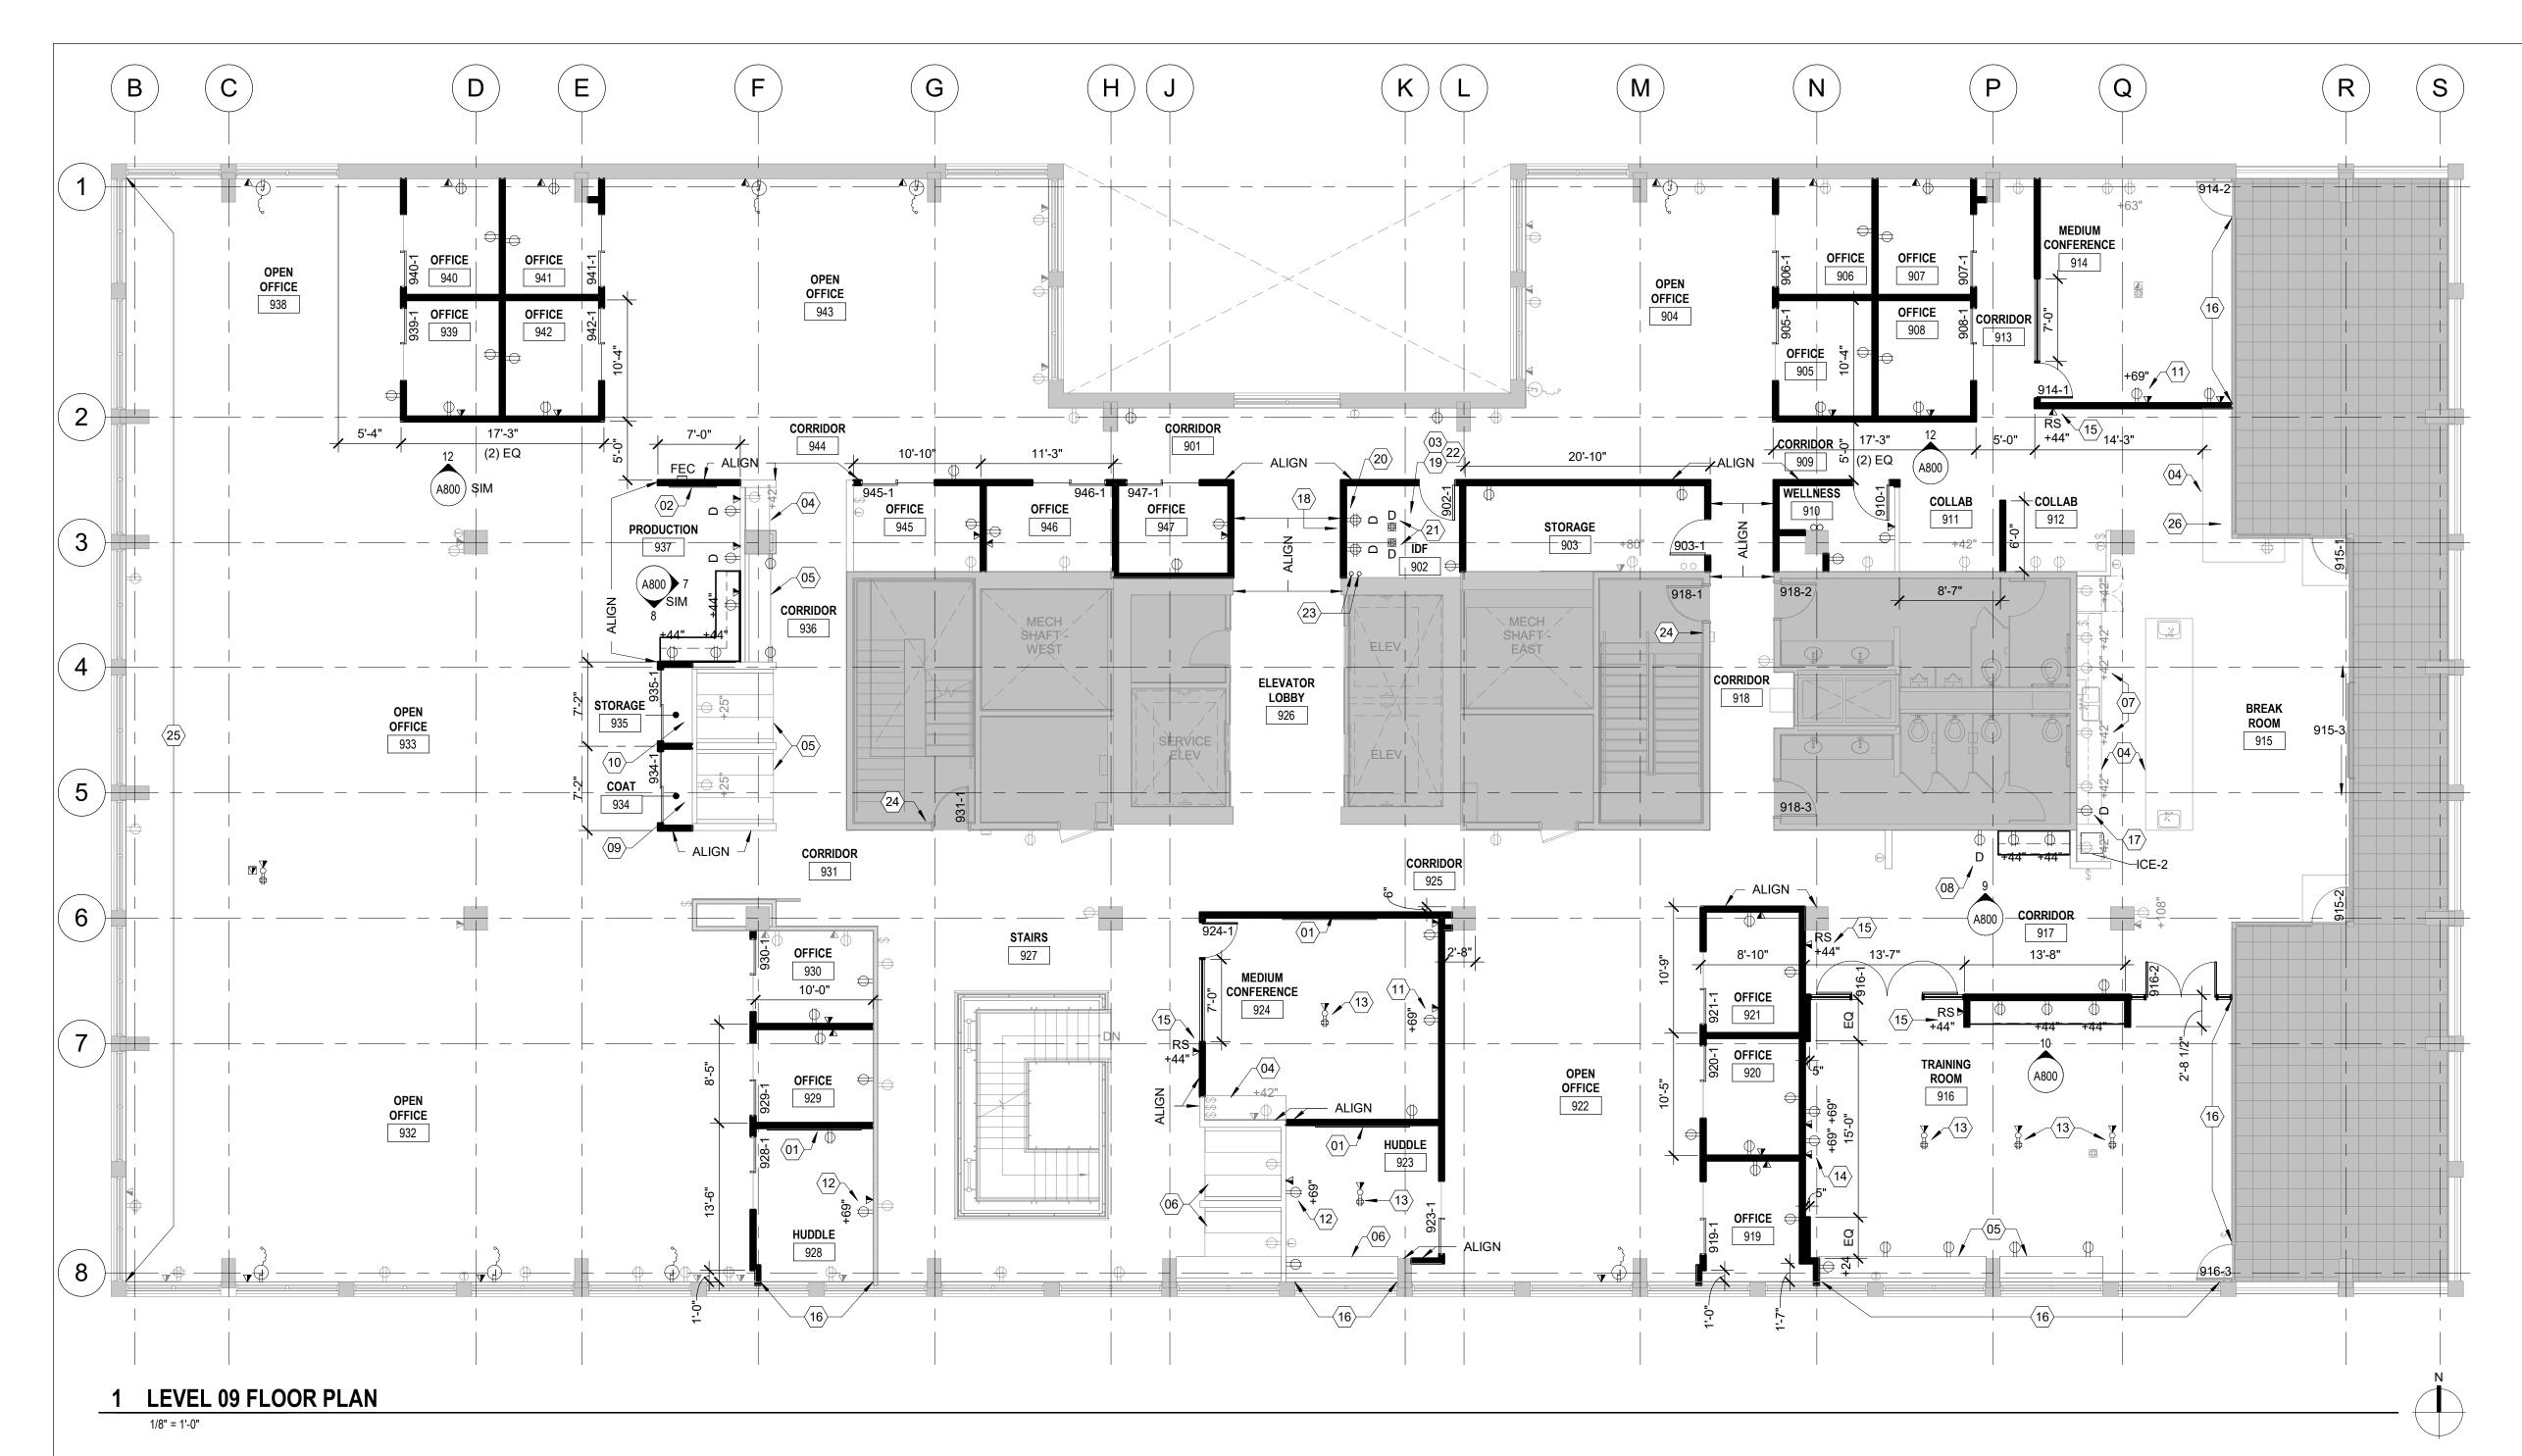LEVEL 08 - FINISH PLAN



1. PROVIDE BLOCKING IN WALL FOR ALL WALL MOUNTED MILLWORK SUPPLIED & INSTALLED BY CONTRACTOR AND/OR TENANT.

- 2. PROVIDE NEW BUILDING STANDARD SHADES AT EXTERIOR WINDOWS AS NEEDED TO ACCOMMODATE NEW LAYOUT AND REPAIR DAMAGED SHADES. ALL NEW SHADES TO BE BUILDING STANDARD, CONFIRM WITH LL.
- 3. PROVIDE NEW ELECTRICAL, TELEPHONE & DATA OUTLETS AS INDICATED. ALL DEVICES TO BE WHITE
- 4. ANY NEW PENETRATIONS IN CONCRETE DEEPER THAN 3/4" MUST BE GPR SCANNED BEFORE DRILLING.
- 5. ABANDONED FLOOR CORES MUST BE FILLED IN TO LL SATISFACTION, CORES GREATER THAN 2" DIA. TO BE FILLED ACCORDING TO LL'S STRUCTURAL ENGINEER.
- 6. ALL ANGLE STOPS SHALL HAVE WATER SENSORS WITH AUTO SHUTOFF AND LOCAL ENUNCIATION.

REFERENCE NOTES

- 01 WHITEBOARD, OFOI.
- 02 TACK BOARD, OFOI.
- 03 CONFIRM SPECIALTY OUTLET REQUIREMENTS W/ TENANT IT. GC TO GROUND ONE OF THE QUAD OUTLETS IN THE ROOM.
- 04 EXISTING CASEWORK TO REMAIN. TOUCH UP CABINETRY / REPLACE OR REPAIR HARDWARE AS NEEDED.
- 05 EXISTING BOOTH TO REMAIN. CLEAN EXISTING UPHOLSTERY / REPAIR ANY DAMAGE.
- 06 EXISTING BOOTH TO REMAIN. REMOVE EXISTING UPHOLSTERY & INSTALL NEW UPHOLSTERY PROVIDED BY FURNITURE VENDOR.
- 07 GC TO PROVIDE NEW ADA HEIGHT GE S.S.
 DISHWASHER #GDT225SSLSS (CONFIRM FINISH
 PRIOR TO ORDER).
- 08 COPIER LOCATION (N.I.C.). CONFIRM SPECIAL NEMA OUTLET REQUIREMENTS & CLEARANCES PRIOR TO CONSTRUCTION. PROVIDE DEDICATED OUTLET.
- 09 PROVIDE CLOSET ROD / SHELF W/ 30% PORTION OF SHELF AT 34".

- 10 PROVIDE 18"D ADJUSTABLE MELAMINE SHELVING (5 SHELVES) ON HEAVY DUTY BRACKETS & STANDARDS. PLACE BRACKETS EVENLY ON BACK WALL & PROVIDE BACKING IN PARTITION AS REQUIRED.
- 11 PROVIDE A/V BACK BOX CHIEF PAC525F. LOCATE FRAMING AS REQUIRED. PROVIDE BLOCKING AT INTERIOR PARTITION FOR TV MOUNT. PROVIDE POWER DUPLEX AT BOTTOM LEFT KNOCKOUT. PROVIDE (1) 1.25" CONDUIT STUBBED UP TO AN ACCESSIBLE LOCATION ABOVE THE FINISHED CEILING W/ MUD RING AT TOP LEFT KNOCKOUT & PULL-STRING FOR DATA VENDOR DATA. FROM TOP RIGHT KOCKOUT PROVIDE (1) 1.25" CONDUIT STUBBED UP TO AN ACCESSIBLE LOCATION ABOVE THE FINISHED CEILING W/ PULL-STRING FOR AV VENDOR. FROM BOTTOM RIGHT KNOCKOUT PROVIDE (1) 1.25" CONDUIT TO THE FLOORCORE LOCATION IN ROOM (IF APPLICABLE - OR LEAVE BLANK). NO HANDY BOXES TO BE USED, FULL JUNCTION BOXES ONLY. ADDITIONAL POWER AT STD RECEPTICAL HEIGHT TO BE CENTERED W/ TV BACKBOXES. CONFIRM EXACT LOCATION & HEIGHT PRIOR TO INSTALLATION.
- 12 PROVIDE A/V BACK BOX CHIEF PAC525F. LOCATE FRAMING AS REQUIRED. PROVIDE BLOCKING AT INTERIOR PARTITION FOR TV MOUNT. PROVIDE POWER DUPLEX OUTLET AT BOTTOM LEFT KNOCKOUT. PROVIDE JUNCTION BOX AT TOP LEFT KNOCKOUT W/ (1) 1.25" CONDUIT STUBBED UP TO AN ACCESSIBLE LOCATION ABOVE THE FINISHED CEILING W/ MUD RING AT TOP LEFT KNOCKOUT & PULL-STRING FOR DATA VENDOR DATA. FROM TOP RIGHT KNOCKOUT PROVIDE (1) 1.25" CONDUIT STUBBED UP TO AN ACCESSIBLE LOCATION ABOVE FINISHED CEILING W/ PULL-STRING FOR AV VENDOR. FROM BOTTOM RIGHT KNOCKOUT PROVIDE (1) 1.25" CONDUIT TO THE FLOORCORE LOCATION IN ROOM (IF APPLICABLE - OR LEAVE BLANK). NO HANDY BOXES TO BE USED. FULL JUNCTION BOXES ONLY. ADDITIONAL POWER AT STD RECEPTICAL HEIGHT TO BE CENTERED W/ TV BACK BOXES. CONFIRM EXACT LOCATION & HEIGHT PRIOR TO INSTALLATION.
- 13 PROVIDE FLUSH FLOOR ELECTRICAL, DATA & TELEPHONE FLOOR BOX. X-RAY & CORE DRILL SLAB AS REQUIRED. PROVIDE A DEVICE SIMILAR TO A 4" CORE W/ A WIREMOLD EVOLUTION 6ATCFF (INCLUDE SOFT & HARD CONNECTIONS). CONFIRM EXACT SPEC FOR THIS TYPE OF INSTALLATION W/ HDR PRIOR TO CONSTRUCTION. PROVIDE BLACK COVER W/ A BLACK FINISH FLANGE. PROVIDE A SEPARATE 1.25" CONDUIT FROM FLOOR BOX TO ABOVE CEILING W/ PULL STRING FOR TENANT PROVIDED DATA CABLING. DO NOT RUN POWER & DATA CONDUIT THROUGH TV BOXES. CONFIRM EXACT LOCATION W/ HDR PRIOR TO INSTALLATION.
- 14 PROVIDE DUAL WALLMATE RVP A/V BACK BOX. LOCATE FRAMING AS REQUIRED. PROVIDE **BLOCKING AT INTERIOR PARTITION FOR TV MOUNT** PROVIDE POWER DUPLEX OUTLET AT BOTTOM LEFT KNOCKOUT. PROVIDE JUNCTION BOX AT TOP LEFT KNOCKOUT W/ (Q) 1.25" CONDUIT STUBBED UP TO AN ACCESSIBLE LOCATION ABOVE FINISHED CEILING W/ PULL-STRING FOR DATA VENDOR. FROM TOP RIGHT KNOCKOUT PROVIDE (1) 1.25" CONDUIT STUBBED UP TO AN ACCESSIBLE LOCATION ABOVE FINISHED CEILING W/ PULL-STRING FOR AV VENDOR. FROM BOTTOM RIGHT KNOCKOUT PROVIDE (1) 1.25" CONDUIT TO CORE LOCATION IN ROOM (IF APPLICABLE - OR LEAVE BLANK). NO HANDY BOXES TO BE USE. FULL JUNCTION BOXES ONLY. ADDITIONAL POWER AT STD RECEPTICAL HEIGHT TO BE CENTERED W/ TV BACK BOXES. CONFIRM EXACT LOCATION & HEIGHT PRIOR TO INSTALLATION.
- 15 NEW ROOM SCHEDULER (RS) / WALL PANEL LOCATION (NIC). PROVIDE 2-GANG BOX W/ CONDUIT STUB OUT ABOVE CEILING, W/ PULL STRING AT DRYWALL LOCATIONS. PROVIDE FRAMING TO ALLOW FOR 2-GANG BOX CENTERED BETWEEN ADJOINING WALLS & JOINING WALL. CONFIRM EXACT LOCATIONS PRIOR TO INSTALLATION. REFER TO PLAN FOR GLASS LOCATIONS THAT REQUIRE SIDELITE FRAMING PATHWAYS.
- 16 ALL EXTERIOR WINDOWS AT MEETING ROOMS TO RECEIVE MANUAL BLACKOUT MECHO SHADES WITH SURFACE MOUNTED CLEAR ALUMINUM HOUSING, LOCATED INTERIOR TO BUILDING STANDARD ROLLER-BLINDS (OR EQUAL).

- 17 COFFEE & ICE/WATER LOCATION (NIC). PROVIDE DEDICATED POWER & WATERLINE AS INDICATED W/DEDICATED POWER SUPPLY (IF NOT EXISTING).
- 18 LOGO, OFCI.
- 19 PROVIDE FIRE EXTINGUISHER USING DUPONT FE-36 EXTINGUISHING AGENT AT MDF ROOM.
- 20 PROVIDE 3/4" CDX 5 PLY FIRE RATED PLYWOOD TO ENTIRE BACK WALL BEHIND RACK NON-PAINTED. REFER TO SERVER ROOM PLAN. ON BOARD, PROVIDE GROUND BUS W/#6 STRANDED COPPER WIRE TO ISOLATED BUILDING GROUND. LOCATE NEAR TOP OF MOUNTING BOARD. TAGS TO BE LEFT UNPAINTED.
- 21 NEW NOTE FOR MDF/IDFSGC TO PROVIDE HARDWIRED AND DEDICATED 20 AMP CIRCUIT IN 3/4" CONDUIT FOR TENANT PROVIDED SECURITY SYSTEM PANEL MOUNTED ON GC PROVIDED PLYWOOD. IF THERE IS NOT A DEDICATED CIRCUIT AVAILABLE, THEN THE EXISTING CIRCUIT USED MUST ALSO BE 20 AMP MINIMUM.
- 22 PROVIDE BUILDING STANDARD AIRFLOW TO ROOM.
 DO NOT LOCATE WATER CONNECTIONS ABOVE
 SERVER EQUIPMENT. ROOM TO HAVE HIGH
 TEMPERATURE SPRINKLER HEADS. PROVIDE
 THERMOSTAT IN SERVER ROOM TO MAINTAIN
 BUILDING SET POINT. PROVIDE EXHAUST FAN THAT
 IS HARDWIRED TO A T-STAT SET TO PULL AIR OUT AT
 80 DEGREES. FAN TO BE LOCATED IN CEILING
 BEHIND SERVER RACK, 400CFM MINIMUM EXHAUST.
 PROVIDE LOUVER, PAINTED TO MATCH DOOR, IN
 SERVER ROOM DOOR.
- 23 PROVIDE (2) CUTS IN FLOOR FOR 4" POWER/DATA SLEEVE. CONTRACTOR TO SCAN SLAB BEFORE DRILLING, AND MAINTAIN EXISTING FIRE RATING OF FLOOR ASSEMBLY.
- 24 EXISTING DOOR AND HARDWARE TO REMAIN. PROVIDE AND INSTALL NEW CARD READER AT STAIRWELL SIDE.
- 25 ADD ALTERNATE: PROVIDE ADITURA TO TURA MOTORIZED SHADES AT WEST EXPOSURE.

Reviewed for

26 LOCATION OF OFOI CB-1. PROVIDE GROMMET IN
COUNTER FOR POWER CORP. OR COMPILIANCE

Date:5/22/2025 Permit #: 25-037217-000-00-FA GBD

GBD Architects Incorporated

1120 NW Couch St. Ste. 300 Portland, OR 97209

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PROJECT

HDR Pearl West

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CLIENT

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2 04/30/2025 ASI 3

1 03/26/2025 ASI 1

DATE 05.06.2025

PROJECT NUMBER

20137549

SCALE

As indicated

SHEET TITLE

LEVEL 09 - FLOOR

Δ109

ERMIT SET

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STAMP

ESTERED.

REFERENCE NOTES

01 EXISTING WALK OFF MAT TO REMAIN.

PROJECT

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20137549

SCALE

1/8" = 1'-0"

SHEET TITLE

City of Portland Reviewed for Code Compliance

Date:5/22/2025 Permit #: 25-037217-000-00-FA

LEVEL 09 - FINISH PLAN

EQ

, EQ

CORRIDOR

813

EQ EQ

GENERAL NOTES

- 1. ALL DIMENSIONS ARE TO FINISH FACE OF WALL,
- 2. ALL LIGHT FIXTURE DIMENSIONS ARE TO CENTERLINE OF FIXTURE.
- 3. ALL CEILING HEIGHTS ARE MEASURED FROM STRUCTURAL FLOOR LEVEL TO FINISH CEILING,
- 4. ALL NEW CEILINGS TO BE AT 9'-0" AFF UNO.
- 5. WHEN A SINGLE LIGHT FIXTURE IN A ROOM IS NOT DIMENSIONED, CENTER THE FIXTURE IN THE ROOM.
- 6. ALL CIRCULAR FIXTURES LOCATED IN NEW ACT CEILING GRIDS TO BE CENTERED WITHIN THE CEILING TILE.
- 7. PROVIDE NEW DIMMER SWITCHING W/ NEW LIGHTING LAYOUT.
- 8. PROVIDE OCCUPANCY SENSOR SWITCHING AT ALL NEW / EXISTING OFFICES, CONFERENCE ROOMS, PRODUCTION / COPY AREAS, & HUDDLE ROOMS. ALL SWITCHES TO BE WHITE. ADJUST ANY EXISTING SENSORS AS NEEDED FOR NEW LAYOUT & CEILING GRIDS.
- 9. REPAIR OR REPLACE ANY INOPERABLE LIGHT FIXTURES TO REMAIN.

REFERENCE NOTES

16'-0"

- 01 (E) GLASS DRAFT CURTAIN TO REMAIN
- 02 FIXTURE TO BE INSTALLED ON SEPARATE DIMMER SWITCH.
- 03 EXISTING DRYWALL/HARDLID CEILING TO REMAIN.
 EXISTING LIGHTING TO REMAIN, REPLACE BULBS AS
 NEEDED. CIRCUIT TOGETHER ON A DIMMER SWITCH
 IF NOT EXISTING.
- 04 PROVIDE SWITCH FOR UNDER CABINET LIGHTING.
- 05 POWER/DATA SLEEVES FROM FLOOR ABOVE.

LUMINAIRE SCHEDULE

- L1 TO MATCH EXISTING CYLIDRICAL FIXTURES IN CIRCULATION AREA; GOTHAM 6" EVO CYLINDER
- L2 MANUFACTURER: TBD, PRODUCT: RECESSED CAN LIGHT
- L3 EXISTING SUSPENDED LINEAR TO BE SALVAGED AND REUSED.
- L4-A MANUFACTURER: FINELITE, PRODUCT: HP-6 RECESSED LINEAR, 6'L
- L4-B MANUFACTURER FINELITE, PRODUCT: HP-6 RECESSED LINEAR, 8'L
- L5-A MANUFACTURER: FINELITE, PRODUCT: HP-4
- RECESSED LINEAR, 4'L

 L5-B MANUFACTURER: FINELITE, PRODUCT: HP-4
- L5-C MANUFACTURER: FINELITE, PRODUCT: HP-4

RECESSED LINEAR, 6'L

- RECESSED LINEAR, 8'L
- L6-A MANUFACTURER: FINELITE, PRODUCT: HP-4 RECESSED LINEAR WALL WASHER, 6'L
- L6-B MANUFACTURER: FINELITE, PRODUCT: HP-4 RECESSED LINEAR WALL WASHER, 8'L
- MANUFACTURER: VISO LIGHTING, PRODUCT: GLOBO PENDANT #VSO731454, MATTE BLACK CANOPY, 12"DIA, LENGTH AS INDICATED IN DRAWINGS City of Portland
- L8 MANUFACTURER: KUZCO LIGHTING. PRODUCT: MOTIF LED MINI PRIDONA #KUZZO 19942, BLACK, 3000K, 26"H PENDANT, LENGTH AS INDICATED IN DRAWINGS CODE COMPLIANCE
- L9 MANUFACTURER: BOYER: BRODUCT: CIRCULAR LED CHANDELIER, WHITE, OUTWARD LIGHT DIRECTION, 2700K, 47"DIAPLENGTHAS INDICATED IN THAT WINGS
- L10 LOW PROFILE LED UNDER CABINET LIGHTING

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PROJECT

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CLIENT

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2 04/30/2025 ASI 3

1 04/02/2025 ASI 2

DATE

05.06.2025

PROJECT NUMBER

20137549

As indicated

SCALE

SHEET TITLE

LEVEL 08 - RCP

LEVEL 08 - RC

A708

LEVEL 08 RCP

1/8" = 1'-0"

16'-0"

- 1. ALL DIMENSIONS ARE TO FINISH FACE OF WALL
- 2. ALL LIGHT FIXTURE DIMENSIONS ARE TO CENTERLINE OF FIXTURE.
- 3. ALL CEILING HEIGHTS ARE MEASURED FROM STRUCTURAL FLOOR LEVEL TO FINISH CEILING,
- 4. ALL NEW CEILINGS TO BE AT 9'-0" AFF UNO.
- 5. WHEN A SINGLE LIGHT FIXTURE IN A ROOM IS NOT DIMENSIONED, CENTER THE FIXTURE IN THE ROOM.
- ALL CIRCULAR FIXTURES LOCATED IN NEW ACT CEILING GRIDS TO BE CENTERED WITHIN THE CEILING TILE.
- 7. PROVIDE NEW DIMMER SWITCHING W/ NEW LIGHTING LAYOUT.
- 8. PROVIDE OCCUPANCY SENSOR SWITCHING AT ALL NEW / EXISTING OFFICES, CONFERENCE ROOMS, PRODUCTION / COPY AREAS, & HUDDLE ROOMS. ALL SWITCHES TO BE WHITE. ADJUST ANY EXISTING SENSORS AS NEEDED FOR NEW LAYOUT & CEILING GRIDS.
- 9. REPAIR OR REPLACE ANY INOPERABLE LIGHT FIXTURES TO REMAIN.

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REFERENCE NOTES

- 01 NEW FIXTURES TO BE INSTALLED IN PREVIOUS FIXTURE LOCATIONS AT VARYING DROP LENGTHS PER DRAWINGS.
- 02 FIXTURES TO BE CIRCUITED TOGETHER AND INSTALLED ON DIMMER SWITCH.
- 03 FIXTURE TO BE INSTALLED ON SEPARATE DIMMER SWITCH.
- 04 EXISTING FULL ROWS OF ACOUSTIC BAFFLES TO REMAIN. GC TO ADJUST ACOUSTIC BAFFLES IN OTHER ROWS TO MATCH, ADDING SALVAGED BAFFLES WHERE NEEDED.
- 05 EXISTING DRYWALL/HARDLID CEILING TO REMAIN. EXISTING LIGHTING TO REMAIN, REPLACE BULBS AS NEEDED. CIRCUIT TOGETHER ON A DIMMER SWITCH IF NOT EXISTING.
- 06 PROVIDE SWITCH FOR UNDER CABINET LIGHTING.
- 07 PROVIDE ACOUSTIC BAFFLES, SALVAGED FROM EXISTING LAYOUT.

LUMINAIRE SCHEDULE

- L1 TO MATCH EXISTING CYLIDRICAL FIXTURES IN CIRCULATION AREA; GOTHAM 6" EVO CYLINDER
- L2 MANUFACTURER: TBD, PRODUCT: RECESSED CAN LIGHT
- L3 EXISTING SUSPENDED LINEAR TO BE SALVAGED AND REUSED.
- L4-A MANUFACTURER: FINELITE, PRODUCT: HP-6 RECESSED LINEAR, 6'L
- L4-B MANUFACTURER FINELITE, PRODUCT: HP-6

L5-A MANUFACTURER: FINELITE, PRODUCT: HP-4

L5-B MANUFACTURER: FINELITE, PRODUCT: HP-4

- RECESSED LINEAR, 8'L
- RECESSED LINEAR, 4'L
- L5-C MANUFACTURER: FINELITE, PRODUCT: HP-4

RECESSED LINEAR, 6'L

- RECESSED LINEAR, 8'L
- L6-A MANUFACTURER: FINELITE, PRODUCT: HP-4 RECESSED LINEAR WALL WASHER, 6'L
- L6-B MANUFACTURER: FINELITE, PRODUCT: HP-4 RECESSED LINEAR WALL WASHER, 8'L
- MANUFACTURER: VISO LIGHTING, PRODUCT: GLOBO PENDANT #VSO731454, MATTE BLACK CANOPY, 12"DIA, LENGTH AS INDICATED IN DRAWINGS
- L8 MANUFACTURER: KUZCO LIGHTING. PRODUCT:
 MOTIF LED MINI PRODUCT: MOTIF LED MINI PRODUCT: MOTIF LED MINI PRODUCT: MOTIF LED MINI PRODUCT: MOTIF LED MINI PRODUCT: MOTIF LED MINI PRODUCT: MOTIF AS INDICATED IN DRAWINGS Code Compliance
- L9 MANUFACTURER: BOYER, BRODUCT: CIRCULAR LED CHANDELIER, WHITE, OUTWARD LIGHT DIRECTION, 2700K, 47"DIAPLENGTHAS WOIGATED IN THAT WOIGATED IN THE WINGS
- L10 LOW PROFILE LED UNDER CABINET LIGHTING

PROJECT

HDR Pearl West

1455 NW Irving St, Suite 800 Portland, OR 97209

CLIENT

HDR

1050 SW 6th Ave, Suite 1800 Portland, OR 97204

Notice of Extended Payment Provision: The contract will allow the owner to make payment within 30 days after the date a billing or estimate is submitted. Notice of Alternate Billing Cycle: The contract will allow the owner to require the submission of billings or estimates in billing cycles other than 30-day cycles. Billings or estimates for the contract shall be submitted as follows: Each calendar month ending on the last day of the applicable month. REVISIONS

1 04/02/2025 ASI 2

DATE

05.06.2025

PROJECT NUMBER

20137549

SCALE

As indicated

SHEET TITLE


LEVEL 09 - RCP

Δ700

Alus

LEVEL 09 RCP

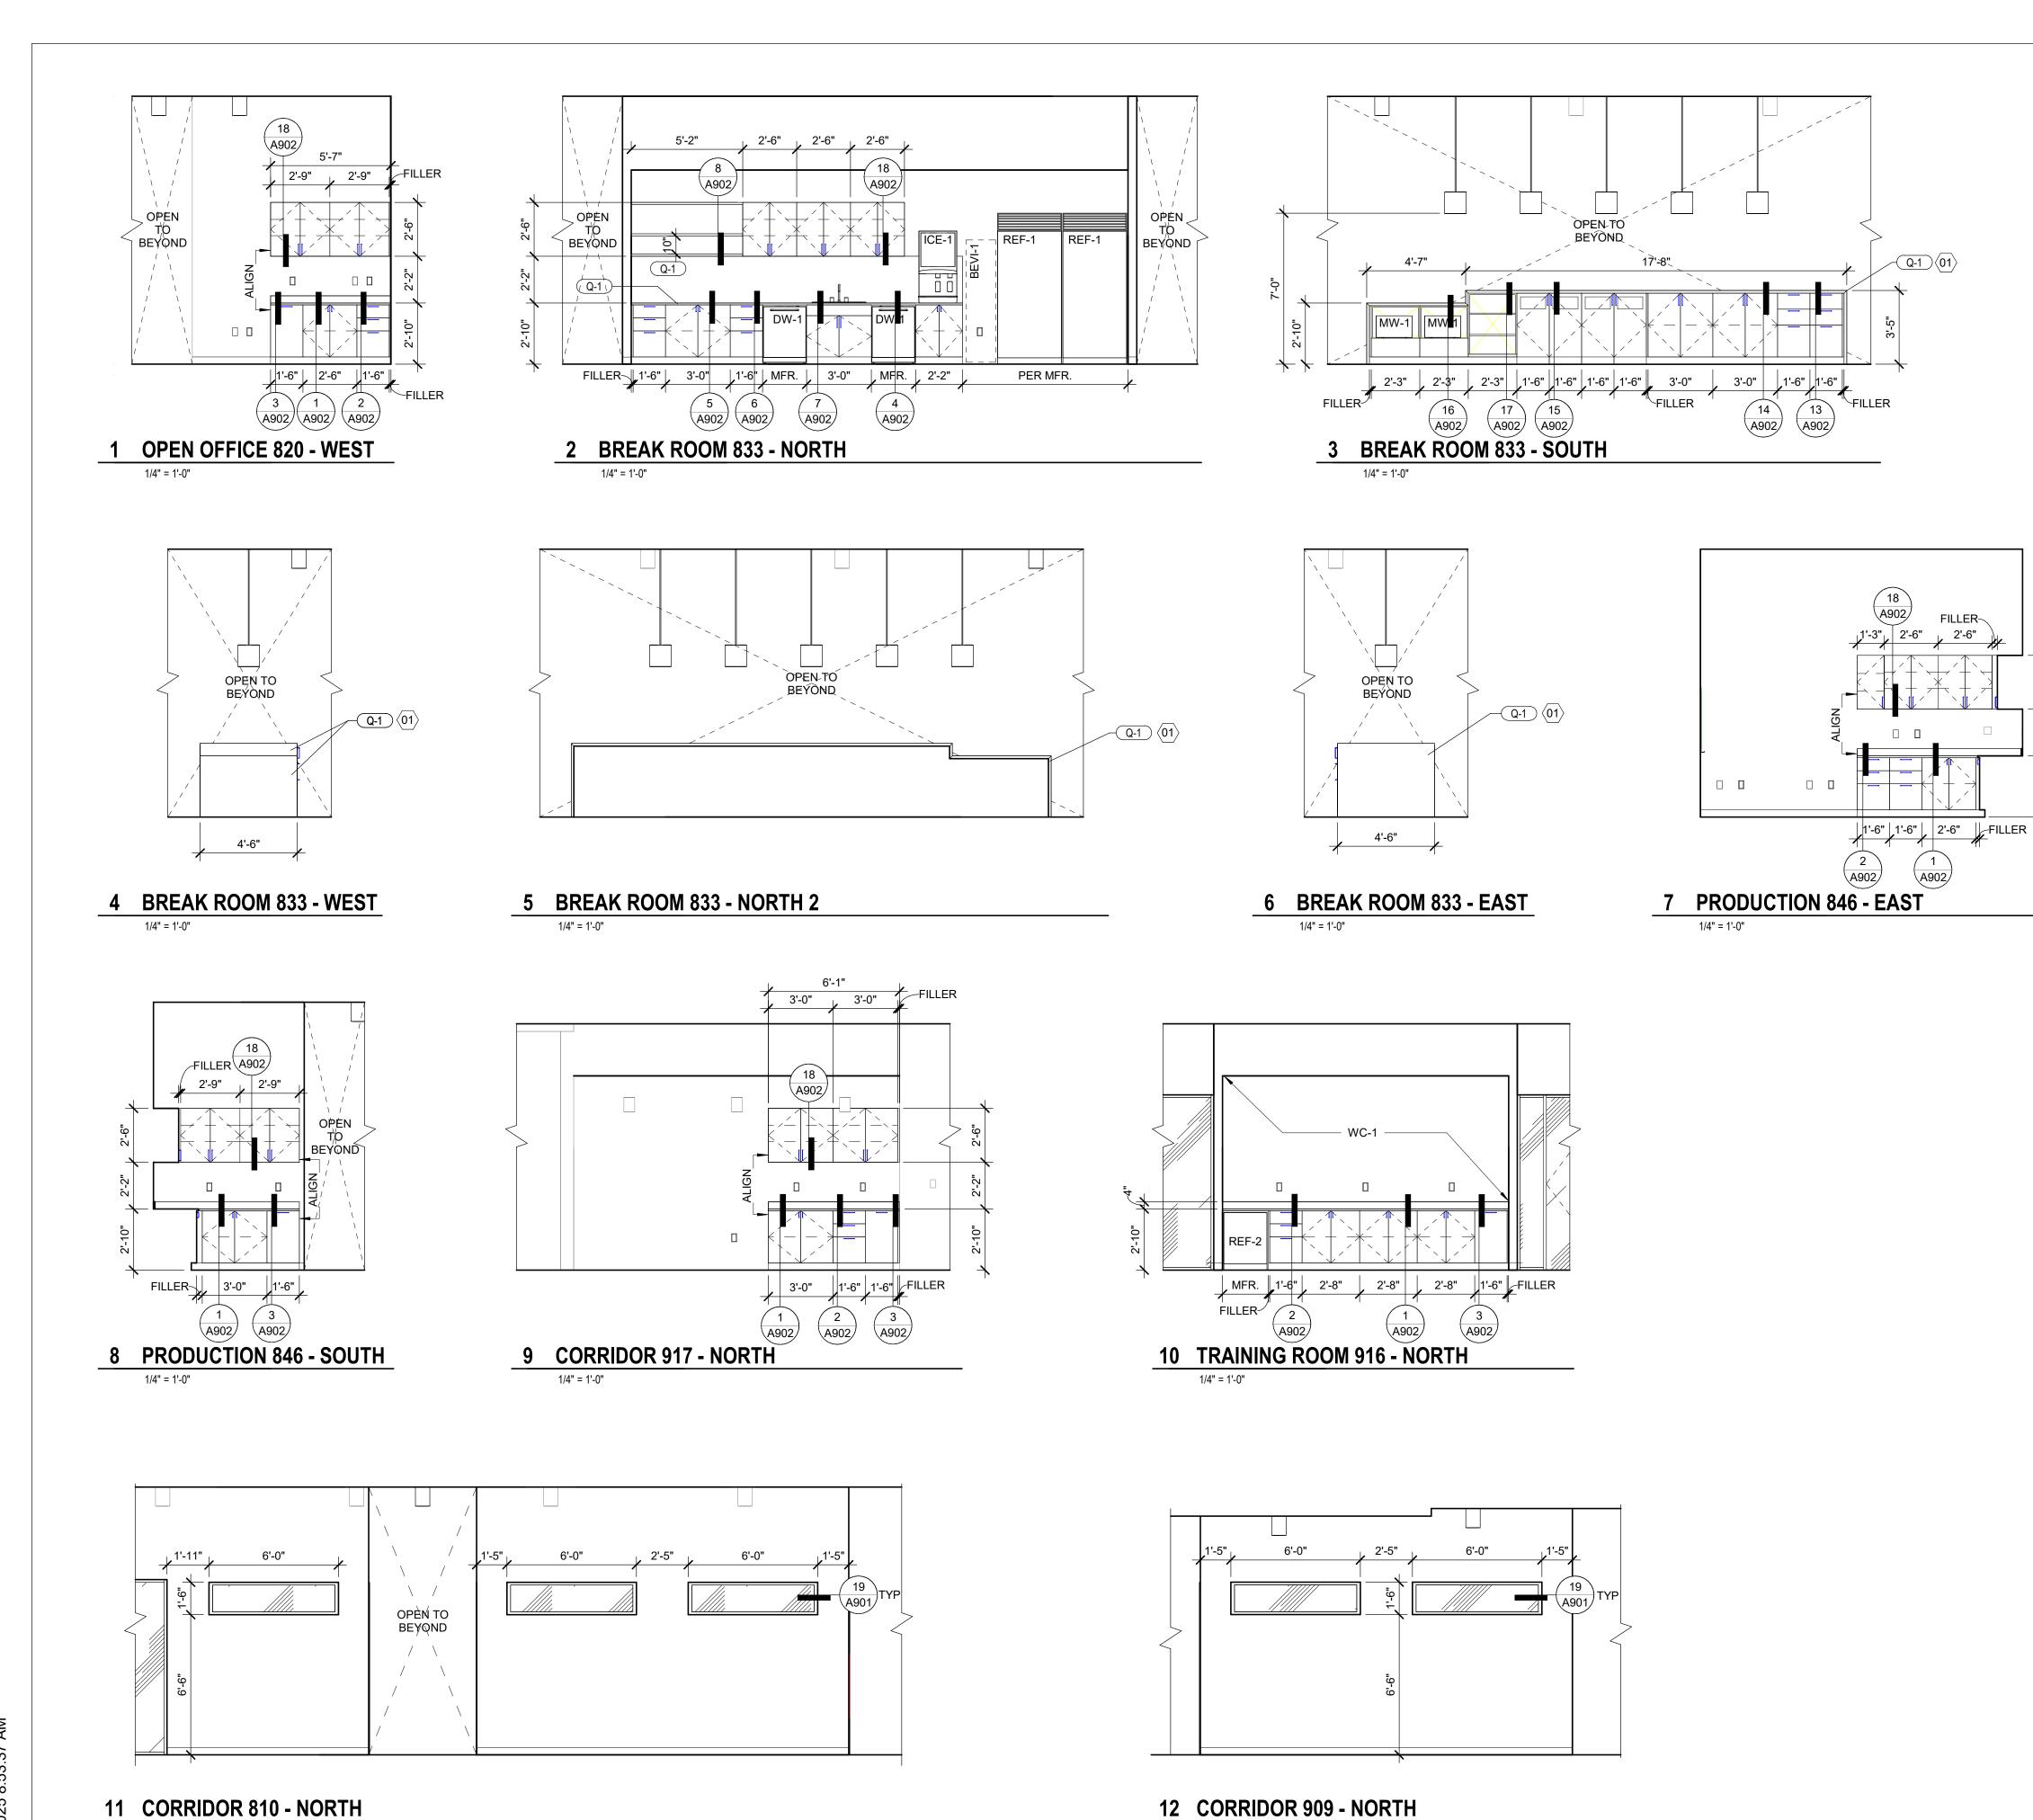1/8" = 1'-0"



REFERENCE NOTES

FILLER-

01 WATERFALL EDGE COUNTER, 1-1/2" EDGE THICKNESS W/ MITERED CORNERS.

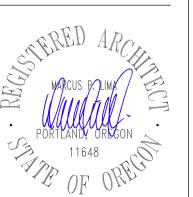
GBD Architects, Incorporated

1120 NW Couch St. Ste. 300 Portland, OR 97209

Tel. (503) 224-9656

gbdarchitects.com

GBD © 2025 STAMP



PROJECT

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2 04/30/2025 ASI 3 1 03/26/2025 ASI 1

PROJECT NUMBER

05.06.2025

20137549

SCALE

1/4" = 1'-0"

City of Portland Reviewed for Code Compliance

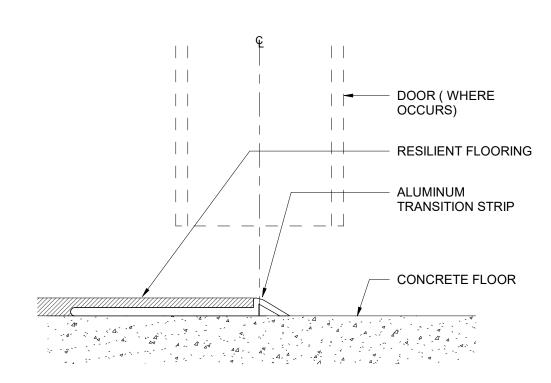
Date:5/22/2025 Permit #: 25-037217-000-00-FA SHEET TITLE INTERIOR ELEVATIONS

A800

1/4" = 1'-0"

17 TRANSITION - CARPET TO CONCRETE

12" = 1'-0"




18 TRANSITION - RF TO CONCRETE

12" = 1'-0"


-METAL FRAMING- ALIGN WITH WALL FRAMING BEYOND -GYPSUM BOARD SEE RCP -SUSPENDED ACOUSTICAL CEILING

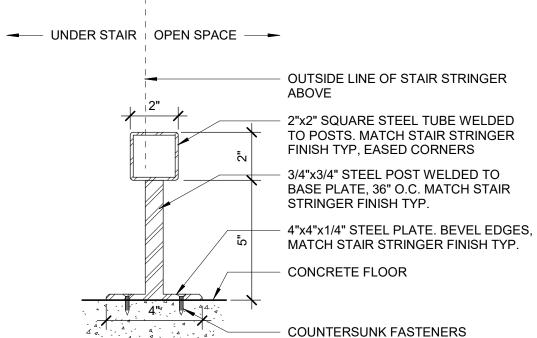19 TYP CEILING TRANSITION



-CORNER BEAD

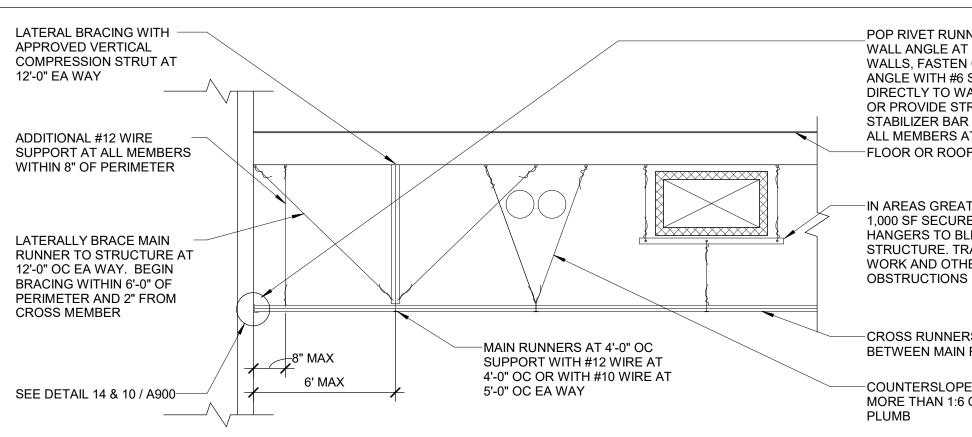20 STAIR CANE DETECTION DETAIL



BERC 2

TYPICAL

SECTION

TYPICAL HORIZONTAL

SECTION

TYPICAL

SECTION

HEAD

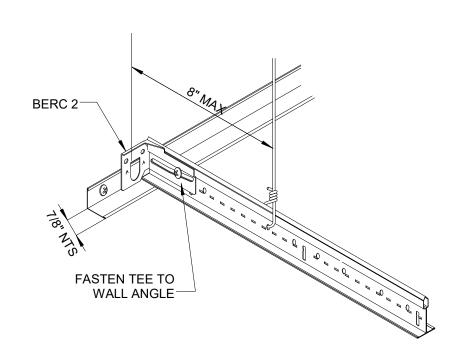
FASTEN TEE TO

BERC CLIP ONLY-


10 CEILING EDGE - UNATTACHED

13 LATERAL BRACING FOR SUSPENDED CEILING SYSTEM

1/2" = 1'-0"



14 CEILING EDGE - ATTACHED

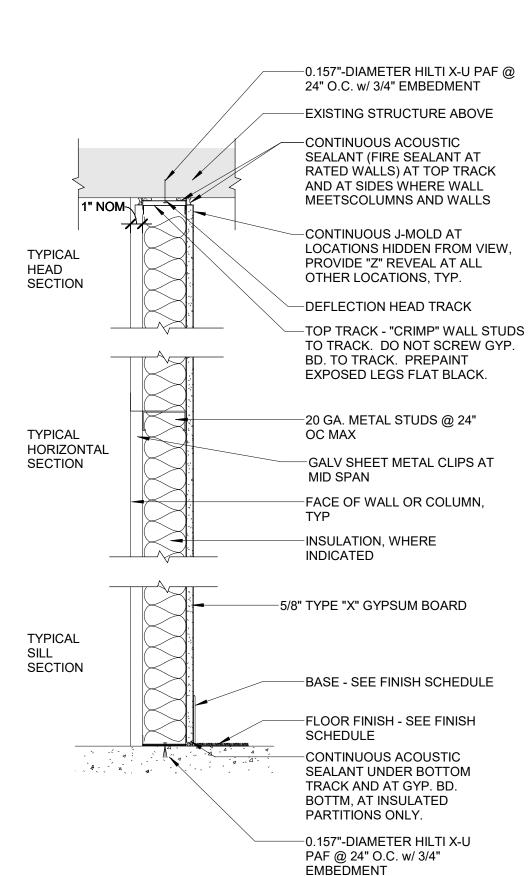

NON-RATED FURRING WALL

UL: N/A - NON-RATED, STC 34, TEST# NGC2013012

POP RIVET RUNNER TO 7/8" WALL ANGLE AT 2 ADJACENT WALLS, FASTEN CLOSURE ANGLE WITH #6 SCREWS DIRECTLY TO WALL FRAMING OR PROVIDE STRUT STABILIZER BAR BETWEEN ALL MEMBERS AT PERIMETER -FLOOR OR ROOF STRUCTURE

-IN AREAS GREATER THAN 1,000 SF SECURE ALL HANGERS TO BLDG STRUCTURE. TRAPEZE DUCT WORK AND OTHER LARGE

CROSS RUNNERS FIT BETWEEN MAIN RUNNERS

-COUNTERSLOPE HANGERS IF MORE THAN 1:6 OUT OF

0.157"-DIAMETER HILTI X-U PAF @

SEALANT AT TOP TRACK AND AT

LOCATIONS HIDDEN FROM VIEW

PROVIDE "Z" REVEAL AT ALL

24" O.C. w/ 3/4" EMBEDMENT

-CONTINUOUS ACOUSTIC

-EXISTING STRUCTURE ABOVE

SIDES WHERE WALL MEETS

CONCRETE COLUMNS AND

-CONTINUOUS J-MOLD AT

OTHER LOCATIONS, TYP.

-DEFLECTION HEAD TRACK

TOP TRACK - "CRIMP" WALL

STUDS TO TRACK. DO NOT

INSULATION, WHERE

TYP. ELECTRICAL BOX

SEPARATION - 16" MIN.

-5/8" TYPE "X" GYPSUM

WALLBOARD, EACH SIDE

-20 GA. METAL STUDS @ 16"

BASE - SEE FINISH SCHEDULE

FLOOR FINISH - SEE FINISH

-CONTINUOUS ACOUSTIC

SEALANT UNDER BOTTOM

0.157"-DIAMETER HILTI X-U

TRACK AND AT GYP. BD.

BOTTM, AT INSULATED PARTITIONS ONLY.

PAF @ 24" O.C. w/ 3/4"

EMBEDMENT

NON-RATED WALL

UL: N/A - NON-RATED, STC 39, TEST# VENEKLASEN STUDY

INDICATED

OC MAX

SCHEDULE

BLACK.

SCREW GYP. BD. TO TRACK.

PREPAINT EXPOSED LEGS FLAT

DEFLECTION.

AND GAUGE

2. DEFLECTION TRACK FLANGE WIDTH SHALL BE AS REQUIRED TO ACCOMMODATE

INTERIOR METAL STUD SCHEDULE


STUD SIZE	MAX. WALL HEIGHT	BOTTOM TRACK	TYPICAL STUD	DEFLECTION TRACK
2 1/2"	12-'10"	250T125-33	250S162-33 @ 16" O.C.	33MIL MIN.
3 5/8"	12'-10"	362T125-30	362S125-30 @ 24" O.C.	33MIL MIN.
4"	12'-10"	400T125-30	400S125-30 @ 24" O.C.	33MIL MIN.
6"	12'-10"	600T125-30	600S125-30 @ 24" O.C.	33MIL MIN.
		•		•

1. SCHEDULE FRAMING IS DESIGNED FOR 5 PSF INTERIOR PRESSURE AND L/240 MAX.

DEFLECTION HEAD MOVEMENT. REF. DETAILS FOR MOVEMENT REQUIREMENTS.

INTERIOR PARTITION HEADER, SILL, AND

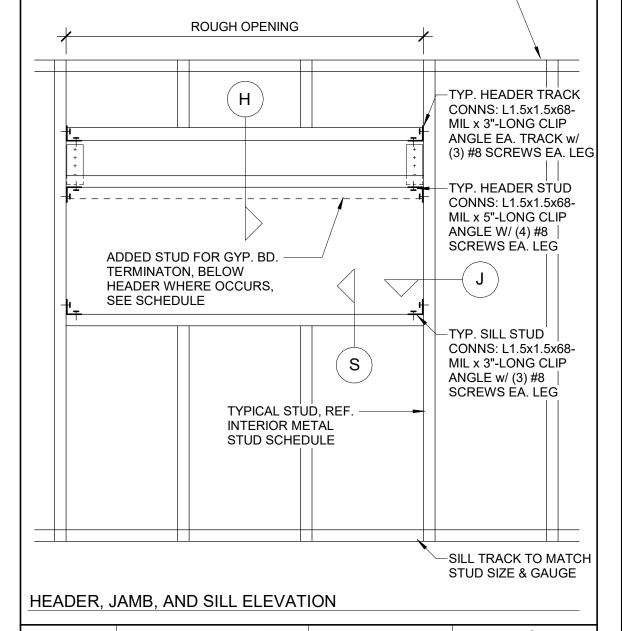JAMB SCHEDULE (3 5/8" STUD WALLS) TOP TRACK TO -MATCH STUD SIZE



OPENING WIDTH	HEADER (H	SILL S	JAMB J
0-4 FEET AT 3 5/8" FRAMING	(1) 362T200-54		(1) 362T150-33	(2) 362S162-33
	OPT. ADD'L STUD FOR GYF TERMINATON, MATCH JAM			
4-8 FEET AT 3 5/8" FRAMING	362T125-33 T&B (2) 362S162-33		(1) 362T125-33	(2) 362S162-33
	OPT. ADD'L STUD FOR GYF TERMINATON, MATCH JAM			
4-12 FEET AT 3 5/8" FRAMING	362T250-43 T&B (2) 600S162-43		(1) 362T250-43	(2) 362S162-43
	OPT. ADD'L STUD FOR GYF TERMINATON, MATCH JAM			
12-16 FEET AT 3 5/8" FRAMING	362T300-68 T&B (2) 800S162-43		(1) 362T300-68	(2) 362S162-97
	OPT. ADD'L STUD FOR GYF TERMINATON, MATCH JAM			

NOTE:

LAP ALL MEMBERS w/ #8 SCREWS @ 12" O.C. TYP.

DESIGN FOR WALL HEIGHT UP TO 12'-10", 5PSF INTERIOR PRESSURE, L/240 MAX. DEFLECTION. MEMBERS NOT DESIGNED FOR COMPOSITE ACTION. OPENINGS BEYOND SCHEDULE DESIGN LIMITS REQUIRE ADDITIONAL

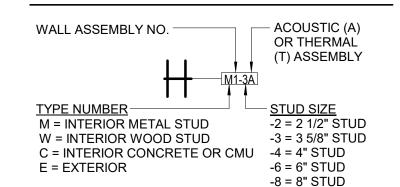
ENGINEERING.

GENERAL WALL TYPE NOTES


1. ALL STC RATINGS LISTED ARE LAB TESTIED NUMBERS. ACTUAL FIELD TESTING NUMBERS MAY VARY FROM LAB NUMBERS.

2. STUD SPACING NOTED IS THE MAXIMUM ALLOWED SPACING PER THE UL DESIGN NO. REFER TO SPECIFICATIONS FOR ADDITIONAL STUD SPACING

METAL FRAMED WALL TYPE LEGEND



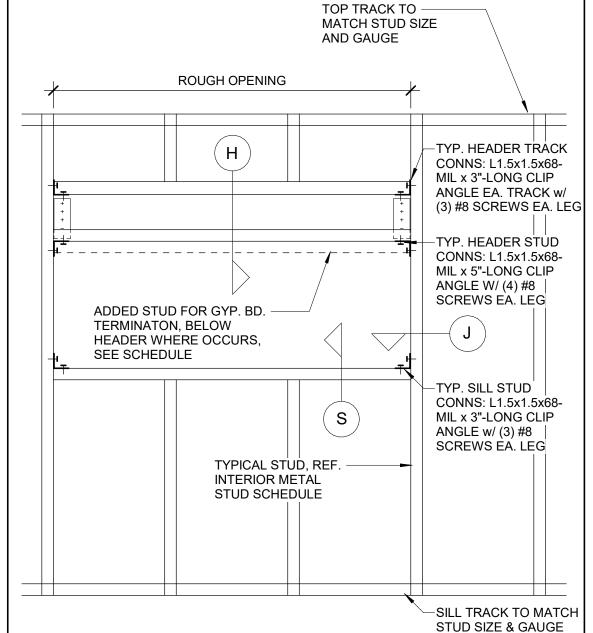INTERIOR PARTITION HEADER, SILL, AND **JAMB SCHEDULE (6" STUD WALLS)**



HEADER, JAMB, AND SILL ELEVATION

OPENING WIDTH	HEADER	$\left(H\right)$	SILL (S)	JAMB (J)
0-4 FEET AT 6" FRAMING	(1) 600T200-54		(1) 600T150-33	(2) 600S162-33
	OPT. ADD'L STUD FOR O			
4-8 FEET AT 6" FRAMING	600T125-33 T&B (2) 362S162-33		(1) 600T125-33	(2) 600S162-33
	OPT. ADD'L STUD FOR O			
4-12 FEET AT 6" FRAMING	600T125-43 T&B (2) 600S162-43		(1) 600T150-43	(2) 600S200-43
	OPT. ADD'L STUD FOR O TERMINATON, MATCH J			
12-16 FEET AT 6" FRAMING	600T125-43 T&B (2) 800S162-43		(1) 600T200-43	(2) 600S162-68
	OPT. ADD'L STUD FOR O			

NOTE:

LAP ALL MEMBERS w/ #8 SCREWS @ 12" O.C. TYP

DESIGN FOR WALL HEIGHT UP TO 12'-10", 5PSF INTERIOCORESSURE LEO MAXIAND DEFLECTION. MEMBERS NOT DESIGNED FOR COMPOSITE ACTION. OPENINGS BEYOND SCHEDULE DESIGN LIMITS REQUIRE ON TOPENINGS ENGINEERING.

Code Compliance

Date:5/22/2025 Permit #: 25-037217-000-00-FA

GBD Architects, Incorporated

1120 NW Couch St. Ste. 300 Portland, OR 97209

Tel. (503) 224-9656 gbdarchitects.com

GBD © 2025 STAMP

PROJECT

HDR Pearl West

1455 NW Irving St, Suite 800 Portland, OR 97209

CLIENT

1050 SW 6th Ave, Suite 1800

Portland, OR 97204

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DATE

05.06.2025

PROJECT NUMBER

20137549

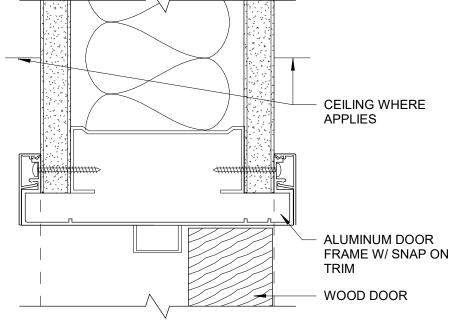
As indicated

SCALE

SHEET TITLE


DETAILS

17 TYP ALUMINUM RELITE @ HEAD 6" = 1'-0"




13 TYP DOOR @ HEAD

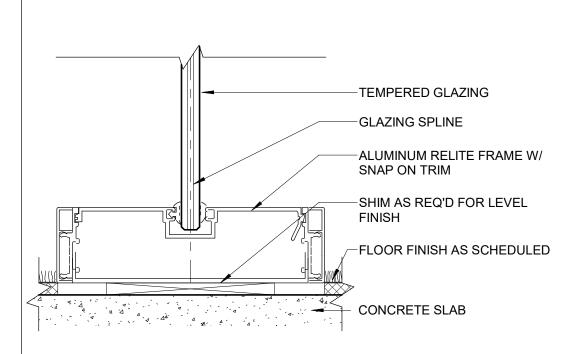6" = 1'-0"




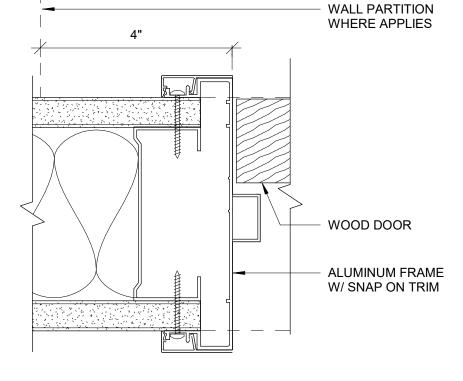18 TYP ALUMINUM RELITE @ SILL 6" = 1'-0"




14 TYP DOOR @ JAMB

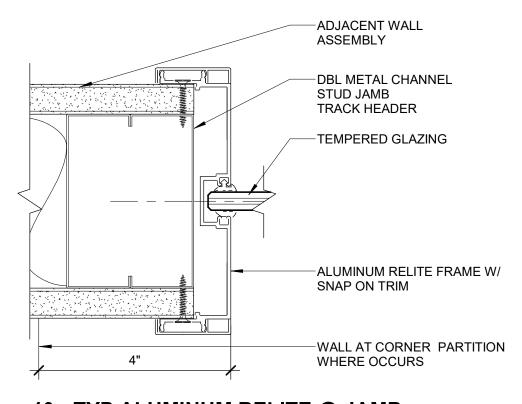6" = 1




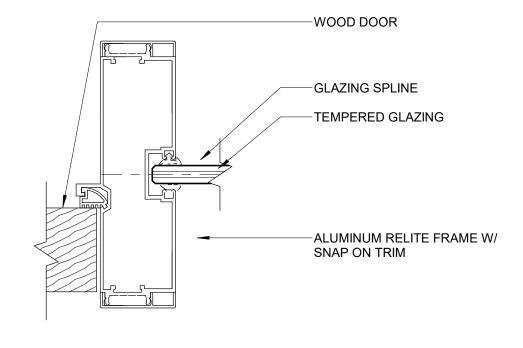19 TYP ALUMINUM RELITE @ JAMB 6" = 1'-0"




15 TYP ALUMINUM DOOR/RELITE JAMB

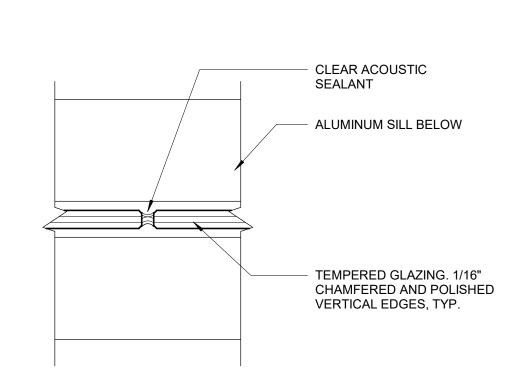6" = 1'-0"



20 RELITE BUTT JOINT

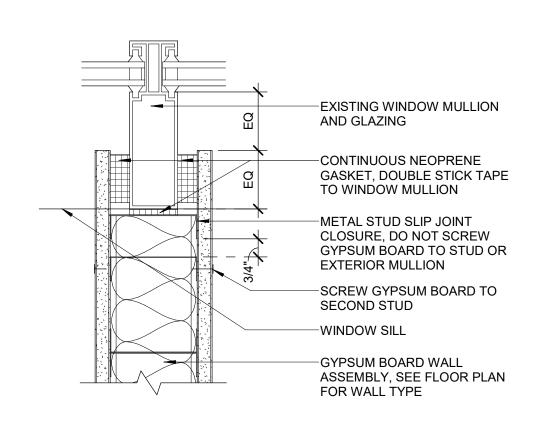6" = 1'-0"



16 PARTITION @ EXTERIOR MULLION

3" = 1'-0

GBD

GBD Architects, Incorporated

1120 NW Couch St. Ste. 300 Portland, OR 97209

Tel. (503) 224-9656

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gbdarchitects.com

WARCUS POLIMA
PORTLANDY ORAGON
11648

PROJECT

HDR Pearl West

1455 NW Irving St, Suite 800 Portland, OR 97209

CLIENT

IDR

1050 SW 6th Ave, Suite 1800 Portland, OR 97204

Notice of Extended Payment Provision: The contract will allow the owner to make payment within 30 days after the date a billing or estimate is submitted. Notice of Alternate Billing Cycle: The contract will allow the owner to require the submission of billings or estimates in billing cycles other than 30-day cycles. Billings or estimates for the contract shall be submitted as follows: Each calendar month ending on the last day of the applicable month.

REVISIONS

1 04/30/2025 ASI 3

DATE

PROJECT NUMBER

05.06.2025

20137549

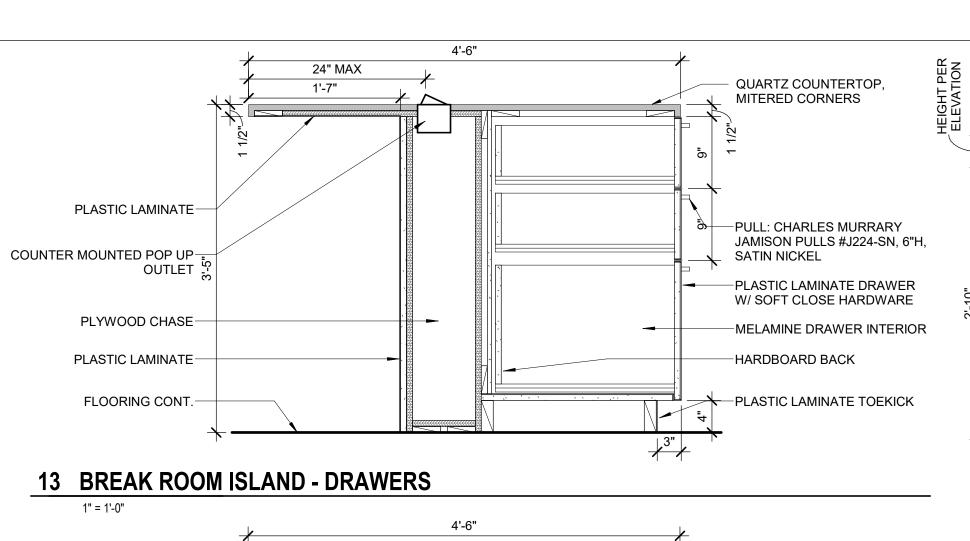
SCALE

As indicated

City of Portland
Reviewed for
Code Compliance

Date:5/22/2025 Permit #: 25-037217-000-00-FA SHEET TITLE
DETAILS

A90²



QUARTZ COUNTERTOP,

-PULL: CHARLES MURRARY JAMISON PULLS #J224-SN, 6"H,

-PLASTIC LAMINATE DOOR W/

-3/4" ADJUSTABLE MELAMINE

-PLASTIC LAMINATE TOEKICK

- QUARTZ COUNTERTOP,

COORDINATE ELECTRICAL

-MELAMINE DRAWER INTERIOR

JAMISON PULLS #J224-SN, 6"H,

-PLASTIC LAMINATE DRAWER

W/ SOFT CLOSE HARDWARE

-PLASTIC LAMINATE TOEKICK

-HARDBOARD BACK

-PULL: CHARLES MURRARY

MITERED CORNERS

GROMMET

SATIN NICKEL

SOFT CLOSE HARDWARE

-MELAMINE INTERIOR

MITERED CORNERS

SATIN NICKEL

SHELVES

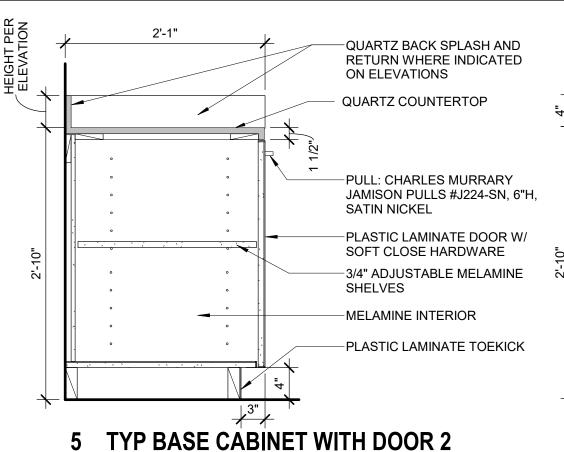
24" MAX 1'-7"

Numari National Property of the Property of th


OUTLET

PLYWOOD CHASE-

FLOORING CONT.



2'-1"

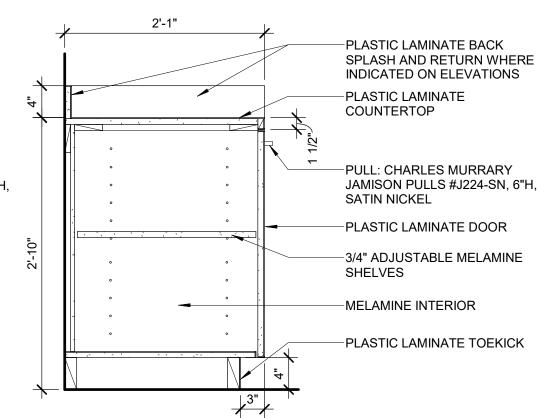

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Portland, OR 97209

Tel. (503) 224-9656

gbdarchitects.com

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STAMP

PROJECT

CLIENT

HDR Pearl West

Portland, OR 97209

Portland, OR 97204

1455 NW Irving St, Suite 800

1050 SW 6th Ave, Suite 1800

Notice of Extended Payment

Provision: The contract will

payment within 30 days after

the date a billing or estimate is

submitted. Notice of Alternate

Billing Cycle: The contract will

allow the owner to require the

submission of billings or

estimates in billing cycles

other than 30-day cycles.

Billings or estimates for the

contract shall be submitted as

follows: Each calendar month

ending on the last day of the

applicable month.

2 04/30/2025 ASI 3

1 03/26/2025 ASI 1

PROJECT NUMBER

REVISIONS

DATE

05.06.2025

20137549

SCALE

1" = 1'-0"


allow the owner to make

Incorporated

Ste. 300

TYP BASE CABINET WITH DOOR 1

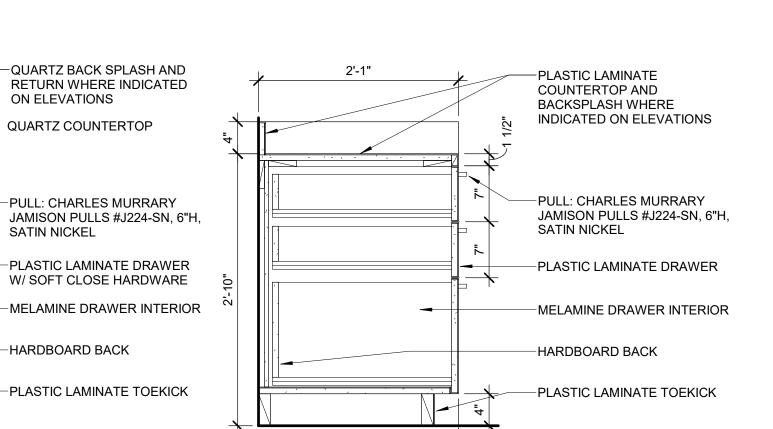1" = 1'-0"







ON ELEVATIONS


SATIN NICKEL

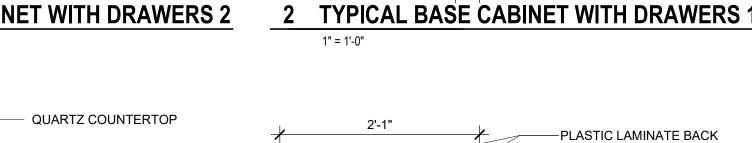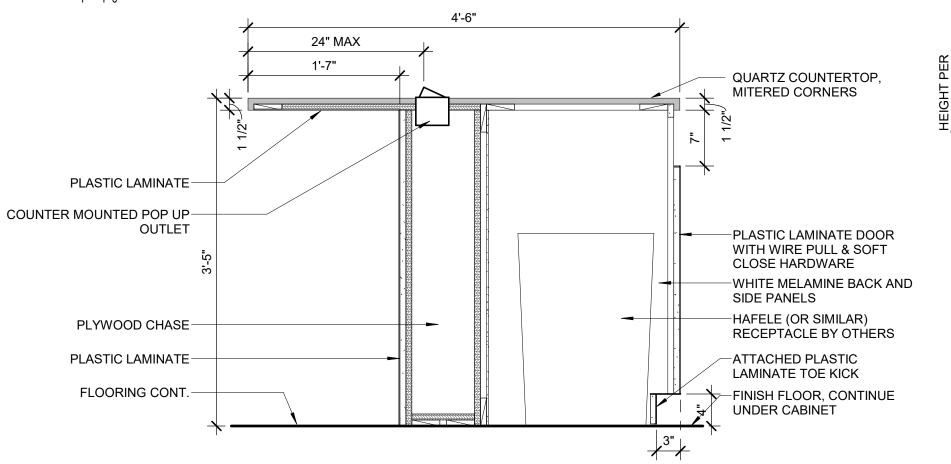
HARDBOARD BACK





4'-6"

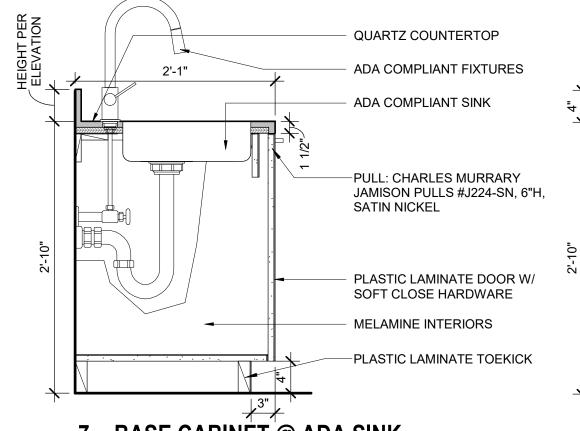

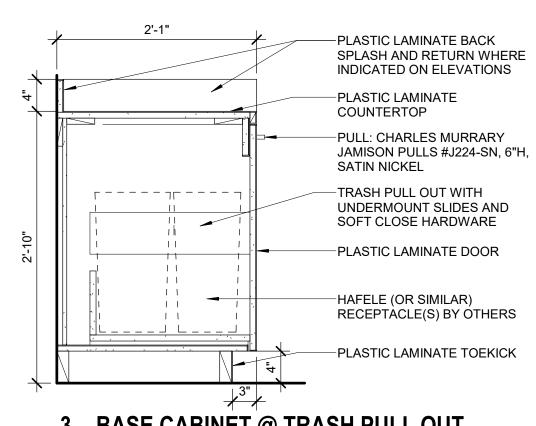





BASE CABINET @ ADA SINK


1" = 1'-0"


8 OPEN SHELVES

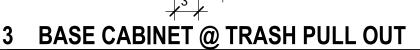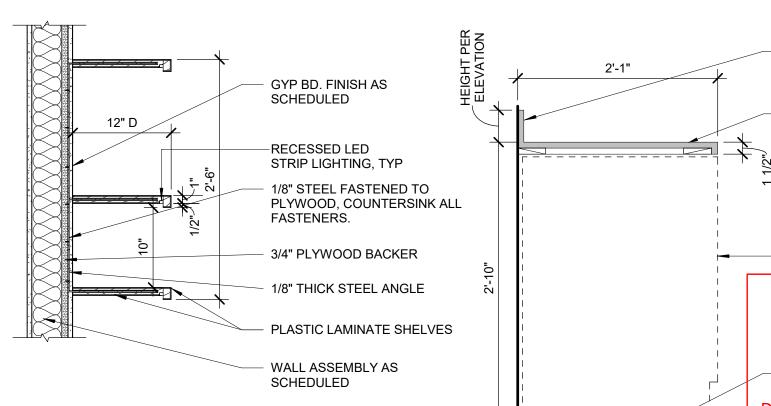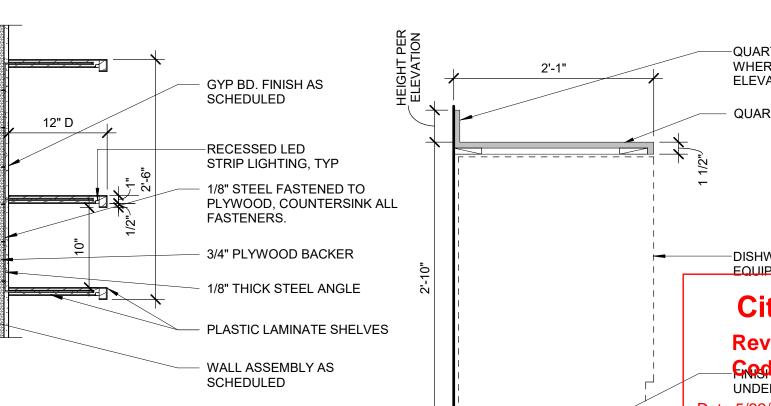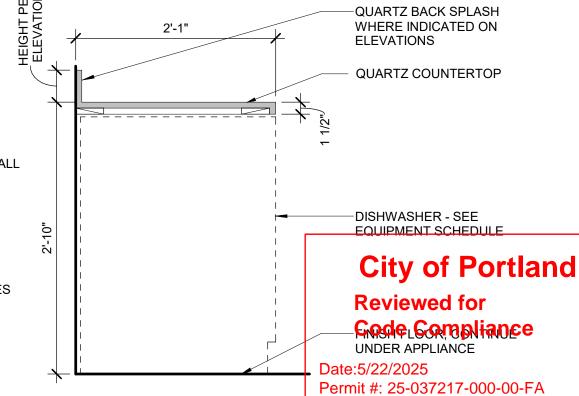1" = 1'-0"









SHEET TITLE DETAILS A902

BASE CABINET @ DW

16 BREAK ROOM ISLAND - UNDERCOUNTER MICROWAVE

24" MAX

1'-7"

1" = 1'-0"

PLASTIC LAMINATE-

PLYWOOD CHASE-

PLASTIC LAMINATE-

FLOORING CONT.

OUTLET 5

COUNTER MOUNTED POP UP-

odesk Docs://Buil /2025 8:53:39 AM



	HDR Connections Legend						
	Description	Quantity					
1 SM	1 - CAT6 SOUND MASKING PATCH CABLE	1					
AV	1 - CAT6 AV DROP	2					
1 CAT6	1 - CAT6 DROP	1					
CATE	1 - CAT6 DROP	52					
FURN.	1 - CAT6 MODULAR FURNITURE	2					
FURN.	1 - CAT6 MODULAR FURNITURE	53					
RS	1 - CAT6 ROOM SCHEDULER DROP	4					
1 SEC	1 - CAT6 SECURITY DROP	4					
	1 - CAT6A WAP	14					
AV AV	2 - CAT6 AV DROP	3					
2 SEC	2 - CAT6 SECURITY DROP	1					
AV AV	3 - CAT6 AV DROP	4					
AV AV	4 - CAT6 AV DROP	1					
5 AV	5 - CAT6 AV DROP	1					
6 CATE	6 - CAT6 DROP	4					
1 PATCH CABLE	SECURITY PATCH CABLE	1					

187 WIRED CONNECTIONS

8 - VLAN50 PORTS NEEDED

	HDR Security Legend					
	Description	Quantity				
A1 CR	ACCESS CARD READER	1				
A2 CR	ACCESS CARD READER	1				
A3 CR	ACCESS CARD READER	1				
A4 CR	ACCESS CARD READER	1				
PANEL A	ACCESS CONTROL PANEL	1				
VMS	CCTV VMS SERVER	1				
D <mark>C1</mark>	SINGLE SENSOR CCTV CAMERA	1				
<u>C2</u> ✓	SINGLE SENSOR CCTV CAMERA	1				
<mark> C3</mark>	SINGLE SENSOR CCTV CAMERA	1				
	SINGLE SENSOR CCTV CAMERA	1				

	HDR Sound Masking L	.egend		MARK DATE
	Description	Quantity		
3	Z1 CH1 SM Speaker	13		
32	Z1 CH2 SM Speaker	13		
S ₁	Z2 CH1 SM Speaker	10		DRAWN BY
S ₂	Z2 CH2 SM Speaker	9		SHEET NAME FURNI
S ₁	Z3 CH1 SM Speaker	24		PLAN
S ₂	Z3 CH2 SM Speaker	City ₂ of Por Reviewed for	tla	nd scale
S ₁	Z4 CH1 SM Speaker	Code Compliar	ice	SHEET NUMBER
S ₂	Z4 CH2 SM Speaker	15/22/2025 hit #: 25-0 <mark>873</mark> 17-000-0	00-F <i>A</i>	PP-

PROJECT FOR

HDR PORTLAND
1455 NW IRVING ST

STE #800
PORTLAND, OR

ISSUE DATE PHASE

10.21.202&K1.0

11.04.202&K1.1

11.06.202&K1.2

11.11.202&K1.3

11.11.202&K1.4/FINAL

ISSUE 11.18.202&P1.0

DESCRIPTION

DRAWN BY SA

SHEET NAME

FURNITURE

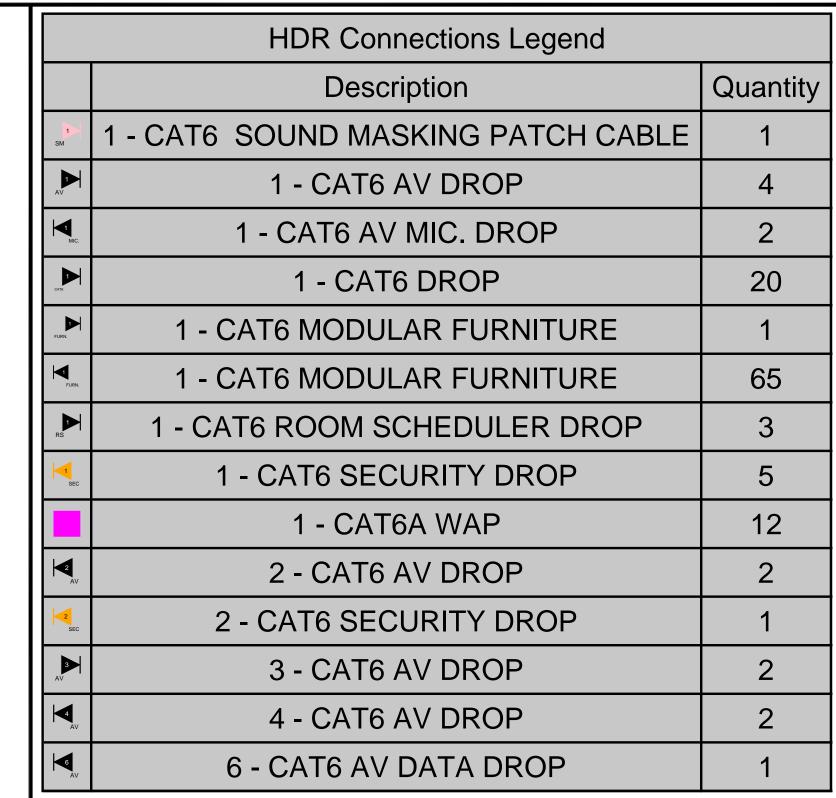
PLAN

PP-1.0_FURN

FOR REFERENCE ONLY

FILE NAME





139 WIRED CONNECTIONS

8 - VLAN50 PORTS NEEDED

Ш	HDR Security Legend						
Ш		Description	Quantity				
	A1 CR	ACCESS CARD READER	1				
	A2 CR	ACCESS CARD READER	1				
	A3 CR	ACCESS CARD READER	1				
	A5 CR	ACCESS CARD READER	1				
	PANEL A	ACCESS CONTROL PANEL	1				
		Dual Sensor CCTV Camera	1				
	<u>C1</u> ✓	SINGLE SENSOR CCTV CAMERA	1				
	C2	SINGLE SENSOR CCTV CAMERA	1				
	<mark>C3</mark>	SINGLE SENSOR CCTV CAMERA	1				
	<u>C4</u> ✓	SINGLE SENSOR CCTV CAMERA	1				

			11
HDR Sound Masking Legend			
	Description	Quantity	
s ₁	Z1 CH1 SM Speaker	16	MARK DATE
S ₂	Z1 CH2 SM Speaker	16	
S ₁	Z2 CH1 SM Speaker	5	
S ₂	Z2 CH2 SM Speaker	5	
S ₁	Z3 CH1 SM Speaker	19	DRAWN BY SHEET NAME
S ₂	Z3 CH2 SM Speaker	17	FURI PLAI
S ₁	Z4 CH1 SM Speaker	City oBPortla	
S ₂	Z4 CH2 SM Speakerc	eviewed for ode Compliance	SCALE SHEET NUMBER

FURNITURE PLAN

CALE 1/8"=1'-0"

HEET NUMBER

PP-1.0_FURN

HDR PORTLAND

PORTLAND, OR

ISSUE DATE PHASE

10.21.20245K1.0 11.04.20245K1.1 11.06.20245K1.2 11.11.20245K1.3 11.11.20245K1.4/FINAL

STE #800

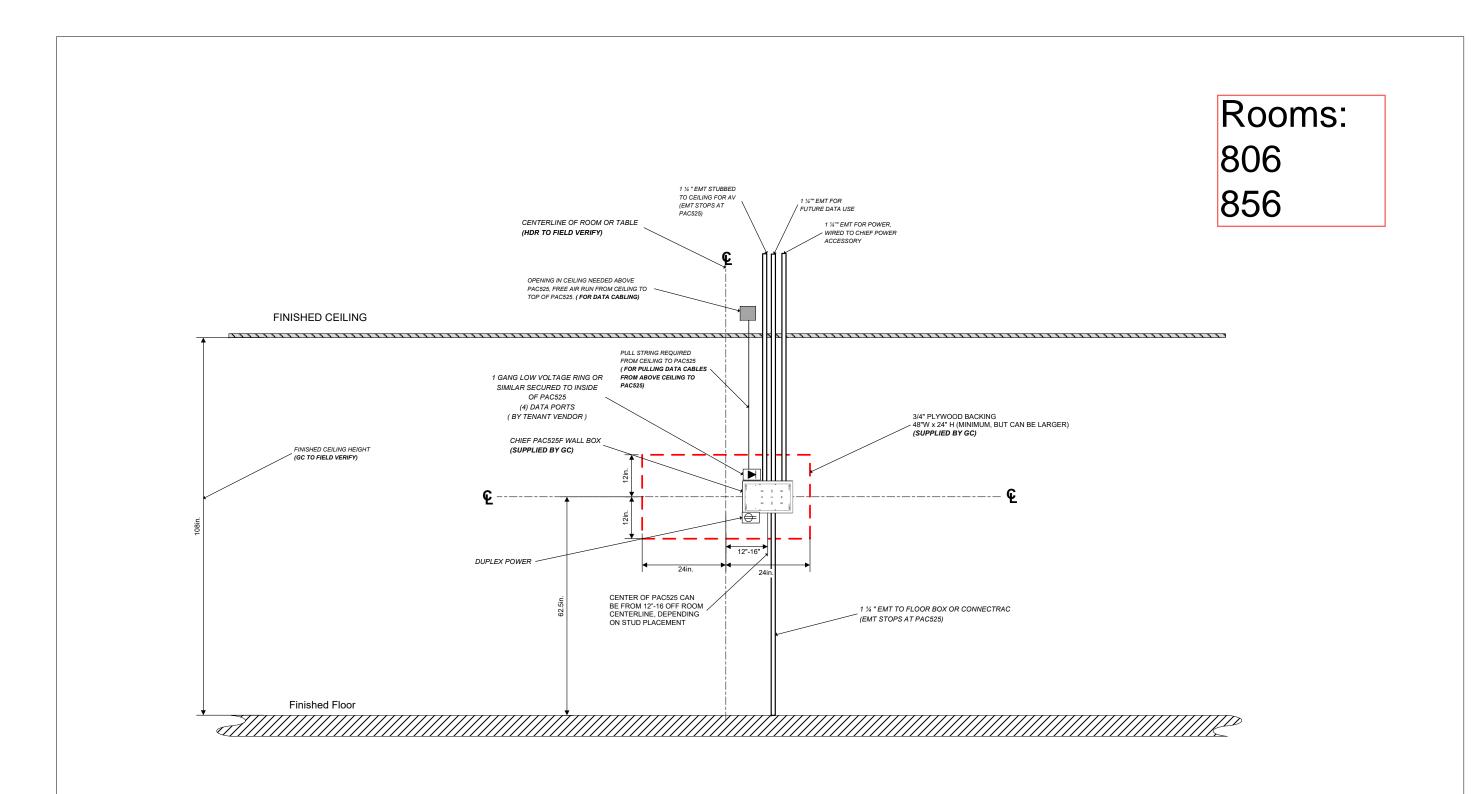
1455 NW IRVING ST

Date:5/22/2025
Permit #: 25-037217-000-00-FA

PP-1.0_FU

FILE NAME

REFERENCE ONLY FOR



(*)			
Computacenter			


1455 NW Irving St, Ste 800, Portland, OR 97209.

Small Conference Room - Infrastructure Elevation

STANDARD ROOM

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1455 NW Irving St, Ste 800, Portland, OR 97209.

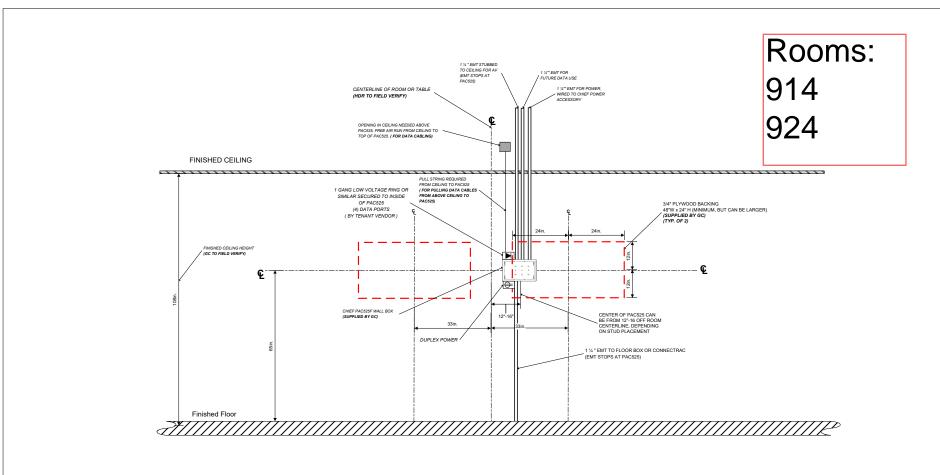Medium Conference Room - Dual 75"- Infrastructure Elevation
STANDARD ROOM

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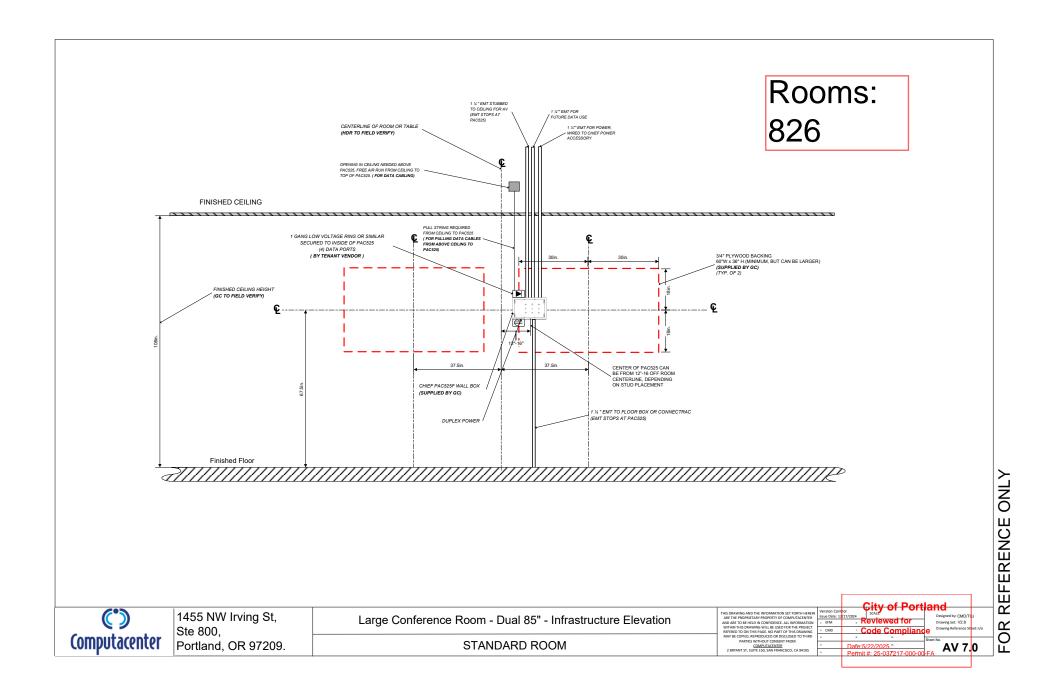
2017/2024 Reviewed for

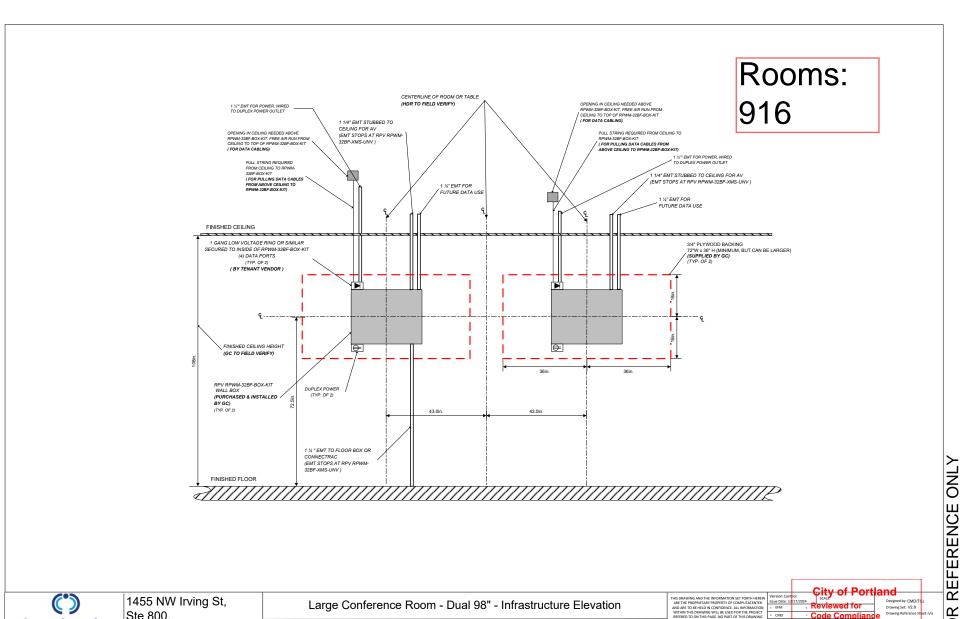
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