Development Services

From Concept to Construction







APPEAL SUMMARY

Status:	Decision	Rendered
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Status. Decision Rendered	
Appeal ID: 23500	Project Address: 2133 N Argyle St
Hearing Date: 2/26/20	Appellant Name: ian Flood
Case No. : B-010	Appellant Phone: 5034168121
Appeal Type: Building	Plans Examiner/Inspector: Brian McCall, Fred Barsukoff, Ken Majors, Michael Silva
Project Type: commercial	Stories: 4 Occupancy: R-2 Construction Type: V-A
Building/Business Name: Renaissance Commons	Fire Sprinklers: Yes - throughout
Appeal Involves: Erection of a new structure	LUR or Permit Application No.:
Plan Submitted Option: pdf [File 1] [File 2]	Proposed use: Housing

APPEAL INFORMATION SHEET

Appeal item 1

Code Section

1009.16

Requires

In buildings four or more stories above grade plane, one stairway shall extend to the roof surface, unless the roof has a slope steeper than four units vertical in 12 units horizontal (33-percent slope). In buildings without an occupied roof, access to the roof from the top story shall be permitted to be by an alternating tread device or a ship stair or ladder that is constructed of steel, is a minimum 30 inches (762 mm) between handrails, has a rise and run of the stair or ladder of 12 inches (304.8) maximum and 4 inches (101.6 mm) minimum respectively and has handrails provided on both sides of the stair or ladder.

Code Modification or Alternate Requested

Proposed Design

The project has two roof hatches with overall dimensions of 3'-0" x 8'-0". We propose to construct the ship's ladders from the stairways to the rooftop with overall widths of 33" leaving 30" clear between the handrails while still maintaining 1 1/2" clear between the outside of one handrail to the wall. At the plane of the framed ceiling opening, we will continue one handrail to the roof. Our proposal will allow one entirely clear graspable surface to run continuously, but the framed opening and sheetrock can remain.

Reason for alternative Section 1009.16 Stairway to roof requires a 30 inch wide between handrails. To have full bearing for the roof hatch attachment angle on the roof trusses below, and then drywall and framing on each side of the access hatch, the overall width of the area becomes roughly 34.75". To provide a consistent and maximum width for handrails and treads, while maintaining handrail clearances from walls (1 1/2"), and fit within, an overall width of 33" is achievable for the stair with only a single handrail to the roof from the bottom of the ceiling plane. This yields a clear handrail to handrail dimension of 30" to the ceiling and one handrail extended through the hole with 1'1/2" clearance.

The proposed design works with the structural bearing of the ship's ladder while allowing safe access to the roof. The $1-\frac{1}{2}$ " diameter handrail with $1-\frac{1}{2}$ " clearance will be set on the access handle/latch side of the hatch so the user will not have to reach across the access hatch for leverage. (See the last page of attached .pdf package for diagram)


APPEAL DECISION

Ships ladder to unoccupied roof with omission of one handrail at roof access hatch: Granted provided two handrails are installed with 1.5 inch clearance on each side and reduced clear width between handrails.

Appellant may contact John Butler (503 823-7339) with questions.

The Administrative Appeal Board finds with the conditions noted, that the information submitted by the appellant demonstrates that the approved modifications or alternate methods are consistent with the intent of the code; do not lessen health, safety, accessibility, life, fire safety or structural requirements; and that special conditions unique to this project make strict application of those code sections impractical.

Pursuant to City Code Chapter 24.10, you may appeal this decision to the Building Code Board of Appeal within 90 calendar days of the date this decision is published. For information on the appeals process, go to www.portlandoregon.gov/bds/appealsinfo, call (503) 823-7300 or come in to the Development Services Center.

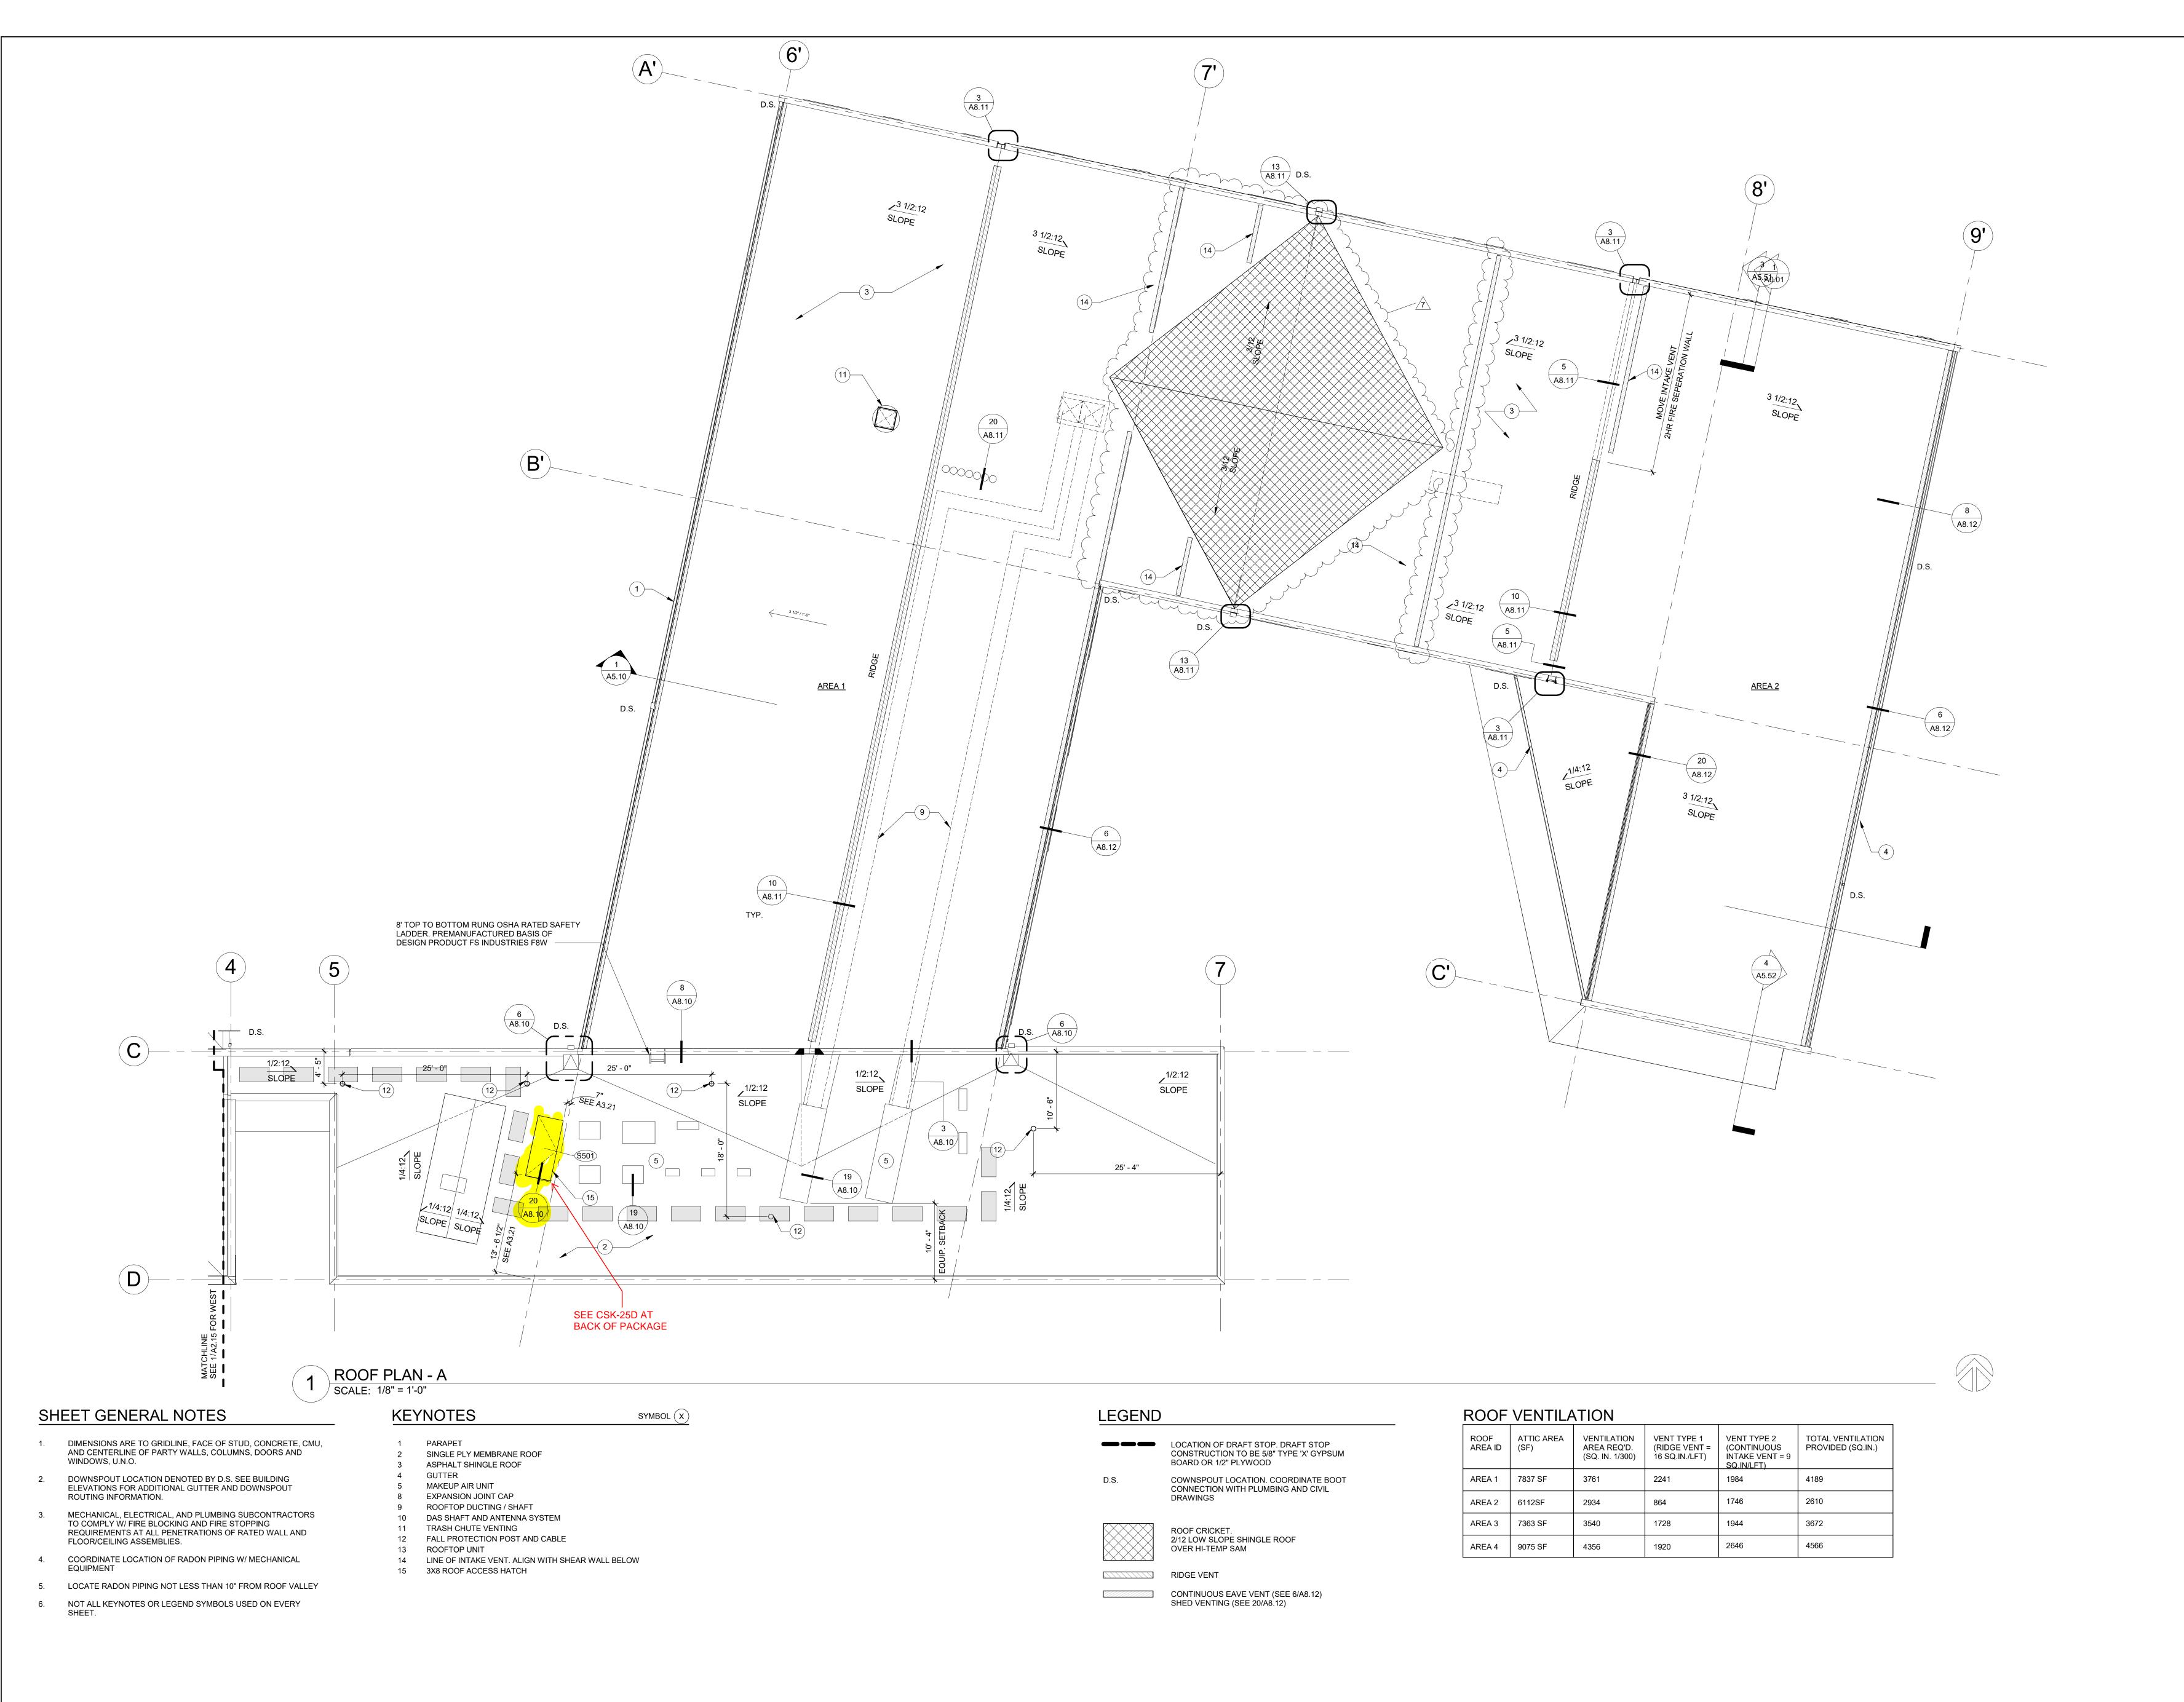

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REVISION NO D

BID SET 10/29/18
2 PERMIT REV1 11/02/18
6 CONST. SET 01/21/19
7 CONST. REV.

ARGYLE

APARTMENTS

2133 N ARGYLE STREET
PORTLAND, OR 97217

ISSUANCE
CONSTRUCTION SET

DATE
06/14/2019

SCALE
As indicated

PROJECT NUMBER
201663.00


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DRAWING TITLE

ROOF PLAN - A

SHEET NUMBER

A2.05

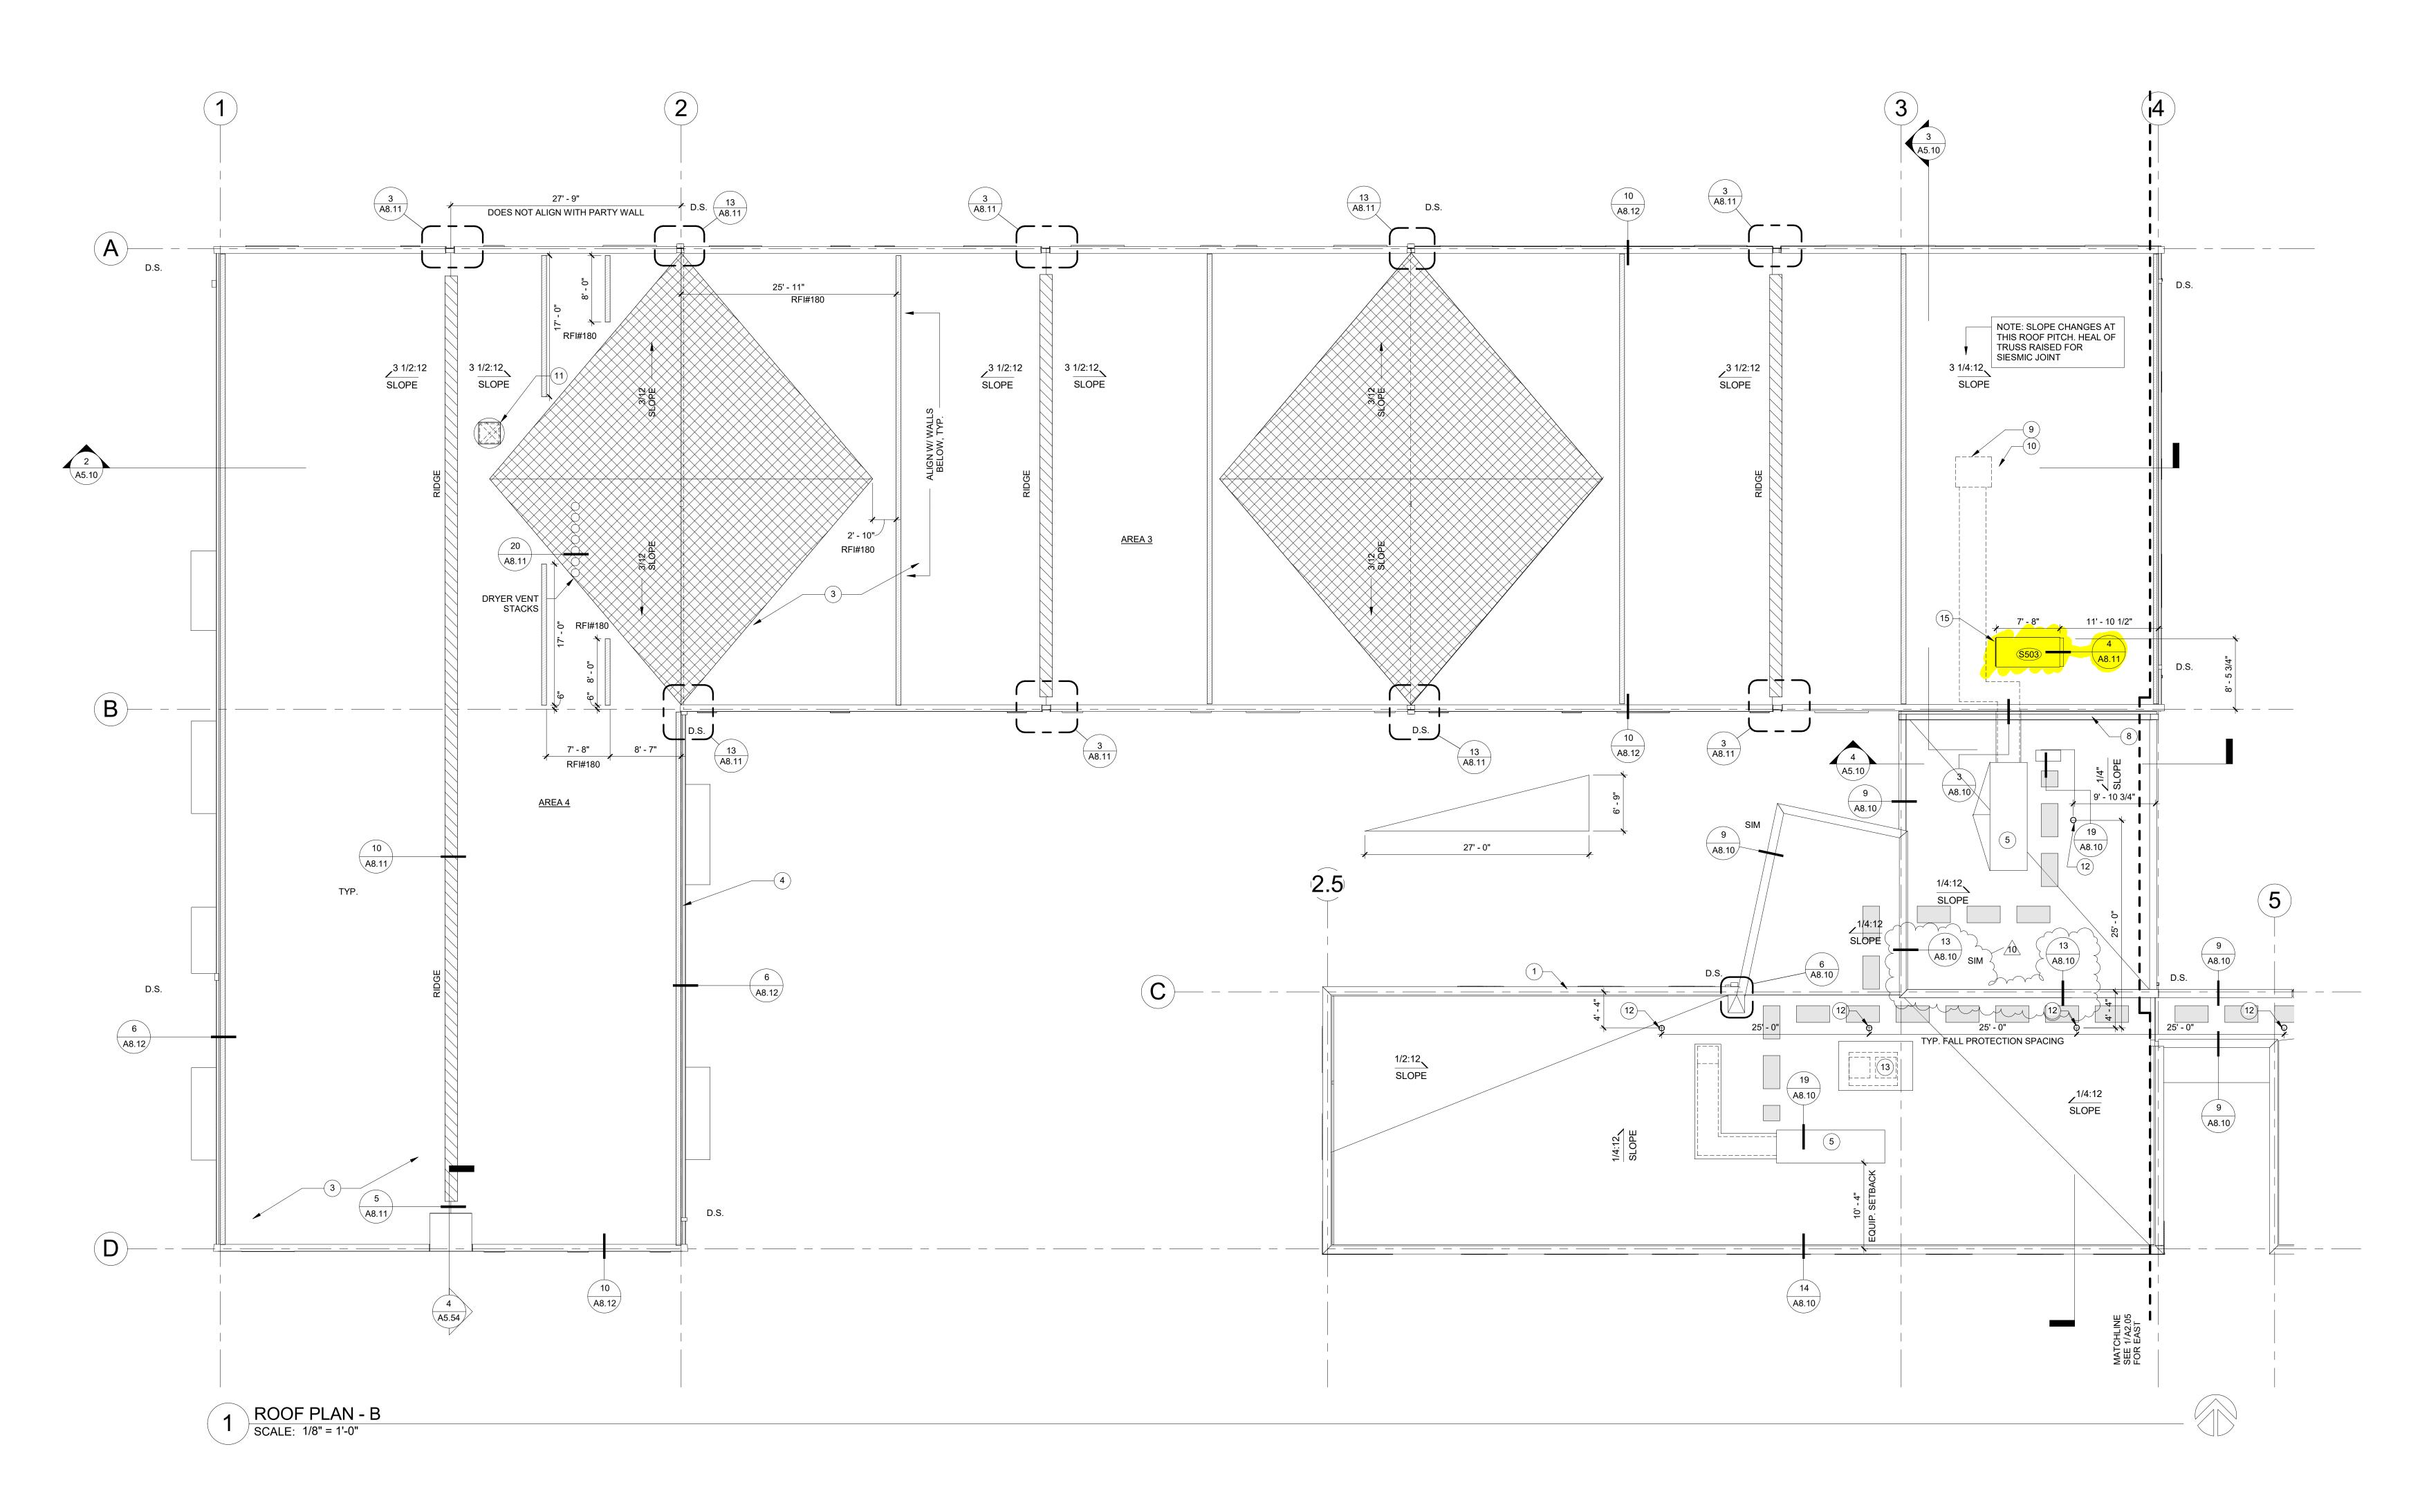

SHEET GENERAL NOTES

- DIMENSIONS ARE TO GRIDLINE, FACE OF STUD, CONCRETE, CMU, AND CENTERLINE OF PARTY WALLS, COLUMNS, DOORS AND WINDOWS, U.N.O.
- DOWNSPOUT LOCATION DENOTED BY D.S. SEE BUILDING ELEVATIONS FOR ADDITIONAL GUTTER AND DOWNSPOUT ROUTING INFORMATION.
- MECHANICAL, ELECTRICAL, AND PLUMBING SUBCONTRACTORS TO COMPLY W/ FIRE BLOCKING AND FIRE STOPPING REQUIREMENTS AT ALL PENETRATIONS OF RATED WALL AND FLOOR/CEILING ASSEMBLIES.
- COORDINATE LOCATION OF RADON PIPING W/ MECHANICAL **EQUIPMENT**
- LOCATE RADON PIPING NOT LESS THAN 10" FROM ROOF VALLEY
- NOT ALL KEYNOTES OR LEGEND SYMBOLS USED ON EVERY

KEYNOTES SYMBOL (X)


PARAPET

- SINGLE PLY MEMBRANE ROOF ASPHALT SHINGLE ROOF
- GUTTER
- MAKEUP AIR UNIT EXPANSION JOINT CAP
- ROOFTOP DUCTING / SHAFT 10 DAS SHAFT AND ANTENNA SYSTEM
- 11 TRASH CHUTE VENTING
- 12 FALL PROTECTION POST AND CABLE 13 ROOFTOP UNIT
- 14 LINE OF INTAKE VENT. ALIGN WITH SHEAR WALL BELOW 15 3X8 ROOF ACCESS HATCH

LEGEND

LOCATION OF DRAFT STOP. DRAFT STOP CONSTRUCTION TO BE 5/8" TYPE 'X' GYPSUM BOARD OR 1/2" PLYWOOD

COWNSPOUT LOCATION. COORDINATE BOOT D.S. CONNECTION WITH PLUMBING AND CIVIL **DRAWINGS**

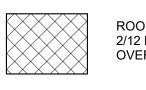

ROOF CRICKET. 2/12 LOW SLOPE SHINGLE ROOF OVER HI-TEMP SAM

RIDGE VENT CONTINUOUS EAVE VENT (SEE 6/A8.12) SHED VENTING (SEE 20/A8.12)

ROOF VENTILATION

ROOF AREA ID	ATTIC AREA (SF)	VENTILATION AREA REQ'D. (SQ. IN. 1/300)	VENT TYPE 1 (RIDGE VENT = 16 SQ.IN./LFT)	VENT TYPE 2 (CONTINUOUS INTAKE VENT = 9 SQ.IN/LFT)	TOTAL VENTILATION PROVIDED (SQ.IN.)
AREA 1	7837 SF	3761	2241	1984	4189
AREA 2	6112SF	2934	864	1746	2610
AREA 3	7363 SF	3540	1728	1944	3672
AREA 4	9075 SF	4356	1920	2646	4566

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REVISION NO


PERMIT REV1 11/02/18 CONST. REV. 10 CONST. REV. 10/04/19

> ARGYLE APARTMENTS 2133 N ARGYLE STREET PORTLAND, OR 97217

ISSUANCE CONSTRUCTION SET 06/14/2019 SCALE As indicated PROJECT NUMBER 201663.00 DRAWN BY DRAWING TITLE

ROOF PLAN - B

SHEET NUMBER

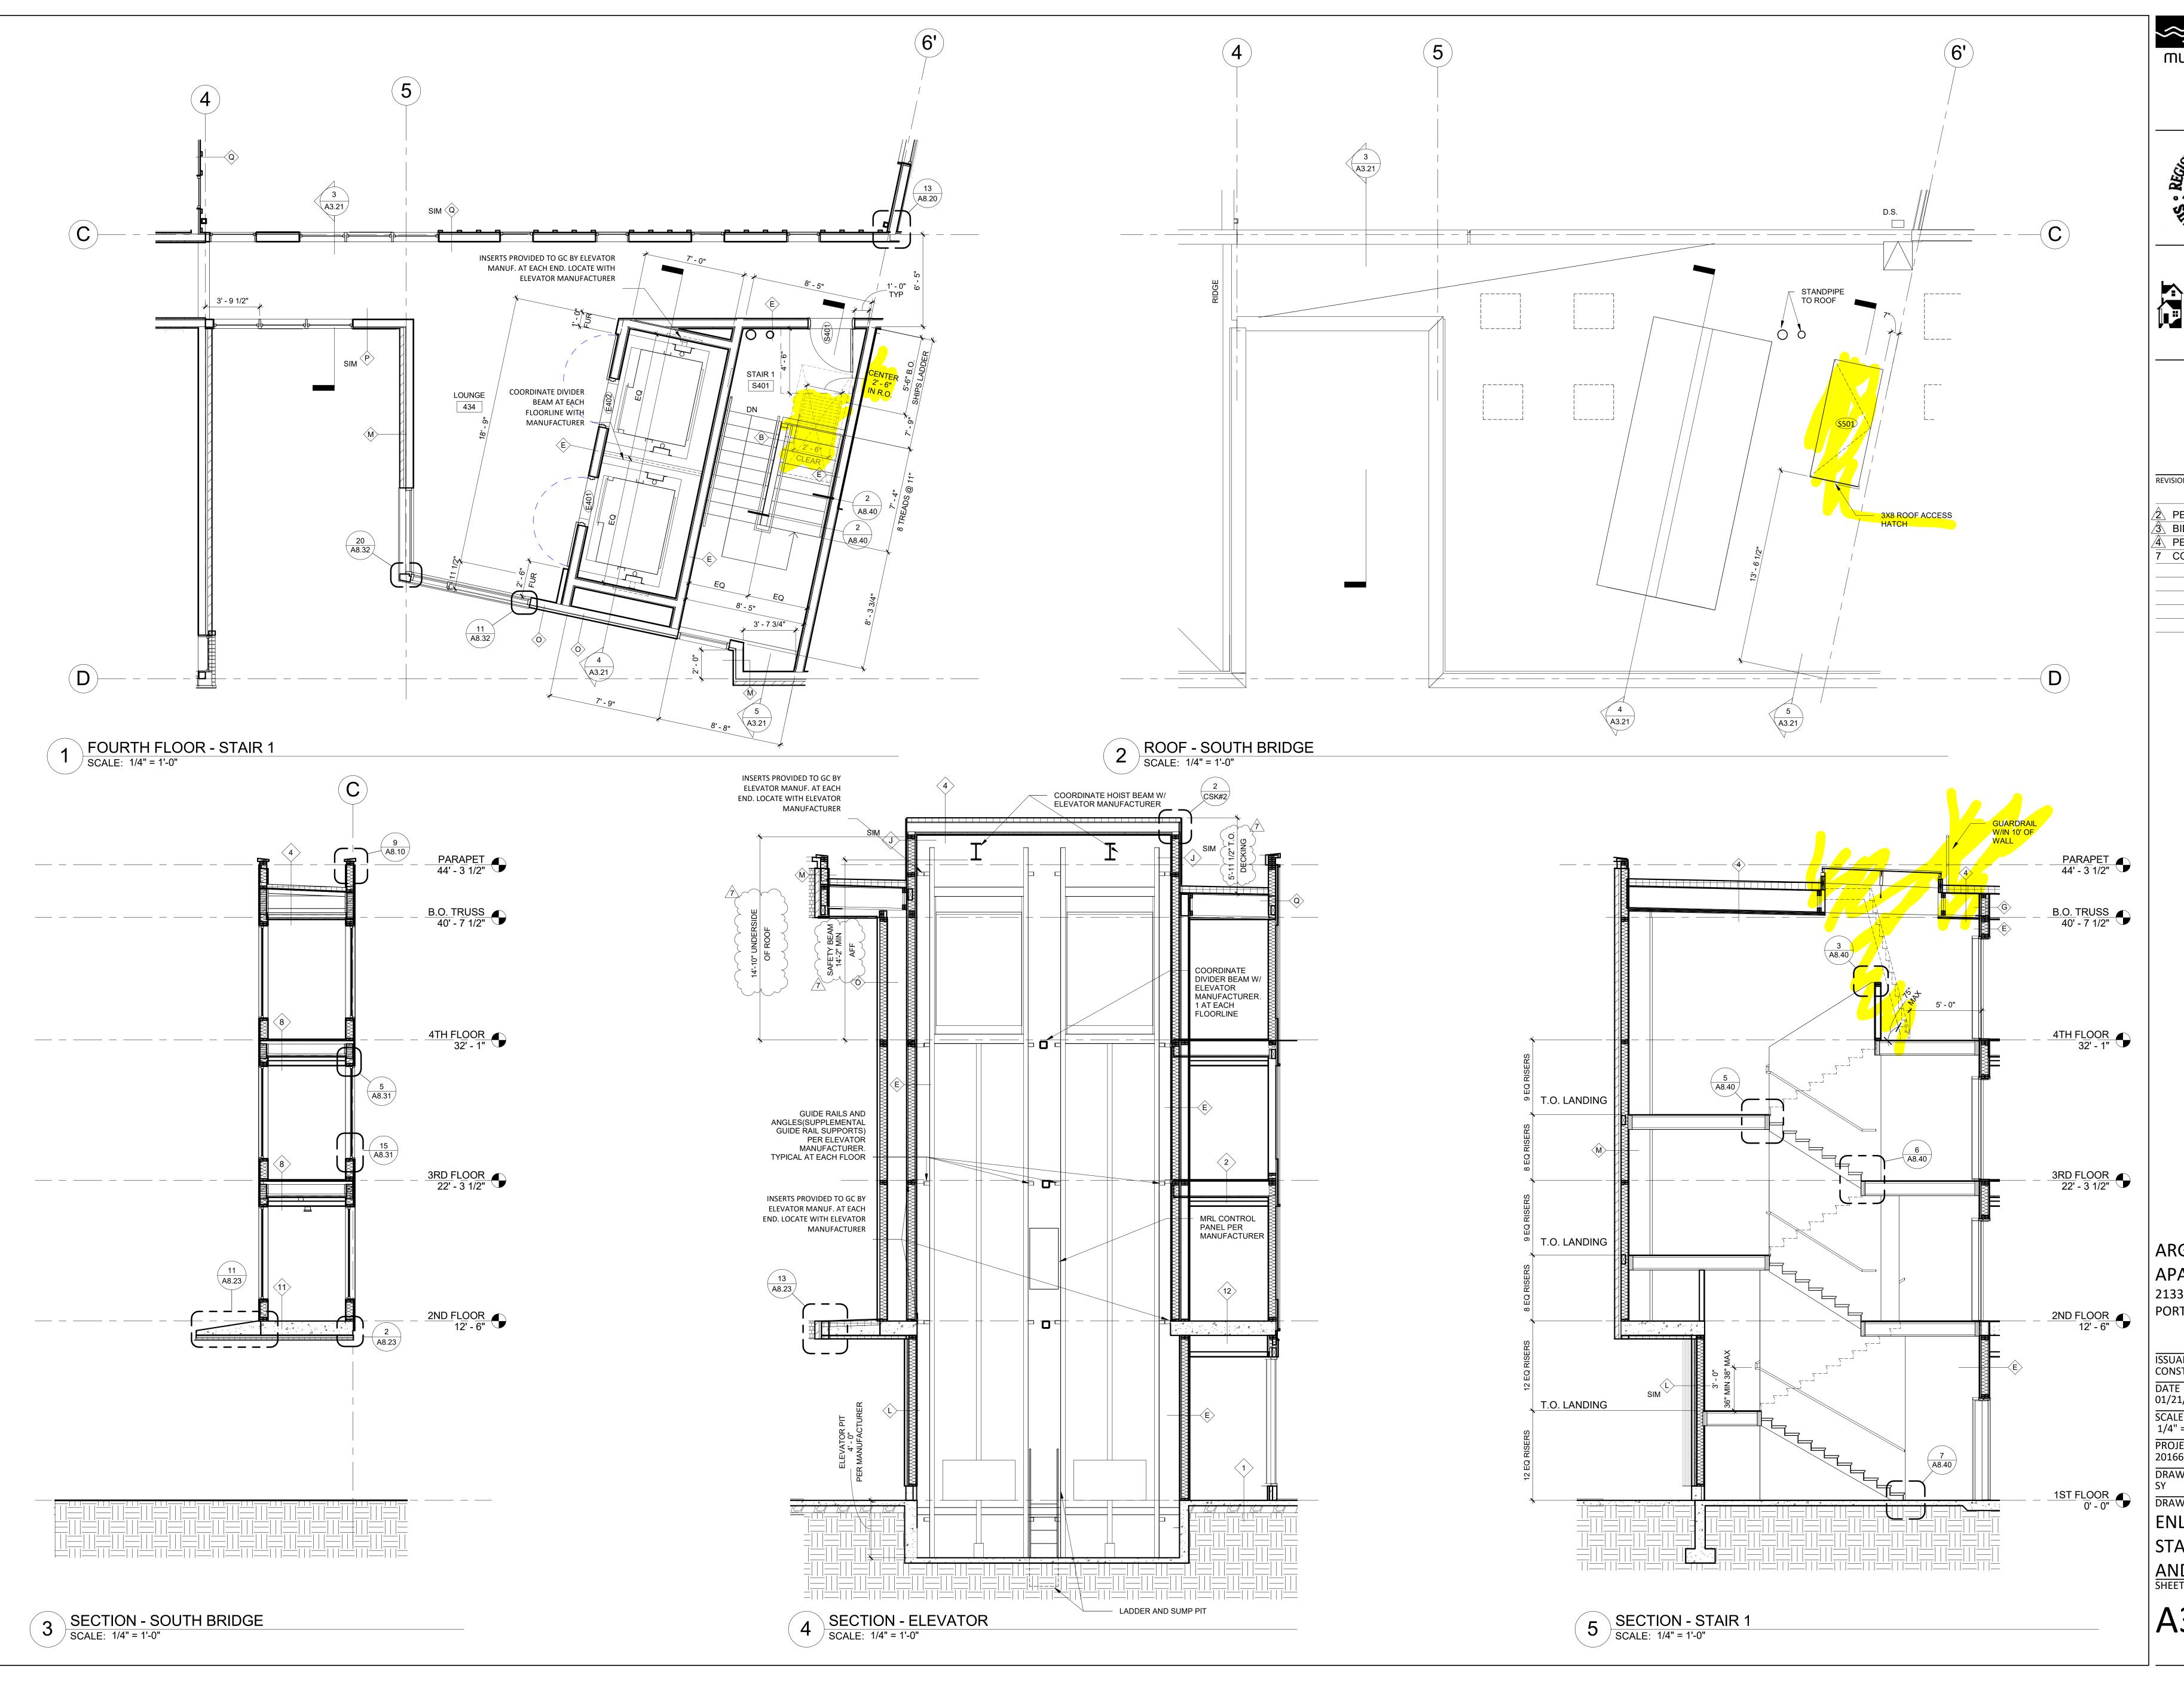

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PERMIT REV1 11/02/18

BID SET 11/19/18

PERMIT REV2 12/05/18

CONST. REV.

ARGYLE
APARTMENTS
2133 N ARGYLE STREET
PORTLAND, OR 97217

ISSUANCE
CONSTRUCTION SET

DATE
01/21/2019

SCALE
1/4" = 1'-0"


PROJECT NUMBER
201663.00

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DRAWING TITLE

DRAWING TITLE
ENLARGED
STAIR PLANS
AND SECTION
SHEET NUMBER

A3.21

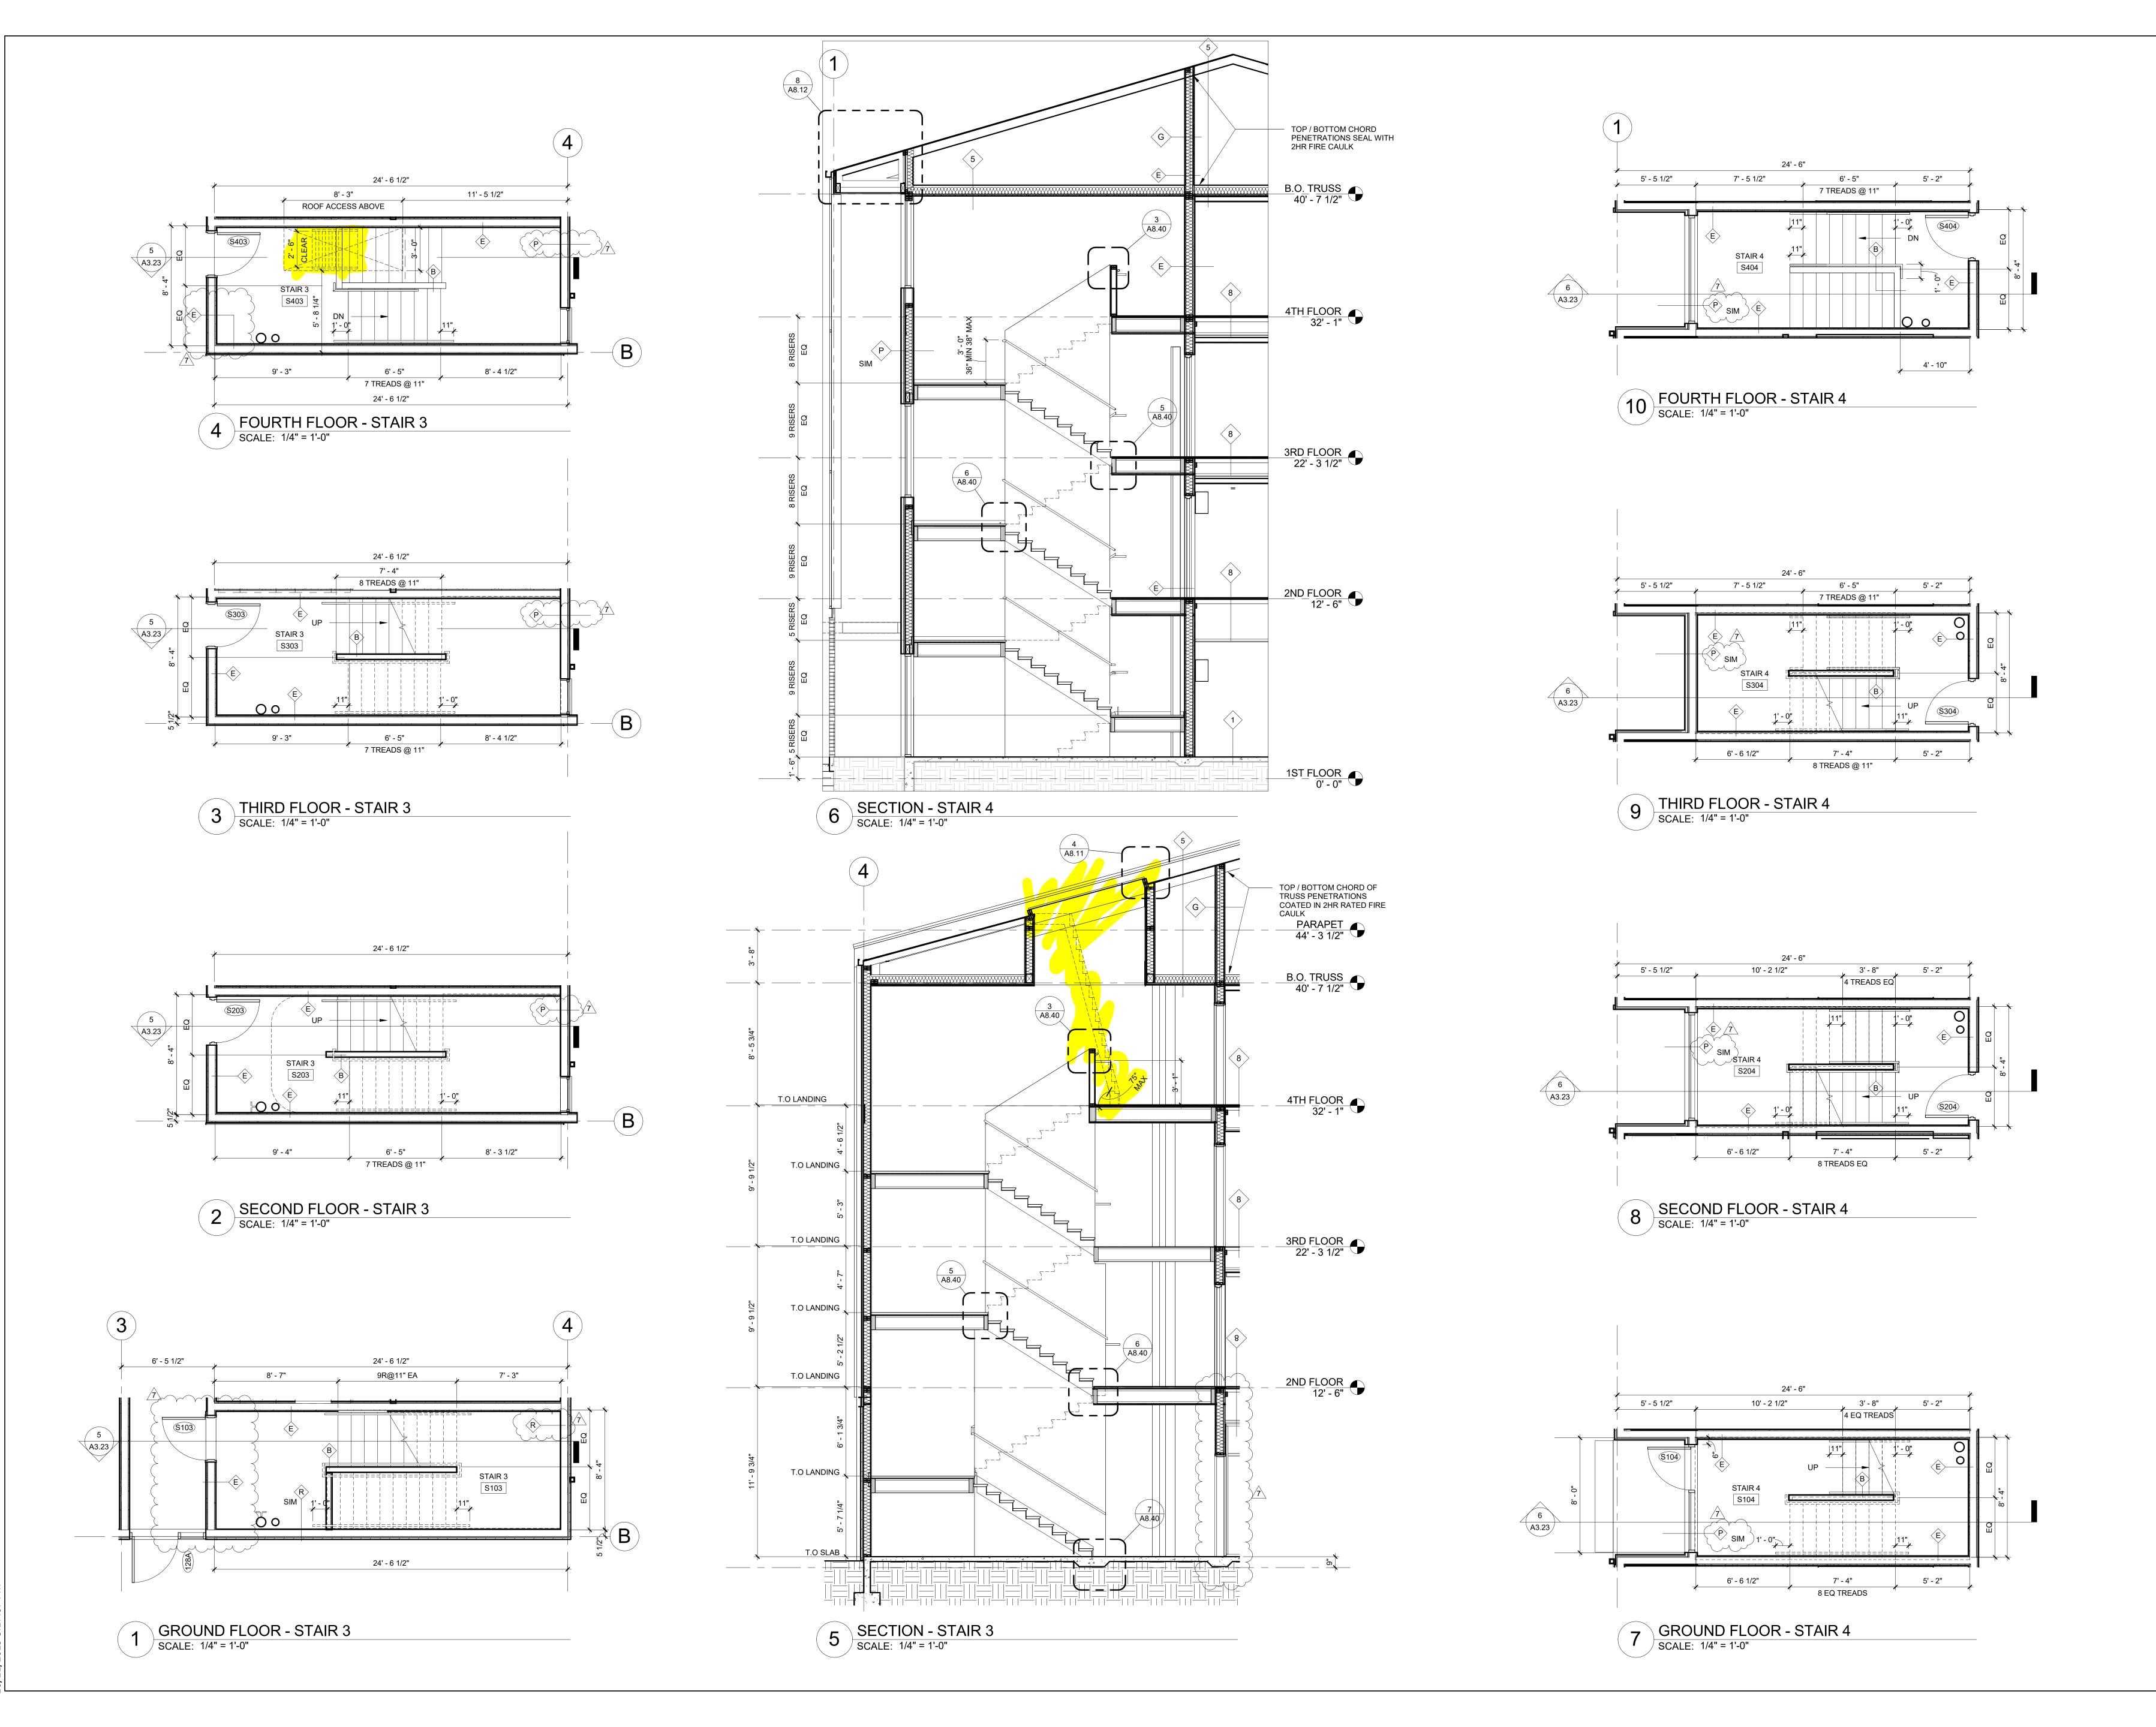

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PERMIT REV1 11/02/18

3 BID SET 11/19/18

4 PERMIT REV2 12/05/18

CONST. REV.

ARGYLE

APARTMENTS

2133 N ARGYLE STREET
PORTLAND, OR 97217

ISSUANCE
CONSTRUCTION SET

DATE
06/14/2019

SCALE
1/4" = 1'-0"

PROJECT NUMBER
201663.00

DRAWN BY
SY

DRAWING TITLE

ENLARGED

STAIR PLANS

AND SECTION
SHEET NUMBER

A3.23

