Development Services

From Concept to Construction



Phone: 503-823-7300 Email: bds@portlandoregon.gov 1900 SW 4th Ave, Portland, OR 97201 More Contact Info (http://www.portlandoregon.gov//bds/article/519984)

APPEAL SUMMARY	
Status: Decision Rendered	
Appeal ID: 22200	Project Address: 4029 SW Hamilton St, Lot 1
Hearing Date: 12/11/19	Appellant Name: Adam Monkaba
Case No.: P-001	Appellant Phone: 248-229-4912
Appeal Type: Plumbing	Plans Examiner/Inspector: McKenzie James, Jim Bechte Joe Blanco, Jessica Ruch
Project Type: residential	Stories: 2 Occupancy: R-3 Construction Type: V
Building/Business Name:	Fire Sprinklers: No
Appeal Involves: Erection of a new structure	LUR or Permit Application No.: 19-118250-LU
Plan Submitted Option: pdf [File 1]	Proposed use: Single family

APPEAL INFORMATION SHEET

Appeal item 1

Appear item 1	
Code Section	308.0
Requires	308.0 Location.
	Except as otherwise provided in this code, no plumbing system, drainage system, building sewer, private sewage disposal system, or parts thereof shall be located in any lot other than the lot that is the site of the building, structure, or premises served by such facilities.
Proposed Design	The lot is proposed to be sub-divided into three parcels and a shared tract. Two new lots will be for future houses and a third lot for the existing residence. The houses will all utilize the same shared private driveway in a separate tract. The site improvements will include 2 new residences on separate properties that would each include a paved driveway and various hardscaping elements around the houses. The existing driveway into the site will be reconstructed to be a 20' wide
	shared driveway and extend approximately 260' north from SW Hamilton.
	The proposed stormwater system for the new development is proposed to use shared stormwater pipes within the shared tract that drain to a single shared stormwater planter designed to meet the SWMM requirements. The planter will be located at the southwest corner of the site next to the driveway at the lowest part of the site. Stormwater from the planter will be slowly released through an orifice and discharge offsite to the public street ditch.
Reason for alternative	The proposed shared design is more efficient and effective than a separate storm system for each new lot and the shared tract and since the "shared" portions of the storm system all reside within the shared tract used by all residents, maintenance will be a shared responsibility.

https://www.portlandoregon.gov/bds/appeals/index.cfm?action=entry&appeal_id=22200

Appeals | The City of Portland, Oregon

Code Section	Chapter 3: Section 312.0
Requires	312.0 Independent Systems
	The drainage system of each new building and of new work installed in any existing building shall
	be separate and independent from that of any other building, and, when available, every shall
	have an independent connection with a public or private sewer.
	Exception: Where one building stands in the rear of another building on an interior lot, and no
	private sewer is available
	or can be constructed to the rear building through an adjoining court, yard, or driveway, the
	building drain from the front building shall be permitted to be extended to the rear of the building.
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	private driveway in a separate tract. The site improvements will include 2 new residences on
	separate properties that would each include a paved driveway and various hardscaping elements
	around the houses. The existing driveway into the site will be reconstructed to be a 20'
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	SWMM requirements.
	The planter will be located at the southwest corner of the site next to the driveway at the lowest
	part of the site. Stormwater from the planter will be slowly released through an orifice and
	discharge offsite to the public street ditch.
Reason for alternative	The proposed shared design is more efficient and effective than a separate storm system for each
	new lot and the shared tract and since the "shared" portions of the storm system all reside within
	the shared tract used by all residents, maintenance will be a shared responsibility.

APPEAL DECISION


1. Shared stormwater lines on shared tract: Granted provided the easement is reviewed and approved by Bureau of Development Services prior to recording. Appellant shall contact Jessica Ruch (503-823-4162) for information.

2. Shared stormwater planter drainage system: Granted provided the easement is reviewed and approved by Bureau of Development Services prior to recording.

Appellant shall contact Jessica Ruch (503-823-4162) for information.

The Administrative Appeal Board finds with the conditions noted, that the information submitted by the appellant demonstrates that the approved modifications or alternate methods are consistent with the intent of the code; do not lessen health, safety, accessibility, life, fire safety or structural requirements; and that special conditions unique to this project make strict application of those code sections impractical.

Pursuant to City Code Chapter 24.10, you may appeal this decision to the Building Code Board of Appeal within 90 calendar days of the date this decision is published. For information on the appeals process, go to www.portlandoregon.gov/bds/appealsinfo, call (503) 823-7300 or come in to the Development Services Center.

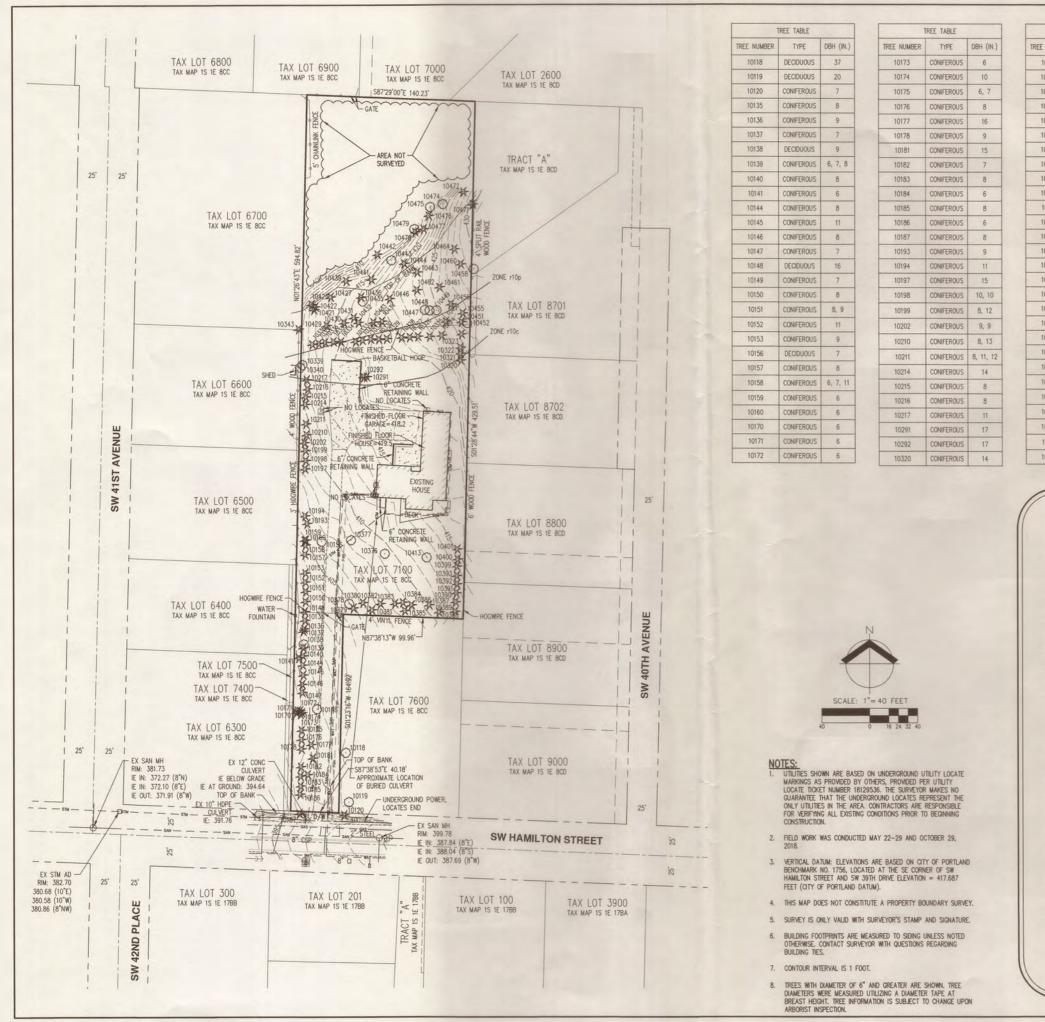


TREE TABLE					
NUMBER	TYPE	DBH (IN.)			
0321	12				
0322	CONIFEROUS	19			
0323	CONIFEROUS	13			
0324	CONIFEROUS	16			
0325	CONIFEROUS	13			
0326	CONIFEROUS	18			
0327	CONIFEROUS	21			
0328	CONIFEROUS	18			
0329	CONIFEROUS	17			
0330	CONIFEROUS	19			
0331	CONIFEROUS	14			
0332	CONIFEROUS	14			
0333	CONIFEROUS 25				
0334	CONIFEROUS 9				
0335	CONIFEROUS	15			
0336	CONIFEROUS	15			
0337	CONIFEROUS	9			
0338	CONIFEROUS	20			
0339	DECIDUOUS	7			
0340	DECIDUOUS	6			
0343	CONIFEROUS	7			
0376	DECIDUOUS	7, 8			
0377	DECIDUOUS	12			
0378	DECIDUOUS	7, 8, 11			
0379	CONIFEROUS	7			
0380	CONIFEROUS	7, 9			
0381	CONIFEROUS	7, 8			
0382	CONIFEROUS	7			

and the second second					
1	TREE TABLE				
TREE NUMBER	TYPE	DBH (IN.)			
10383	CONIFEROUS	7			
10384	CONIFEROUS	7			
10385	CONIFEROUS	8			
10386	CONIFEROUS	6, 8			
10387	CONIFEROUS	6, 8			
10388	CONIFEROUS	9			
10389	CONIFEROUS	8			
10390	CONIFEROUS	9			
10391	CONIFEROUS	10			
10392	CONIFEROUS	6			
10393	CONIFEROUS	13			
10399	CONIFEROUS	10			
10400	CONIFEROUS	6			
10401	CONIFEROUS	14			
10413	DECIDUOUS	9, 9			
10421	CONIFEROUS	23			
10422	CONIFEROUS	15			
10423	CONIFEROUS	26			
10427	CONIFEROUS	35			
10429	CONIFEROUS	21			
10430	CONIFEROUS	22			
10431	CONIFEROUS	7			
10432	CONIFEROUS	16			
10433	CONIFEROUS	21			
10434	CONIFEROUS	12			
10435	DECIDUOUS	18			
10436	CONIFEROUS	7			
10439	CONIFEROUS	33			

	TREE TABLE	
TREE NUMBER	TYPE	DBH (IN.)
10441	CONIFEROUS	13
10442	CONIFEROUS	45
10443	DECIDUOUS	11
10444	CONIFEROUS	6
10446	CONIFEROUS	28
10447	DECIDUOUS	6
10448	DECIDUOUS	23
10449	DECIDUOUS	23
10450	CONIFEROUS	13
10451	CONIFEROUS	11
10452	DECIDUOUS	15, 15
10455	CONIFEROUS	14
10456	CONIFEROUS	20
10458	DECIDUOUS	9
10460	CONIFEROUS	16
10461	CONIFEROUS	20
10462	CONIFEROUS	25
10463	CONIFEROUS	23
10464	CONIFEROUS	25
10471	CONIFEROUS	29
10472	CONIFEROUS	29
10474	DECIDUOUS	12
10475	DECIDUOUS	13
10476	CONIFEROUS	.24
10477	CONIFEROUS	35
10478	CONIFEROUS	9
10479	DECIDUOUS	14

WS BNONKERBNG & FORSTRY, LLC ANS BNONKERBNG & FORSTRY, LLC 12865 SW HERMAN RD STE 100 IUALATIN, OR 97062 P. 50.565.1651	OREGON BRIGGON BRINGERING - SURVEYING - NATURAL RESOURCES AUTINOMAH COUNTY TAX MAP IS TE 800 FORESTRY - PLANNING - LANDSCAPE ARCHITECTURE
4029 SW HAMILTON ROAD AS ENAMERANG & PORSTRY, UC 12865 SW HAMILTON ROAD 12865 SW HERAW RD STE TOD 104ATIN, OR 97052 P. 503556151	
STING CONDITIONS 4029	PLAN PORTLAND
	ZJG SMG AS NOTED J/2019 STERED SSIONAL JURVEYOR M. J. L. B M. J. L. B M. J. L. B M. J. L. B SIONAL SSI
6 SF	NUMBER 811 HEET) 1

		LEGEND	
Ð	KISTING		EXISTING
DECIDUOUS TREE	0	STORM SEWER CLEAN OUT	0
	X	STORM SEWER CATCH BASIN	D
CONIFEROUS TREE	谈	STORM SEWER AREA DRAIN	D
FIRE HYDRANT	Q	STORM SEWER MANHOLE	0
WATER BLOWOFF	9	GAS METER	
WATER METER		GAS VALVE	101
WATER VALVE	M	GUY WIRE ANCHOR	-
DOUBLE CHECK VALVE	88	UTILITY POLE	-0-
AIR RELEASE VALVE	, p°	POWER VAULT	P
SANITARY SEWER CLEAN OUT	0	POWER JUNCTION BOX	
SANITARY SEWER MANHOLE	0	POWER PEDESTAL	0
SIGN	-0-	COMMUNICATIONS VAULT	C
STREET LIGHT	\$	COMMUNICATIONS JUNCTION BOX	
MAILBOX	(ME)	COMMUNICATIONS RISER	0
	EXIS	TING	
RIGHT-OF-WAY LINE		D/W	DRIVEWAY ENTRANCE
BOUNDARY LINE			
PROPERTY LINE			
CENTERLINE			
DITCH		, _	
CURB	A		
EDGE OF PAVEMENT			
EASEMENT			
FENCE LINE	-000		
GRAVEL EDGE			
POWER LINE	PBR		
OVERHEAD WIRE	OHE		
COMMUNICATIONS LINE	com-	com	
FIBER OPTIC LINE			
GAS LINE	as_	GAS	
STORM SEWER LINE	stw	5TM	
SANITARY SEWER LINE	SAN		
SANITARY SEWER LINE WATER LINE	SAN	SAN	

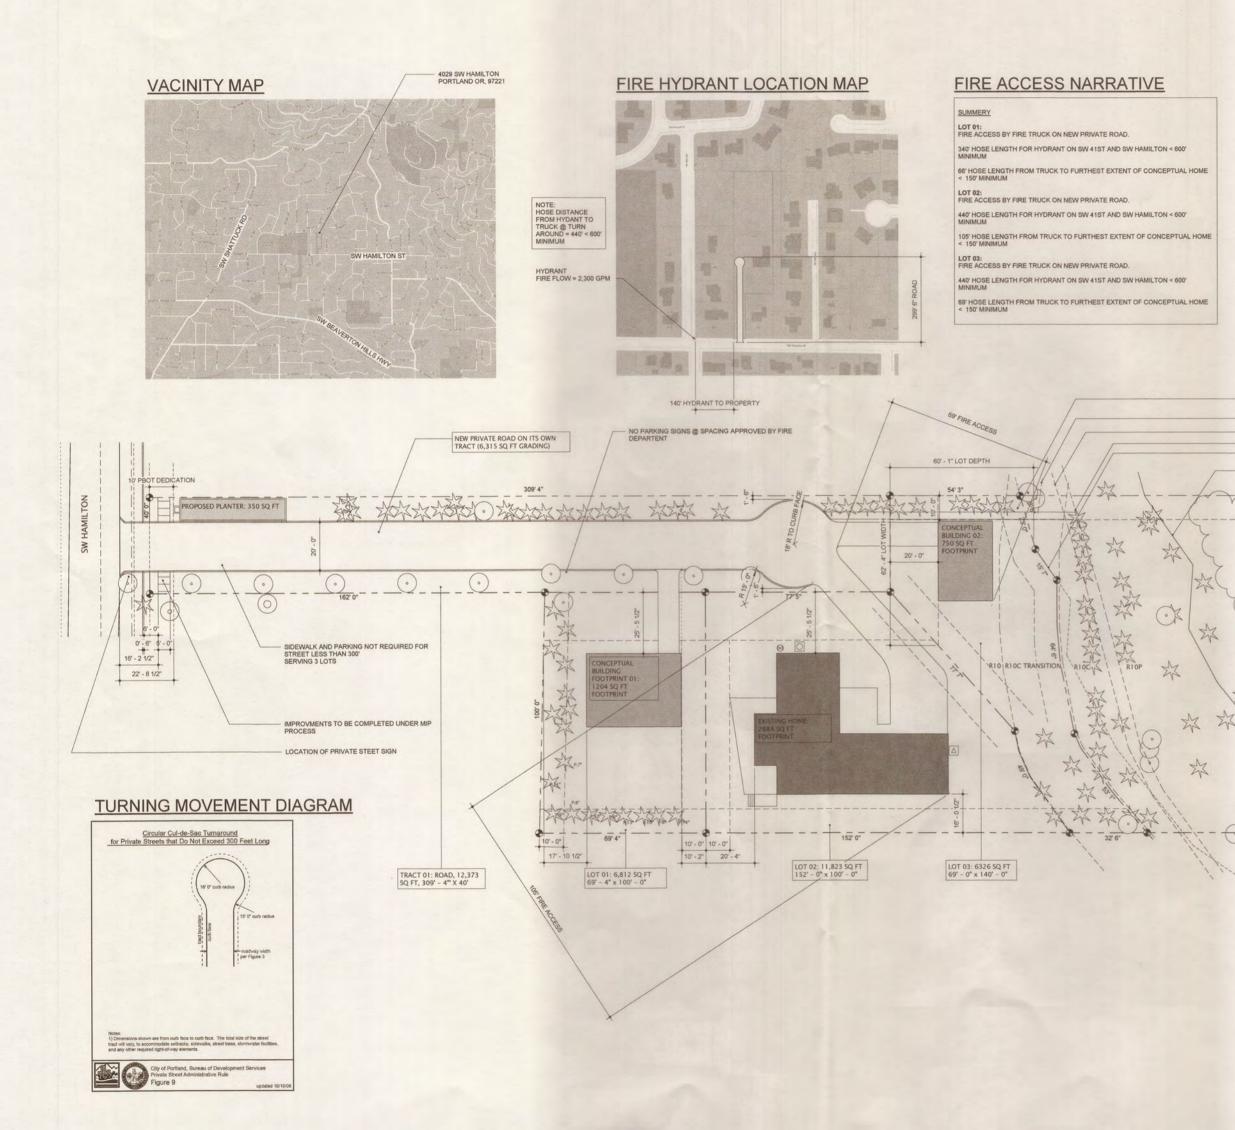

ENVIRONMENTAL STANDARDS NARRATIVE

SUMMERY OF STANDARDS OF 33.430.160

- A. ALL DEVELOPMENT IS OUTSIDE THE RESOUCE AREA OF THE ENVIRMENTAL PROTECTION ZONE.
- B. THERE IS NO EXISTING HOME IN THE ENVIRONMENTAL PROTECTION ZONE.

C. THE ENTIERTY RESOUCE AREA IS LOCATED IN PROTECTED TRACT 02 WHICH WILL BE CO OWNED IN COMMON BY ALL THE OWNERS OF THE LAND DIVISION SITE.

D. THE TOTAL AMOUNT OF DISTURBANCE IN THE RESOURCE AREA IS ZERO.

E. ALL RESOUCE AREA OUTSIDE ANY DESIGNATED DISTURBANCE AREA IS LOCATED IN PROTECTED TRACT 02 WHICH WILL BE CO OWNED IN COMMON BY ALL THE OWNERS OF THE LAND DIVISION SITE.

- 1. NO NATIVE TREES ARE REMOVED FROM THE RESOUCE AREA. NO NATIVE TREE'S ROOT PROTECTION ZONES ARE DISTURBED
- 2. NO NON-NATIVE TREES ARE REMOVED FROM THE RESOUCE AREA. NO NON-NATIVE TREE'S ROOT PROTECTION ZONES ARE DISTURBED

3. NO NUISANCE TREES ARE REMOVED FROM THE RESOUCE AREA. NO NUISANCE TREE'S ROOT PROTECTION ZONES ARE DISTURBED

G. THE STANDARDS OF 33.430.140 B,C,K-R ARE ALL MET AT THERE IS NO DISTURBANCE, ROMOVAL OR PLANTING TAKING PLACE IN THE RESOUCE AREA OR WITHIN 50' OF ANY BODY OF WATER OR TOP OF BANK. H. NO STREETS, ALLEYS, WALKWAYS OR STORMWATER FACILITES ARE PROPOSED WITHIN 50 OF ANY IDENTIFIED WETALND OR WATER BODY.

I, RIGHT AWAY AND ROADWAY WIDTHS TO NOT EXCEED MAXIMUMS

J. NO UTILITIES ARE IN THE RESOURCE AREA

NOTE: NO NEW BUILDING SHALE EXCEED

10' WIDE EASEMENT THROUGH WEST EDGE OF LOT FOR ACCESS TO ENVIRONMENTAL RESOUCE AREA - REAR SETBACK 5' FROM R10P R10P

50' FROM TOP OF BANK

231'6'

TOP OF BANK

(.

XX

TRACT 02: ENVIRONMEN 29,366 SQ FT 200' x 140' MENTAL ZONE

X

Ser 1

240

175' 1

0

Zis

1 UTILITY & STORMWATER PLAN 1" = 20'-0" €N

4029 SW HAMILTON


4029 SW Hamilton St portland OR, 97221

DATE: ISSUE:

07/31/2019 Land Divisio REVISION: DESCRIPTION:

SHEET TITLE: PRELIMINARY LAND DIVISION AND PROPOSED IMPROVEMENTS PLAN

A1.01

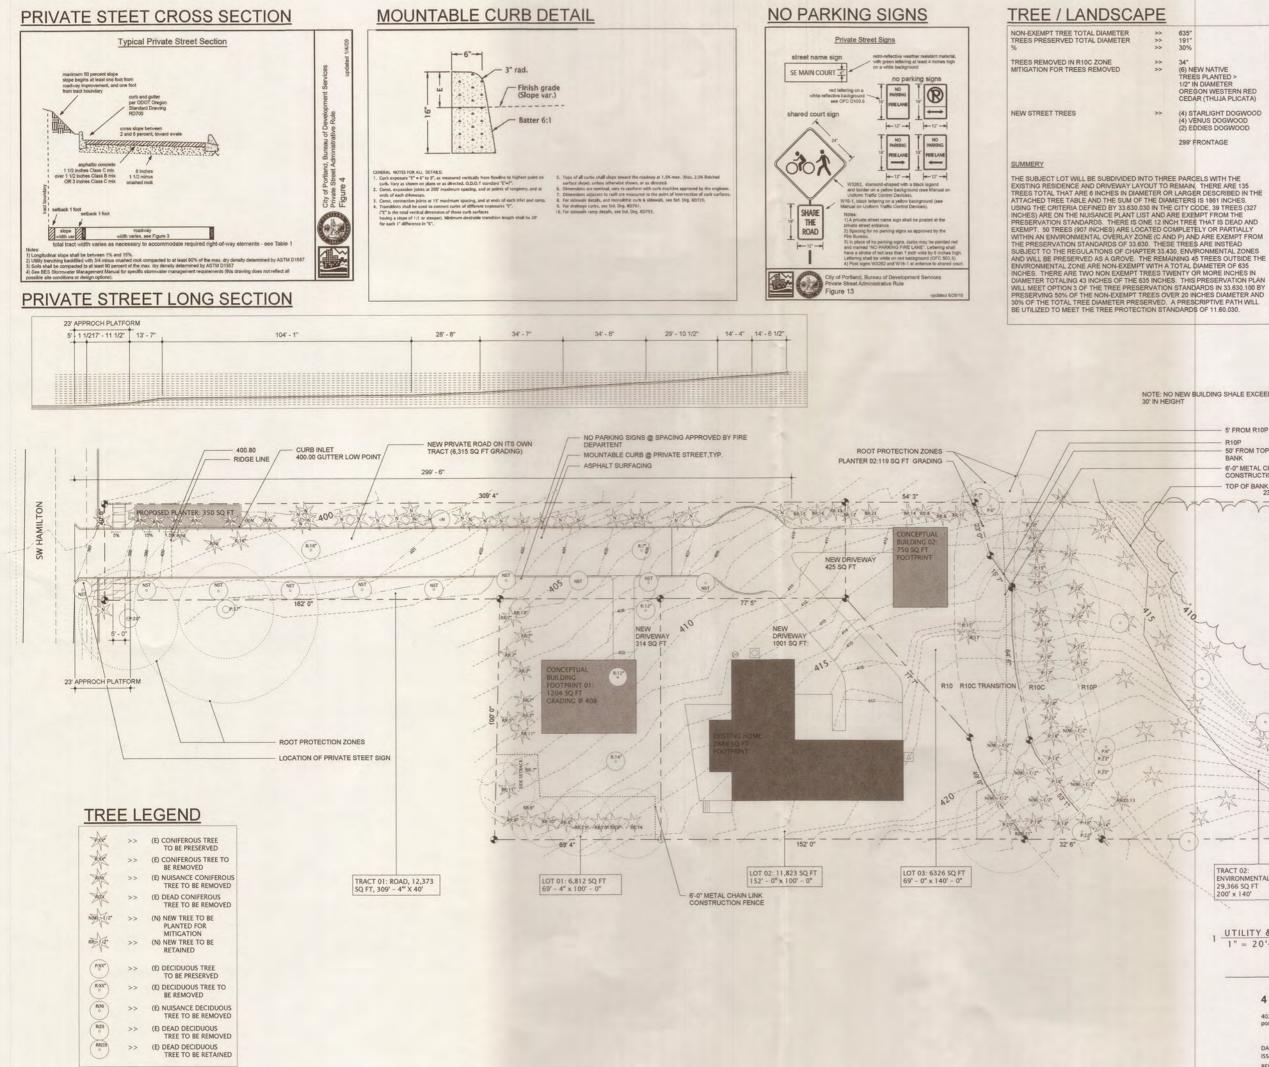

>	191"
>	30%
>	34"
>	(6) NEW NATIVE
	TREES PLANTED >
	1/2" IN DIAMETER
	OREGON WESTERN RED
	CEDAR (THUJA PLICATA)

635"

(4) STARLIGHT DOGWOOD (4) VENUS DOGWOOD (2) EDDIES DOGWOOD

299' FRONTAGE

GRADING

SQUARE FOOTAGE TO BE CLEARED):	
CONCEPTUAL BUILDING 01	>>	1204 SQ FT
CONCEPTUAL BUILDING 02	>>	750 SQ FT
CONCEPTUAL BUILDING 01 DRIVE	>>	94 SQ FT
CONCEPTUAL BUILDING 02 DRIVE	>>	260 SQ FT
PLANTER 01	>>	485 SQ FT
NEW PRIVATE ROAD	>>	3250 SQ FT
TOTAL SQ FT TO BE GRADED	>>	6043 SQ FT
SOIL TO BE DISTERBED:		
CONCEPTUAL BUILDING 01	>>	100 CUBIC YARDS CUT
CONCEPTUAL BUILDING 02 DRIVE	>>	1.5' CUBIC YARDS FILL
CONCEPTUAL BUILDING 02	>>	62 CUBIC YARDS CUT
CONCEPTUAL BUILDING 02 DRIVE	>>	2 CUBIC YARDS FILL
EXISTING BUILDING NEW DRIVE	>>	2.5 CUBIC YARDS CUT
		6 CUBICS YARDS FILL
NEW PRIVATE ROAD & PLANTER	>>	100 CUBIC YARDS CUT
		120' CUBIC YARDS FILL
TOTAL SQ FT TO BE GRADED	>>	264.5 CUBIC YARDS CUT
		129.5 CUBIC YARDS FILL
	CONT	
EXISTING		
NEW CON	ITOURS	

NOTE: NO NEW BUILDING SHALE EXCEED 30' IN HEIGHT

5' FROM R10P - R10P - 50' FROM TOP OF BANK 6'-0" METAL CHAIN LINK CONSTRUCTION FENCE TOP OF BANK 231' 6"

5-



TRACT 02: ENVIRONMEN 29,366 SQ FT 200' x 140' ENTAL ZONE

1 UTILITY & STORMWATER PLAN

4029 SW HAMILTON

4029 SW Hamilton S portland OR, 97221

ISSUE: REVISION:

07/31/2019 Land Divisio DESCRIPTION

SHEET TITLE: GRADING, STREET, AND TREE PLAN


SHEET NO.

A1.02

AREA SUMMARY / STORM

TOTAL LOT AREA	>>	66722 SQ FT	
TOTAL BUILDING COVERAGE	>>	4799 SQ FT	
TOTAL PAVING	>>	8865 SQ FT	
TOTAL IMPERVIOUS AREA:	>>	13664 SQ FT	
CONCEPTUAL BUILDING 01: IMPERVIOUS AREA:			
ROOF	>>	1205 SQ FT	
PAVING	>>	315 SQ FT	
TOTAL	>>	1520 SQ FT	
CONCEPTUAL BUILDING 02:			
ROOF	>>	750 SQ FT	
PAVING	>>	425 SQ FT	
TOTAL	>>	1235 SQ FT	
EXISTING BUILDING:			
	>>	2844 SQ FT	
ROOF			
PAVING	>>	1810 SQ FT 4654 SQ FT	
TOTAL IMPERVIOUS AREA	>>	4654 SQ F1	
RODE:			
PAVING	>>	6315 SQ FT	
TOTAL IMPERVIOUS AREA	>>	6315 SQ FT	
INFILTRATION PLANTER:	>>	350 SQ FT	

SYN	IBO	LS LEGEND
	>>	COMMUNICATIONS RISER
0	>>	GAS METER
0	>>	WATER VALVE
	>>	POWER JUNCTION BOX

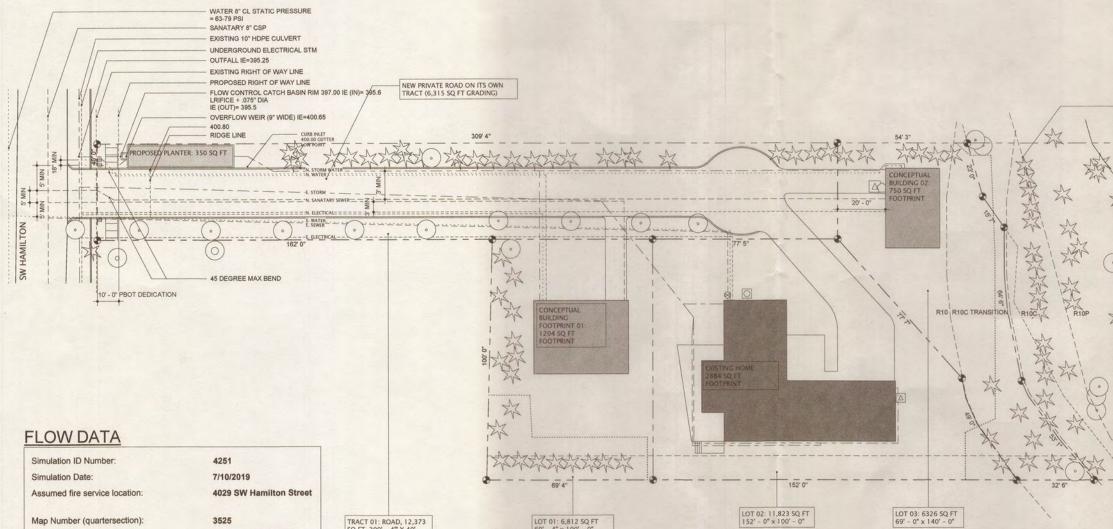

LOT 01: 6,812 SQ FT 69' - 4" x 100' - 0"

TRACT 01: ROAD, 12,373 SQ FT, 309' - 4"' X 40'

Map Number (quartersection):

Assumed fire service elevation:

Maximum Static Pressure:

ESTIMATED FLOW:

Maximum Static Hydraulic Grade Line:

STATIC PRESSURE to use for design:

ESTIMATED RESIDUAL PRESSURE:

(in the system, with the simulated flow)

(80% of the nominal max static pressure)

Pressure Zone:

Main size:

3525

8 inch

400 feet

585 feet


80 psi


64 psi


2500 gpm


28 psi


VERMONT 585 TANK

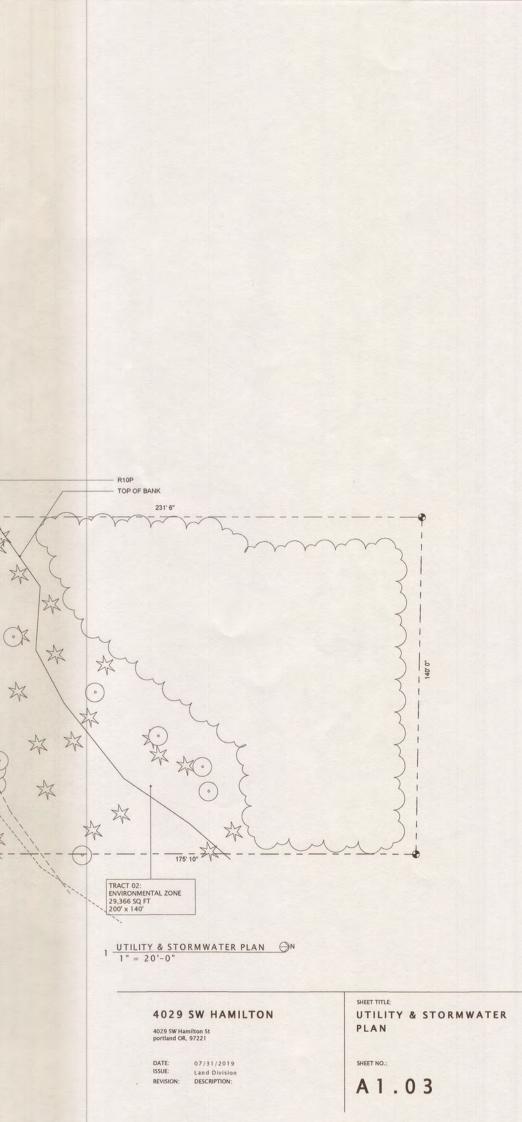

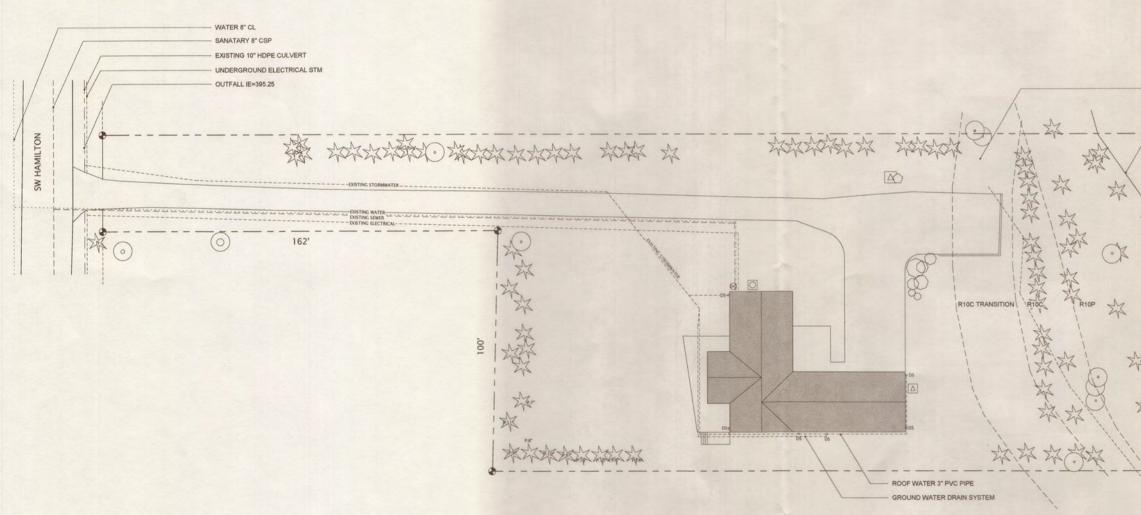

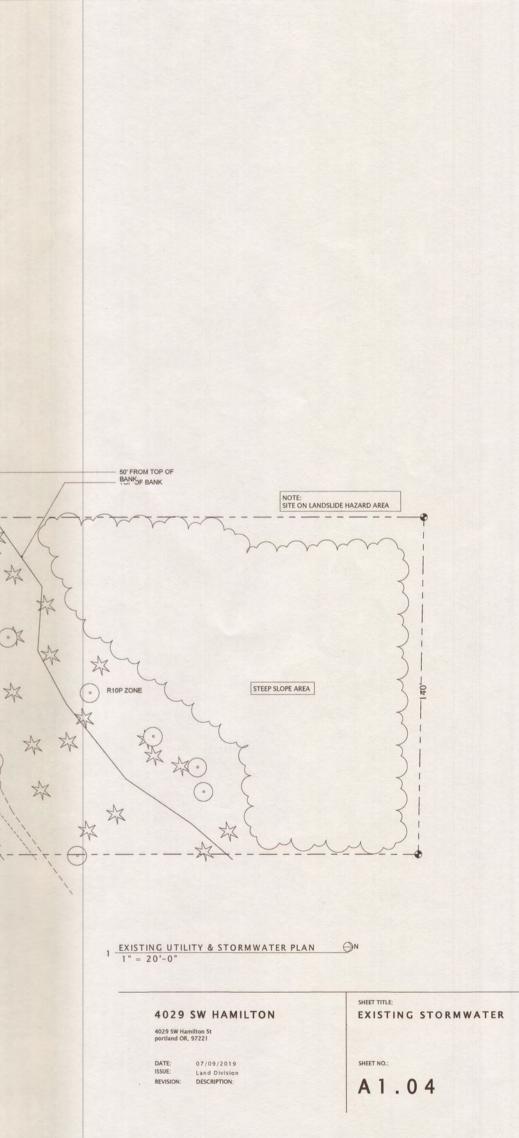

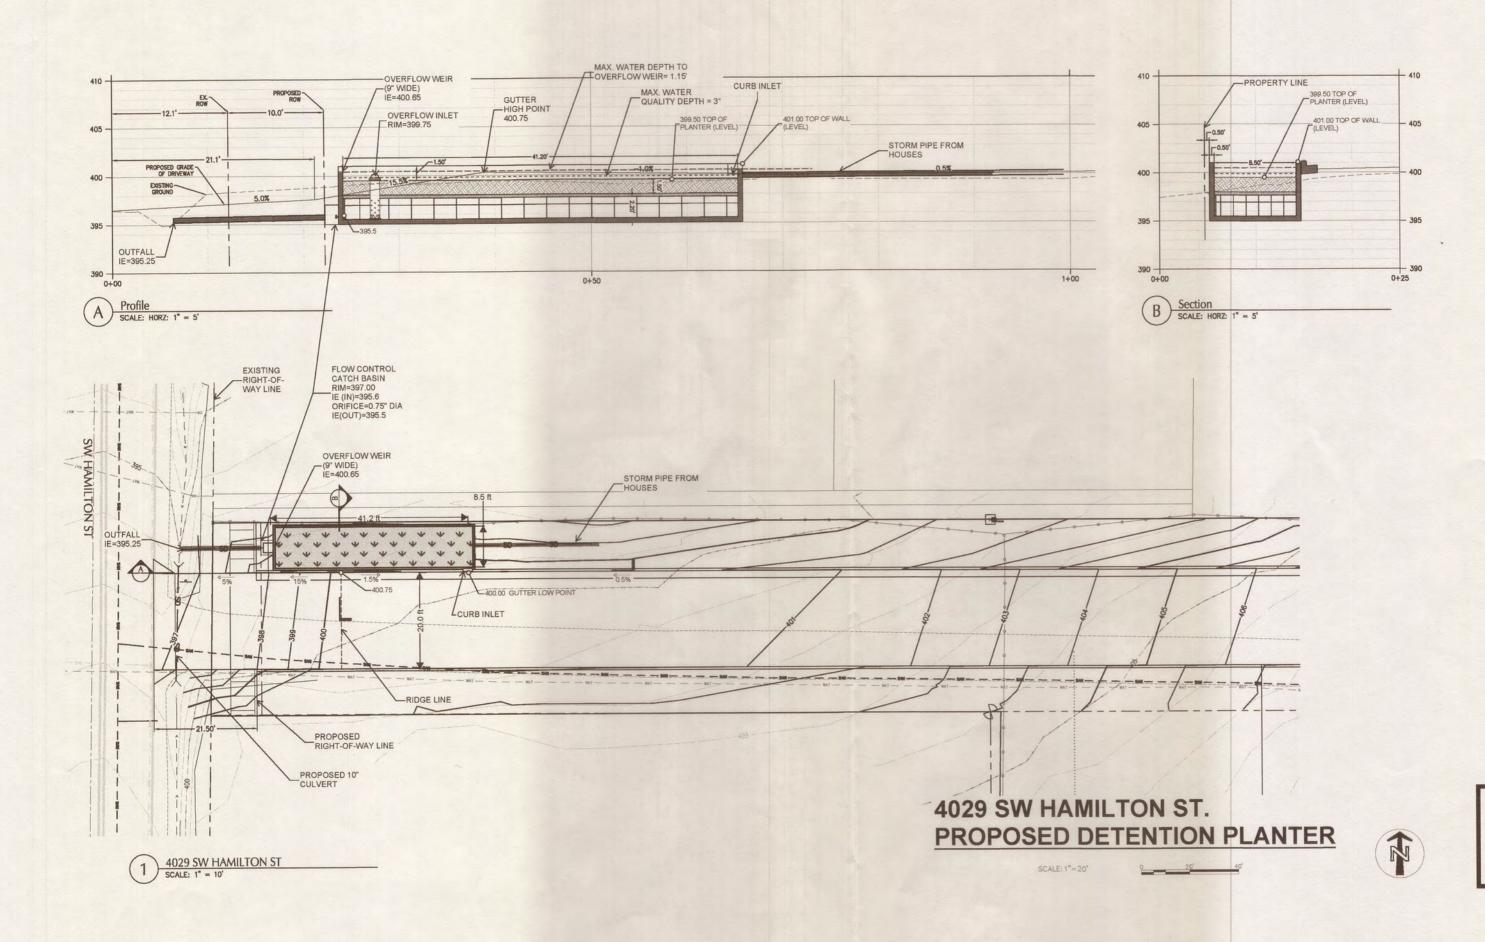

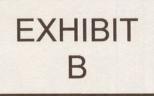

4029 SW HAMILTON

4029 SW Hamilton St portland OR, 97221

DATE: ISSUE: REVISION:

07/09/2019 Land Division DESCRIPTION: SHEET TITLE:

SHEET NO .:

A1.05