#### **Development Services**

#### From Concept to Construction







#### APPEAL SUMMARY

Appeal ID: 20415	Project Address: 3506 SE 119th Ave
Hearing Date: 5/22/19	Appellant Name: Sasha Beckwith
Case No.: B-004	Appellant Phone: 541-231-6318
Appeal Type: Building	Plans Examiner/Inspector: David Wood, Kris Gutierrez
Project Type: residential	Stories: 1 Occupancy: R-3 Construction Type: Wood Construction
Building/Business Name:	Fire Sprinklers: No
Appeal Involves: Alteration of an existing structure	LUR or Permit Application No.: 18-246235-RS
Plan Submitted Option: pdf [File 1]	Proposed use: Residence and ADU

#### APPEAL INFORMATION SHEET

#### Appeal item 1

**Code Section** 

Requires	Code requirements: Any ceiling heights or projections below 6'-8" must be located at least 3'-0" away from any door leading into the room.
Proposed Design	Request that the main beam of the house can remain within 3' of the doorway to the new ADU even though below the beam is min. of 6'-2" from floor to beam.
Reason for alternative	Moving the door 3' away from beam would ether make the laundry room unusable for both the main house and ADU and restrict access to the mechanical room or it would cut into the living space and kitchen of the ADU. To cut the beam to meet the head height would also require engineering and a significant work considering the space is mostly finished. The door way is designed so that a normal 6'-8" door is installed and can fully swing open inside the ADU and it is only in the one area in front of the door below the beam which has a clearance of 6'-2" min. (which is allowed by this guide for heights below beams).

Residential Construction - ORSC/3/#1 & ORSC/11/#1

#### APPEAL DECISION

Reduction in minimum required headroom to 6 feet 2 inches within 3 feet of entry door: Denied. Proposal does not provide equivalent Life Safety protection.

Appellant may contact John Butler (503 823-7339) with questions.

Pursuant to City Code Chapter 24.10, you may appeal this decision to the Building Code Board of Appeal within 180 calendar days of the date this decision is published. For information on the appeals process and costs,

including forms, appeal fee, payment methods and fee waivers, go to www.portlandoregon.gov/bds/appealsinfo, call (503) 823-7300 or come in to the Development Services Center.

### BUILDING LOCATION

## 3506 SE 119TH AVE PORTLAND OR 97266

(11902 SE POWELL BLVD)

#### CONTRACTOR

#### PROJECT INFORMATION

PROJECT LOCATION: PORTLAND, OREGON 2017 OREGON RESIDENTIAL SPECIALTY CODE

CONSTRUCTION TYPE: WOOD FRAMED

OCCUPANCY GROUP: R-3

ZONING: R-1A (ALTERNATIVE DESIGN DENSITY)

YEAR BUILT: 1947

PROJECT: BASEMENT ADU

#### EXISTING SQ FT (INTERIOR)

- BASEMENT: 451 SQ FT (UNFINISHED)

- MAIN FLOOR: 921.77 SQ FT

- 2ND FLOOR: 185 SQ FT

- (N) BASEMENT ADU: 278 SQ FT

- (N) COMMON SPACE: 154 SQ FT

- (N) MAIN HOUSE: 1106.77 SQ FT

TOTAL LIVING SPACE: 1.384.77 SQ FT

#### INDEX OF DRAWINGS

A - 01: COVER & INFORMATION SHEET

A - 02: SITE PLAN

A - 03: EXISTING: BASEMENT

A - 04: EXISTING: MAIN FLOOR

A - 05: PROPOSED: BASEMENT ADU

A - 06: PROPOSED: MAIN FLOOR ADU

A - 07: SECTIONS

A - 08: DETAILS

#### GENERAL NOTES

- INSULATION:

- WALL: R-15 OR BETTER

- FLAT CEILING: R-49 OR BETTER

- BASEMENT WALLS: R-15 OR BETTER

- WINDOWS U-VALUE: 0.30

- EXTERIOR DOORS U- VALUE: 0.20

- EXTERIOR DOORS WITH >2.5 SQ FT

GLAZING: U-0.40

- EXISTING HEADERS USED UNLESS

NOTED OTHERWISE

#### **ENERGY CODE TABLE N1101.3 SELECTION**

5. SEAL AND PERFORMANCE TEST
THE DUCT SYSTEM

#### **ABBREVIATIONS:**

(N): NEW

(E): EXISTING

TYP.: TYPICAL

FTG.: FOOTING

A.F.F.: ABOYE FINISHED FLOOR

SHTG.: SHEATHING O.C.: ON CENTER CONC.: CONCRETE


BLK'N: BLOCKING

#### REVISION DATE



10/12/18



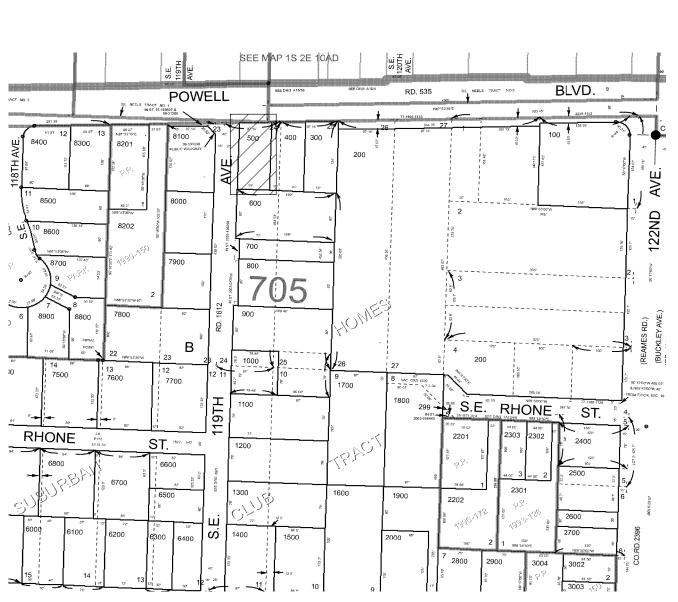



10/12/2018

SCALE:

COVER AND

PROJECT DESCRIPTION: 3506 SE 119TH AVE PORTLAND OR 97266

AWINGS PROVIDED BY: AB DESIGN AND DRAFTING LLC SHA.A.BECKWITH@GMAIL.COM 541-231-6318 SE POMELL BLYD

# **♦**



DATE:

SCALE:

3/32" = 1'-0"


SITE PLAN SHEET TITLE:


PROJECT DESCRIPTION: 3506 SE 119TH AVE PORTLAND OR 97266

DRAWINGS PROVIDED BY: SAB DESIGN AND DRAFTING LLC SASHA.A.BECKWITH@GMAIL.COM 541-231-6318

MODNIM(N) GARAGE 15'-2" × 19'-2" 36'-6 7/8" BEDROOM 10'-11" × 11'-6" BEDROOM 10'-4" × 11'-9" LIVING 12'-1" X 18'-2" (E) STAIRS TO REMAIN 22'-7 1/8" KITCHEN 25'-7" × 7'-9"

## SE 119TH AVE

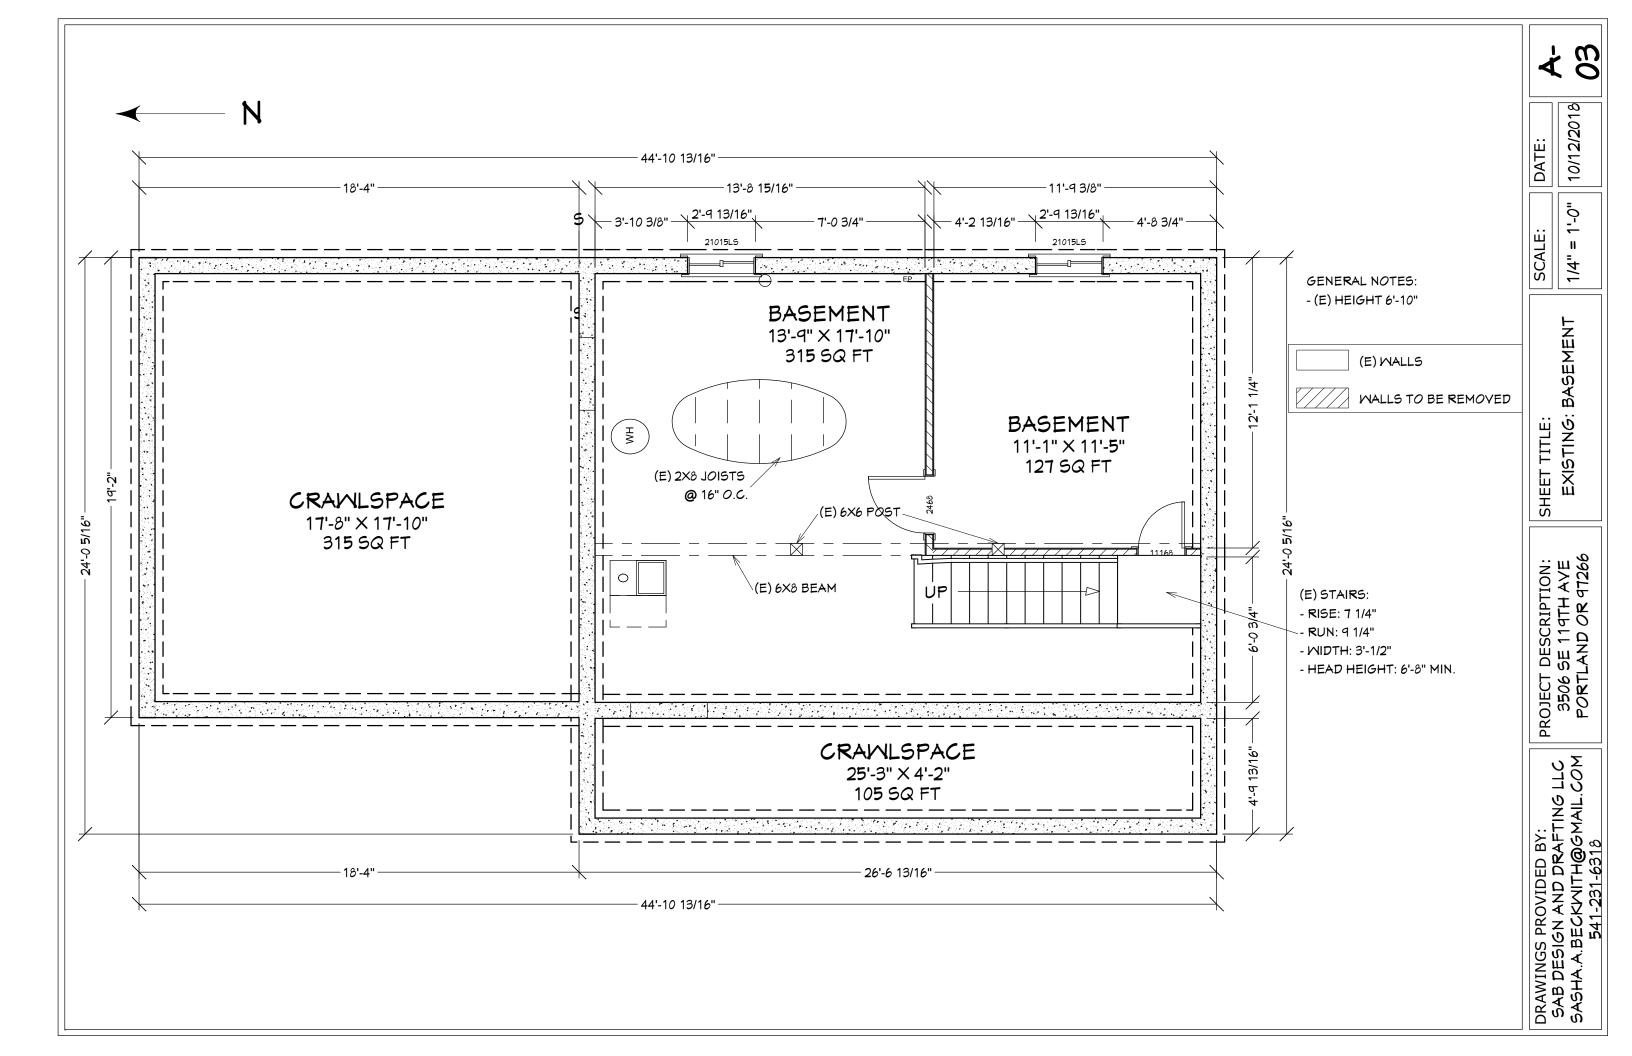

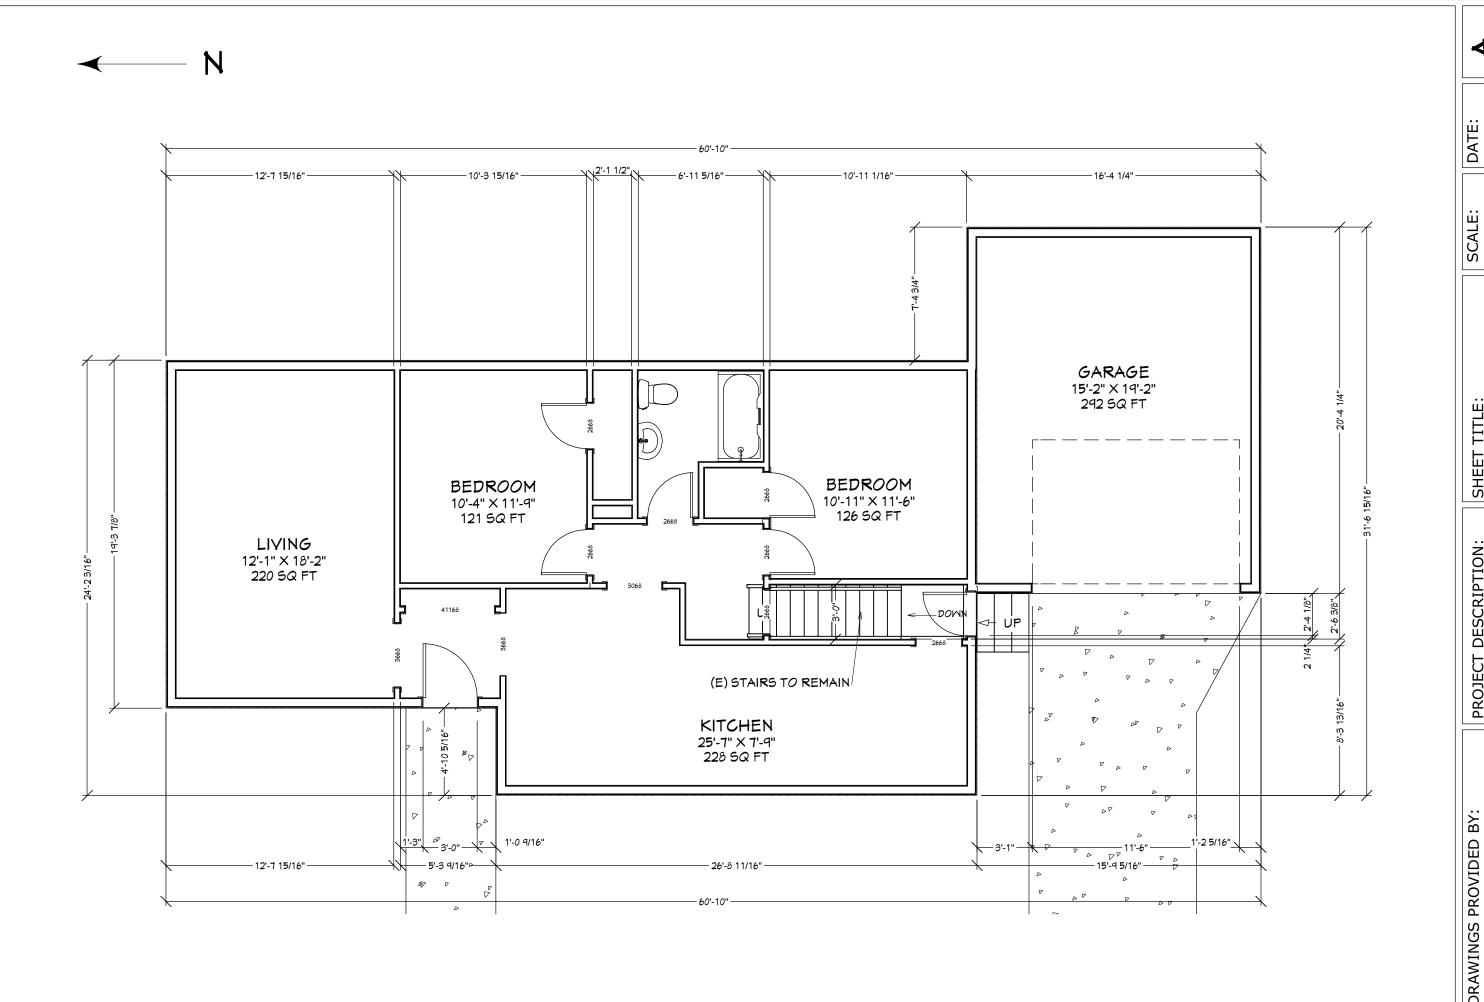

₹ 6

10/12/2018


= 1'-0"

3/16"

SHEET TITLE: EXISTING: MAIN FLOOR

PROJECT DESCRIPTION: 3506 SE 119TH AVE PORTLAND OR 97266

DRAWINGS PROVIDED BY: SAB DESIGN AND DRAFTING LLC SASHA.A.BECKWITH@GMAIL.COM 541-231-6318

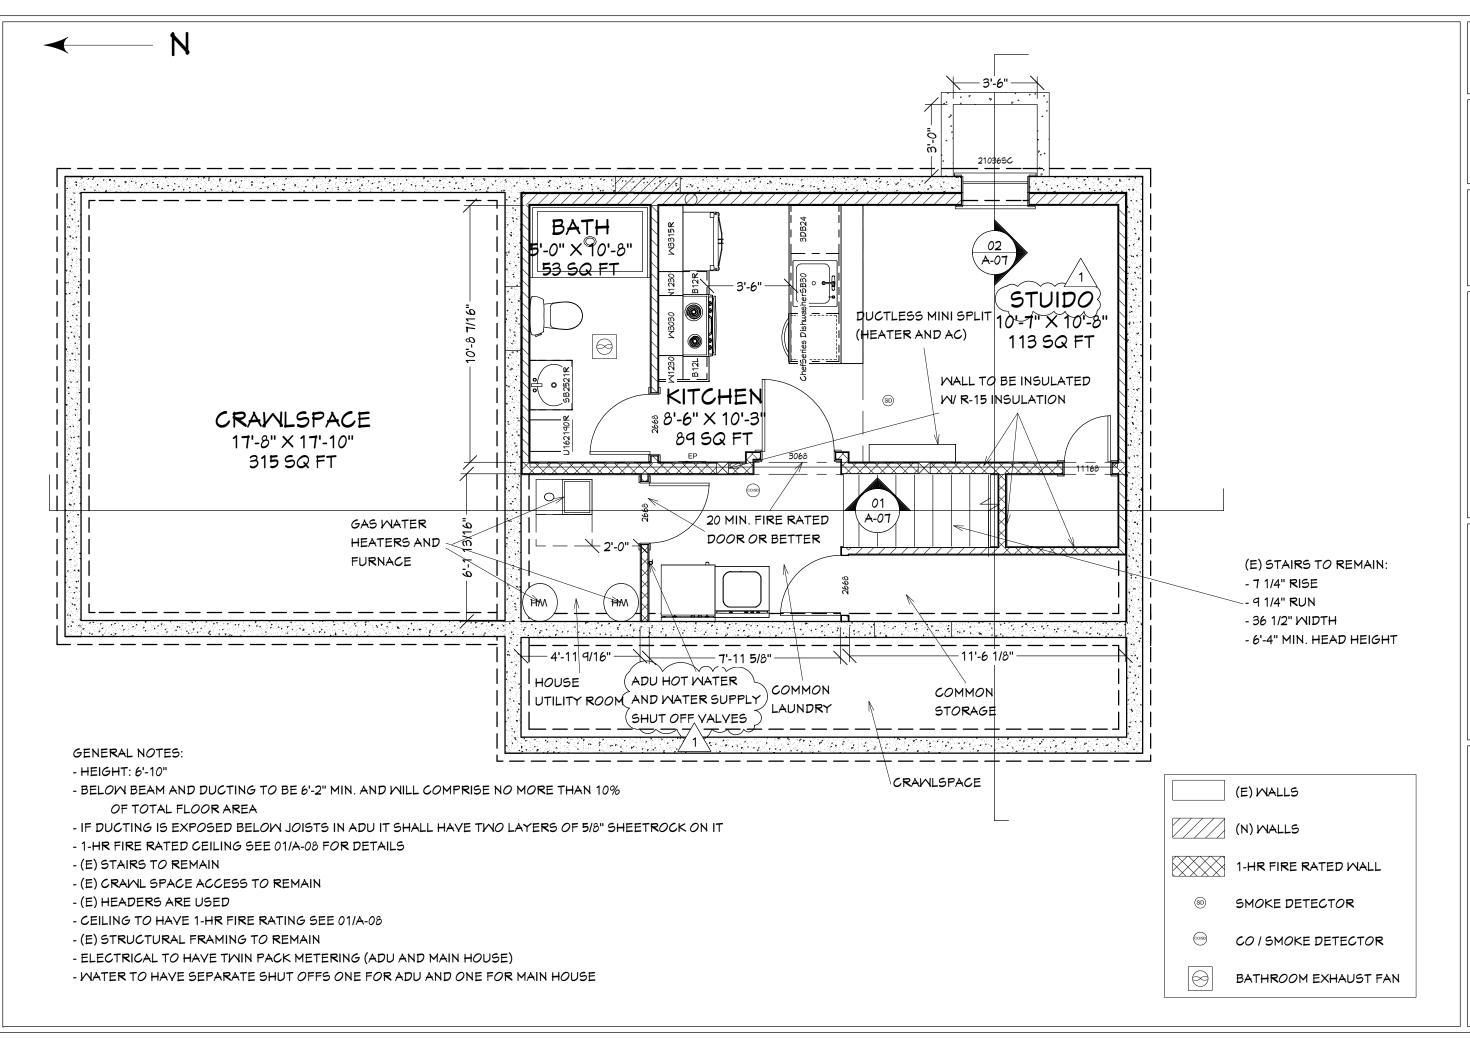

A-05


10/12/2018 DATE:


1-0 SCALE 1/4"

SHEET TITLE: PROPOSED: A

PROJECT DESCRIPTION: 3506 SE 119TH AVE PORTLAND OR 97266

DRAWINGS PROVIDED BY: SAB DESIGN AND DRAFTING LLC SASHA.A.BECKWITH@GMAIL.COM 541-231-6318

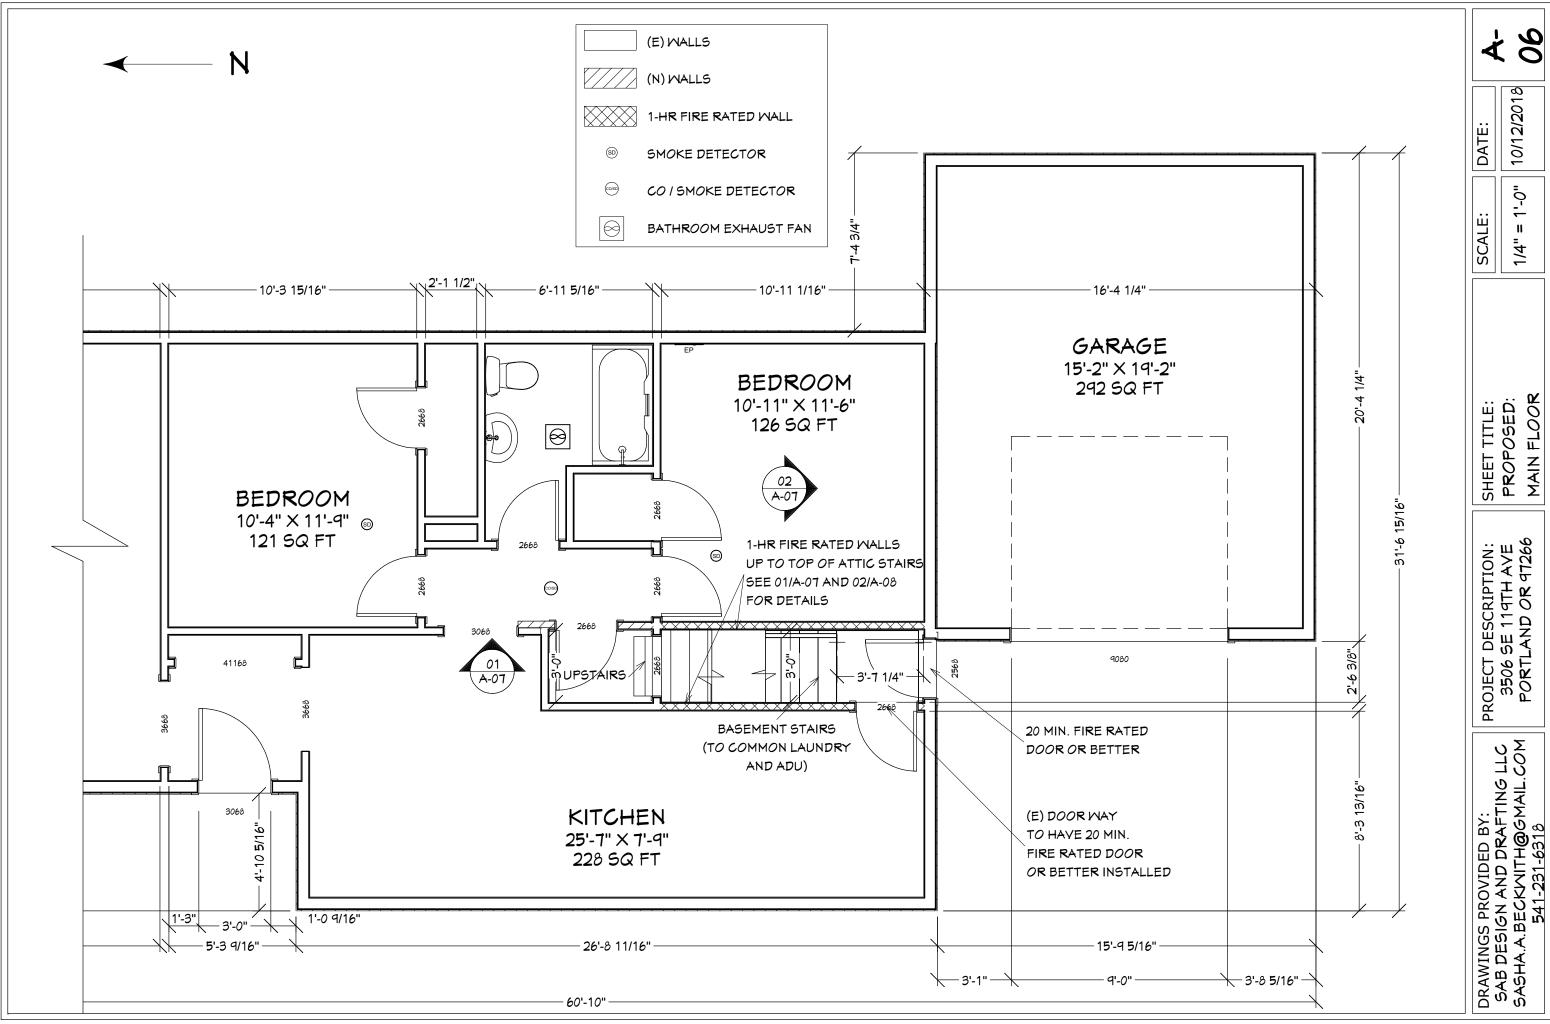

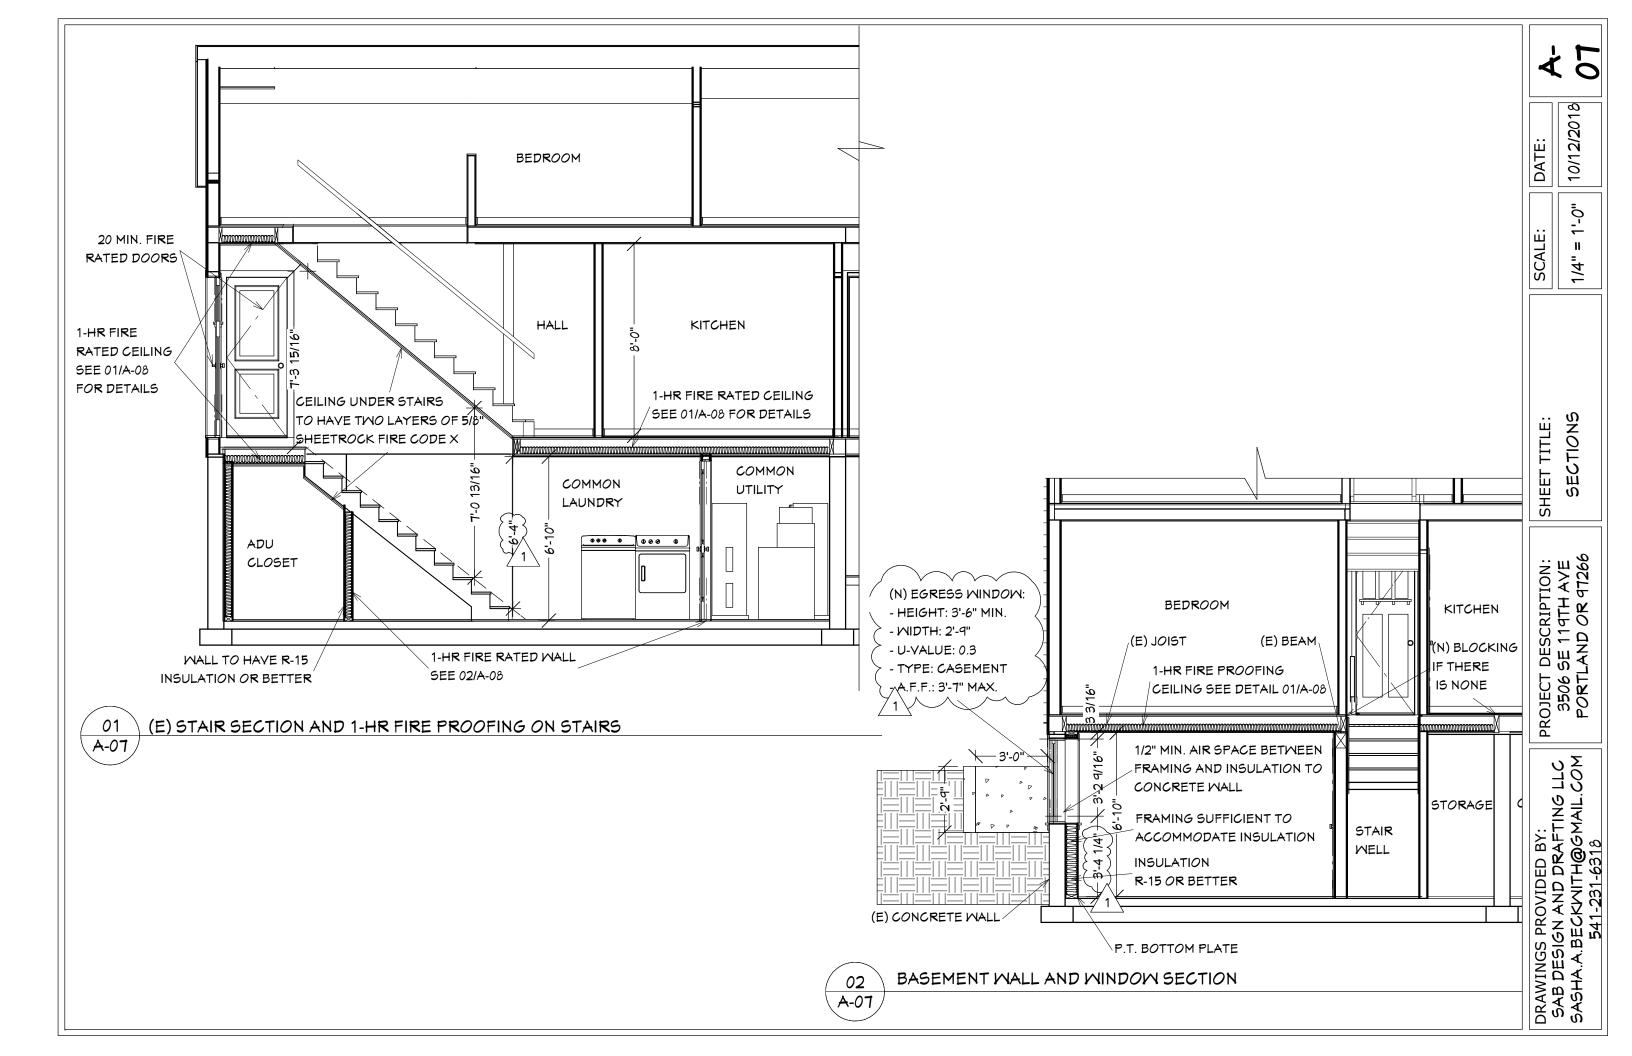

(E) 3/4" T & G HARDWOOD FLOORING (E) 3/4" T & G SUBFLOOR RESILIENT (E) 2X8 JOISTS CHANNELS 5/8" TYPE X GYP.

ASSEMBLY IS BASED OFF OF GA FILE NO.FC 5240 AND INSTILLATION INSTRUCTIONS SHALL BE FOLLOWED EXCEPT FOR USING EXISTING FLOOR SYSTEM, AND USING 5/8" GYPSUM INSTEAD OF 1/2"

DUCTING: AROUND DUCTING TWO 5/8" GYPSUM WILL BE USED

01


A-08

1-HR CEILING FIRE PROOFING ASSEMBLE

(2) 5/8 GYPSUM BOARD R-15 OR BETTER INSULATION WHERE SPECIFIED (2) 5/8 SHEETROCK FIRECODE X 2X4 WALL 16" O.C BASED OFF OF GA FILE NO. MP 3343 EXCEPTIONS: 2X6 STUD WALLS ARE USED INSTEAD OF 2X4

A-08

1-HR WALL FIRE PROOFING AND 45 MIN. STC SOUND ASSEMBLE

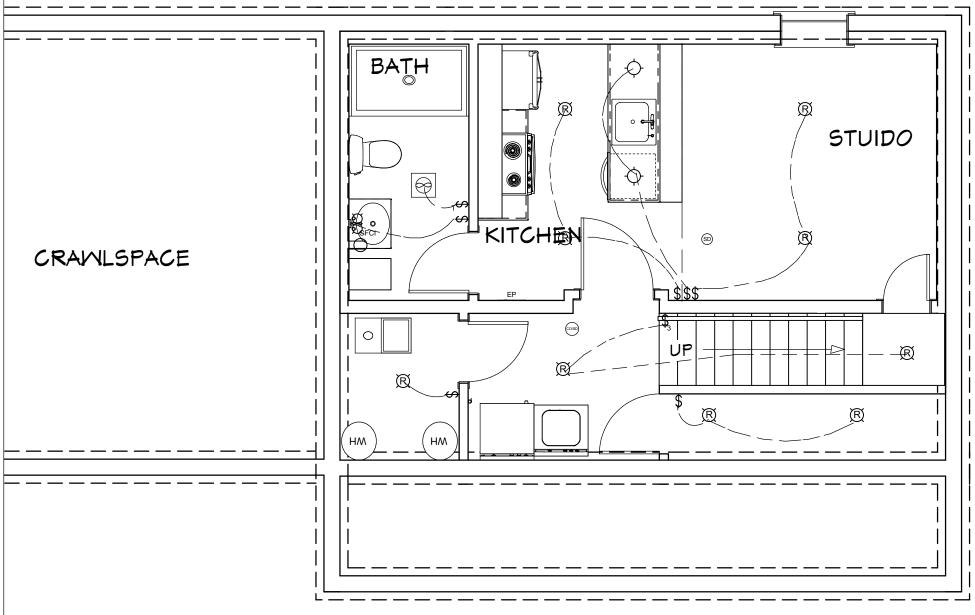

Electrical KEY Description
Sconce
Switch 3-May
Single Pole SWITCH
Switch Timer
GFCI Outlet
Pendant
Recessed Down Light
Electrical Panel
CO/Smoke Detector
Smoke Detector
Exhaust

#### GENERAL NOTES:

- ALL RECESSED CAN LIGHTS WILL

  BE INSTALLED TO RETAIN THE 1-HR FIRE

  RATING OF THE CEILING WHERE APPLICABLE
- ARTIFICIAL LIGHT WILL HAVE A MIN. 6 FOOTCANDLES
  (65 LUX) OVER THE AREA OF THE HABITABLE SPACE
  AT A HEIGHT OF 30" ABOVE THE FLOOR LEVEL
- ALL OTHER OUTLETS TO BE INSTALLED PER CODE
- ELECTRICAL PLAN MAY CHANGE LOCATIONS OF LIGHTS, AND OUTLETS HOWEVER ABOVE NOTES TO REMAIN CONSTANTLY APPLICABLE TO ANY CHANGES
- 3-WAY SWITCHES SECOND SWITCH IS AT THE TOP OF THE STAIRS