Development Services

From Concept to Construction







APPEAL SUMMARY

Status:	С	ecision	R	Rend	lered	
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Appeal ID: 20222	Project Address: 1938 W Burnside (Suite 101)
Hearing Date: 4/10/19	Appellant Name: Justin Zier
Case No.: B-019	Appellant Phone: 2063226249
Appeal Type: Building	Plans Examiner/Inspector: Anne Schmidt
Project Type: commercial	Stories: 1 Occupancy: A-2 Construction Type: 1-A
Building/Business Name: Mox Boarding House	Fire Sprinklers: Yes - throughout
Appeal Involves: Alteration of an existing structure,occ Change from M to A	LUR or Permit Application No.: 19-131561-CO

APPEAL INFORMATION SHEET

Plan Submitted Option: pdf [File 1] [File 2]

Appeal item 1

Code	Section
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1108.2.9.1

Requires

The code requires that where a bar or counter is provided for consumption of food or drink exceeding 34" in height, a integrated portion of the main bar or counter shall be provided, that is a minimum of 60" in length, or 5% of the length, whichever is greater, and 28 to 34" high.

Proposed use: Restaurant/Game Store

Proposed Design

The proposed design shows the entire bar height at 42" high. It accommodates 12 stools.

Reason for alternative Federal requirements allow service at accessible tables in the same area to satisfy the seating requirements at counters in bars. My understanding is that the change in the federal requirements was due to the realization that a dropped section of the main bar did not constitute an equivalent seating experience to the raised portion of the bar. In providing accessible seating in nearby tables, larger groups of guests are able to sit together in an area that is truly equivalent seating.

> Our experience in the first two Mox Boarding House locations, which have a lowered portions of the main bar, is that our guests in wheelchairs do not use the 34" high bar area, but rather sit at the nearby tables or banquettes.

> The proposed design complies with federal guidelines and has ample seating that can accommodate side by side wheelchair seating areas as needed. Finally, due to the small size of the bar, the integrated dropped portion would result in a loss of approximately 17% of the bar seating.

> From The Code of Federal Regulations, Standards for Accessible Design: 5.2 Counters and Bars. Where food or drink is served at counters exceeding 34 in (865 mm) in height for consumption by customers seated on stools or standing at the counter, a portion of the


main counter which is 60 in (1525 mm) in length minimum shall be provided in compliance with 4.32 or service shall be available at accessible tables within the same area.

APPEAL DECISION

Omission of structurally integrated 34 inch bar: Denied. Proposal does not provide equivalent Life Safety protection.

Appellant may contact John Butler (503 823-7339) with questions.

Pursuant to City Code Chapter 24.10, you may appeal this decision to the Building Code Board of Appeal within 180 calendar days of the date this decision is published. For information on the appeals process and costs, including forms, appeal fee, payment methods and fee waivers, go to www.portlandoregon.gov/bds/appealsinfo, call (503) 823-7300 or come in to the Development Services Center.

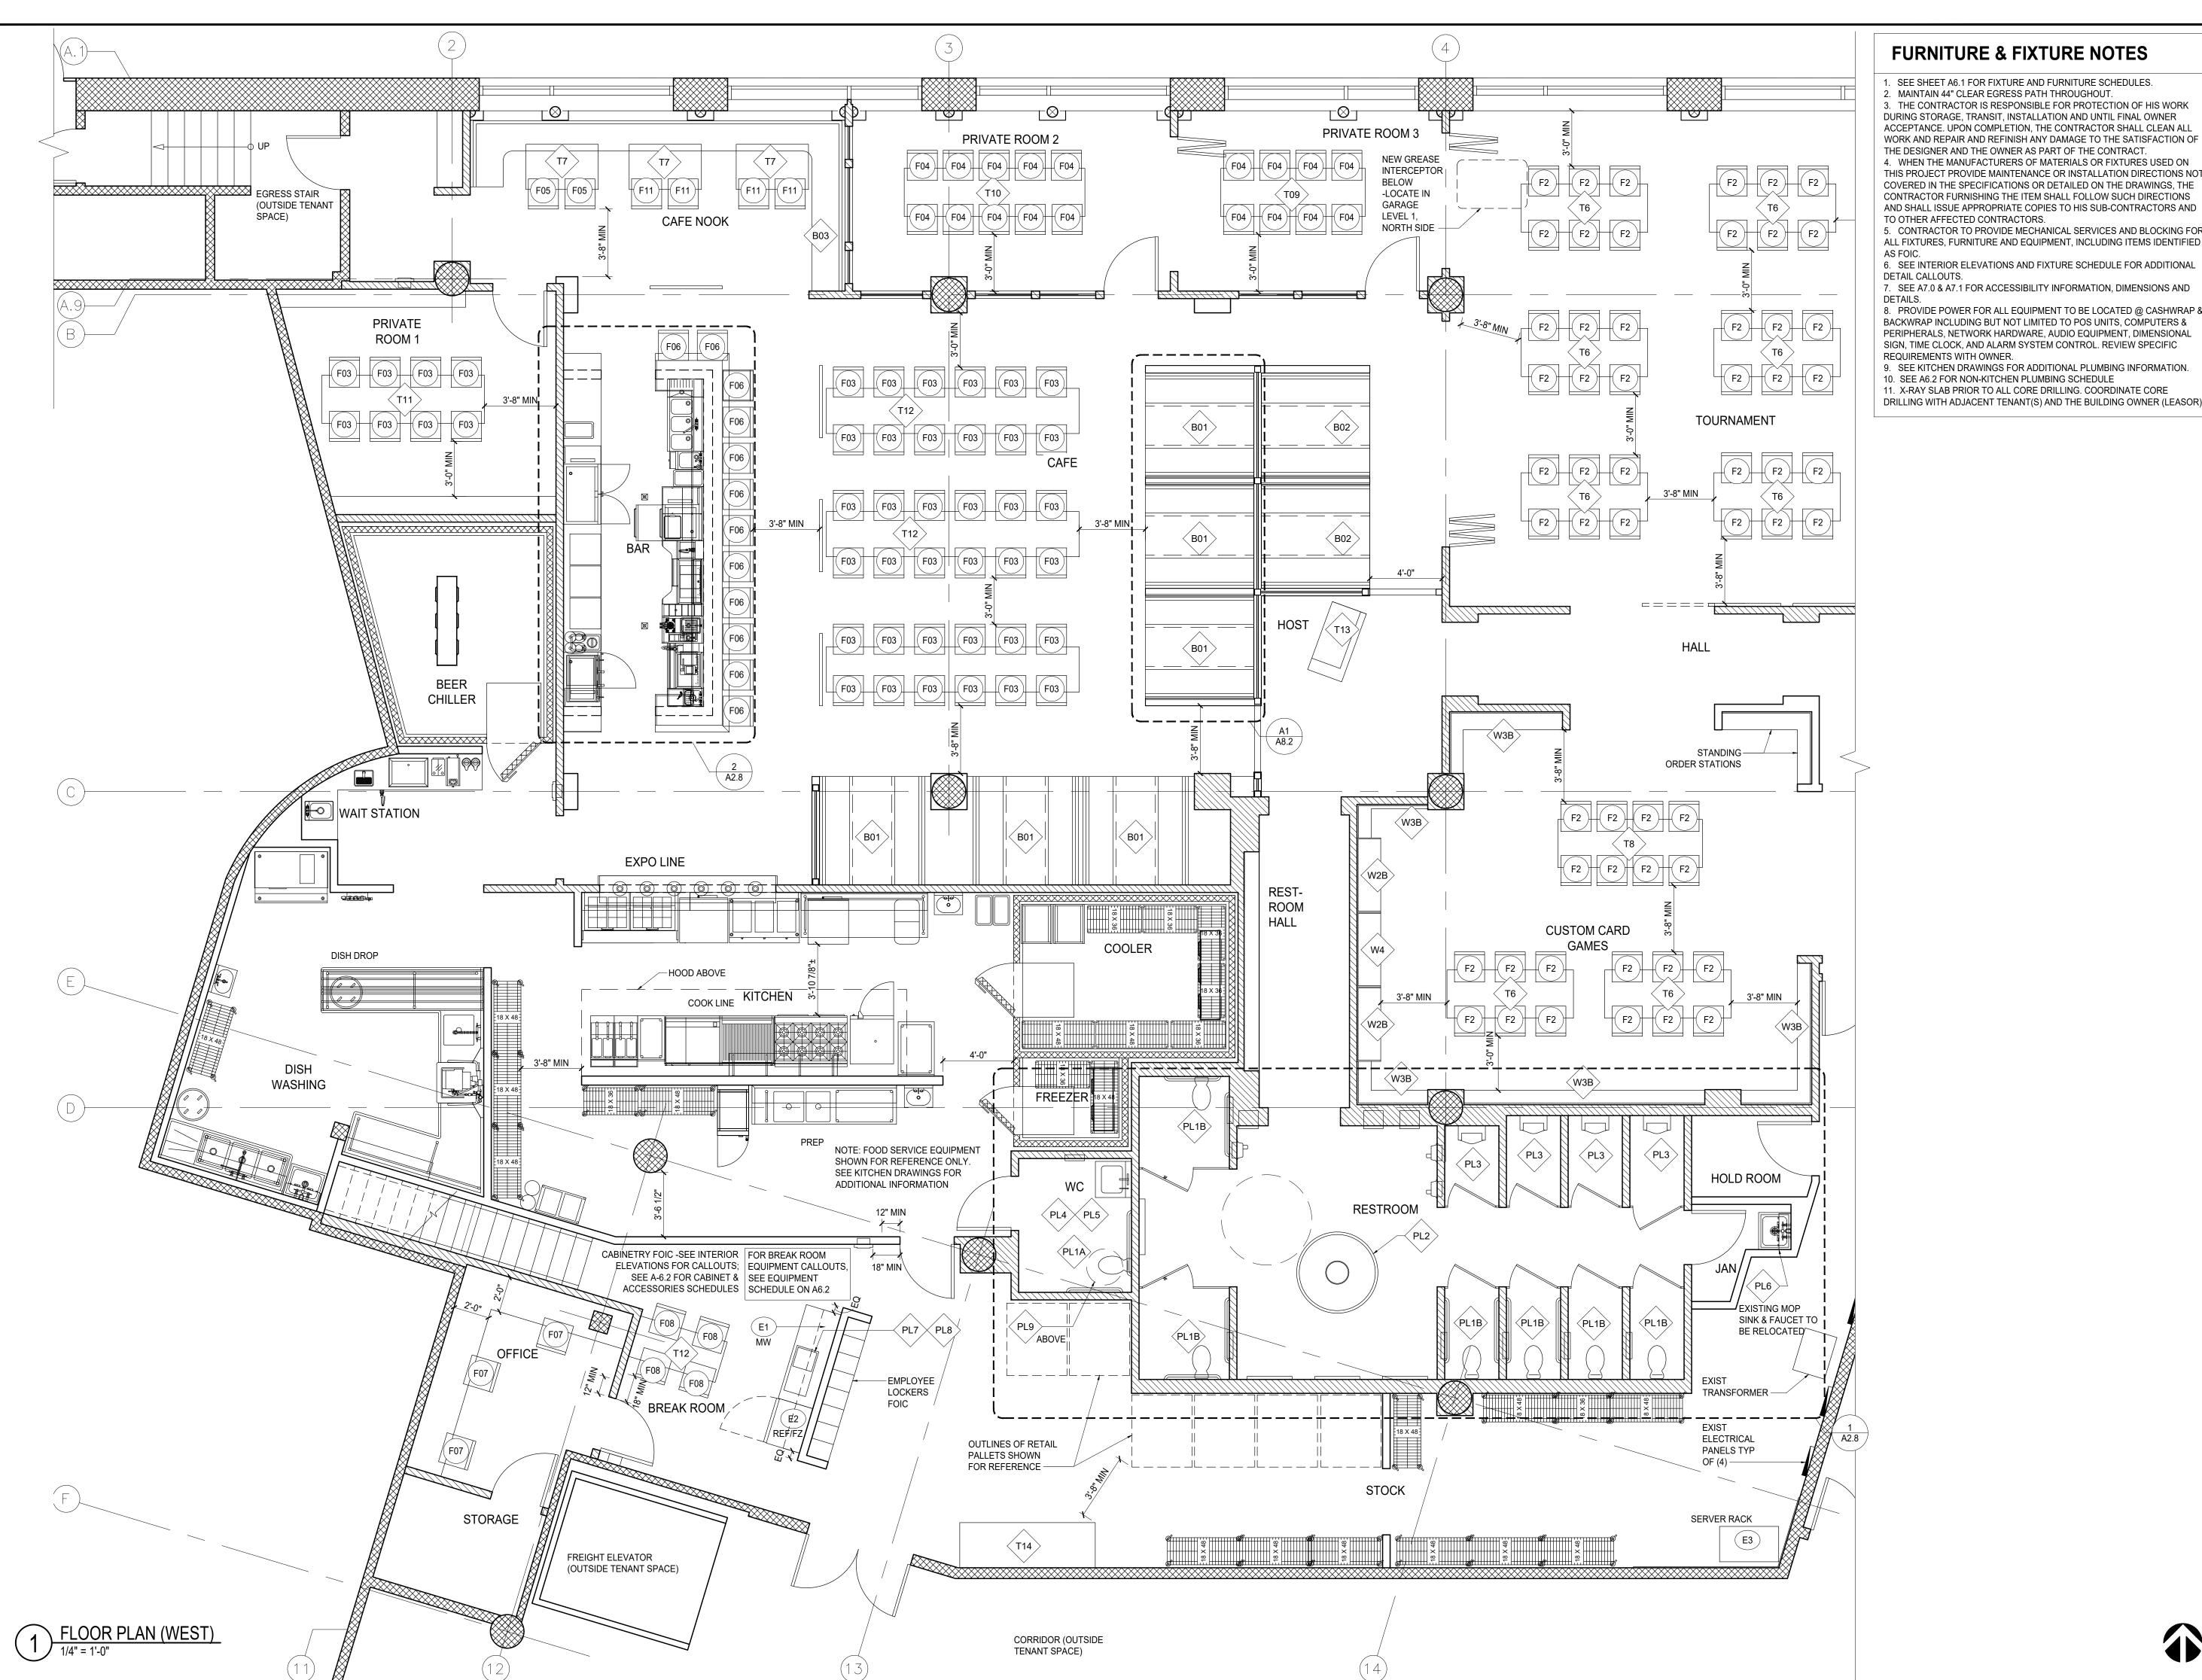

FURNITURE & FIXTURE NOTES

1. SEE SHEET A6.1 FOR FIXTURE AND FURNITURE SCHEDULES. 2. MAINTAIN 44" CLEAR EGRESS PATH THROUGHOUT. 3. THE CONTRACTOR IS RESPONSIBLE FOR PROTECTION OF HIS WORK DURING STORAGE, TRANSIT, INSTALLATION AND UNTIL FINAL OWNER ACCEPTANCE. UPON COMPLETION, THE CONTRACTOR SHALL CLEAN ALL

THE DESIGNER AND THE OWNER AS PART OF THE CONTRACT. 4. WHEN THE MANUFACTURERS OF MATERIALS OR FIXTURES USED ON THIS PROJECT PROVIDE MAINTENANCE OR INSTALLATION DIRECTIONS NOT COVERED IN THE SPECIFICATIONS OR DETAILED ON THE DRAWINGS, THE CONTRACTOR FURNISHING THE ITEM SHALL FOLLOW SUCH DIRECTIONS AND SHALL ISSUE APPROPRIATE COPIES TO HIS SUB-CONTRACTORS AND

TO OTHER AFFECTED CONTRACTORS. 5. CONTRACTOR TO PROVIDE MECHANICAL SERVICES AND BLOCKING FOR ALL FIXTURES, FURNITURE AND EQUIPMENT, INCLUDING ITEMS IDENTIFIED

6. SEE INTERIOR ELEVATIONS AND FIXTURE SCHEDULE FOR ADDITIONAL

7. SEE A7.0 & A7.1 FOR ACCESSIBILITY INFORMATION, DIMENSIONS AND

8. PROVIDE POWER FOR ALL EQUIPMENT TO BE LOCATED @ CASHWRAP & BACKWRAP INCLUDING BUT NOT LIMITED TO POS UNITS, COMPUTERS & PERIPHERALS, NETWORK HARDWARE, AUDIO EQUIPMENT, DIMENSIONAL

REQUIREMENTS WITH OWNER. 9. SEE KITCHEN DRAWINGS FOR ADDITIONAL PLUMBING INFORMATION.

10. SEE A6.2 FOR NON-KITCHEN PLUMBING SCHEDULE

11. X-RAY SLAB PRIOR TO ALL CORE DRILLING, COORDINATE CORE DRILLING WITH ADJACENT TENANT(S) AND THE BUILDING OWNER (LEASOR). **JUSTIN A ZIER**

1121 EAST THOMAS STREET SEATTLE, WA 98102, U.S.A. VOICE 1-206-322-6249 WWW.DESIGNLEISURE.COM



PERMIT SET THIS DRAWING ISSUED 03-07-19 MARCH 7, 2019 MARK | DATE | DESCRIPTION


PROJECT NO.:

JAZ, TVL

DRAWN BY: CHECKED BY:

SHEET NAME: FIRST FLOOR FURNITURE &

EQUIPMENT PLAN (WEST) SHEET NUMBER:

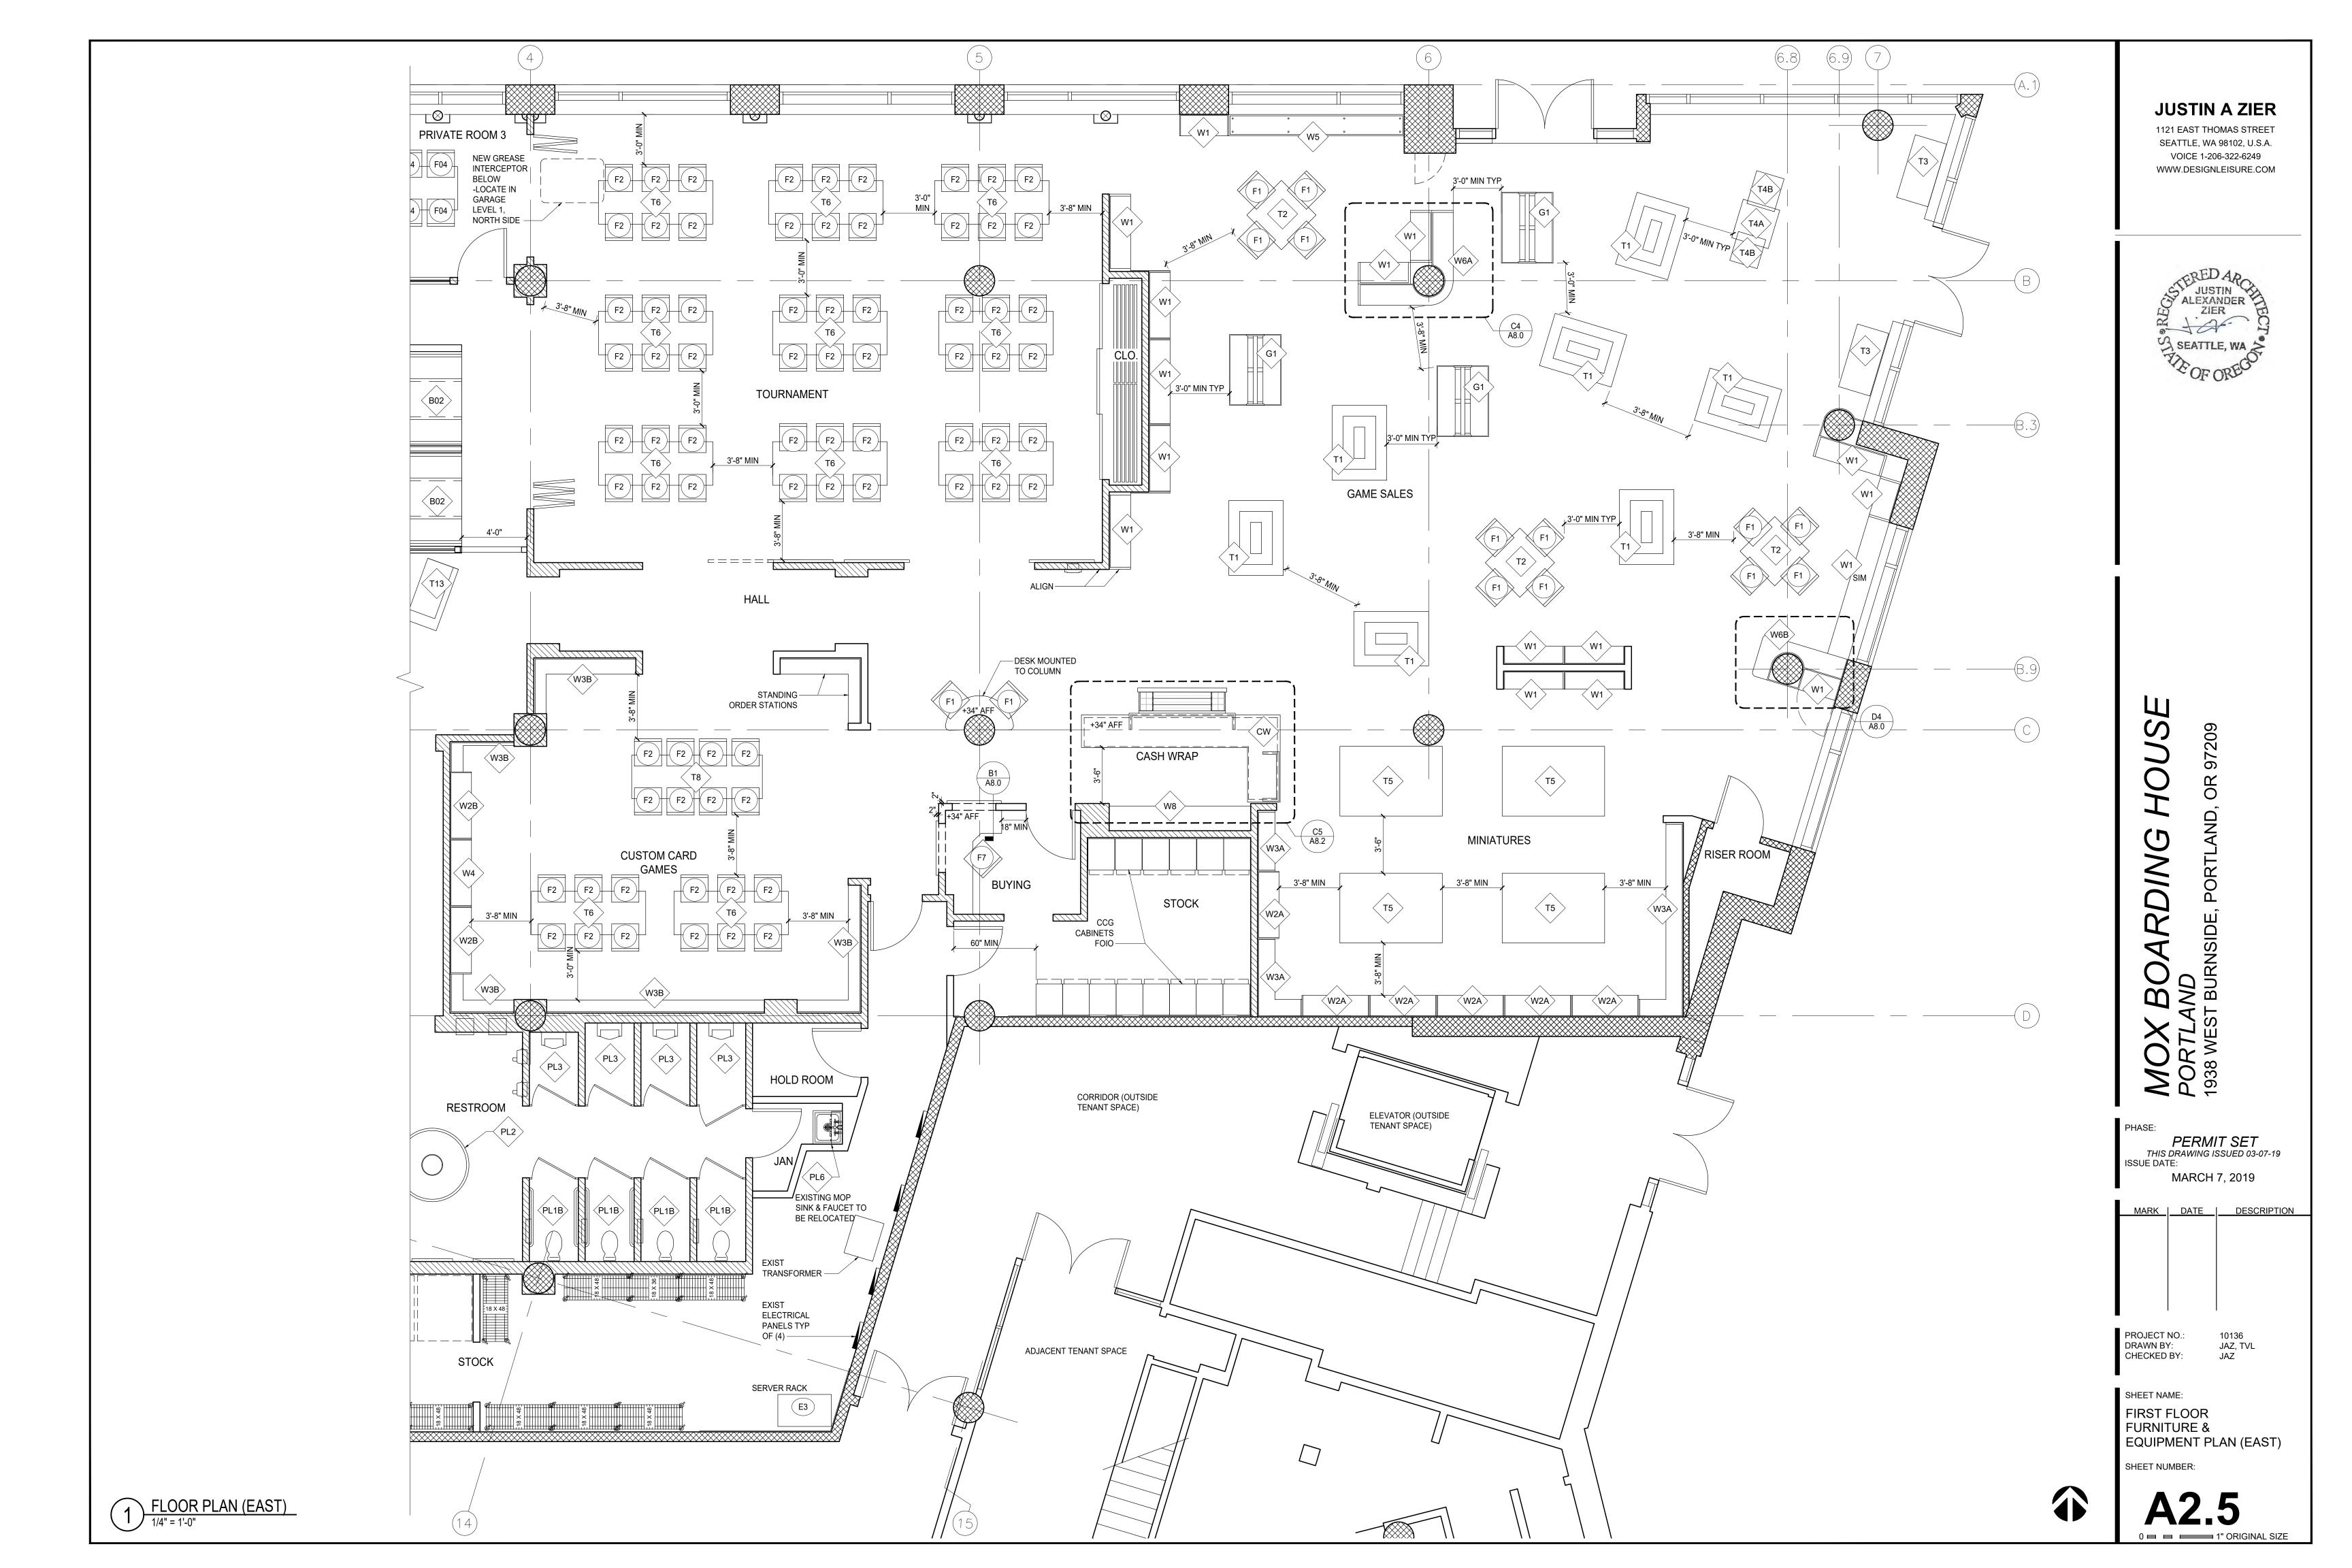

Knockout

Kilowatt

Length Laminate

Left hand

Live Load

Lease Line

Machine(ry)

Magnetic

Material

Medium

Maximum

Membrane

Manufacturer

Miscellaneous

Not In Contact

Not To Scale

On Center(s)

Outside Diàmeter

Precast Concrete

Plastic Laminate

Pounds per

Perforate(d)

Perimeter

Plywood

Primarv

Partition

Quantity

Reference

Required

Rough Open Reverse (Sid

Solid Core

Section, Second

Specifications

Sprinkler

Speaker

quare

Standard

Structural

Suspended

empered

Threshold

Steel Tubin

elevision

Unfinished

U.S. Gauge

Vertical

Window

West, Wide

Wire Glass

Waterproofin

Weight Welded Wire Fabric

REVISION

Without

Wainscot

Yard

Varnish, Varies

Verify In Field

Tread

Symmetrical

o' Be Verified

Top of Concrete

Wal

Unless Otherwise Noted

Vinyl Composition Tile

emperature, Temporary

Schedule

Receptacle

Prefabricate

Pressed Steel

Pressured Treated

Polyvinyl Chloride

Reflected Ceiling Plan

Reinforce(d), (ing)

Revision(s), Revised

Pounds per Square Inch

Prefinished

Opposite Hand

Millimeter(s

Mounted

Nominal

Parallel

New


Mechanical

Leader

Linear

Incandescen

Insulation

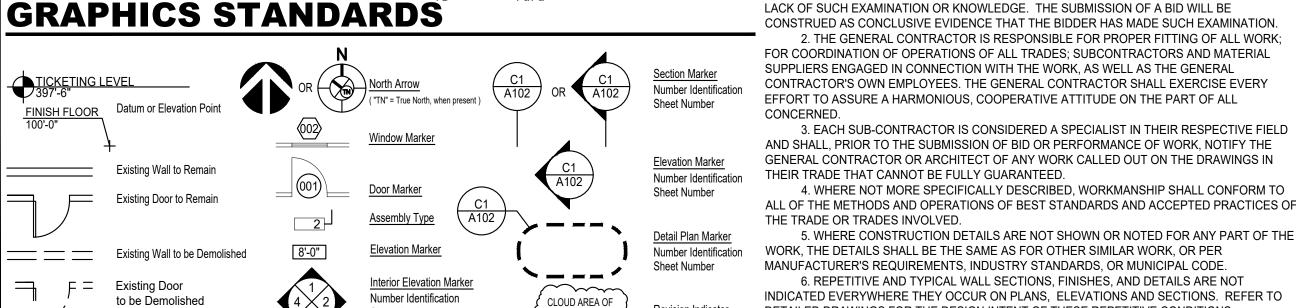

Sheet Number

GENERAL NOTES

1. SITE BOUNDARY DATA AND EXISTING SITE CONTOURS WERE TAKEN FROM DRAWINGS PREPARED BY OTHERS. THE ARCHITECT SHALL NOT BE RESPONSIBLE FOR THE ACCURACY OF THIS SITE INFORMATION.

1. THE WORK SHALL BE PERFORMED BY A SKILLED AND TRAINED WORK CREW. WORK SHALL BE PERFORMED TO CREATE A RIGID, SECURE, LEVEL OR PLUMB FINISH SURFACE. WITH LINE DIMENSIONS AND/OR CONTOURS AS INDICATED IN THE CONTRACT DOCUMENTS OR REFERENCE STANDARDS. **INTEGRITY OF FIRE ASSEMBLIES**

1. MAINTAIN STRUCTURAL AND FIRE RESISTIVE INTEGRITY AT EXTERIOR AND RATED NTERIOR WALL PENETRATIONS FOR MECHANICAL ELECTRICAL PLUMBING AND COMMUNICATIONS CONDUITS, PIPED AND SIMILAR SYSTEMS PER MUNICIPAL BUILDING CODE. APPLY APPROVED FIRE STOPPING MATERIAL WHERE REQUIRED TO MAINTAIN FIRE RESISTIVE INTEGRITY OF RATED ASSEMBLIES.

1. CONTRACTOR SHALL OBTAIN AND MAINTAIN DURING THE COURSE OF WORK. ALL REQUIRED WORKMAN'S COMPENSATION, COMPREHENSIVE LIABILITY INSURANCE INCLUDING COVERAGE FOR BODILY INJURY, PROPERTY DAMAGE AND AUTOMOBILE INSURANCE IN ACCORDANCE WITH LOCAL, STATE AND FEDERAL REQUIREMENTS. ALL SUCH COSTS SHALL BE BORNE BY THE CONTRACTOR.

2. CONTRACTOR SHALL PROVIDE EVIDENCE INDICATING INDEMNIFICATION OF THE OWNER (TENANT), BUILDING OWNER (LEASOR) AND ARCHITECT.

3. THE CONTRACTOR SHALL BEAR THE RISK OF LOSS AND RESPONSIBILITY FOR ALL INJURIES OR DAMAGES TO PERSONS OR PROPERTY THAT MAY ARISE FROM THE WORK. 4. THE CONTRACTOR SHALL BE RESPONSIBLE FOR THEFT OF TOOLS, MATERIALS AND CONTRACTOR'S EXPENSE FOR MATERIALS AND LABOR. EQUIPMENT STORED ON OR OFF THE SITE.

PERMITS, FEES, LICENSES, INSPECTIONS 1. CONTRACTOR SHALL OBTAIN AND PAY FOR ALL PERMITS, FEES, AND LICENSES REQUIRED TO CARRY OUT THE WORK, EXCEPT FOR THOSE PERMITS, FEES AND LICENSES

PAID FOR BY OWNER AS DESCRIBED IN THE PRIMARY CONTRACT. 2. CONTRACTOR SHALL GIVE NOTICES AS REQUIRED AND PAY FOR ALL INSPECTION TESTS. THESE TESTS ARE TO TAKE PLACE IN A TIMELY MANNER. ANY ADDITONAL COSTS INCURRED BY THE OWNER FOR THE CONTRACTOR'S FAILURE TO ACT IN THIS MANNER SHALL BE BORNE BY THE CONTRACTOR.

 CONTRACTOR AND SUB-CONTRACTORS SHALL COMPLY WITH ALL LOCAL, STATE AND FEDERAL LAWS, ORDINACES, INSPECTIONS, AND RULES & REGULATIONS APPLICABLE TO THE WORK. IF DRAWINGS AND SPECIFICATIONS ARE AT VARIANCE WITH ANY OF THE ABOVE PROVISIONS. THE ARCHITECT SHALL BE NOTIFIED PRIOR TO START OF ANY WORK. 2. COPIES OF ALL INSPECTION CERTIFICATES SHALL BE PROVIDED TO THE OWNER

(TENANT), BUILDING OWNER (LEASOR) AND ARCHITECT.

1. MATERIALS FOR THE PROJECT MUST COMPLY WITH ALL APPLICABLE CODES AND REGULATIONS. INSTALLATION SHALL BE GOVERNED BY MANUFACTURER'S SPECIFICATIONS. INSTRUCTIONS AND RECOMMENDATIONS, AND BY THE INDUSTRY STANDARDS LISTED. 2. WHERE THE MATERIALS, ASSEMBLIES, OR SYSTEMS ARE NOT SPECIFICALLY SPECIFIED ON THE CONTRACT DOCUMENTS, THE GENERAL CONTRACTOR MUST SUBMIT

THE MANUFACTURER, SPECIFICATIONS, AND STYLE TO THE OWNER FOR APPROVAL. 3. FOLLOWING THE CONTRACTOR'S REVIEW AND APPROVAL, HE SHALL PROVIDE THREE (3) SETS OF MATERIALS AND FINISHES FOR APPROVAL. ONE SET FOR THE ARCHITECT, ONE SET FOR THE OWNER AND ONE TO BE RETURNED TO THE CONTRACTOR THE CONTRACTOR SHALL IDENTIFY IN ITS LETTER OF TRANSMITTAL ANY VARIATION, DISCREPANCY OR CONFLICT WITH THE CONTRACT DOCUMENTS OR BEAR THE RISK OF LOSS

AND RECONSTRUCTION COSTS OR DELAYS 4. SUBSTITUTIONS FOR PRODUCTS SPECIFIED HEREIN SHALL BE PERMITTED ONLY WITH THE ARCHITECT'S REVIEW AND OWNER'S APPROVAL

5. ANY REQUESTS FOR SUBSTITUTION SHALL BE SUBMITTED TO THE OWNER WITH APPROPRIATE LITERATURE, SPECIFICATIONS, ETC. THE WARRANTY AND PERFORMANCE OF SUBSTITUTED PRODUCT OR MATERIALS SHALL BE EQUAL TO OR EXCEED ORIGINALLY SPECIFIED PRODUCT OR MATERIALS.

6. MATERIALS OR WORK DESCRIBED IN WORDS WHICH, IN THE CONTEXT, HAVE A WELL KNOWN TECHNICAL OR TRADE MEANING SHALL BE UNDERSTOOD TO REFER TO SUCH 7. STORE ALL MATERIALS IN SUCH MANNER AS NECESSARY TO PROPERLY PROTECT

FHEM FROM DAMAGE, AS MATERIALS OR EQUIPMENT DAMAGED BY HANDLING, WEATHER, DIRT OR ANY OTHER CAUSE WILL NOT BE ACCEPTED. 8.CAULKING AND SEALANTS: USE PRIMERS AS REQUIRED BY MANUFACTURER. BACKING RODS OR TAPE AS RECOMMENDED BY MANUFACTURER. USE POLYURETHANE

SEALANTS AT CONCRETE FLOOR AND SIDEWALK JOINTS. ALL OTHER LOCATIONS USE

9. VAPOR BARRIERS: CONTINUOUS APPROVED VAPOR BARRIERS SHALL BE MAINTAINED ON THE HEATED SIDE OF ALL THERMAL INSULATION INSTALLED.

POLYSULFIDE OR SILICONE.

PROJECT NOTES

FOR MATERIALS AND METHODS OF INSTALLATION.

NOT APPROVED IN WRITING BY THE ARCHITECT.

CONSTRUCTION COORDINATION

1. CONTRACTOR SHALL MAINTAIN AT THE PROJECT SITE ONE (1) SET OF PRINTS AND SPECIFICATIONS THAT SHALL BE UPDATED AS WORK PROGRESSES TO RECORD AND INDICATE: ALL LOCATIONS OF UTILITIES, SYSTEMS, PIPES, CONDUITS, DUCT WORK, CABLING, ETC.; CHANGES WITHIN THE CONSTRUCTION DOCUMENTS; AND ANY OTHER ITEMS WHICH MAY AFFECT FUTURE CONSTRUCTION. RENOVATIONS OR REPAIRS. THE INFORMATION SHALL BE SUBMITTED TO THE OWNER ON A CLEAN SET OF MARKED-UP PRINTS UPON

COMPLETION OF THE PROJECT. 2. CONTRACTOR SHALL PRESENT THE OWNER (TENANT) AND THE BUILDING OWNER (LEASOR) WITH A BINDER OF WARRANTIES, MAINTENANCE AND OWNER'S MANUALS FOR APPLICABLE FINISH MATERIALS AND ALLEQUIPMENT AND FIXTURES.

THE OWNER HAS REQUESTED THAT THE ARCHITECT PREPARE THESE PROJECT

CONSTRUCTION OF THE PROJECT IN COMPLIANCE WITH APPLICABLE GOVERNING BUILDING

CODES AND REGULATIONS. WHERE MATERIALS, ASSEMBLIES, EQUIPMENT, FIXTURES, AND

SYSTEMS ARE NOT SHOWN, OR ARE SHOWN DIAGRAMMATICALLY, IT IS THE RESPONSIBILITY

COMPLIANCE WITH APPLICABLE BUILDING CODES, REGULATIONS, AND INDUSTRY STANDARDS

ANY CHANGES IN THE WORK DESCRIBED BY THESE PROJECT DRAWINGS MUST BE

RESPONSIBLE FOR ANY CHANGES IN THE WORK OR ANY PART OF THE PROJECT AFFECTED B'

1. BEFORE SUBMITTING A BID, THE CONTRACTOR AND SUBCONTRACTORS SHALL

CAREFULLY EXAMINE THE DRAWINGS AND ALL OTHER PROPOSED CONTRACT DOCUMENTS,

TO BE PERFORMED, PARTICULARLY THOSE BEARING UPON CODES AND ORDINANCES,

TRANSPORTATION, UTILITIES, DISPOSAL, HANDLING AND STORAGE OF MATERIALS AND

AVAILABILITY OF LABOR. THE CONTRACTOR SHALL INCLUDE IN THE BID A SUM TO COVER ALL

COSTS OF ALL ITEMS NECESSARY TO PERFORM THE WORK AS SET FORTH IN THE PROPOSED

CONTRACT DOCUMENTS. NO ALLOWANCE WILL BE MADE TO THE CONTRACTOR BECAUSE OF

2. THE GENERAL CONTRACTOR IS RESPONSIBLE FOR PROPER FITTING OF ALL WORK;

3. EACH SUB-CONTRACTOR IS CONSIDERED A SPECIALIST IN THEIR RESPECTIVE FIELD

4. WHERE NOT MORE SPECIFICALLY DESCRIBED, WORKMANSHIP SHALL CONFORM TO

5. WHERE CONSTRUCTION DETAILS ARE NOT SHOWN OR NOTED FOR ANY PART OF THE

6. REPETITIVE AND TYPICAL WALL SECTIONS, FINISHES, AND DETAILS ARE NOT

DETAILED DRAWINGS FOR THE DESIGN INTENT OF THESE REPETITIVE CONDITIONS.

CHANGES IN WORK MADE BY THE OWNER OR THE CONTRACTOR IF THOSE CHANGES WERE

OF THE OWNER AND THE GENERAL CONTRACTOR TO DETERMINE SPECIFIC LOCATIONS,

REVIEWED AND APPROVED BY THE ARCHITECT, THE OWNER, AND THE LOCAL BUILDING

OFFICIAL BEFORE PROCEEDING WITH THE WORK. THE ARCHITECT SHALL NOT BE HELD

PROVIDE SPECIFIC MATERIALS, AND DETERMINE CONSTRUCTION DETAILING, ALL IN

DRAWINGS, WHICH ARE LIMITED IN SCOPE, TO ESTABLISH MINIMUM GUIDELINES FOR

1. CONTRACTOR SHALL GUARANTEE WORK AGAINST DEFECTS FOR A MINIMUM OF ONE (1) YEAR FROM DATE OF ACCEPTANCE. WHERE LONGER GUARANTEE PERIOD IS SPECIFIED UNDER ITEM SPECIFICATION, IT SHALL SUPERSEDE THE ONE YEAR GUARANTEE CONTRACTOR SHALL MAKE GOOD BY REPAIR AT NO COST TO OWNER AND WITHIN FIVE (5) DAYS AFTER NOTICE IS GIVEN FOR ANY PORTION OF THE WORK THAT MAY SHOW DEFECTS IN EITHER WORKMANSHIP OR MATERIALS DURING THAT PERIOD. FIELD VERIFICATION OF EXISTING CONDITIONS

1. THE CONTRACTOR AND/OR SUB-CONTRACTORS SHALL VERIFY ALL LINES, LEVELS INTERFERENCES, FIELD DIMENSIONS AND CONDITIONS WITH THE DRAWINGS AND REPORT ANY ERRORS, OMISSIONS, OR DISCREPANCIES TO THE ARCHITECT PRIOR TO COMMENCING

FIELD CONDITIONS THAT MAY CAUSE CONSTRUCTION PROBLEMS PRIOR TO COMMENCING WORK. FAILURE TO REPORT TO THE ARCHITECT FOR INTERPRETATION OF SUCH CONDITIONS OR COVERING OVER A CONDITION WHICH SUBSEQUENTLY CAUSES ANY DELAY OR ADDITIONAL COST SHALL BE THE RESPONSIBILITY OF THE CONTRACTOR INTERPRETATION OF DOCUMENTS

1. ALL MATERIALS SPECIFIED ARE TO BE INSTALLED IN ACCORDANCE WITH THESE DOCUMENTS AND MANUFACTURER'S INSTRUCTIONS AND SPECIFICATIONS. CONTRACTOR TO NOTIFY ARCHITECT OF ANY DISCREPENCIES BETWEEN THESE DOCUMENTS AND MANUFACTURER'S INSTRUCTIONS/SPECIFIATIONS PRIOR TO COMMENCEMENT OF WORK

2. THE ARCHITECT IS THE SOLE INTERPRETER OR ARBITER OF THESE DOCUMENTS. ANY DEVIATION FROM THE INTENT OF THE DOCUMENTS, WITHOUT ARCHITECT'S APPROVAL IS AT THE CONTRACTOR'S OWN RISK AND MAY RESULT IN A CORRECTION AT THE LAYOUT, CONFLICTS AND DIMENSIONS

DO NOT SCALE DRAWINGS. 2. ALL DIMENSIONS ARE GIVEN FROM FINISHED SURFACES OR CENTERLINES, UNLESS

OTHERWISE NOTED. 3. DIMENSIONS ARE GIVEN FROM ESTABLISHED REFERENCE POINTS AND ARE NOT CONTINUOUS. ALL TRADES SHOULD LAY OUT THEIR RESPECTIVE WORK FROM THE SAME REFERENCE POINTS. CRITICAL DIMENSIONS ARE SHOWN; UNDIMENSIONED SPACE MAY BE ADJUSTED TO SUIT FIELD CONDITIONS.

4 NOTIFY ARCHITECT OF ANY CONFLICTS BETWEEN LAYOUT AND DIMENSIONS PRIOR TO COMMENCEMENT OF WORK FOR INTERPRETATION. ANY SUCH CONFLICT NOT SO RESOLVED WHEREBY LATER CORRECTION IS REQUIRED. SHALL BE AT THE CONTRACTOR'S

5. WORK SHALL PROCEED FROM THE DIMENSIONS SHOWN ON THE MOST RECENT DRAWINGS SUPPLIED BY THE ARCHITECT 6. THE GENERAL CONTRACTOR SHALL BE RESPONSIBLE FOR HIS/HER OWN LAYOUT

AND FOR THAT OF HIS/HER SUB-TRADES. 7. VERIFY REQUIRED EQUIPMENT CLEARANCES AND POWER/FUEL CONNECTIONS PRIOR TO CONSTRUCTION AND NOTIFY ARCHITECT OF ANY CONFLICTS. JOB SITE CLEANLINESS AND PROTECTION

1. CONTRACTOR IS TO CONSULT TENANT AND BUILDING OWNER ABOUT SPECIFIC OWNER REQUESTS FOR JOB SITE CLEANLINESS AND NOISE CONTROL 2. CONTRACTOR SHALL PROVIDE AND MAINTAIN ALL ITEMS/METHODS REQUIRED BY MUNICIPAL CODE AND GUIDELINES FOR ON-SITE SAFETY. SITE PROTECTION, NEIGHBORING

SITE PROTECTION, EROSION CONTROL, AND NOISE CONTROL. 3. THE CONTRACTOR SHALL PROVIDE AND CONTINUOUSLY MAINTAIN ADEQUATE SAFEGUARDS, SUCH AS FENCES, RAILINGS, TEMPORARY WALKS, LIGHTS, POSTED DANGER SIGNS, ETC., TO PREVENT ACCIDENTS, INJURIES, DAMAGE OR HURT TO ANY PERSON OR

4. THE CONTRACTOR SHALL PROVIDE FIRE EXTINGUISHERS AS REQUIRED BY CODE AND LOCATE PER FIRE MARSHALL'S DIRECTION. UNLESS SUPERSEDED BY APPLICABLE CODE, PROVIDE (1) FIRE EXTINGUISHER PER 3,000 S.F. OF BLDG. AREA WITH 75'-0" TRAVEL DISTANCE BETWEEN EXTINGUISHERS. EXTINGUISHERS U.L. RATED-4A

5. CONTRACTOR SHALL MAINTAIN A CLEAN, ORDERLY AND SAFE WORK SITE AT ALL TIMES. ON A DAILY BASIS, THE CONTRACTOR SHALL CLEAN THE PREMISES, SITE, ADJACENT STREET AND SIDEWALKS. THESE AREAS SHALL BE KEPT CLEANED AND FREE FROM ACCUMULATION OF WASTE MATERIALS OR RUBBISH CAUSED BY THE CONTRACTOR'S OPERATIONS. AT COMPLETION OF THE WORK, ALL RUBBISH, TOOLS, SCAFFOLDING, SURPLUS MATERIALS. AND OTHER DEBRIS OR ITEMS USED IN CONSTRUCTION SHALL BE REMOVED AND DISPOSED PROPERLY AS REQUIRED BY MUNICIPAL CODE/GUIDELINES. 6. REFUSE CONTAINERS SHALL BE EMPTIED AT FREQUENT ENOUGH INTERVALS SO

THAT WASTE DOES NOT OVERFLOW THE CONTAINERS. 7. PRIOR TO FINAL ACCEPTANCE AND OCCUPANCY BY THE OWNER. THE CONTRACTOR SHALL THOROUGHLY CLEAN THE INTERIOR AND EXTERIOR OF THE BUILDING, THE SITE AND ADJACENT AREAS IMPACTED BY THE WORK. WORK SITE TO BE "BROOM CLEAN" OR EQUIVALENT, UNLESS MORE EXACTLY SPECIFIED. IN CASE OF DISPUTE, OWNER MAY REMOVE DEBRIS AND CHARGE THE COST TO THE CONTRACTOR.

TEMPORARY UTILITIES 1. CONTRACTOR SHALL FURNISH ALL TEMPORARY UTILITIES REQUIRED TO PERFORM HIS/HER WORK INCLUDING BUT NOT LIMITED TO ELECTRICITY, WATER, HEAT, AND TELEPHONE.

ACCESSIBILITY GUIDELINES 1. ALL EQUIPMENT AND ACCESSORIES INSTALLED AND WORK SHALL BE PERFORMED

IN ACCORDANCE WITH ALL ACCESSIBILITY REQUIREMENTS OF FEDERAL, STATE AND LOCAL CODES, INCLUDING BUT NOT LIMITED TO, THE AMERICANS WITH DISABILITIES ACT (ADA) AND ANSI A117.1.

1. CONTRACTOR IS TO CONSULT OWNER ABOUT SPECIFIC OWNER REQUESTS FOR

2. ANY WORK WHICH IS REQUIRED TO TAKE PLACE AT NIGHT AND/OR HOURS NOT AGREED UPON AS WORK HOURS, SHALL BE VERIFIED WITH THE OWNER (TENANT) AND THE BUILDING OWNER (LEASOR) AND SUCH COSTS SHALL BE INCLUDED IN BID. 3. HOURS OF WORK SHALL COMPLY WITH THE BUILDING QUIET HOURS

7. IT SHALL BE THE RESPONSIBILITY OF THE CONTRACTOR TO LOCATE ALL EXISTING UTILITIES PRIOR TO THE WORK, WHETHER SHOWN OR NOT ON DRAWINGS, AND TO PROTECT THEM FROM DAMAGE. THE CONTRACTOR SHALL BEAR ALL EXPENSE OF REPAIR OR REPLACEMENT OF UTILITIES OR OTHER ITEMS DAMAGED BY OPERATIONS IN CONJUNCTION WITH THE EXECUTION OF WORK.

COORDINATE THEIR WORK WITH MECHANICAL AND ELECTRICAL TRADES TO AVOID CONFLICTS AND UNNECESSARY MODIFICATION OF FRAMING. 9. MECHANICAL TRADES MUST COORDINATE THEIR WORK WITH FRAMERS AND ELECTRICAL TRADES TO AVOID CONFLICTS AND UNNECESSARY MODIFICATION OF FRAMING.

8. FRAMING PLANS, WHEN INCLUDED, ARE DIAGRAMMATIC. FRAMERS MUST

10. ELECTRICAL TRADES MUST COORDINATE THEIR WORK WITH FRAMERS AND MECHANICAL TRADES TO AVOID CONFLICTS AND UNNECESSARY MODIFICATION OF FRAMING. 11. THE OWNER ASSUMES NO RESPONSIBILITY FOR ANY REPRESENTATIONS MADE BY ANY OF ITS AGENTS OR REPRESENTATIVES TO THE CONTRACTOR DURING OR PRIOR TO EXECUTION OF AGREEMENT, UNLESS SUCH REPRESENTATION AND OWNER'S RESPONSIBILITY IS EXPRESSLY STATED IN THE AGREEMENT

12. GENERAL CONTRACTOR SHALL PROVIDE SUFFICIENT AND SATISFACTORY WORK FORCES REQUIRED TO ENSURE THE EXECUTION OF THE WORK TO COMPLETION AND TO MEET AGREED UPON COMPLETION (TURNOVER) DATE. NEGLECT OR FAILURE TO FURNISH SUCH WORK FORCES OR MEET REQUIRED DATES SHALL BE GROUNDS FOR TERMINATION OF AND VISIT THE SITE OF THE WORK. THE CONTRACTOR SHALL FULLY INFORM THEMSELF PRIOR AGREEMENT. THE OWNER MAY FURNISH ADDITIONAL FORCES AT THE CONTRACTOR'S TO BIDDING AS TO ALL EXISTING CONDITIONS AND LIMITATIONS ASSOCIATED WITH THE WORK EXPENSE TO MEET THE SCHEDULE AND COMPLETION DATE AND/OR WITH LEGAL NOTICE RECOVER DAMAGES ARISING FROM SUCH DELAYS.

13. NO VERBAL AGREEMENTS OR CONVERSATION WITH THE OWNER OR THE OWNER'S AGENTS BEFORE, DURING OR AFTER THE CONTRACT DOCUMENTS SHALL AFFECT OR MODIFY ANY TERM OR CONDITION OF THE CONTRACT DOCUMENTS. NOR SHALL SUCH VERBAL AGREEMENT OR CONVERSATION ENTITLE THE CONTRACTOR TO ADDITIONAL PAYMENT OR

14. WHENEVER TWO OR MORE STANDARDS OR REQUIREMENTS APPEAR IN THE CONTRACT DOCUMENTS, THE HIGHEST STANDARD OR REQUIREMENT SHALL BE APPLIED AND

15. PRIOR TO THE START OF WORK, THE CONTRACTOR SHALL SUBMIT A DETAILED PROPOSED CONTRACT SCHEDULE PRESENTING AN ORDERLY AND REALISTIC PLAN FOR COMPLETION OF THE WORK. THE SCHEDULE SHALL INCLUDE: OVERALL TIME OF COMPLETION TIME OF COMPLETION FOR ALL MILESTONES, PROCUREMENT OF MAJOR EQUIPMENT, OWNER FURNISHED MATERIALS AND ACTIVITIES, DEPENDENCIES OR RELATIONSHIPS BETWEEN ACTIVITIES SHOWN, PROCESSING OF SUBMITTALS AND SHOP DRAWINGS, TIME FOR DEVELOPING PUNCH LISTS, COMPLETION OF PUNCH LISTS AND FINAL CLEAN UP, AND INTERFACE WITH THE WORK OF OTHER CONTRACTORS OR ENTITIES.

16. BEFORE SUBMITTING ANY REQUEST FOR INFORMATION (RFI) OR ANY OTHER CONTRACTOR INITIATED REQUEST FOR INFORMATION, THE CONTRACTOR SHALL DETERMINE THAT THE INFORMATION REQUESTED IS NOT CLEARLY PROVIDED IN THE CONTRACT DOCUMENTS. RFI SUBMITTALS SHALL BE SUBMITTED TO THE ARCHITECT ONLY FROM THE CONTRACTOR AND NOT FROM ANY SUBCONTRACTOR, SUPPLIER OR OTHER VENDOR. THE CONTRACTOR SHALL MAINTAIN AN RFI PRIORITY SCHEDULE RANKING THE RFI'S IN ORDER OI PRIORITY. THE RFI PROCESS IS FOR INFORMATION AND CLARIFICATION ONLY AND MAY NOT BE USED TO OBTAIN APPROVAL FOR CHANGES IN THE WORK.

MOX BOARDING HOUSE: PORTLAND

PROJECT DIRECTORY

EMAIL: DAMON@CARDKINGDOM.COM

OWNER (TENANT)

5105 LEARY AVE NW

SEATTLE, WA 98107

206-355-2413 VOICE

CONTACT: DAMON MORRIS

ANCHORAGE, AK 99503

CONTACT: DEBORAH ABEL

WNER'S ARCHITECT

JUSTIN ALEXANDER ZIER

CONTACT: JUSTIN A. ZIER

GENERAL CONTRACTOR:

STRUCTURAL ENGINEER:

T.M. RIPPEY CONSULTING ENGINEERS

EMAIL: JWETTERLIN@TMRIPPEY.COM

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JOSH WETTERLIN, PE

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WWW.TMRIPPEY.COM

BLOCK MAP NO SCALE

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WWW.DESIGNLEISURE.COM

EMAIL: JZIER@DESIGNLEISURE.COM

OR STATE LICENSE # ARI-4832

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425-643-9203 VOICE

SEATTLE, WA 98201

CARD KINGDOM

DATA & CODE SUMMARY

COMMERCIAL TENANT IMPROVEMENT EXISTING 1ST FLOOR (9947.5 NET SF) - ADD PARTITIONS, FINISHES, FLOORING, WASH ROOMS, CAFE, FIXTURES & LIGHTING EXISTING MEZZANINE (46.4 NET SF) - ADDITION OF ACCESS STAIR

"MOX BOARDING HOUSE", 1938 WEST BURNSIDE STREET (SUITE 101). PORTLAND, OREGON, 97209; MULTNOMAH COUNTY ASSESSOR'S PROPERTY ID: R601669; MAP # 1N1E33DC-70262; LEGAL DESCRIPTION:

S.W.1/4 S.E.1/4 SEC.33 T.1N. R.1E. W.M., MULTNOMAH COUNTY

PORTLAND ORDINANCES EFFECTIVE JANUARY 24TH 2018.

BUILDING CODE EDITION 2014 OREGON STRUCTURAL SPECIALTY CODE AS MODIFIED BY THE BUILDING CODES DIVISION OF THE OREGON DEPARTMENT OF CONSUMER AND BUSINESS SERVICES AMENDMENTS (2012 EDITION OF THE INTERNATIONAL BUILDING CODE), AND AMENDED BY THE CITY OF

ENERGY CODE ENERGY EFFICIENCY SPECIALTY CODE, 2014 EDITION, AS PUBLISHED BY THE INTERNATIONAL CODE COUNCIL AND KNOWN AS THE INTERNATIONAL ENERGY CONSERVATION CODE, 2009 EDITION AND AMENDED BY THE BUILDING CODES DIVISION OF THE OREGON DEPARTMENT OF CONSUMER AND BUSINESS SERVICES AND AMENDED

BY THE CITY OF PORTLAND ORDINANCES EFFECTIVE JANUARY 24TH 2018

PROJECT TO MEET APPLICABLE REQUIREMENTS FOR BARRIER-FREE ACCESSIBILITY FOUND IN CHAPTER 11 AND PORTIONS OF APPENDIX E OF THE 2014 OREGON STRUCTURAL SPECIALTY CODE (THE INTERNATIONAL BUILDING CODE AS AMENDED BY THE BUILDING CODES DIVISION OF THE OREGON DEPARTMENT OF CONSUMER AND BUSINESS SERVICES), FEDERAL REGULATIONS OF THE ADA (AMERICANS WITH DISABILITIES ACT), AND GUIDELINES FOUND IN THE ADA ACCESSIBILITY GUIDELINES (ADAAG).

LAND USE & BUILDING CODE

BASE ZONE: CXd "CENTRAL COMMERCIAL - DESIGN" WATER & SEWER SERVICE: BUREAU OF ENVIRONMENTAL SERVICES / CITY OF PORTLAND / PORTLAND WATER BUREAU LOT AREA: 59,961.4± SF (1.38 ACRES) LOT COVERAGE: 45,328.4± SF (2 BLDGS) = 75.6% TENANT LEASED AREA (GROSS): 10,466 SF (ON 2 STORIES) TENANT LEASED AREA (NET): 9993.9 (ON 2 STORIES)

PARKING & TRANSPORTATION

VEHICLE PARKING: 85 DEDICATED RETAIL PARKING SPACES PROVIDED ON TOP LEVEL OF 3-LEVEL UNDERGROUND GARAGE. BIKE PARKING: 5 EXISTING BICYCLE RACKS ON W 19TH AVE.; SEE 2/A1.0 FOR LOCATIONS, EXISTING RACKS WITH SPACE FOR APPROX, 20 BICYCLES ON TOP LEVEL OF PARKING GARAGE.

TRANSIT ACCESS: PORTLAND TRI-MET STOP/SHELTER WITHIN 200' OF BUILDING ENTRANCE; SEE 2/A1.0 FOR LOCATION

NO PROPOSED CHANGES TO BUILDING SHELL OR GROSS FLOOR AREA. CONSTRUCTION TYPE: TYPE I-B (SPRINKLERED PER NFPA 13) BUILDING STORIES: 6 AND 3 BELOW GRADE PARKING LEVELS OF PARAPET TO SIDEWALK AVERAGES APPROX. 67'-6"

TENANT SPACE USE & OCCUPANCY

CLASSIFICATION

EXISTING OCCUPANCY CLASSIFICATIONS AND USE M: RETAIL SALES PROPOSED OCCUPANCY CLASSIFICATIONS AND USE:

M: RETAIL SALES; A-2: ASSEMBLY (RESTAURANT); A-3: ASSEMBLY (RECREATIONAL SPACES - TOURNAMENT ROOM) BUILDING TO COMPLY WITH IBC 508.3 NONSEPARATED OCCUPANCIES.

PER 508.3.1 THE MOST RESTRICTIVE APPLICABLE PROVISIONS OF SECTION 403 AND CHAPTER 9 SHALL APPLY. MINIMUM 1 HOUR FIRE SEPARATION FROM ADJACENT EXIT ACCESS CORRIDOR AND MINIMUM 2 HOUR SEPARATION FROM ADJACENT PARKING GARAGE ACCESS, PARKING LEVELS BELOW, AND R-2 OCCUPANCY ABOVE. TOTAL OCCUPANTS = 430 OCCUPANTS

NOTE: SEE SHEETS A1.1 FOR OCCUPANCY DIAGRAMS & TABULATIONS, A6.0 FOR ASSEMBLY TYPES

EXIT WIDTH CALCULATION

0.2" WIDTH PER OCCUPANT SERVED @ STAIRS (FULLY SPRINKLERED 0.2" WIDTH PER OCCUPANT SERVED @ OTHER EGRESS COMPONENTS

REQUIRED EXIT WIDTH @ FIRST FLOOR 430 OCCUPANTS X 0.2" = 86"

PROVIDED EXIT WIDTH @ FIRST FLOOR = 180"

ENERGY & LIGHTING CALCULATIONS

NO PROPOSED CHANGES TO BUILDING ENVELOPE SEE LIGHTING DESIGNERS DRAWINGS AND COMCHECK FORM FOR REQUIRED INFORMATION

DEFFERED SUBMITTALS & SEPARATE PERMITS

-ELECTRICAL PERMIT -EXTERIOR SIGN PERMIT & FLS PERMITS

-MECHANICAL PERMIT -PLUMBING PERMIT

DRAWING INDEX

ARCHITECTURAL

A-0.0 GENERAL INFORMATION A-1.0 SITE PLAN / DEMOLITION PLAN / EXISTING BUILDING PLAN A-1.1 OCCUPANCY / EXITING / EGRESS / ACCESSIBLE PATH &

A-2.6 FIRST FLOOR REFLECTED CEILING PLAN (WEST)

LIGHTING DIAGRAMS / LEVEL 01 PARKING PLAN A-2.0 FIRST FLOOR PLAN (WEST)

A-2.1 FIRST FLOOR PLAN (EAST) A-2.2 FIRST FLOOR FINISH PLAN (WEST)

BUILDING OWNER (LEASOR) CIVIC RETAIL LLC A-2.3 FIRST FLOOR FINISH PLAN (EAST) A-2.4 FIRST FLOOR FURNITURE & EQUIPMENT PLAN (WEST) CALISTA REAL ESTATE LLC A-2.5 FIRST FLOOR FURNITURE & EQUIPMENT PLAN (EAST) 5015 BUSINESS PARK BLVD #3000

A-2.7 FIRST FLOOR REFLECTED CEILING PLAN (EAST) A-2.8 ENLARGED PLANS & MEZZANINE PLANS EMAIL: DABEL@ENAHOLDINGLLC.COM

A-3.0 EXTERIOR ELEVATIONS & BUILDING SECTIONS A-5.0 INTERIOR ELEVATIONS

A-5.1 INTERIOR ELEVATIONS A-5.2 INTERIOR ELEVATIONS

A-5.3 INTERIOR ELEVATIONS A-5.4 INTERIOR ELEVATIONS A-5.5 INTERIOR ELEVATIONS 206-322-6249 VOICE 206-322-6402 FAX

A-6.0 ASSEMBLY TYPES A-6.1 DOOR SCHEDULE AND NOTES A-6.2 SCHEDULES AND NOTES

A-7.0 ACCESSIBILITY DIAGRAMS & NOTES A-7.1 ACCESSIBILITY DIAGRAMS & NOTES A-7.2 DETAILS A-7.3 DETAILS

A-7.4 DETAILS A-8.0 DETAILS A-8.1 DETAILS

A-8.2 DETAILS STRUCTURAL ENGINEER STRUCTURAL GENERAL NOTES AND SPECIAL INSPECTION S-2.1 STAIR FRAMING PLAN AND FOLDING DOOR ELEVATIONS

S-3.1 STRUCTURAL DETAILS LIGHTING CONSULTANT


LD-0.1 LIGHTING FIXTURE SCHEDULE LD-0.1 LIGHTING FIXTURE SCHEDULE FIRST FLOOR LIGHTING PLAN (WEST) LD-2.0 LD-2.1 FIRST FLOOR LIGHTING PLAN (EAST) **FOODSERVICE CONSULTANT**

FOODSERVICE EQUIPMENT PLAN FOODSERVICE EQUIPMENT SCHEDULE K-3 FOODSERVICE ELECTRICAL ROUGH-IN PLAN


FOODSERVICE PLUMBING ROUGH-IN PLAN FOODSERVICE WALL BACKING PLAN FOODSERVICE UNDERSLAB ROUGH-IN PLAN

(1938 WEST BURNSIDE S

VICINITY MAP NO SCALE

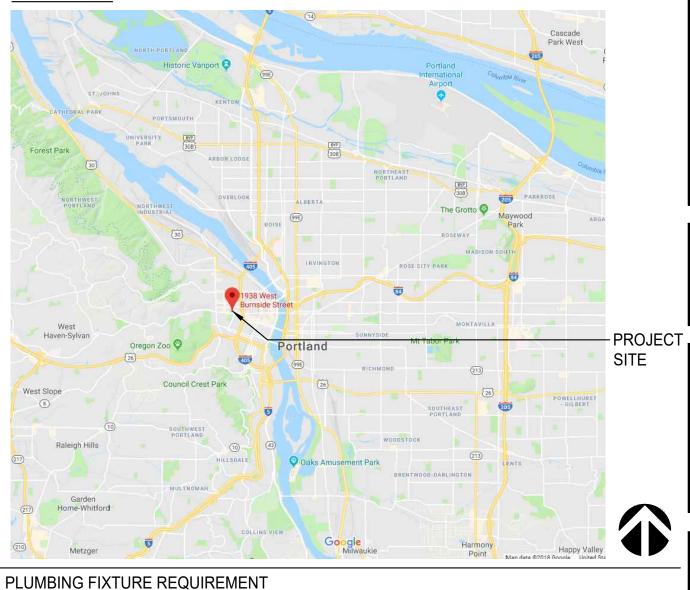

REQUIRED FIXTURES PER IBC TABLE 2902.1 FROM 2015 OSSC AS AMENDED BY THE CITY OF PORTLAND

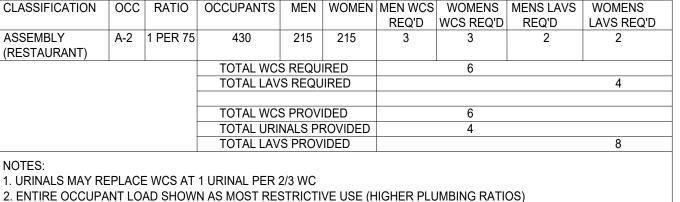

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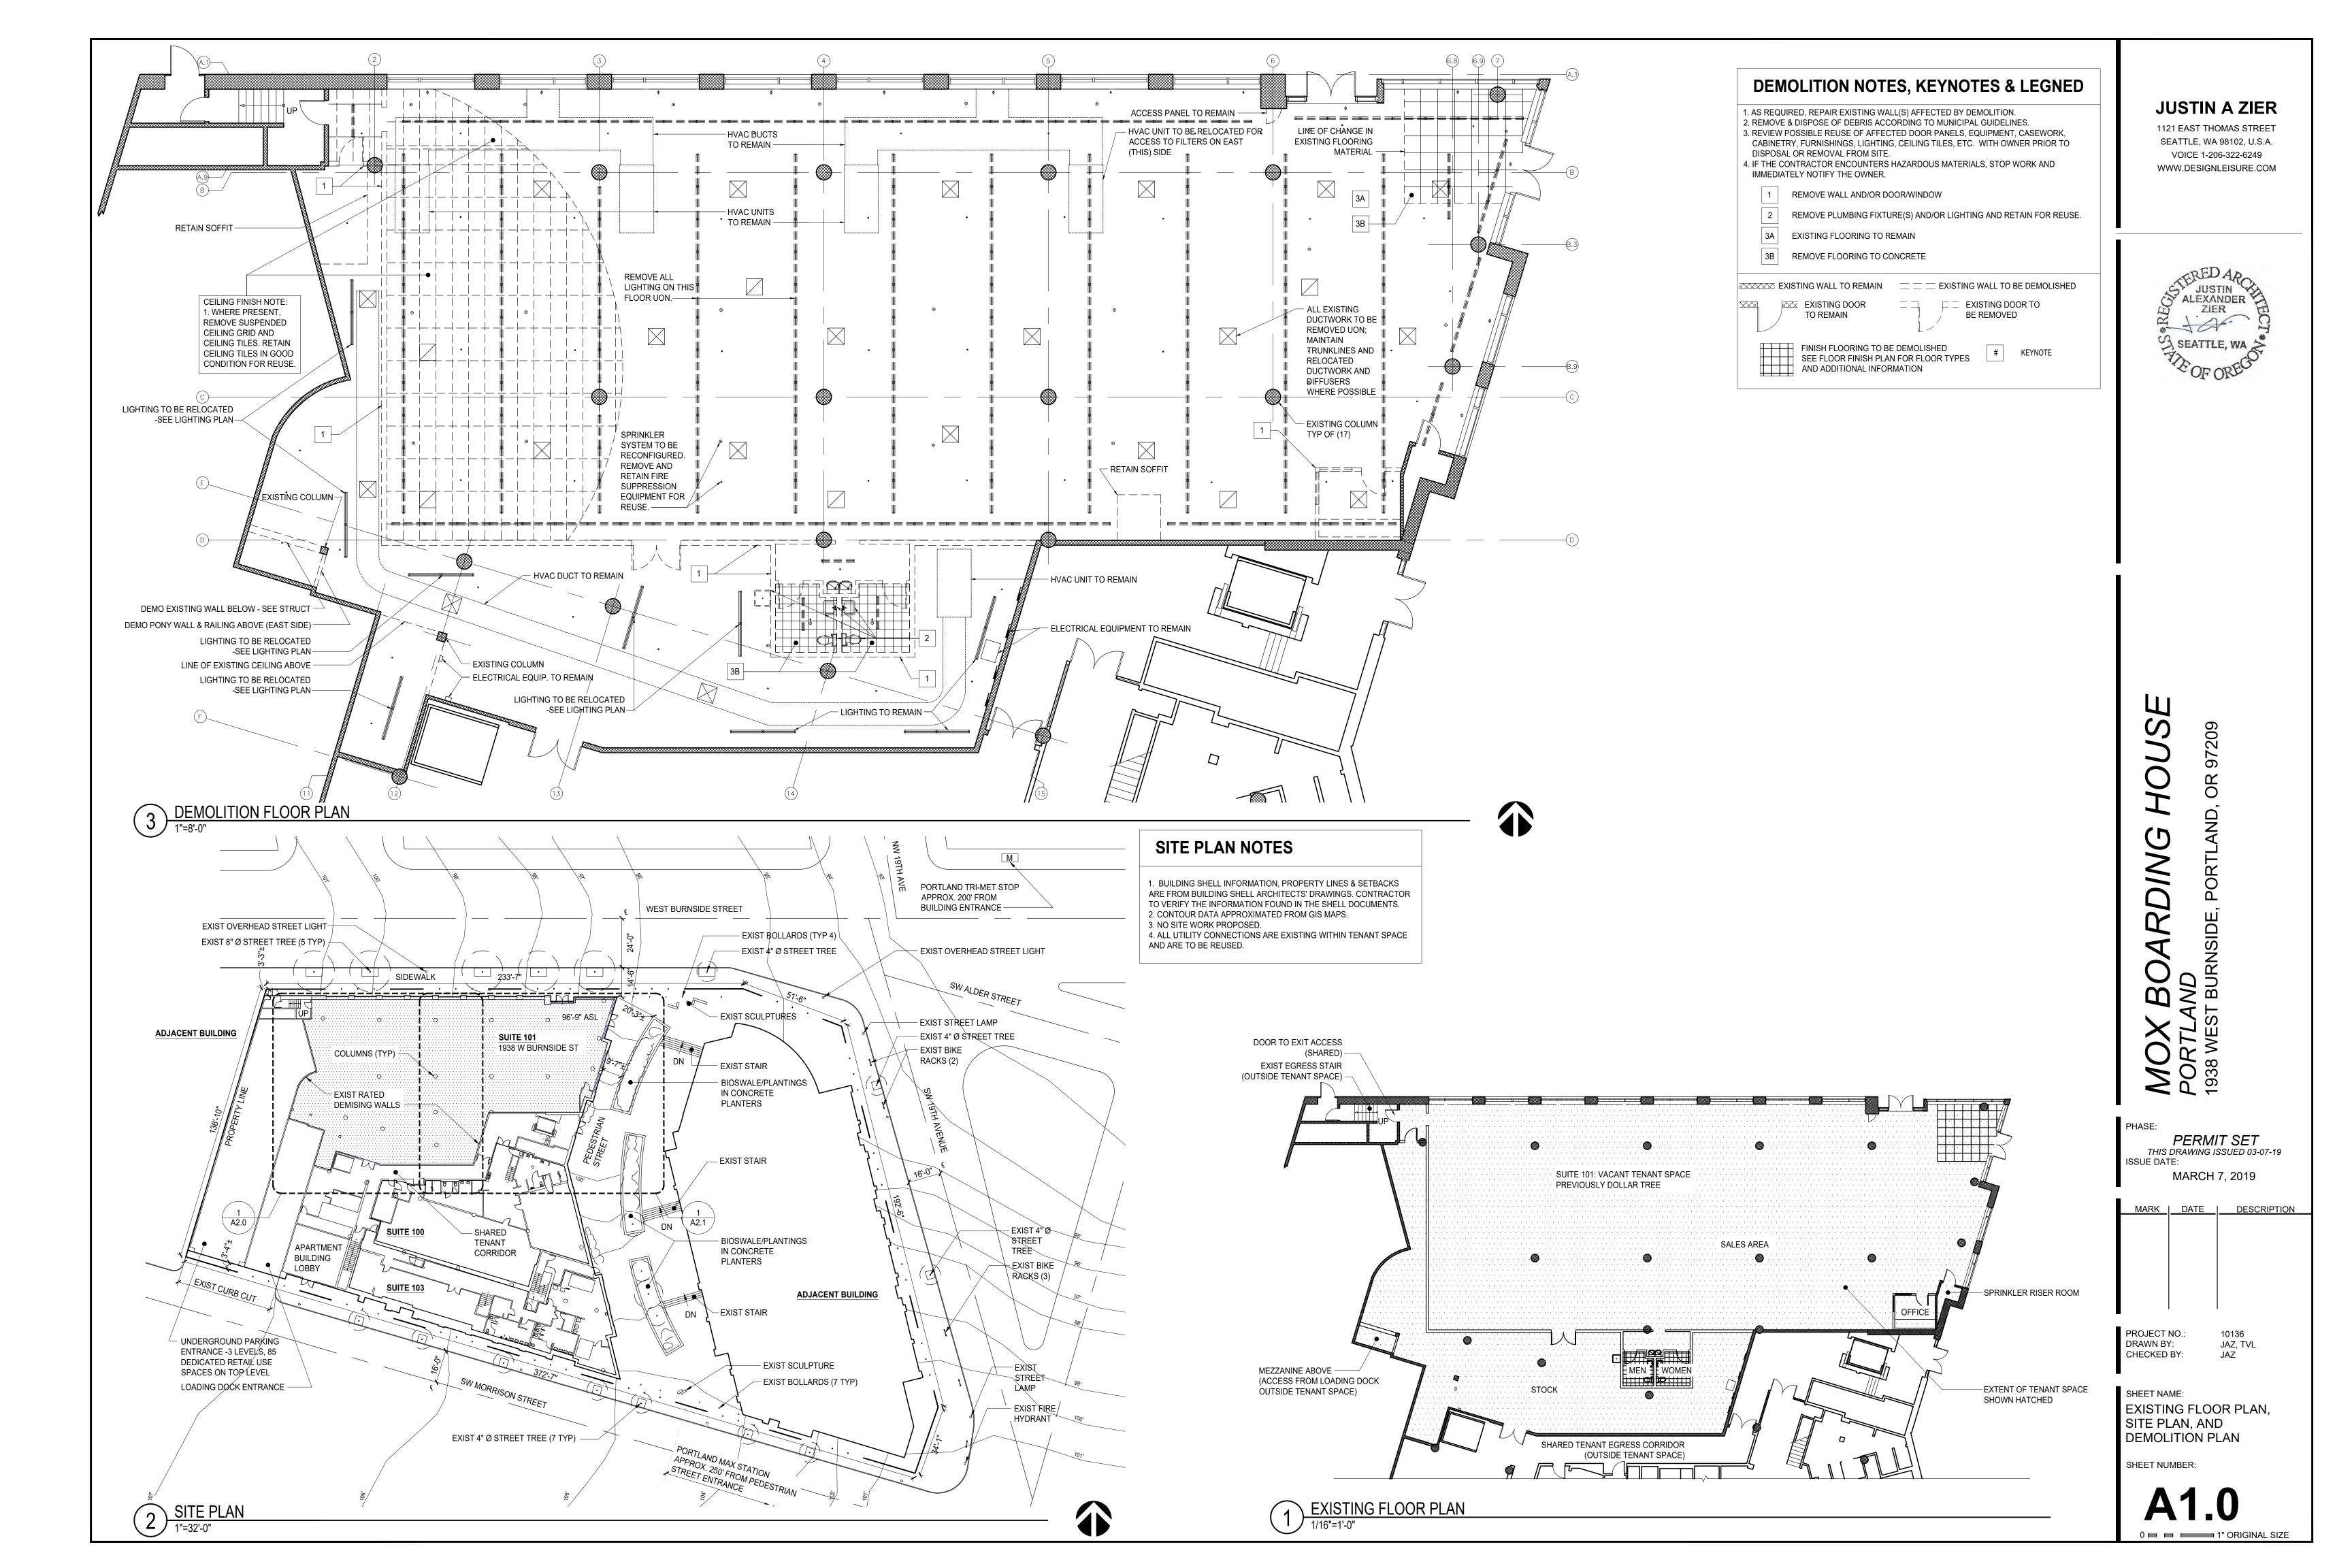
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JAZ, TVL JAZ

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GENERAL INFORMATION

SHEET NUMBER:






EXIT DISCHARGE UTILITY TO PUBLIC WAY

EXIT ACCESS (TO SHARED FIRE D26) STAIR WITH AREA OF REFUGE)

3 EXITING/EGRESS AND ACCESSIBLE PATH PLAN DIAGRAM
1/16"=1'-0"

EXIT DISCHARGE 32" REQ'D, 36" PER ADA (36" PROVIDED)

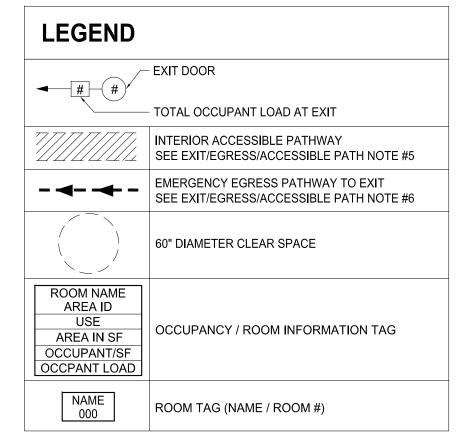

FLOOR AREA ALLOWANCES (FROM CHAPTER 10, TABLE 1004.1.1)

ASSEMBLY WITHOUT FIXED SEATING
UNCONCENTRATED: 1/15 NET
CONCENTRATED: 1/7 NET

BOOTH/BANQUETTE: 1/24" MERCANTILE

STORAGE / STOCK / ACCESSORY: 1/300 GROSS GRADE FLOOR AREAS: 1/30 GROSS

BUSINESS BUSINESS AREAS: 1/100 GROSS

KITCHENS, COMMERCIAL: 1/200 GROSS

ACCESSORY/ MECHANICAL: 1/500 GROSS

NOTES

SIGN LOCATIONS.

1. SEE A1.1 FOR ADDITIONAL EXITING / EGRESS / ACCESSIBLE INFORMATION.

2. SEE FLOOR PLAN ON A2.0 AND A2.1 FOR FIRE EXTINGUISHER TYPES AND LOCATIONS

3. SEE REFLECTED CEILING PLAN ON A2.6 AND A2.7 FOR ADDITIONAL EMERGENCY EGRESS LIGHTING INFORMATION.

4. SEE REFLECTED CEILING PLAN ON A2.6 AND A2.7 FOR EXIT

5. SEE COVER SHEET FOR ADDITIONAL OCCUPANT LOAD & EGRESS/EXITING CALCULATIONS AND INFORMATION.

6. PROVIDE ACCESSIBLE PATH OF TRAVEL WITHIN TYPICAL CUSTOMER AND/OR COMMON EMPLOYEE AREAS OF LEASED SPACE. ENTIRE LENGTH OF ACCESSIBLE PATHWAY TO BE MINIMUM 36" CLEAR WIDTH WITH MAXIMUM SLOPE OF 1/20. FOR ADDITIONAL INFORMATION, SEE ACCESSIBILITY DIAGRAMS & NOTES ON A7.0 AND A7.1.

7. PROVIDE EMERGENCY EGRESS PATHWAY WITHIN INTERIOR OF LEASED SPACE TO DESIGNATED EMERGENCY EXITS. ENTIRE LENGTH OF EGRESS PATHWAY TO BE MINIMUM 44" CLEAR WIDTH WITH MAXIMUM SLOPE OF 1/20. PER 1009.1, EXCEPTION #1: MINIMUM 36" WIDTH ALLOWED WHERE OCCUPANT LOAD SERVED IS < 50

8. DOORS D01, D26, & D27 TO BE PROVIDED WITH SIGN STATING: "EXIT DOOR TO REMAIN UNLOCKED DURING BUSINESS HOURS"

9. EXISTING PANIC HARDWARE ON DOORS D01, D26 & D27 TO

10. PER OSSC 1014.3, TABLE 1014.3, THE COMMON PATH OF EGRESS TRAVEL WILL NOT EXCEED 75'.

11. PER OSSC 1004.3, ROOMS 115-119 SHALL HAVE THE OCCUPANT LOAD OF THE ROOM OR SPACE POSTED IN A CONSPICUOUS PLACE, NEAR THE MAIN EXIT OR EXIT ACCESS DOORWAY FROM THE ROOM OR SPACE.

OCCUPANCY TABULATION

ID	DESCRIPTION	OCCUPANTS
116	CAFE	162
	UNCONCENTRATED: 1064 SF / 15 SF = 71	
	FIXED SEATS: 1474 LI / 24 LI = 61 (1 OCCPANT PER 24 LINEAR INCHES (LI) OF BOOTH SEAT LENGTH)	
	CONCENTRATED: 212 SF / 7 SF = 30	
101-102	RETAIL	104
104-107	STOCK	3
113	KITCHEN	6
111, 111B	OFFICE	2
112	BREAK ROOM	2
119	TOURNAMENT	95
110	RESTROOM	15
115	PRIVATE ROOM 1	12
117	PRIVATE ROOM 2	14
118	PRIVATE ROOM 3	12
114	BACK BAR	1
108-109	UTILITY	1
200	MEZZANINE	1
	TOTAL OCCUPANCY	430

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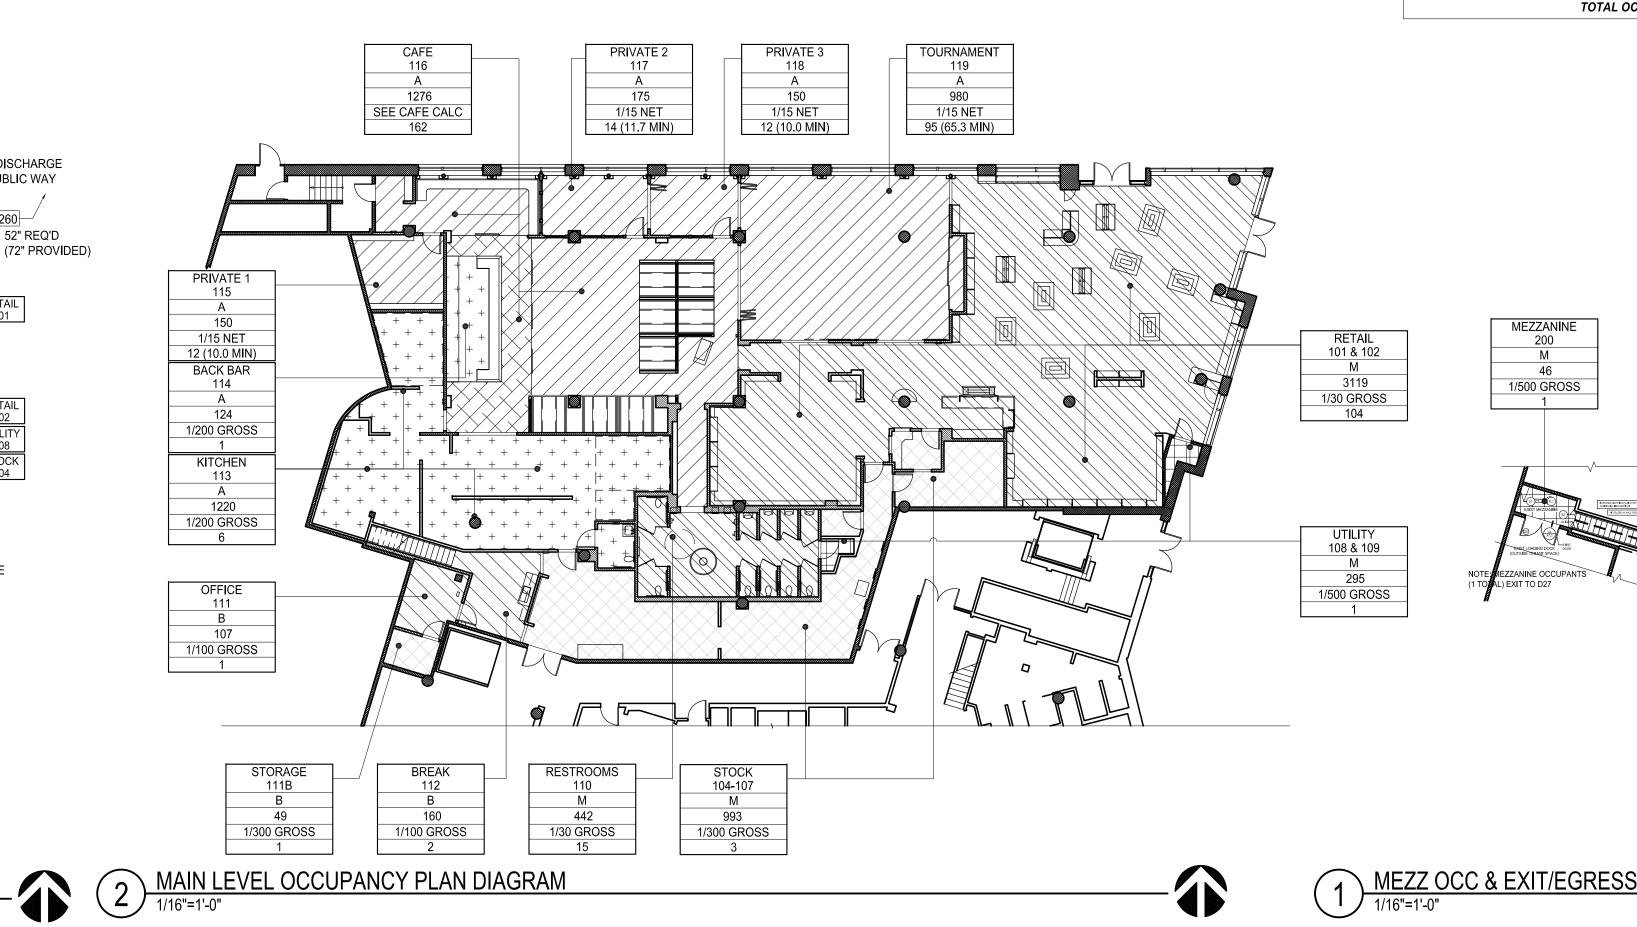
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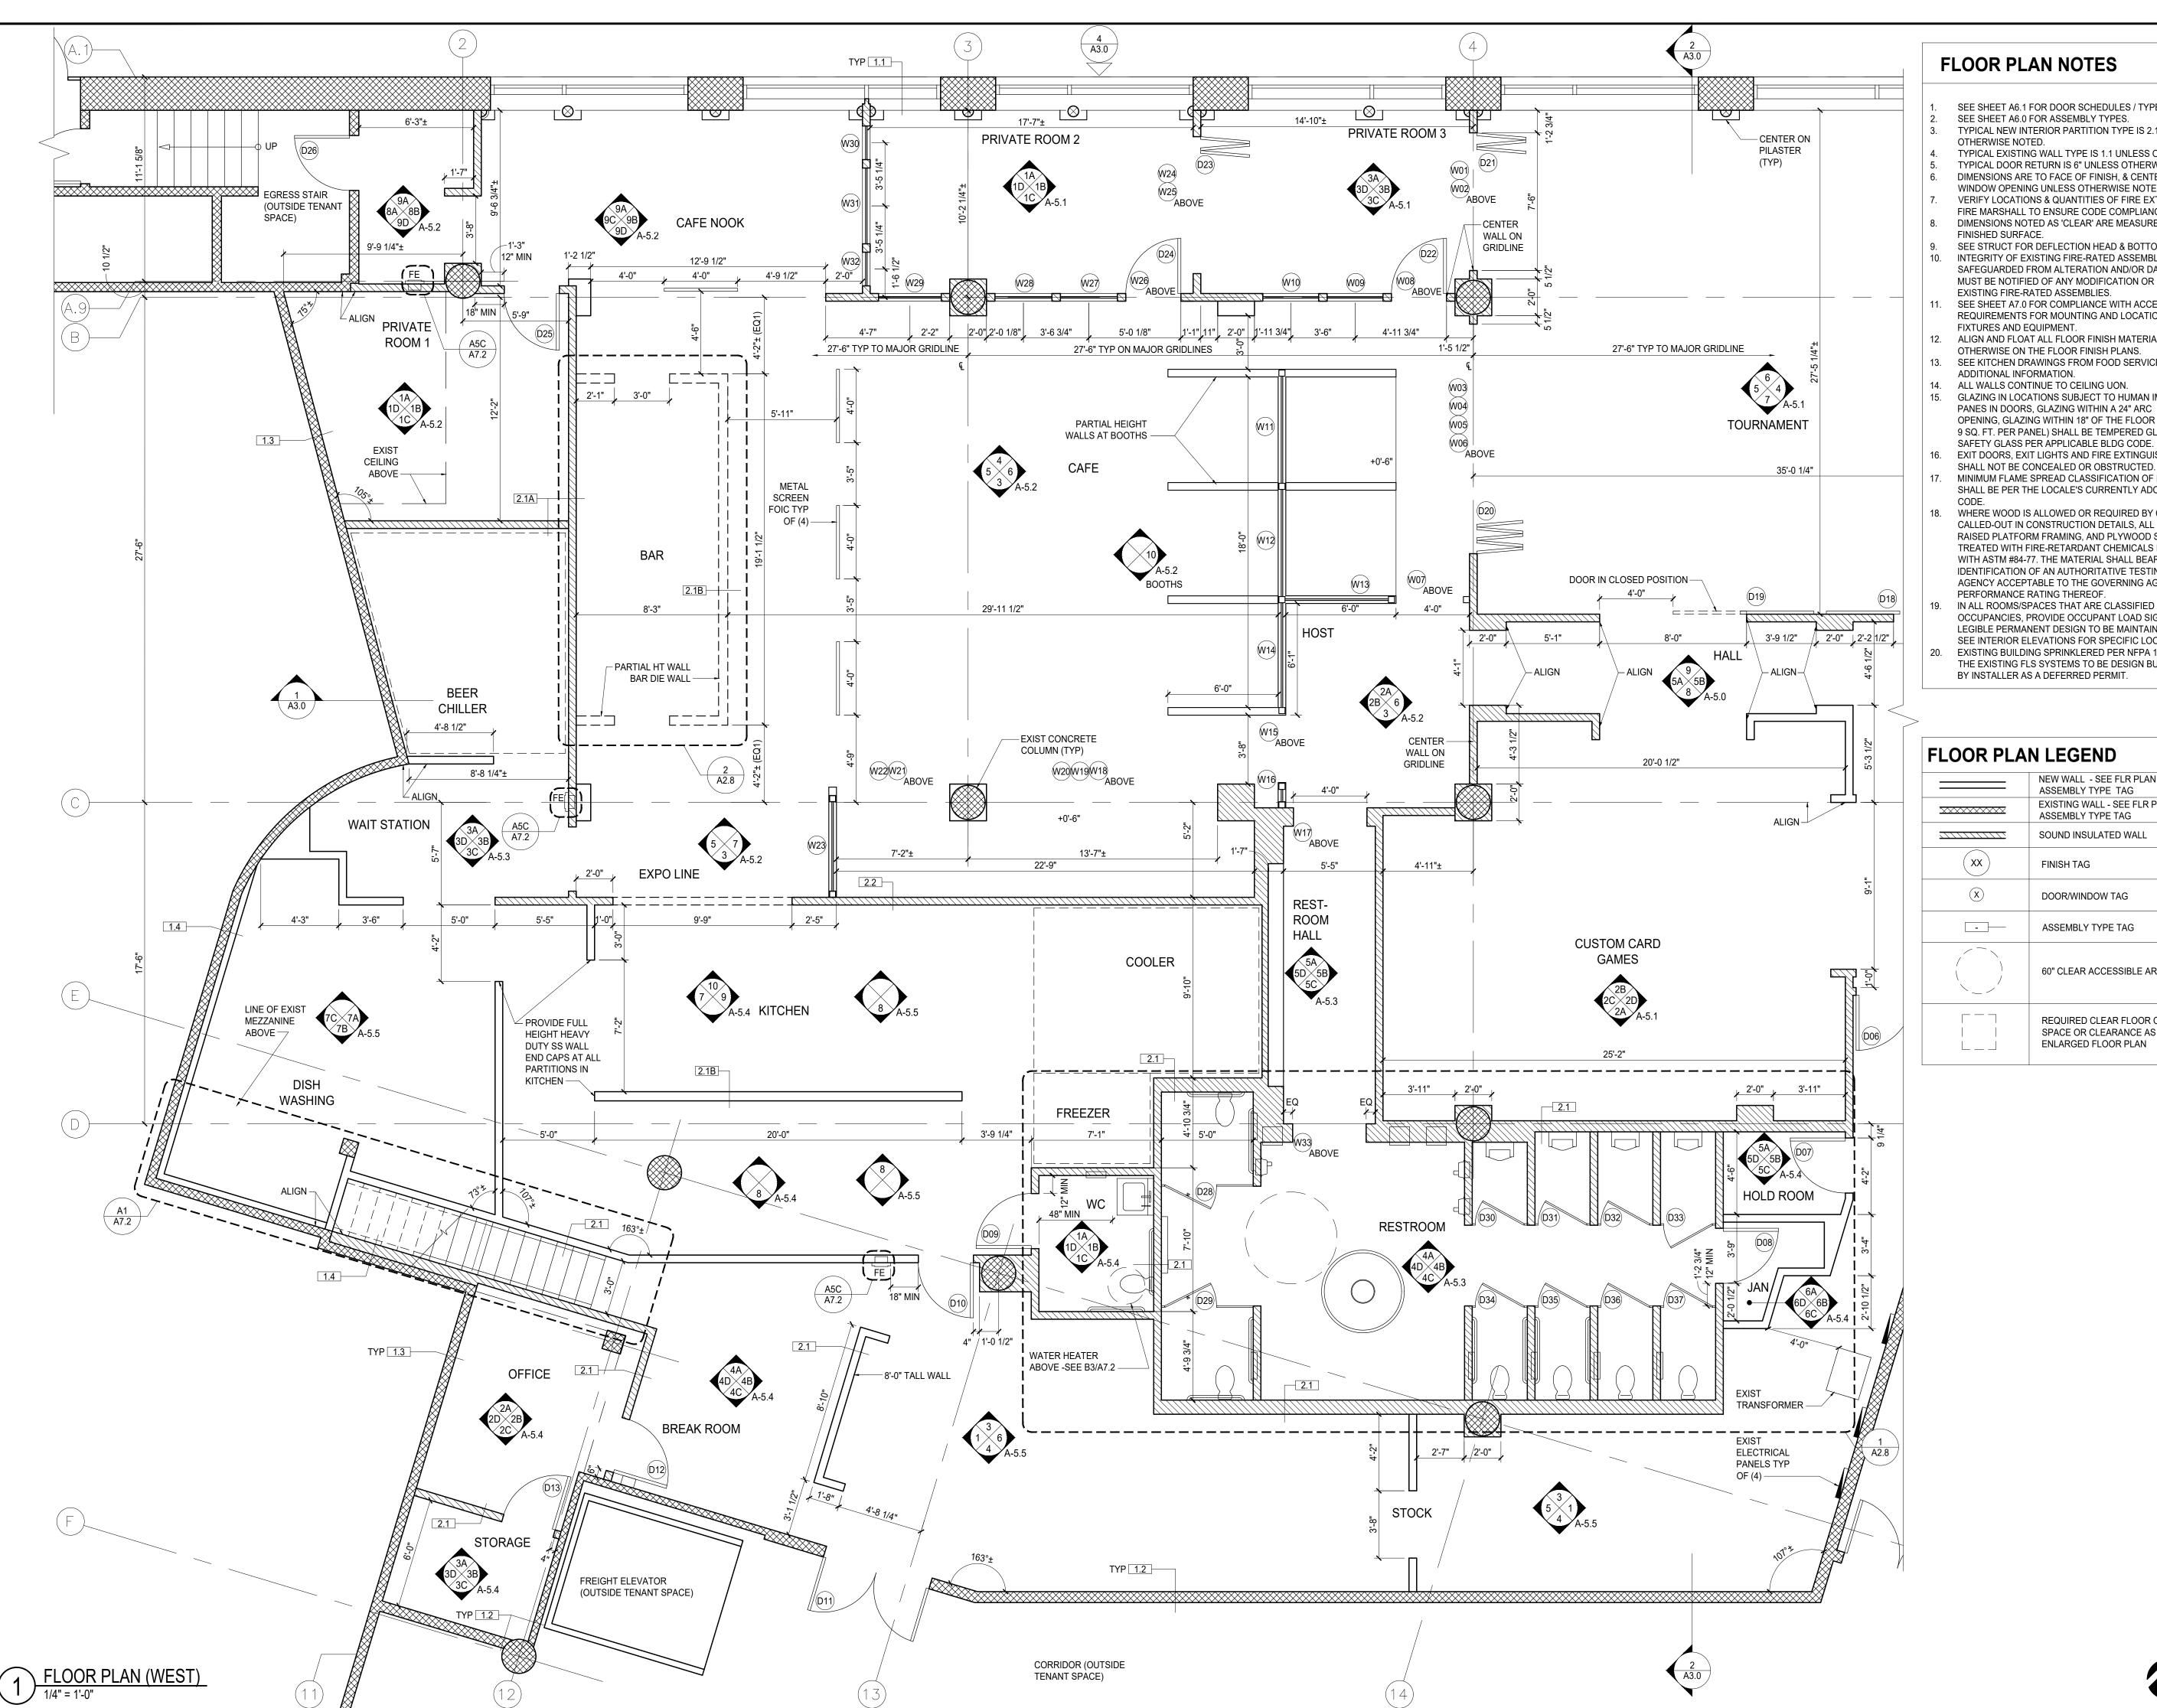
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JAZ, TVL

SHEET NAME: PARKING, EGRESS, OCCUPANCY ANALYSIS & LIFE SAFETY PLAN

SHEET NUMBER:





FLOOR PLAN NOTES

- SEE SHEET A6.1 FOR DOOR SCHEDULES / TYPES. SEE SHEET A6.0 FOR ASSEMBLY TYPES.
- TYPICAL NEW INTERIOR PARTITION TYPE IS 2.1 UNLESS
- TYPICAL EXISTING WALL TYPE IS 1.1 UNLESS OTHERWISE NOTED. TYPICAL DOOR RETURN IS 6" UNLESS OTHERWISE NOTED.
- DIMENSIONS ARE TO FACE OF FINISH, & CENTERLINE OF DOOR OR WINDOW OPENING UNLESS OTHERWISE NOTED.
- VERIFY LOCATIONS & QUANTITIES OF FIRE EXTINGUISHERS WITH FIRE MARSHALL TO ENSURE CODE COMPLIANCE.
- DIMENSIONS NOTED AS 'CLEAR' ARE MEASURED TO FACE OF FINISHED SURFACE. SEE STRUCT FOR DEFLECTION HEAD & BOTTOM TRACK DETAILS.
- 10. INTEGRITY OF EXISTING FIRE-RATED ASSEMBLIES ARE TO BE SAFEGUARDED FROM ALTERATION AND/OR DAMAGE. ARCHITECT MUST BE NOTIFIED OF ANY MODIFICATION OR DAMAGE TO EXISTING FIRE-RATED ASSEMBLIES.
- SEE SHEET A7.0 FOR COMPLIANCE WITH ACCESSIBILITY REQUIREMENTS FOR MOUNTING AND LOCATION OF TOILET ROOM FIXTURES AND EQUIPMENT.
- 12. ALIGN AND FLOAT ALL FLOOR FINISH MATERIALS UNLESS NOTED OTHERWISE ON THE FLOOR FINISH PLANS.
- 13. SEE KITCHEN DRAWINGS FROM FOOD SERVICE CONSULTANT FOR ADDITIONAL INFORMATION.
- 14. ALL WALLS CONTINUE TO CEILING UON. 15. GLAZING IN LOCATIONS SUBJECT TO HUMAN IMPACT SUCH AS PANES IN DOORS, GLAZING WITHIN A 24" ARC OF A DOOR OPENING, GLAZING WITHIN 18" OF THE FLOOR (AND WHERE OVER 9 SQ. FT. PER PANEL) SHALL BE TEMPERED GLASS OR LAMINATED
- 16. EXIT DOORS, EXIT LIGHTS AND FIRE EXTINGUISHERS LOCATIONS SHALL NOT BE CONCEALED OR OBSTRUCTED.
- 17. MINIMUM FLAME SPREAD CLASSIFICATION OF INTERIOR FINISHES SHALL BE PER THE LOCALE'S CURRENTLY ADOPTED BUILDING
- 18. WHERE WOOD IS ALLOWED OR REQUIRED BY CODE AND/OR CALLED-OUT IN CONSTRUCTION DETAILS, ALL NAILERS, BLOCKING, RAISED PLATFORM FRAMING, AND PLYWOOD SHALL BE PRESSURE TREATED WITH FIRE-RETARDANT CHEMICALS IN ACCORDANCE WITH ASTM #84-77. THE MATERIAL SHALL BEAR THE IDENTIFICATION OF AN AUTHORITATIVE TESTING OR INSPECTION AGENCY ACCEPTABLE TO THE GOVERNING AGENCY WITH THE
- PERFORMANCE RATING THEREOF. IN ALL ROOMS/SPACES THAT ARE CLASSIFIED AS ASSEMBLY OCCUPANCIES, PROVIDE OCCUPANT LOAD SIGN OF AN APPROVED LEGIBLE PERMANENT DESIGN TO BE MAINTAINED BY THE OWNER. SEE INTERIOR ELEVATIONS FOR SPECIFIC LOCATIONS.
- EXISTING BUILDING SPRINKLERED PER NFPA 13. REVISIONS TO THE EXISTING FLS SYSTEMS TO BE DESIGN BUILD AND SUBMITTED BY INSTALLER AS A DEFERRED PERMIT.

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FLOOR PLAN LEGEND

	NEW WALL - SEE FLR PLAN NOTE 3 & ASSEMBLY TYPE TAG
*********	EXISTING WALL - SEE FLR PLAN NOTE 4 & ASSEMBLY TYPE TAG
	SOUND INSULATED WALL
xx	FINISH TAG
X	DOOR/WINDOW TAG
-	ASSEMBLY TYPE TAG
	60" CLEAR ACCESSIBLE AREA
	REQUIRED CLEAR FLOOR OR GROUND SPACE OR CLEARANCE AS NOTED OR SEE ENLARGED FLOOR PLAN

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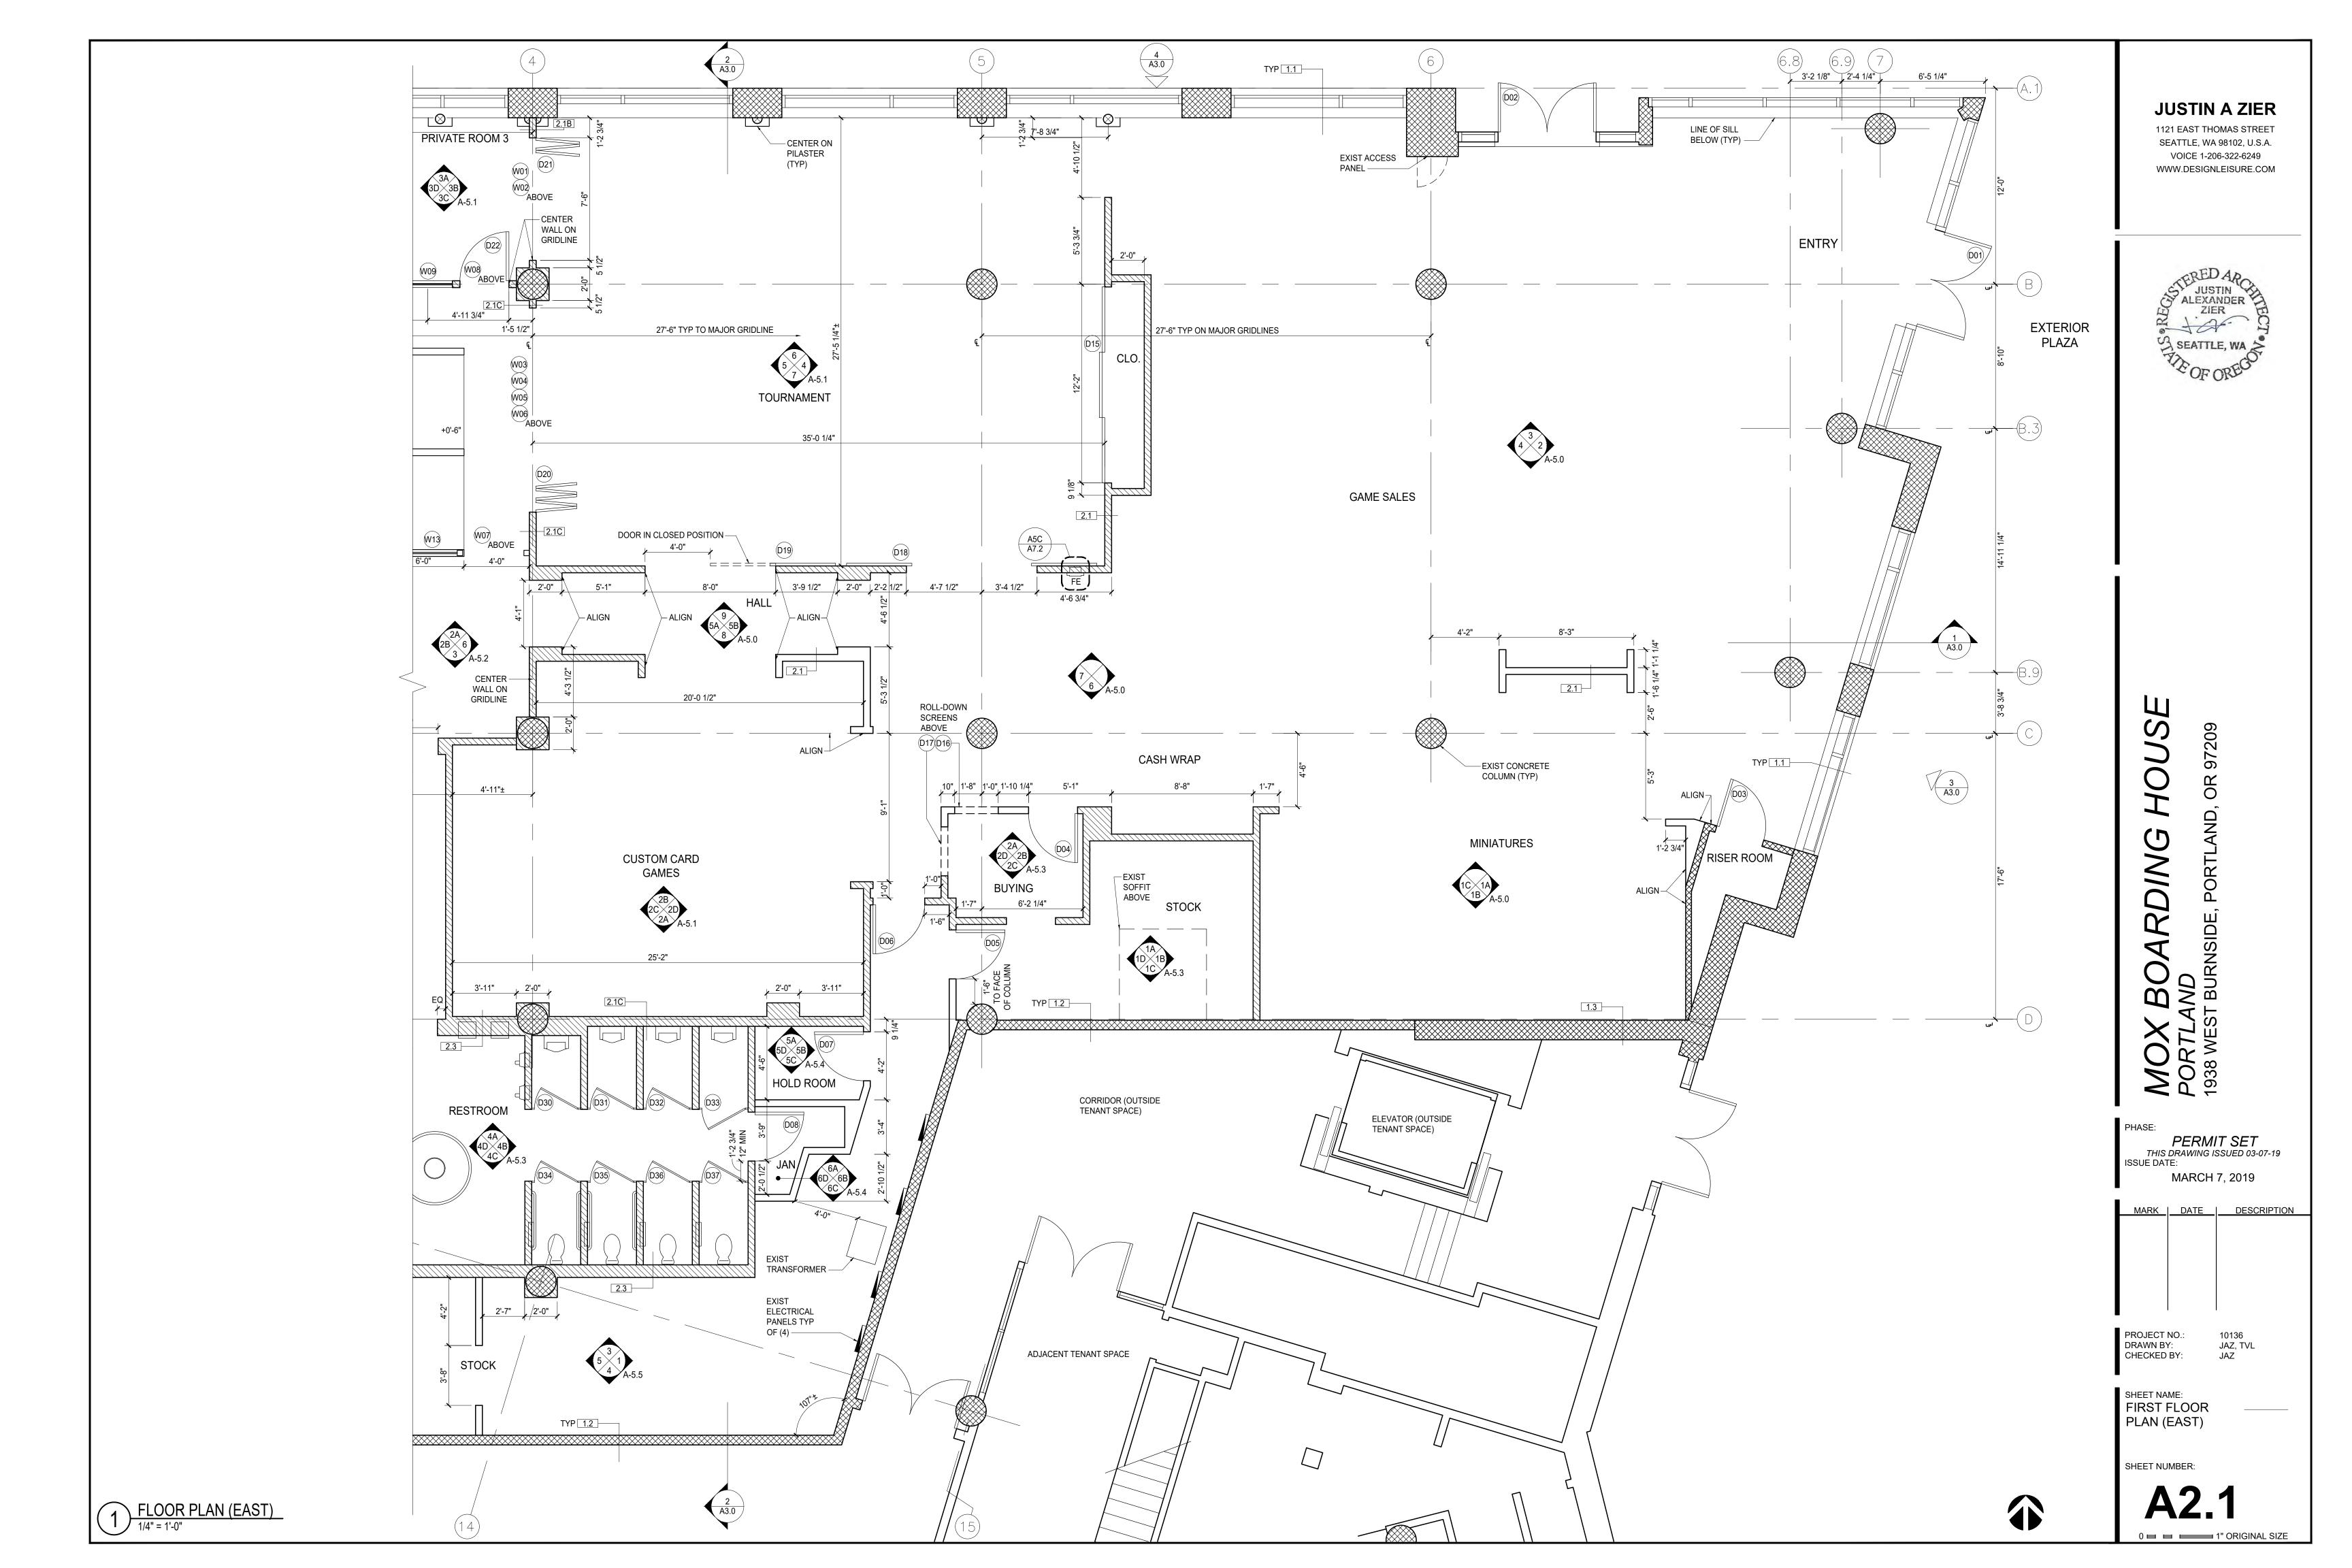
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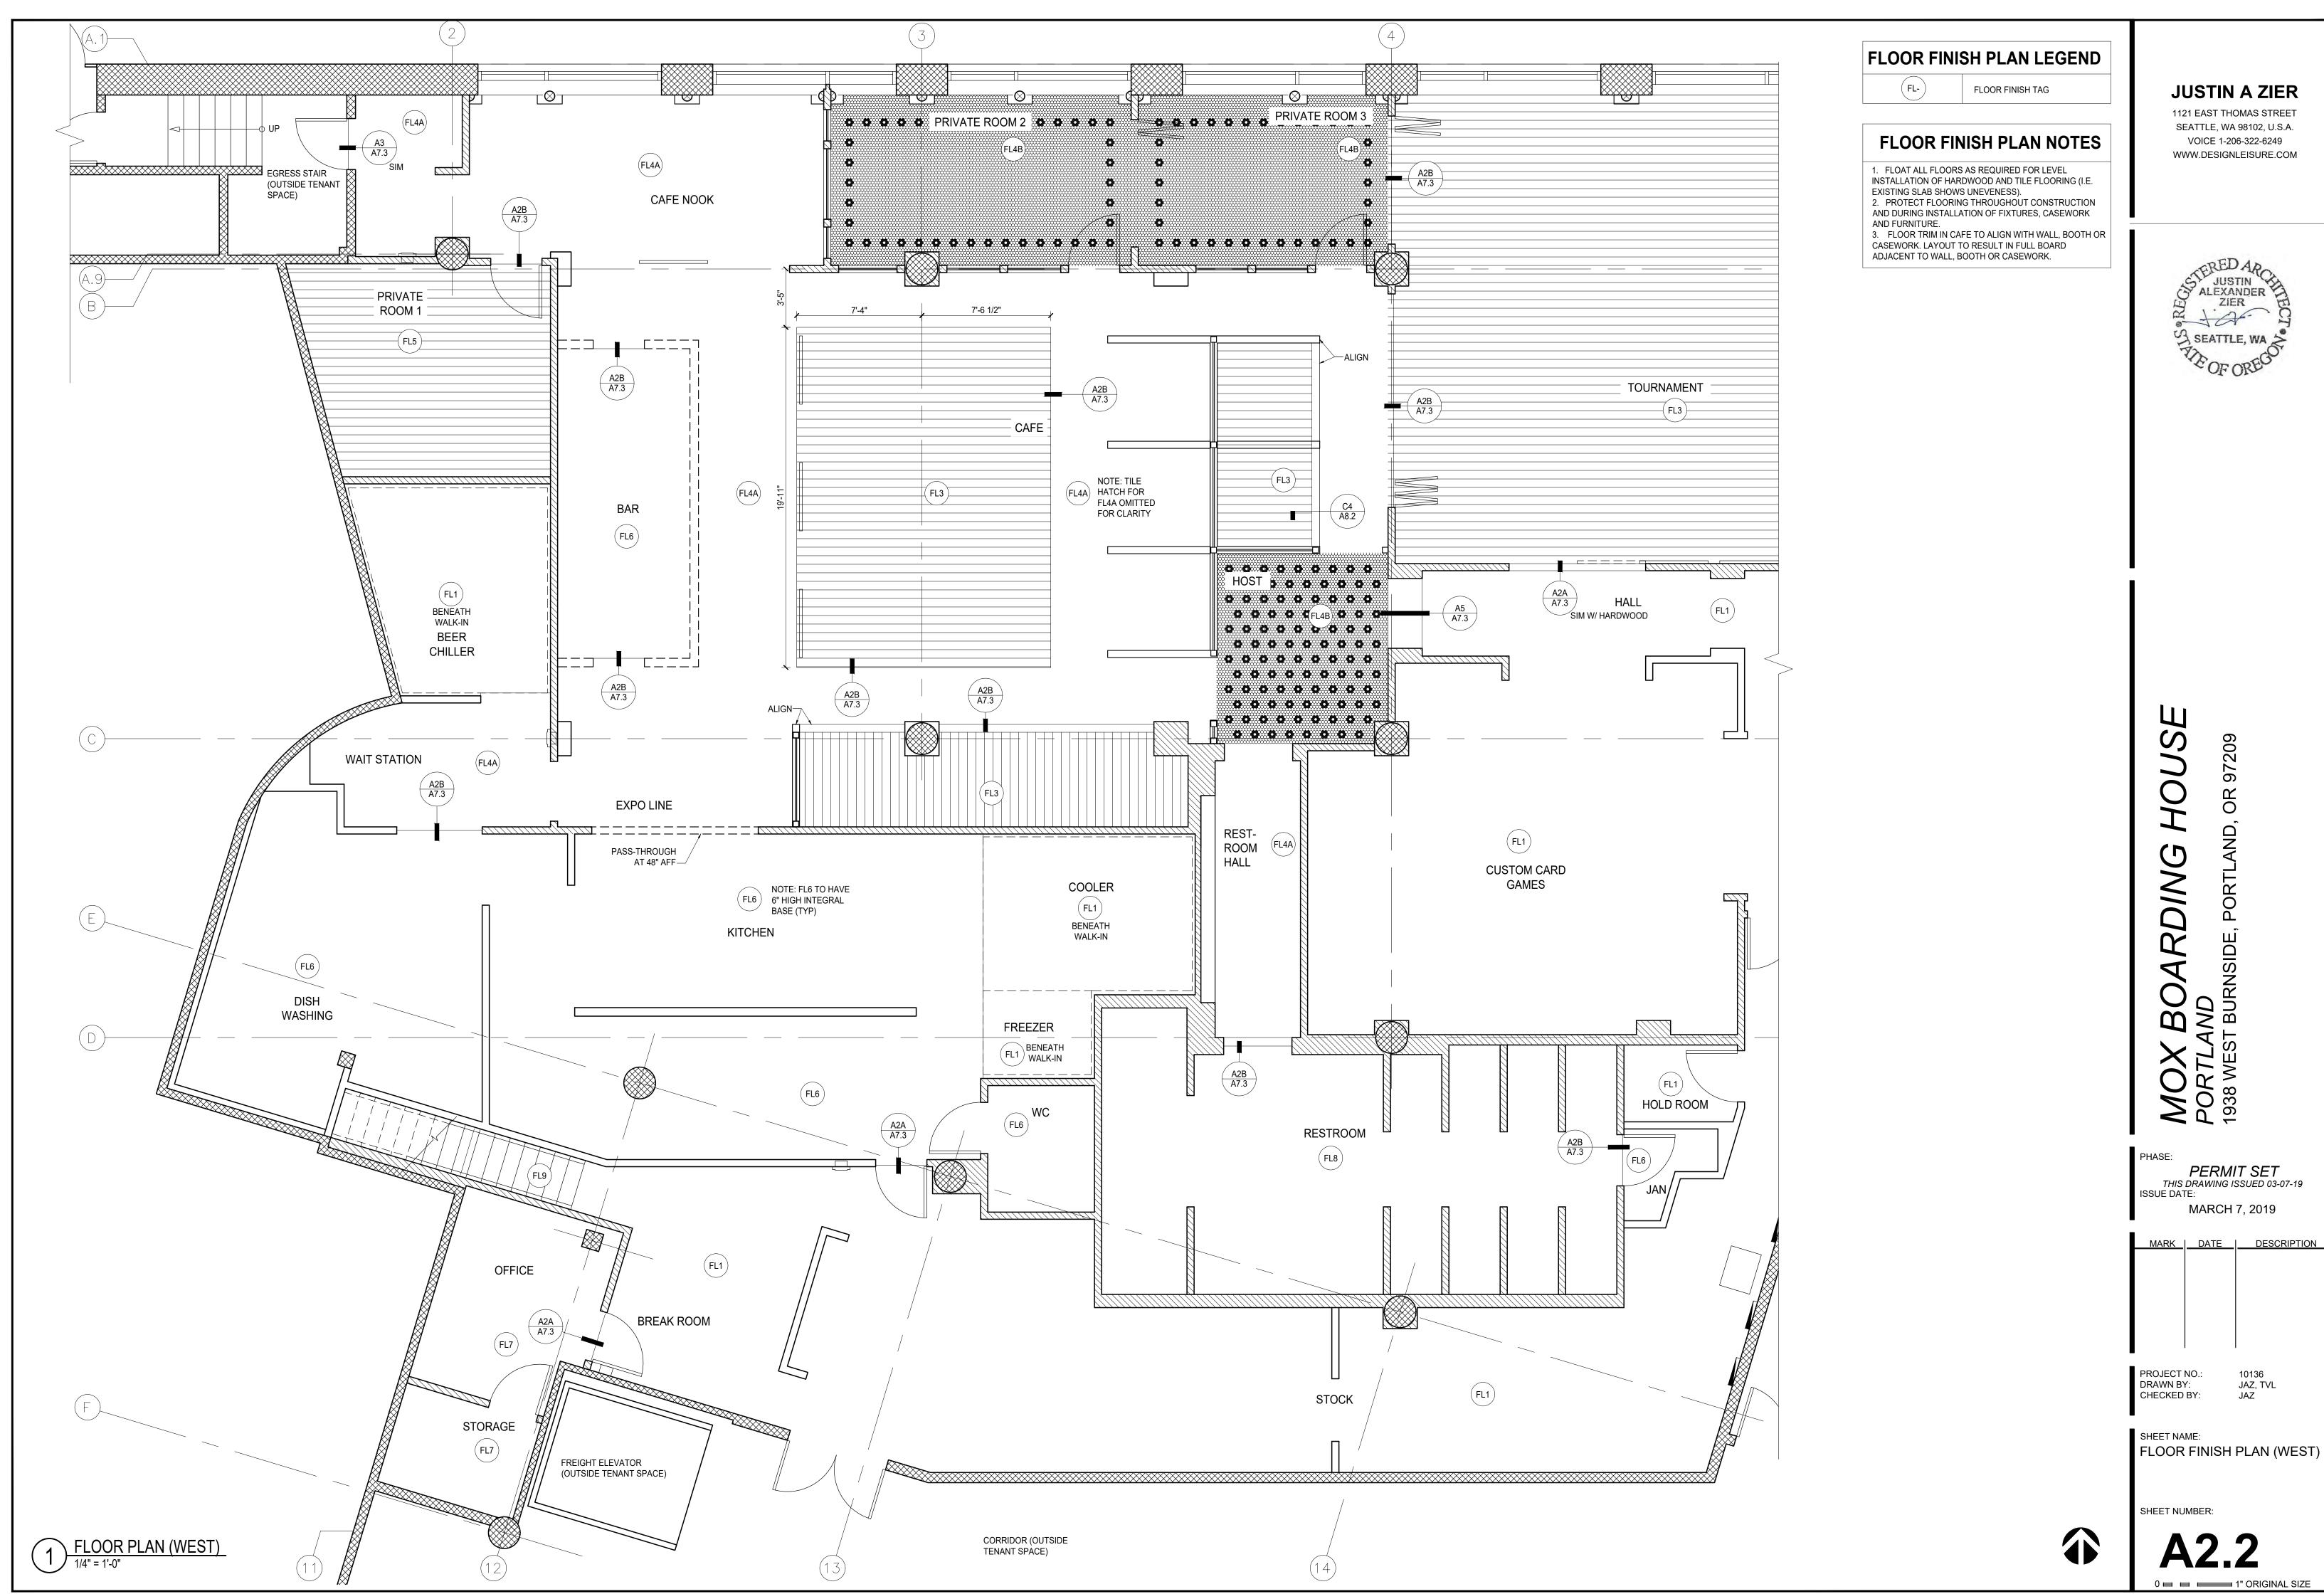
SHEET NAME: FIRST FLOOR PLAN (WEST)

SHEET NUMBER:


0 ■ ■ ■ 1" ORIGINAL SIZE








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FURNITURE & FIXTURE NOTES

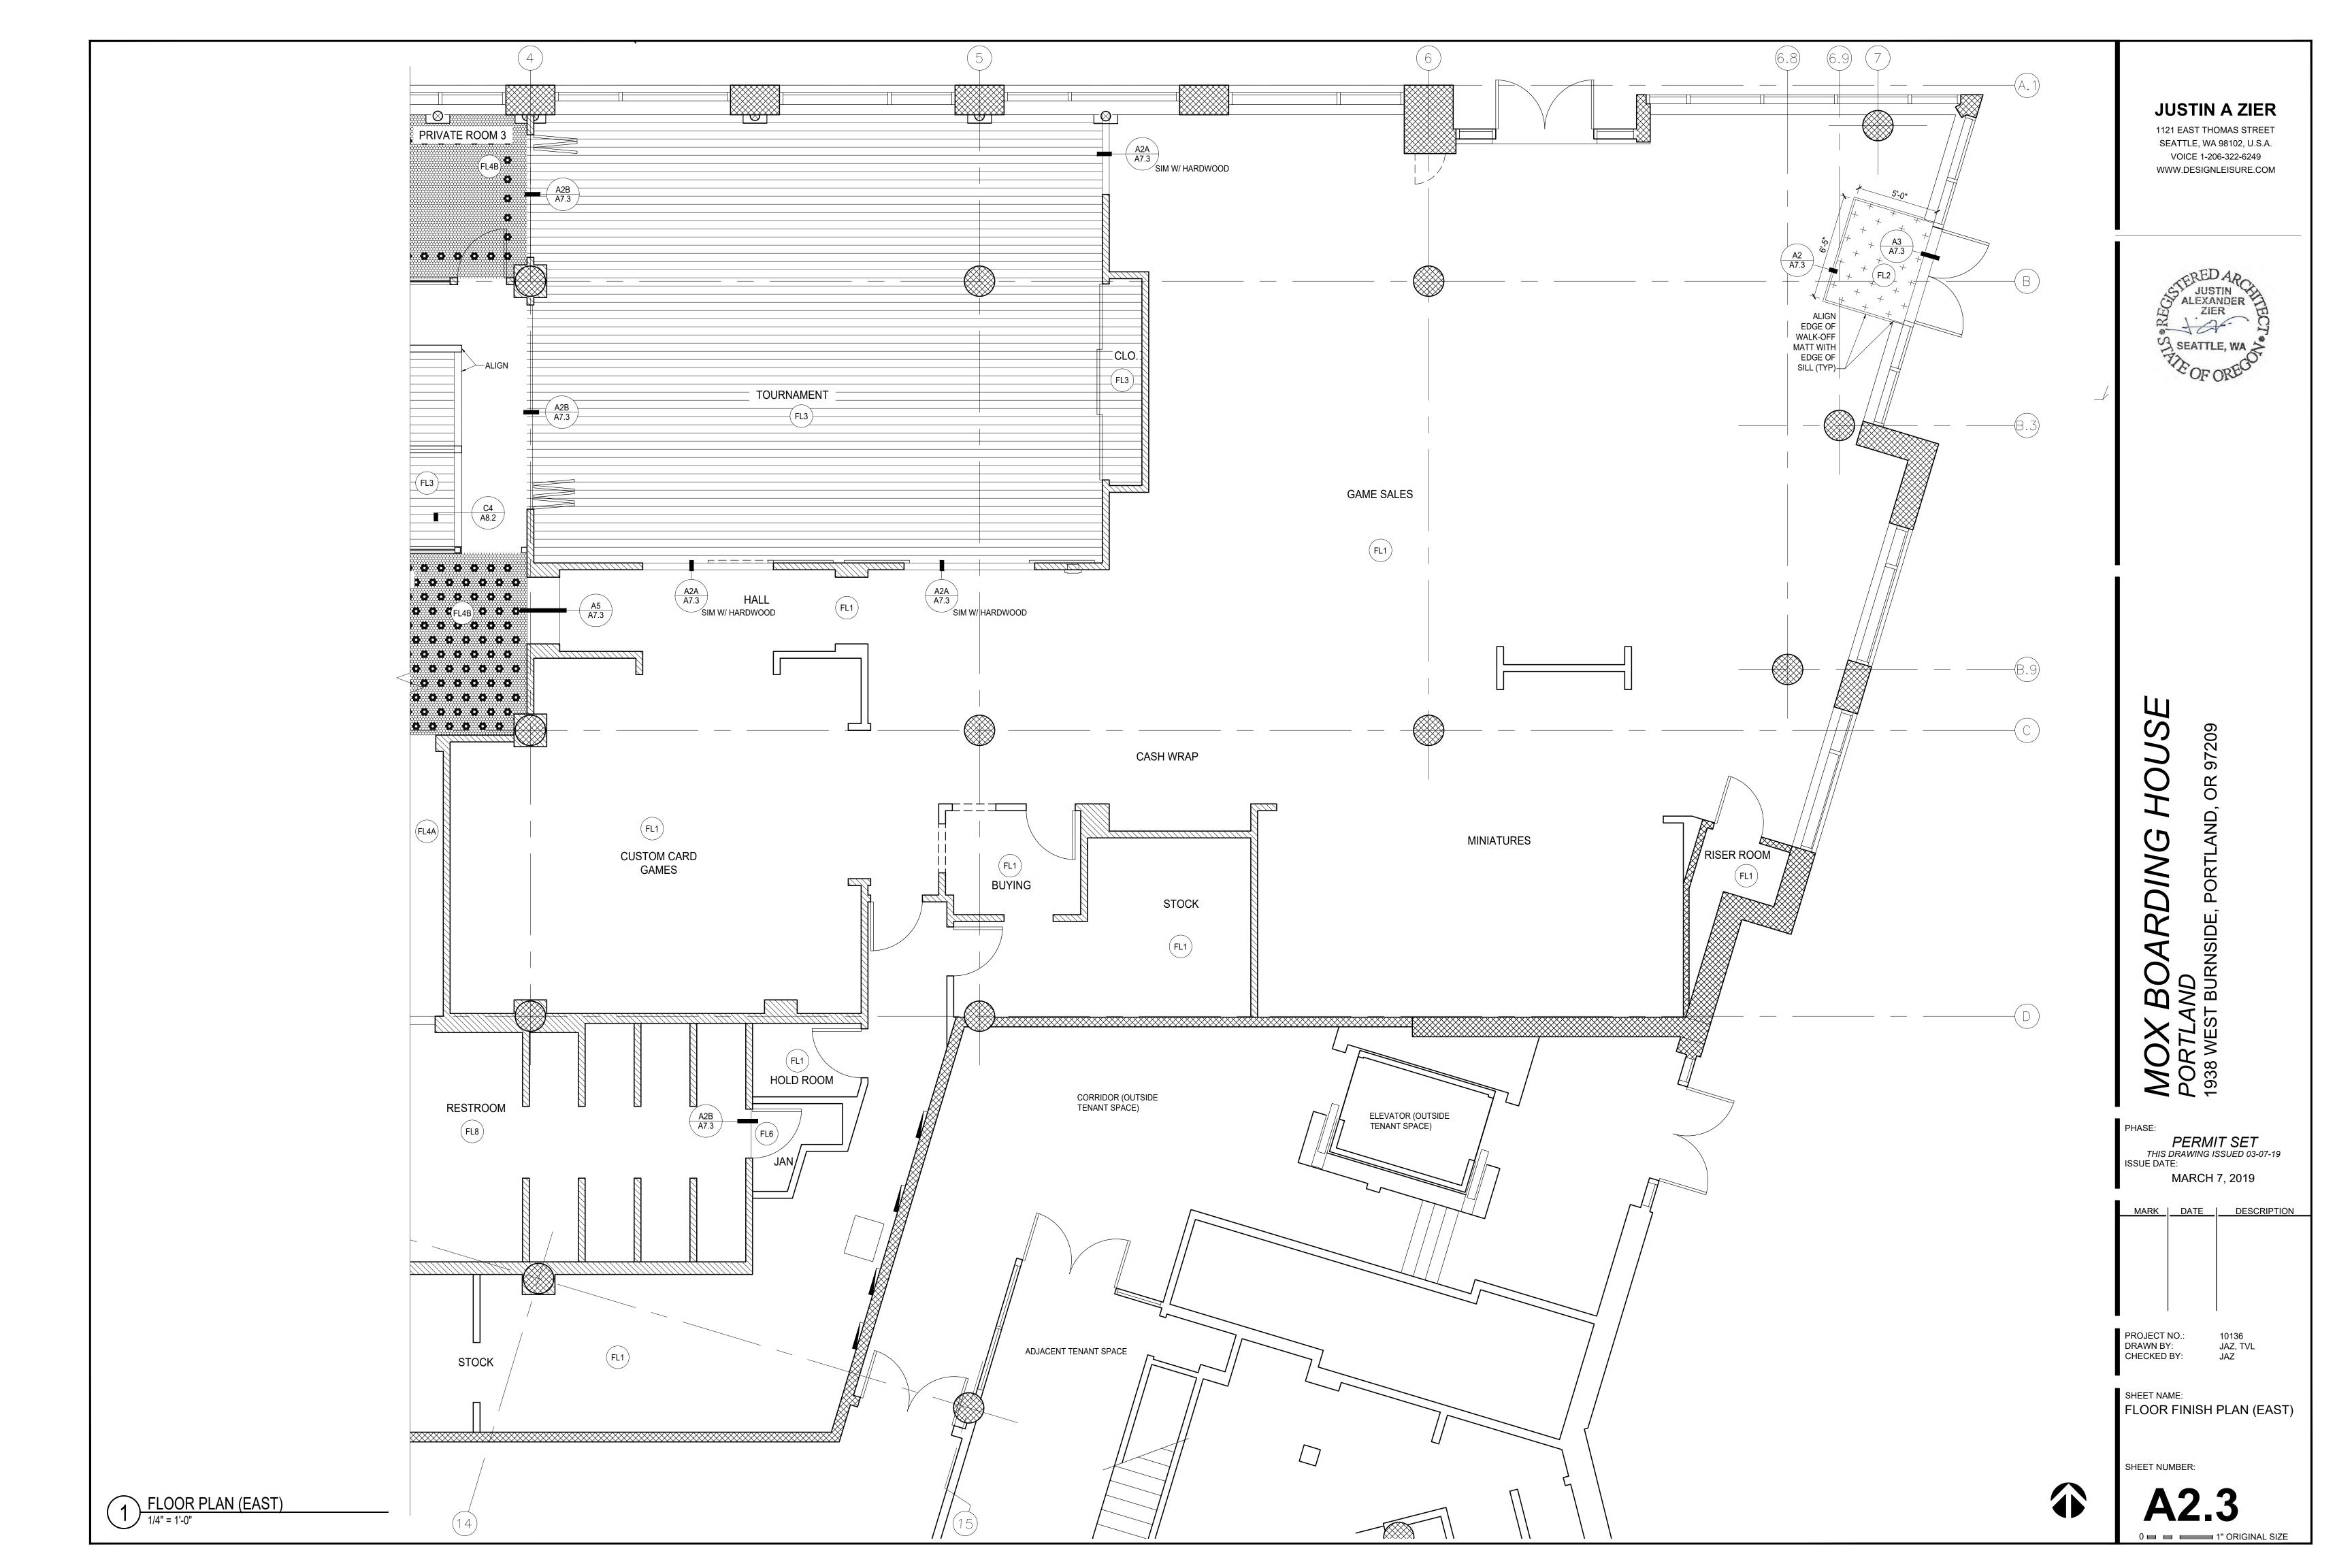1. SEE SHEET A6.1 FOR FIXTURE AND FURNITURE SCHEDULES. 2. MAINTAIN 44" CLEAR EGRESS PATH THROUGHOUT. 3. THE CONTRACTOR IS RESPONSIBLE FOR PROTECTION OF HIS WORK DURING STORAGE, TRANSIT, INSTALLATION AND UNTIL FINAL OWNER ACCEPTANCE. UPON COMPLETION, THE CONTRACTOR SHALL CLEAN ALL

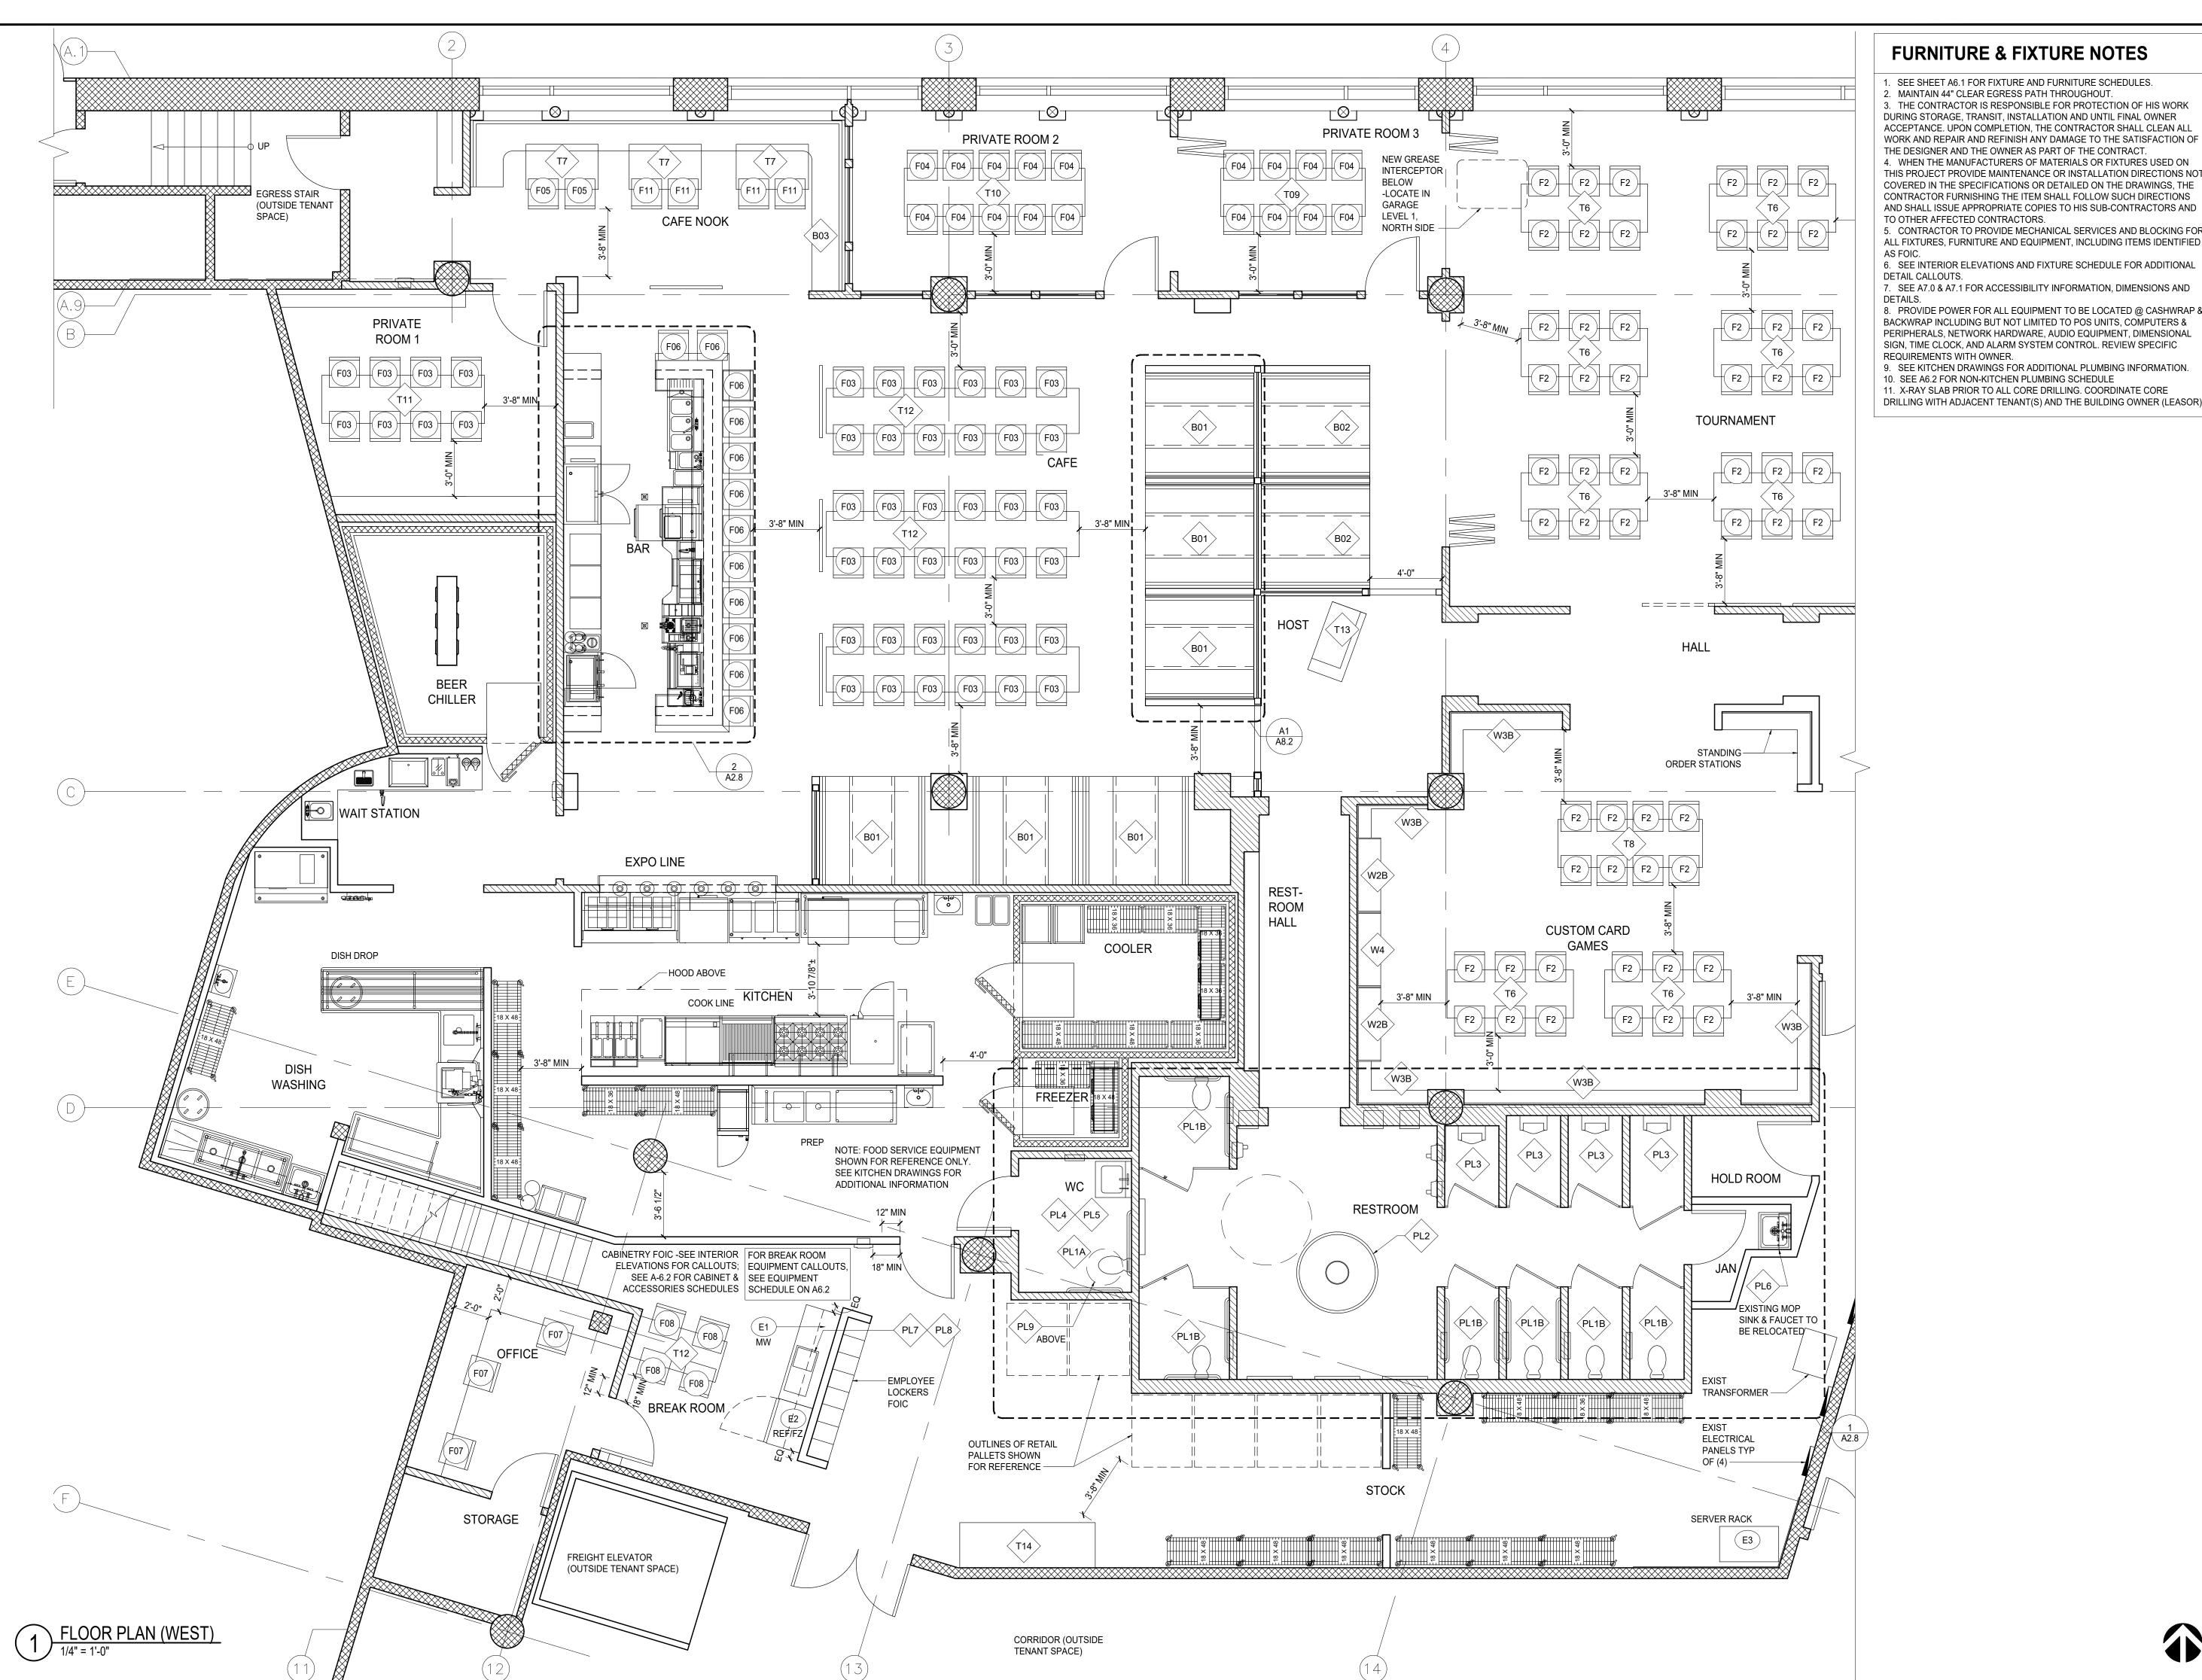THE DESIGNER AND THE OWNER AS PART OF THE CONTRACT. 4. WHEN THE MANUFACTURERS OF MATERIALS OR FIXTURES USED ON THIS PROJECT PROVIDE MAINTENANCE OR INSTALLATION DIRECTIONS NOT COVERED IN THE SPECIFICATIONS OR DETAILED ON THE DRAWINGS, THE CONTRACTOR FURNISHING THE ITEM SHALL FOLLOW SUCH DIRECTIONS AND SHALL ISSUE APPROPRIATE COPIES TO HIS SUB-CONTRACTORS AND

TO OTHER AFFECTED CONTRACTORS. 5. CONTRACTOR TO PROVIDE MECHANICAL SERVICES AND BLOCKING FOR ALL FIXTURES, FURNITURE AND EQUIPMENT, INCLUDING ITEMS IDENTIFIED

6. SEE INTERIOR ELEVATIONS AND FIXTURE SCHEDULE FOR ADDITIONAL

7. SEE A7.0 & A7.1 FOR ACCESSIBILITY INFORMATION, DIMENSIONS AND

8. PROVIDE POWER FOR ALL EQUIPMENT TO BE LOCATED @ CASHWRAP & BACKWRAP INCLUDING BUT NOT LIMITED TO POS UNITS, COMPUTERS & PERIPHERALS, NETWORK HARDWARE, AUDIO EQUIPMENT, DIMENSIONAL

REQUIREMENTS WITH OWNER. 9. SEE KITCHEN DRAWINGS FOR ADDITIONAL PLUMBING INFORMATION.

10. SEE A6.2 FOR NON-KITCHEN PLUMBING SCHEDULE

11. X-RAY SLAB PRIOR TO ALL CORE DRILLING, COORDINATE CORE DRILLING WITH ADJACENT TENANT(S) AND THE BUILDING OWNER (LEASOR). **JUSTIN A ZIER**

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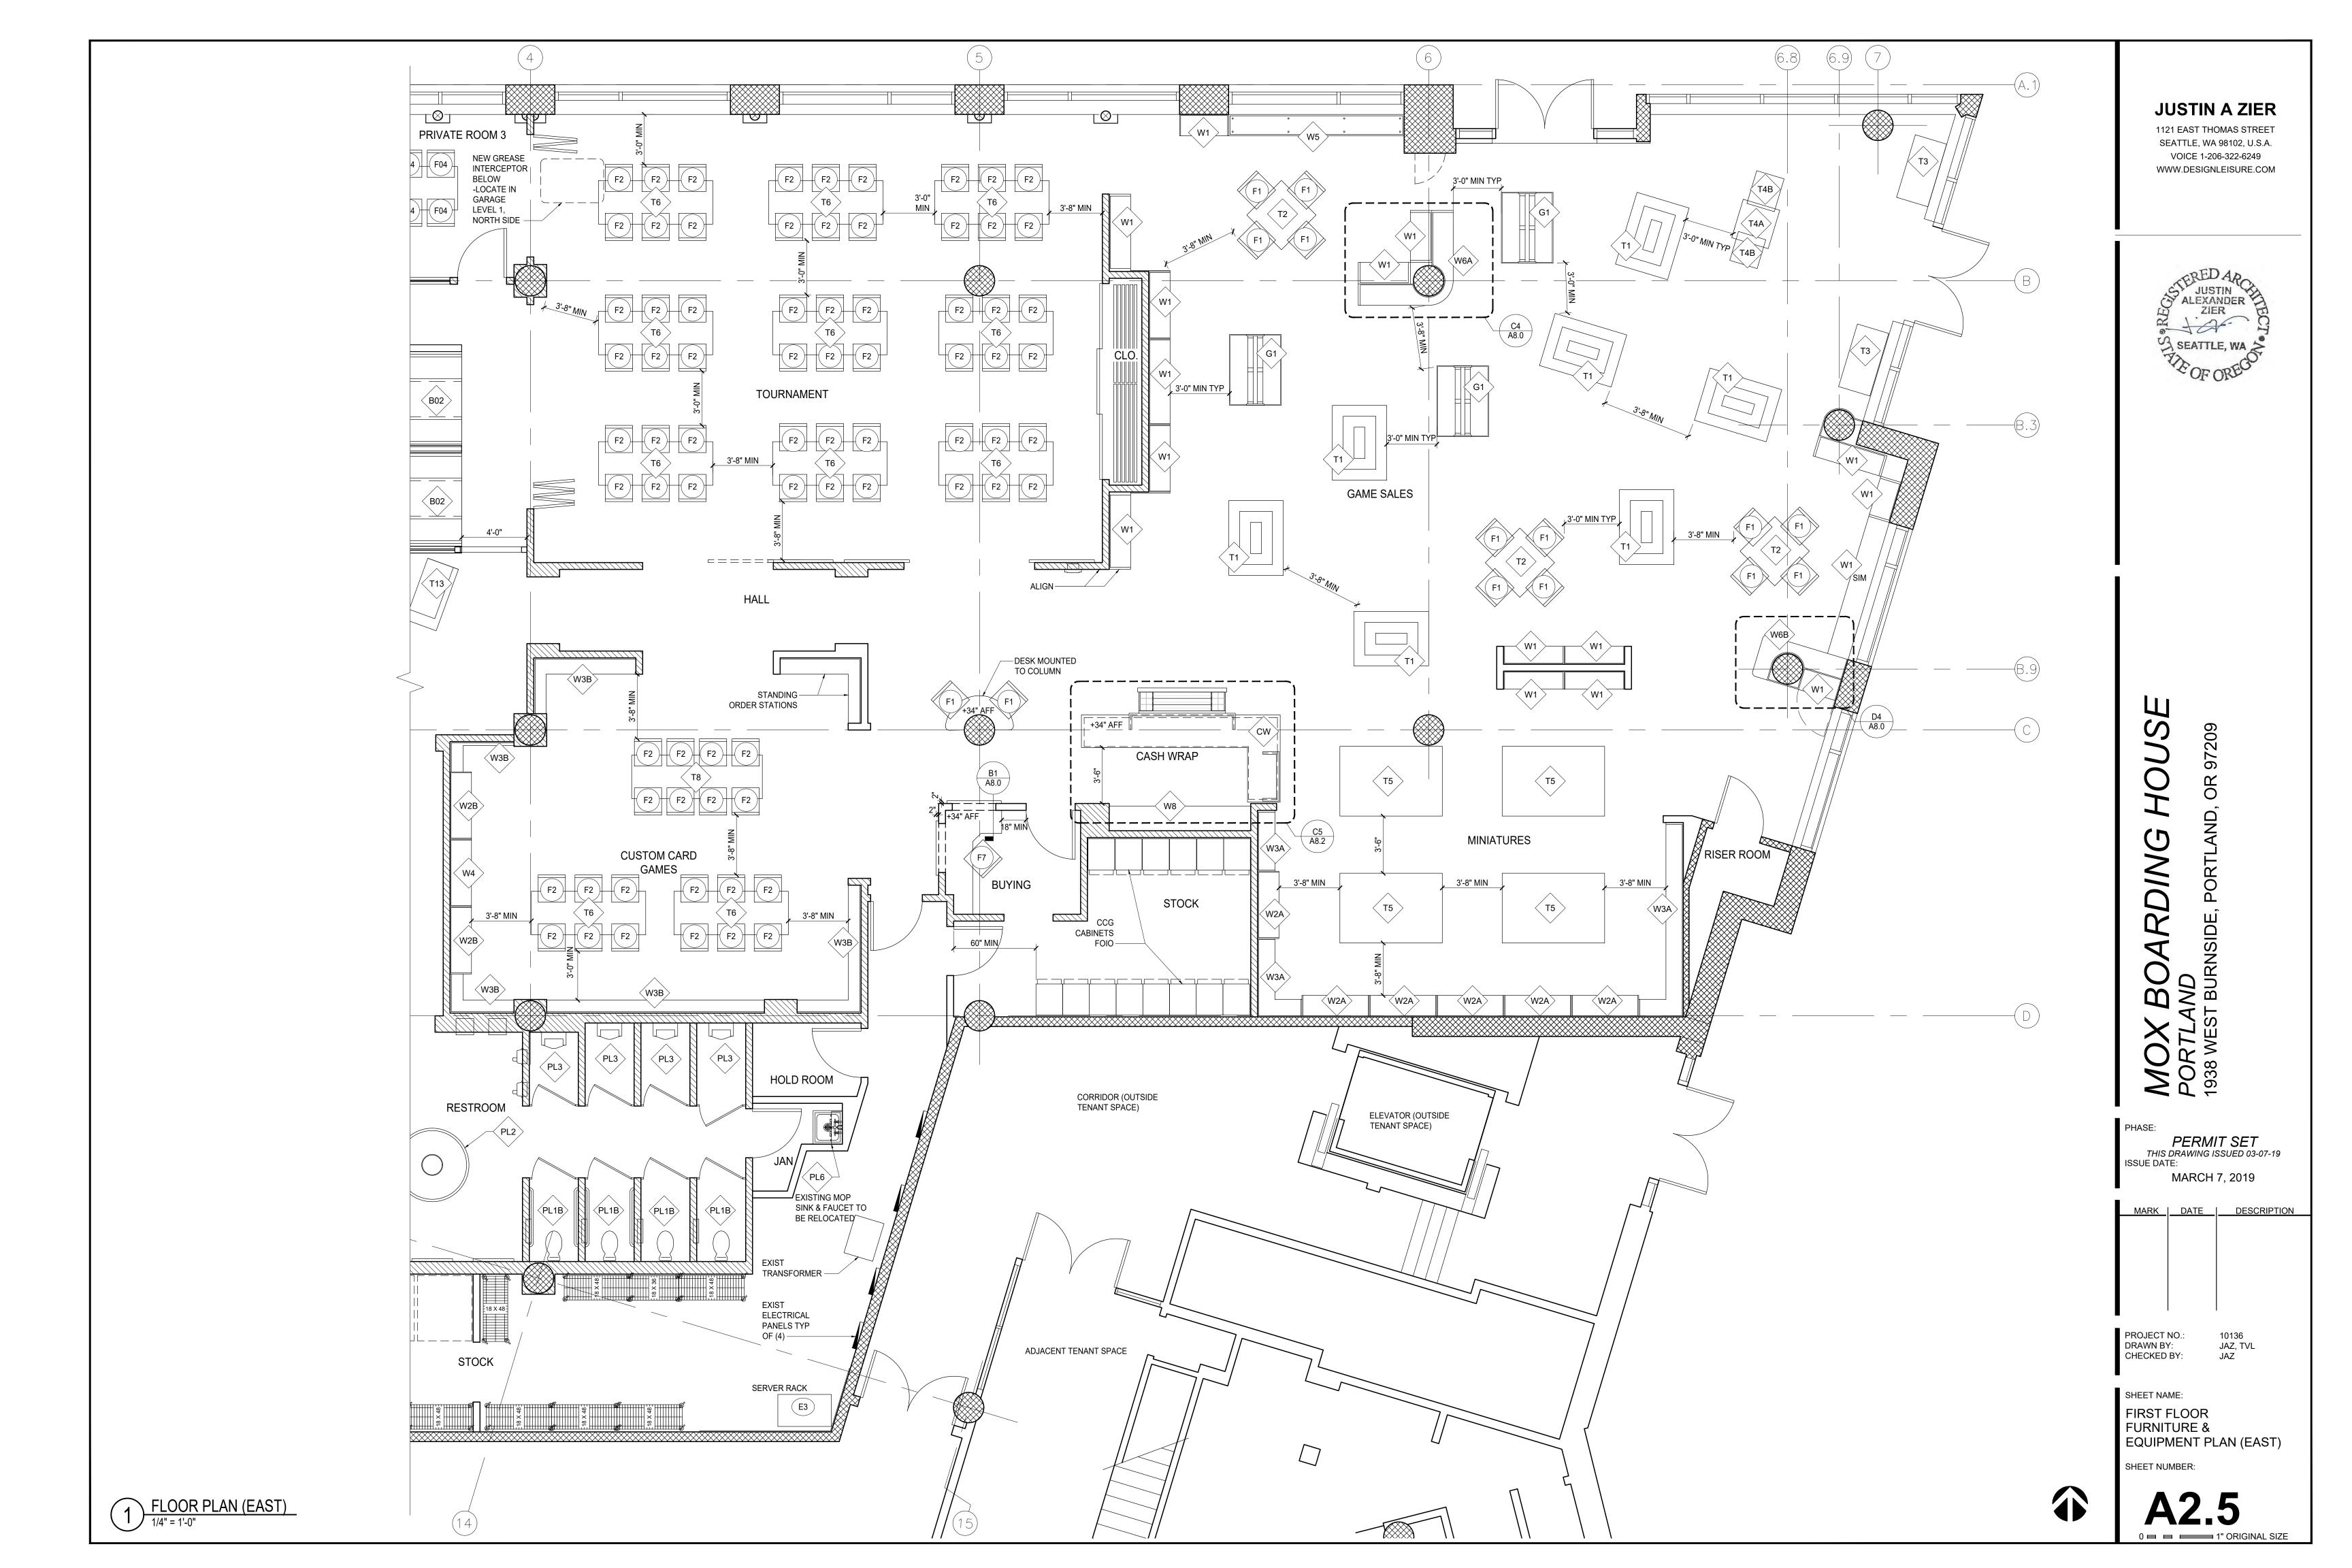
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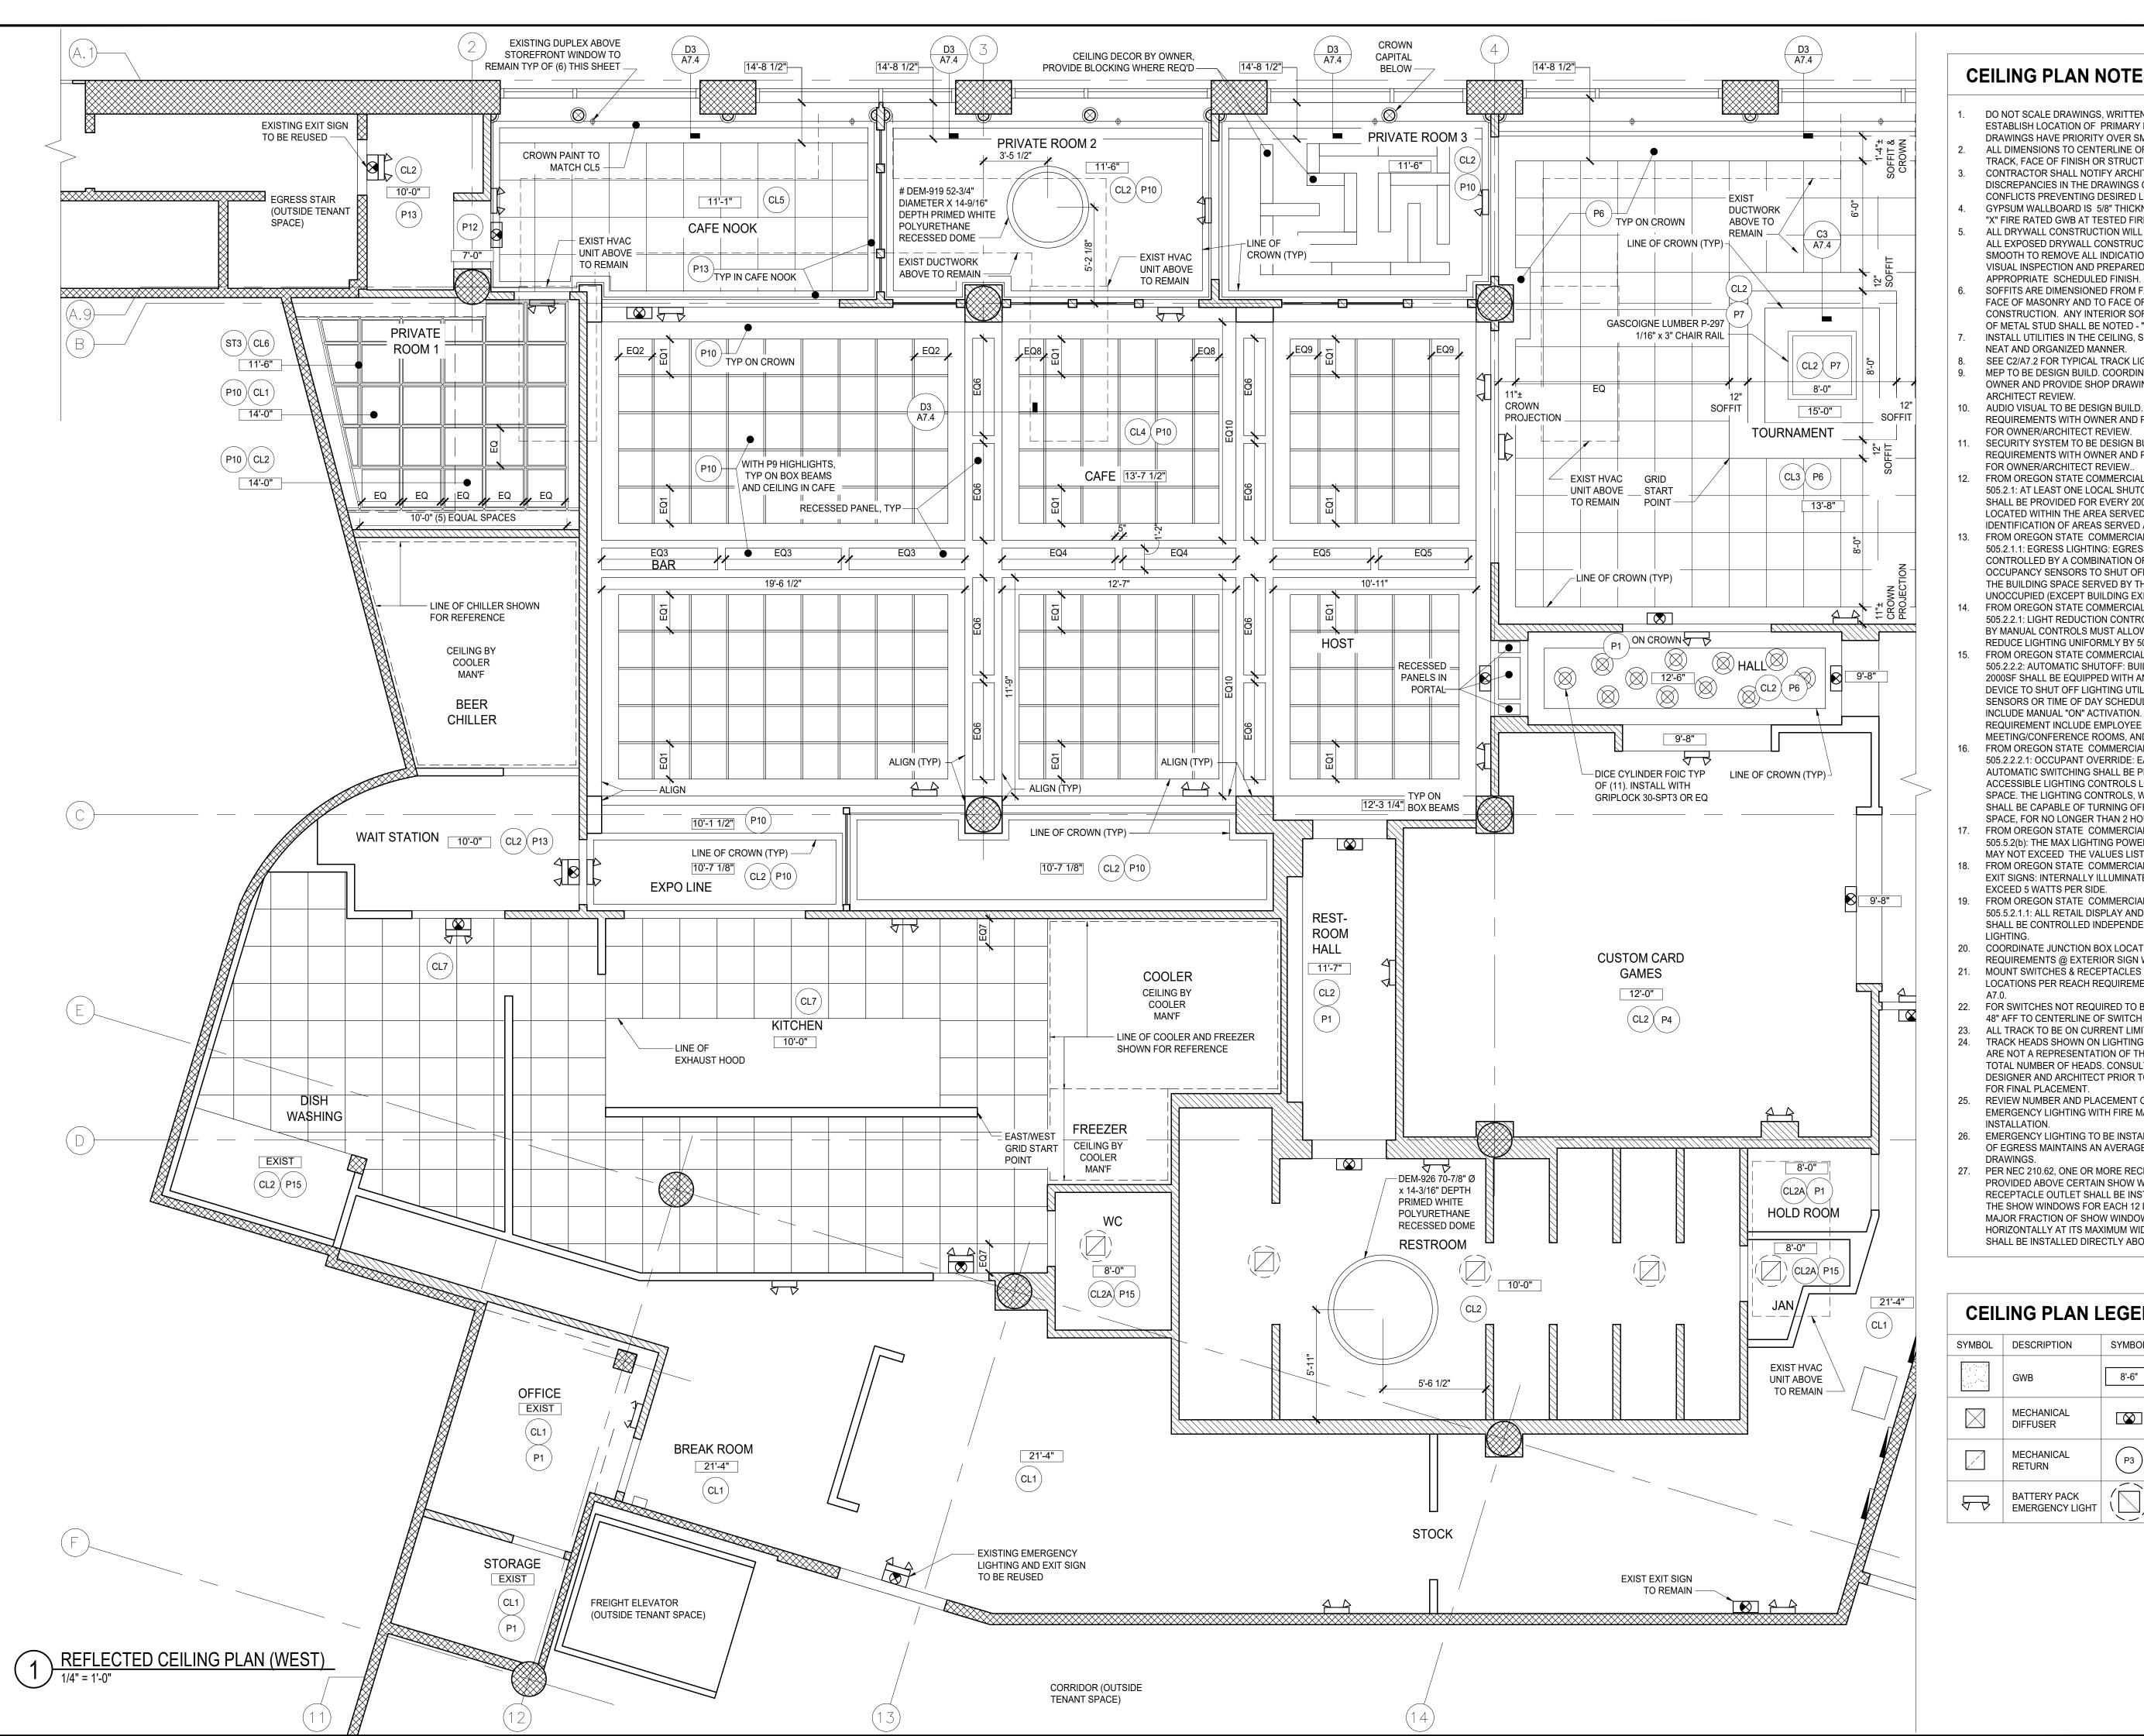
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SHEET NAME: FIRST FLOOR FURNITURE &

EQUIPMENT PLAN (WEST) SHEET NUMBER:





CEILING PLAN NOTES

- DO NOT SCALE DRAWINGS, WRITTEN DIMENSIONS SHALL ESTABLISH LOCATION OF PRIMARY ELEMENTS. LARGER SCALE DRAWINGS HAVE PRIORITY OVER SMALLER SCALE DRAWINGS. ALL DIMENSIONS TO CENTERLINE OF LIGHT FIXTURE OR
- TRACK, FACE OF FINISH OR STRUCTURAL ELEMENT UON. CONTRACTOR SHALL NOTIFY ARCHITECT OF ANY DISCREPANCIES IN THE DRAWINGS OR UNFORSEEN CONFLICTS PREVENTING DESIRED LIGHT MOUNTING HEIGHTS.
- GYPSUM WALLBOARD IS 5/8" THICKNESS UON; PROVIDE TYPE "X" FIRE RATED GWB AT TESTED FIRE ASSEMBLIES. ALL DRYWALL CONSTRUCTION WILL BE TAPED AND FLOATED; ALL EXPOSED DRYWALL CONSTRUCTION WILL BE SANDED SMOOTH TO REMOVE ALL INDICATIONS OF THE JOINT WITH A VISUAL INSPECTION AND PREPARED TO RECIEVE THE
- SOFFITS ARE DIMENSIONED FROM FACE OF GYPSUM BOARD, FACE OF MASONRY AND TO FACE OF EXISTING CONSTRUCTION. ANY INTERIOR SOFFIT DIMENSIONED TO FACE OF METAL STUD SHALL BE NOTED - "FOS" (FACE OF STUD) INSTALL UTILITIES IN THE CEILING, SUCH AS CONDUIT, IN A
- NEAT AND ORGANIZED MANNER. SEE C2/A7.2 FOR TYPICAL TRACK LIGHT MOUNTING DETAILS. MEP TO BE DESIGN BUILD. COORDINATE REQUIREMENTS WITH
- OWNER AND PROVIDE SHOP DRAWINGS FOR OWNER/ ARCHITECT REVIEW. 10. AUDIO VISUAL TO BE DESIGN BUILD. COORDINATE REQUIREMENTS WITH OWNER AND PROVIDE SHOP DRAWINGS
- FOR OWNER/ARCHITECT REVIEW. SECURITY SYSTEM TO BE DESIGN BUILD. COORDINATE REQUIREMENTS WITH OWNER AND PROVIDE SHOP DRAWINGS
- FOR OWNER/ARCHITECT REVIEW.. 12. FROM OREGON STATE COMMERCIAL ENERGY CODE SEC 505.2.1: AT LEAST ONE LOCAL SHUTOFF LIGHTING CONTROL SHALL BE PROVIDED FOR EVERY 2000SF OF LIT FLOOR AREA, LOCATED WITHIN THE AREA SERVED OR REMOTELY WITH
- IDENTIFICATION OF AREAS SERVED AND STATUS: FROM OREGON STATE COMMERCIAL ENERGY CODE SEC. 505.2.1.1: EGRESS LIGHTING: EGRESS ILLUMINATION SHALL BE CONTROLLED BY A COMBINATION OF EMERGENCY RELAY AND OCCUPANCY SENSORS TO SHUT OFF DURING PERIODS THAT THE BUILDING SPACE SERVED BY THE MEANS OF EGRESS IS UNOCCUPIED (EXCEPT BUILDING EXITS).
- FROM OREGON STATE COMMERCIAL ENERGY CODE SEC. 505.2.2.1: LIGHT REDUCTION CONTROLS: EACH AREA SERVED BY MANUAL CONTROLS MUST ALLOW THE OCCUPANT TO REDUCE LIGHTING UNIFORMLY BY 50%.
- FROM OREGON STATE COMMERCIAL ENERGY CODE SEC. 505.2.2.2: AUTOMATIC SHUTOFF: BUILDINGS LARGER THAN 2000SF SHALL BE EQUIPPED WITH AN AUTOMATIC CONTROL DEVICE TO SHUT OFF LIGHTING UTILIZING OCCUPANCY SENSORS OR TIME OF DAY SCHEDULING. DAYLIT ZONES MUST INCLUDE MANUAL "ON" ACTIVATION. EXCEPTIONS TO THIS REQUIREMENT INCLUDE EMPLOYEE AREAS, MEETING/CONFERENCE ROOMS, AND RESTROOMS.
- FROM OREGON STATE COMMERCIAL ENERGY CODE SEC. 505.2.2.2.1: OCCUPANT OVERRIDE: EACH SPACE CONTOLLED BY AUTOMATIC SWITCHING SHALL BE PROVIDED WITH ACCESSIBLE LIGHTING CONTROLS LOCATED WITHIN THAT SPACE. THE LIGHTING CONTROLS, WHETHER ONE OR MORE, SHALL BE CAPABLE OF TURNING OFF ALL LIGHTS WITHIN THE SPACE, FOR NO LONGER THAN 2 HOURS.
- FROM OREGON STATE COMMERCIAL ENERGY CODE TABLE 505.5.2(b): THE MAX LIGHTING POWER THAT MAY BE PROVIDED MAY NOT EXCEED THE VALUES LISTED. FROM OREGON STATE COMMERCIAL ENERGY CODE SEC 505.4:
- EXIT SIGNS: INTERNALLY ILLUMINATED EXIT SIGNS SHALL NOT EXCEED 5 WATTS PER SIDE. 19. FROM OREGON STATE COMMERCIAL ENERGY CODE SEC 505.5.2.1.1: ALL RETAIL DISPLAY AND SPECIALTY LIGHTING
- SHALL BE CONTROLLED INDEPENDENTLY OF GENERAL AREA LIGHTING. 20. COORDINATE JUNCTION BOX LOCATION & POWER REQUIREMENTS @ EXTERIOR SIGN WITH SIGN CONTRACTOR.
- 21. MOUNT SWITCHES & RECEPTACLES AT ACCESSIBLE LOCATIONS PER REACH REQUIREMENTS AS SHOWN ON SHEET
- 22. FOR SWITCHES NOT REQUIRED TO BE ACCESSIBLE, MOUNT @ 48" AFF TO CENTERLINE OF SWITCH U.O.N. 23. ALL TRACK TO BE ON CURRENT LIMITERS.
- 24. TRACK HEADS SHOWN ON LIGHTING DESIGNER'S DRAWINGS ARE NOT A REPRESENTATION OF THE FINAL LOCATION OR TOTAL NUMBER OF HEADS. CONSULT WITH LIGHTING DESIGNER AND ARCHITECT PRIOR TO INSTALLATION OF HEADS FOR FINAL PLACEMENT.
- 25. REVIEW NUMBER AND PLACEMENT OF EXIT SIGNS AND EMERGENCY LIGHTING WITH FIRE MARSHALL PRIOR TO INSTALLATION.
- 26. EMERGENCY LIGHTING TO BE INSTALLED SO THAT THE PATH OF EGRESS MAINTAINS AN AVERAGE OF 1 FC. SEE LIGHTING DRAWINGS.
- 27. PER NEC 210.62, ONE OR MORE RECEPTACLES SHALL BE PROVIDED ABOVE CERTAIN SHOW WINDOWS. AT LEAST ONE RECEPTACLE OUTLET SHALL BE INSTALLED DIRECTLY ABOVE THE SHOW WINDOWS FOR EACH 12 LINEAR FEET, OR THE MAJOR FRACTION OF SHOW WINDOW (AREA MEASURED HORIZONTALLY AT ITS MAXIMUM WIDTH). THE RECEPTACLE SHALL BE INSTALLED DIRECTLY ABOVE THE SHOW WINDOW

CEILING PLAN LEGEND

SYMBOL	DESCRIPTION	SYMBOL	DESCRIPTION
	GWB	8'-6"	CLG HEIGHT TAG
	MECHANICAL DIFFUSER		EXIT SIGN
	MECHANICAL RETURN	P3	FINISH TAG
₹	BATTERY PACK EMERGENCY LIGHT		EXHAUST FAN

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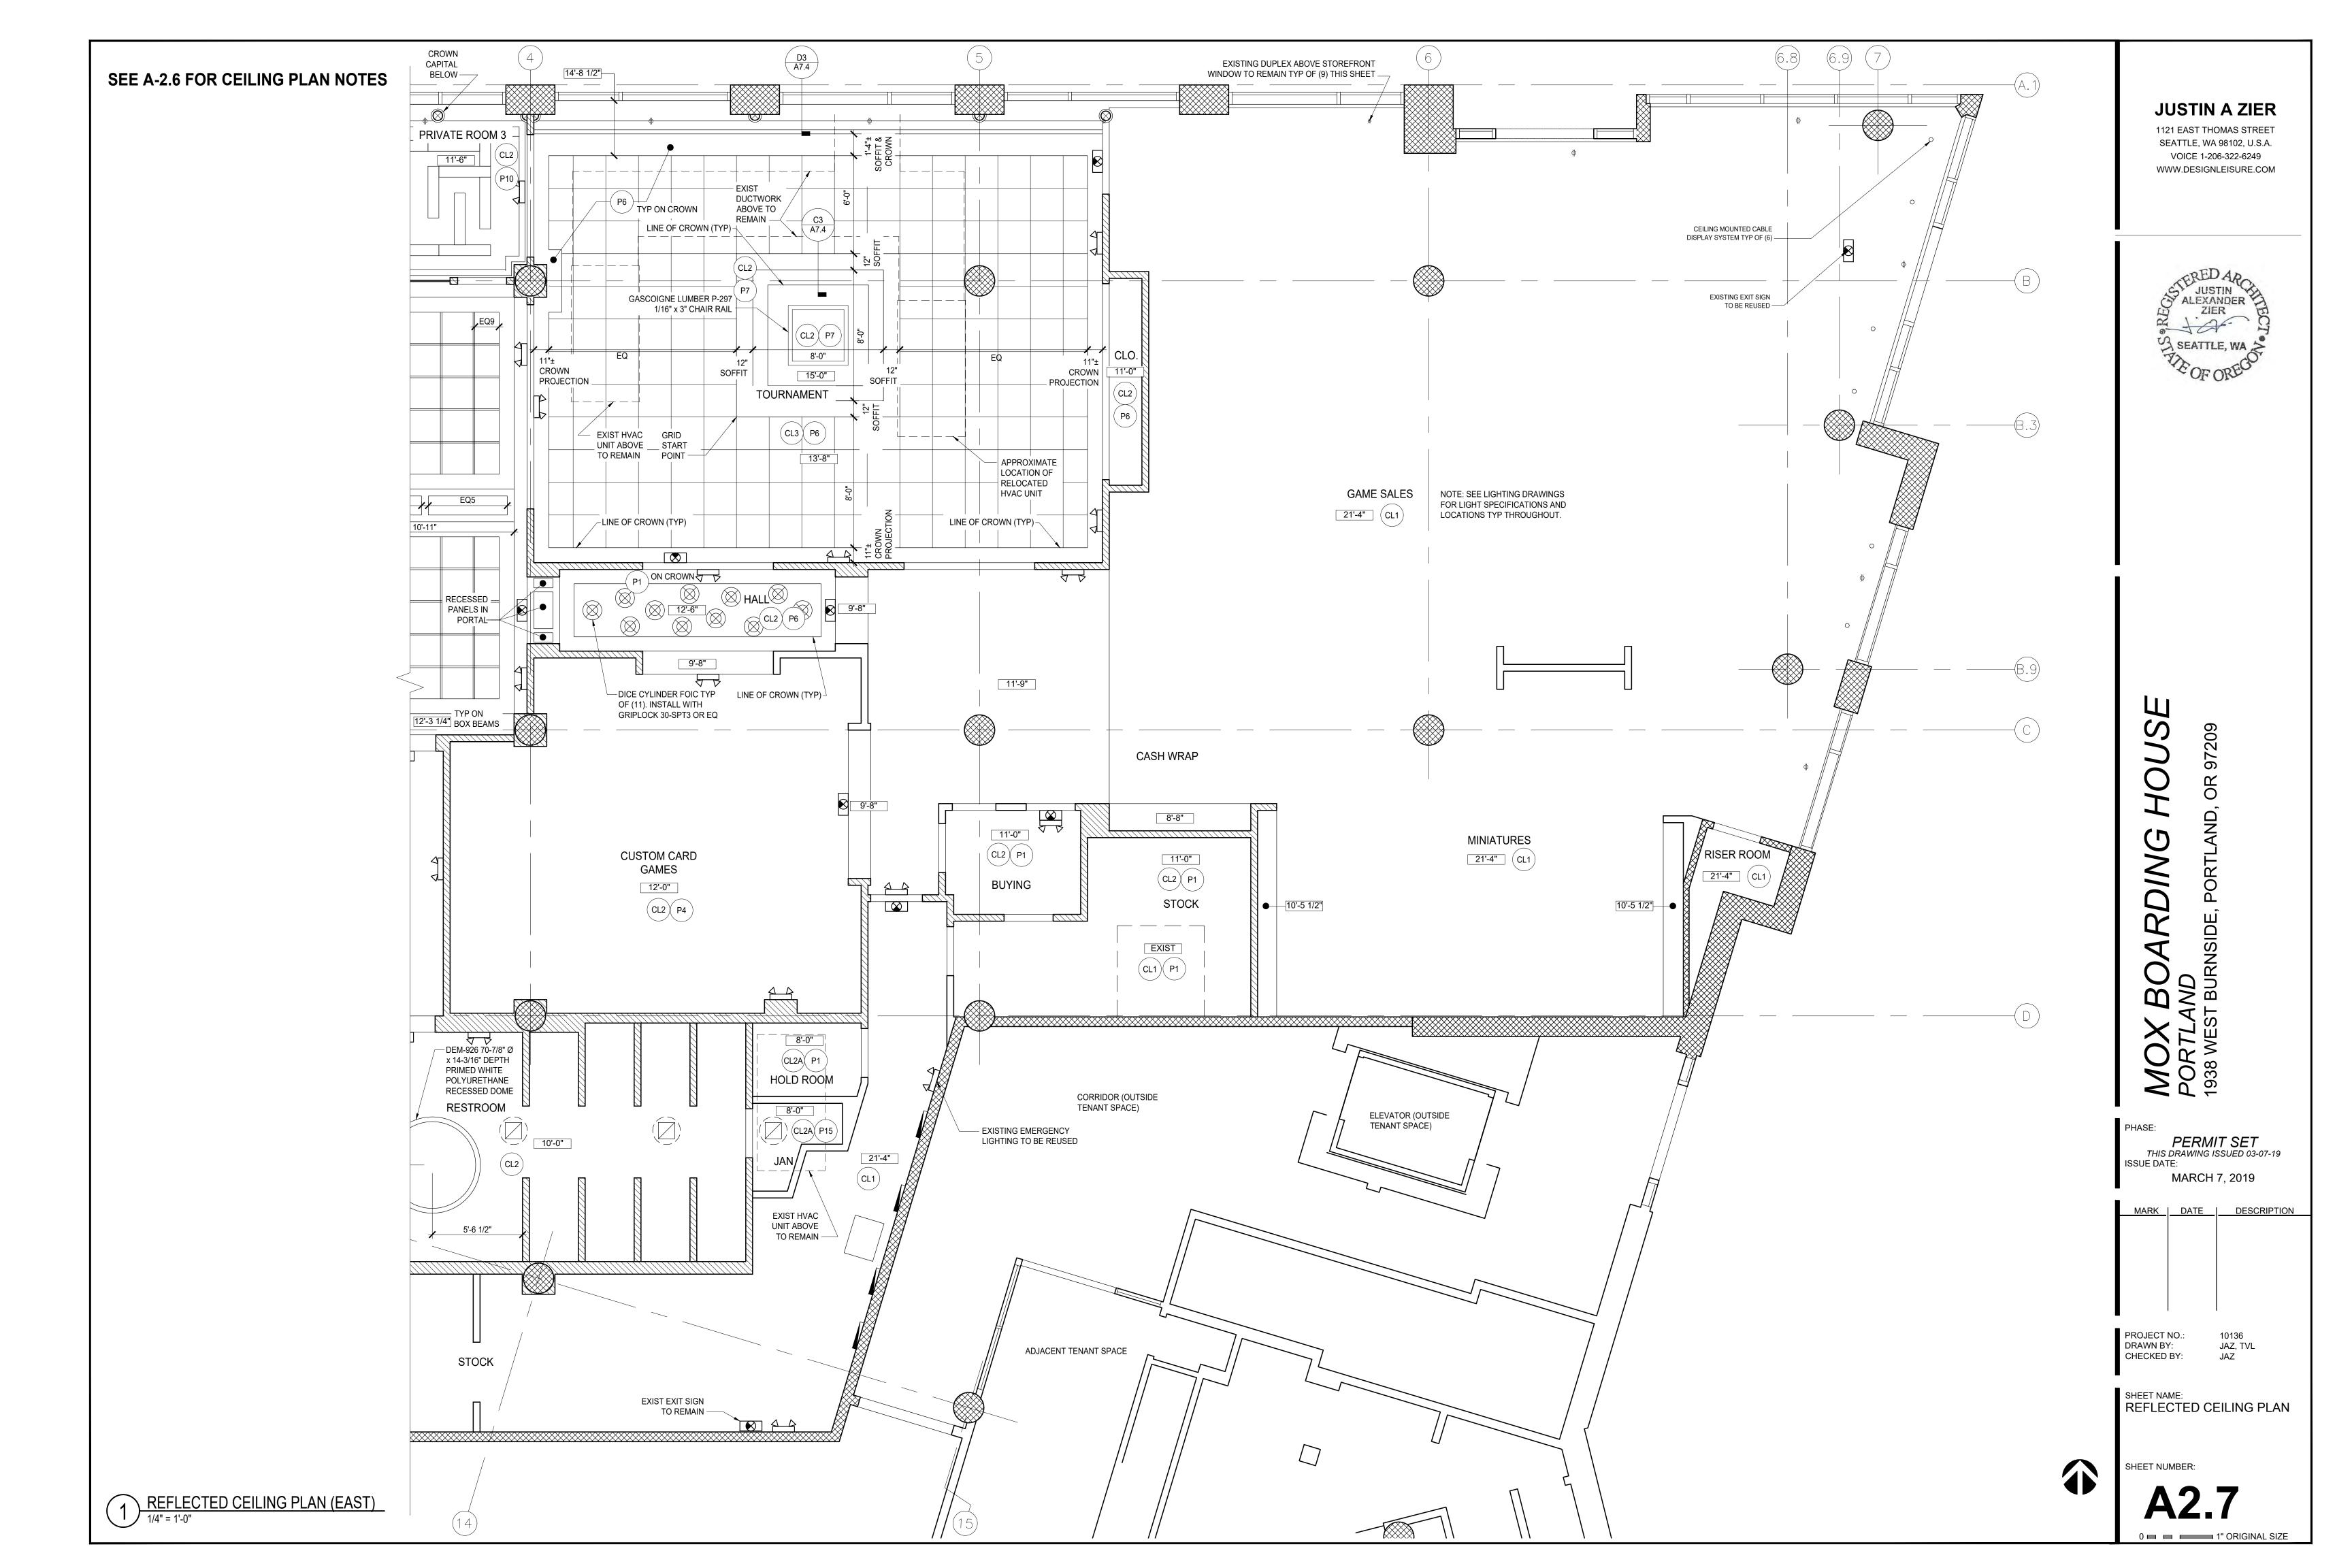
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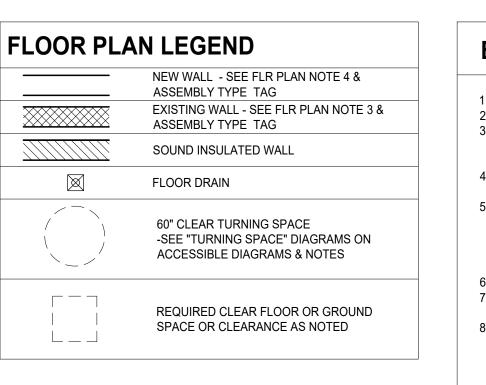
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PROJECT NO.: DRAWN BY: JAZ, TVL CHECKED BY: JAZ

SHEET NAME: REFLECTED CEILING PLAN







BAR NOTES

- SLOPE FLOORING TO DRAINS
- MOP SINK LOCATED IN JANITOR'S CLOSET. SEE 1/A2.8 THE SIZE OF THE DISHWASHER AND/OR COMPARTMENTS OF THE THREE COMPARTMENT SINKS MUST BE LARGE ENOUGH TO ACCOMMODATE THE
- LARGEST UTENSILS/EQUIPMENT USED IN THE ESTABLISHMENT ALL HANDSINKS TO BE ACCESSIBLE, EQUIPPED WITH MIXING FAUCETS,
- HANDSOAP AND PAPER TOWELS KITCHEN HAND-WASH SINKS SHALL BE EQUIPPED TO PROVIDE WATER AT A TEMPERATURE OF AT LEAST 100 DEGREES TO A MAX OF 120 DEGREES FAHRENHEIT THROUGH A MIXING VALVE OR COMBINATION FAUCET; SELF CLOSING OR METERING FAUCETS SHALL PROVIDE A FLOW OF WATER FOR AT LEAST 15 SECONDS
- PREP SINK, ICE MACHINE & ICE BIN DRAIN TO HAVE INDIRECT WASTE DRAIN LINE THREE COMPARTMENT SINK AND ALL SANITARY DRAINAGE TO BE CONNECTED
- DIRECTLY TO A PUBLIC SEWER PROVIDE GREASE INTERCEPTOR OR OTHER GREASE CAPTURING DEVICE SIZED AND INSTALLED PER TITLE 25 OF PORTLAND'S PLUMBING CODE, SPECIFICALLY CHAPTER 10 OF THE 2017 OPSC BASED ON 2015 UPC AND PER MANF'S INSTALL INSTRUCTIONS. TOTAL GALLON CAPACITY OF FIXTURES DISCHARGING TO A HYDROMECHANICAL GREASE INTERCEPTOR TO COMPLY WITH SECTION 1014.2.2 OF UPC. MANF. INSTALLATION INSTRUCTIONS TO BE AVAILABLE ON-SITE AT TIME
- ALL WALLS, FLOORS AND CEILINGS TO BE SMOOTH AND EASILY CLEANABLE. SEE FLOOR FINISH PLAN AND INTERIOR ELEVATIONS FOR ADDITIONAL INFORMATION 10. ALL FLOOR WALL JUNCTIONS TO HAVE INTEGRAL COVED BASE
- 11. ALL WOOD SURFACES, SUCH AS THE BAR, TO BE EPOXY SEALED
- 12. EXPOSED PLUMBING AND WIRING NOT ALLOWED. NO UNNECESSARILY EXPOSED UTILITIES ABOVE BAR OR PREP ROOM
- 13. SEE A2.6 & A2.7 REFLECTED CEILING PLAN FOR LOCATION OF EXHAUST VENTS. MECHANICAL SYSTEMS TO BE DESIGN/BUILD UNDER SEPARATE PERMIT 14. ALL LIGHT FIXTURES IN BAR AND PREP AREA TO HAVE SHATTER-PROOF
- SHIELDING. SEE A2.6 & A2.7 REFLECTED CEILING PLAN, AND LIGHTING SCHEDULE FOR ADDITIONAL INFORMATION 15. DRAINBOARDS, UTENSIL RACKS, OR TABLES LARGE ENOUGH TO ACCOMMODATE ALL SOILED AND CLEANSED ITEMS SHALL BE PROVIDED FOR NECESSARY
- UTENSIL HOLDING, BEFORE CLEANING AND AFTER SANITIZING 16. FOOD, FOOD PREPARATION AND FOOD & SERVICE EQUIPMENT STORAGE AREAS ARE PROHIBITED UNDER SEWER LINES THAT ARE NOT SHIELDED TO INTERCEPT
- POTENTIAL DRIPS; OTHER UTILITIES MAY NOT BE UNNECESSARILY EXPOSED 17. HOT WATER GENERATION AND DISTRIBUTION SYSTEMS SHALL BE SUFFICIENT TO MEET THE PEAK HOT WATER DEMANDS THROUGHOUT THE FOOD ESTABLISHMENT
- 18. FOOD SERVICE OPERATION AREA FLOORS, FLOOR COVERINGS, WALLS, WALL COVERINGS, AND CEILING SHALL BE DESIGNED, CONSTRUCTED AND INSTALLED SO THEY ARE SMOOTH, DURABLE AND EASILY CLEANABLE.
- 19. PROVIDE BACKFLOW ASSEMBLY DEVICES ON CARBONATOR, DISHWASHER, STEAMER, AND ANY OTHER FIXTURE/DEVICE THAT MAY REQUIRE CROSS CONNECTION CONTROL ON POTABLE WATER SUPPLY. ALL BACKFLOW DEVICES SHALL BE PERMITTED AND TESTED PRIOR TO FINAL PLUMBING INSPECTION
- 20. WHERE CARBONATED BEVERAGE DISPENSERS ARE INSTALLED, THE CONNECTION TO THE POTABLE WATER SYSTEM SHALL BE PROTECTED BY MEANS OF A REDUCED PRESSURE BACKFLOW ASSEMBLY (RPBA). THE BEVERAGE DISPENSER SHALL BE INSTALLED AT THE TIME OF FINAL PLUMBING INSPECTION. IF SUCH DISPENSERS ARE TO BE INSTALLED AT A FUTURE TIME, THEY SHALL REQUIRE A PLUMBING PERMIT AND INSPECTION PRIOR TO OPERATION.
- 21. FLOOR SINKS SHALL BE PROVIDED FOR PLUMBING FIXTURES AND APPLIANCES
- WHICH REQUIRE INDIRECT WASTE. 22. ALL FLOOR DRAINS REQUIRED TO BE TRAP PRIMED

<u>ENLARGED RESTROOM PLAN</u>

23. SEE KITCHEN DRAWINGS FOR ADDITIONAL INFORMATION 24. PROVIDE POWER TO ALL EQUIPMENT PER EQUIPMENT MANF. SPECIFICATIONS

FLOOR PLAN NOTES

- SEE SHEET A6.1 FOR DOOR SCHEDULES / TYPES.
- SEE SHEET A6.0 FOR ASSEMBLY TYPES. SEE A2.0 & 2.1 FOR PARTITION TYPE CALL OUTS.
- TYPICAL DOOR RETURN IS 6" UNLESS OTHERWISE NOTED. DIMENSIONS ARE TO FACE OF FINISH, & CENTERLINE OF DOOR OR
- WINDOW OPENING UNLESS OTHERWISE NOTED. DIMENSIONS NOTED AS 'CLEAR' ARE MEASURED TO FACE OF FINISHED SURFACE.
- SEE STRUCT FOR DEFLECTION HEAD & BOTTOM TRACK DETAILS. INTEGRITY OF EXISTING FIRE-RATED ASSEMBLIES ARE TO BE SAFEGUARDED
- FROM ALTERATION AND/OR DAMAGE. ARCHITECT MUST BE NOTIFIED OF ANY MODIFICATION OR DAMAGE TO EXISTING FIRE-RATED ASSEMBLIES. ALIGN AND FLOAT ALL FLOOR FINISH MATERIALS UNLESS NOTED OTHERWISE
- ON THE FLOOR FINISH PLANS. X-RAY SLAB PRIOR TO ALL CORE DRILLING. COORDINATE CORE DRILLING WITH ADJACENT TENANT(S).

TOILET ROOM NOTES

- FOR DETAILED ACCESSIBILITY REQUIREMENTS & INFORMATION, SEE NOTES AND DIAGRAMS ON SHEETS A7.0 & A7.1. FOR PLUMBING FIXTURE SPECIFICATIONS, SEE PLUMBING FIXTURE SCHEDULE ON A6.2.
- FOR WC AND GRAB BAR ACCESSIBILITY REQUIREMENTS, SEE SHEET A7.0
- 3. FOR URINAL ACCESSIBILITY REQUIREMENTS, SEE C2/A7.0
- 4. FOR LAVATORY ACCESSIBILITY REQUIREMENTS, SEE C1/A7.0 5. FOR ACCESSORIES ACCESSIBILITY, SEE D1/A7.0
- 6. FOR REQUIRED SIGNAGE ACCESSIBILITY, SEE D2/A7.0 7. FOR ACCESSIBLE TURNING SPACE REQUIREMENTS, SEE E1/A7.0
- 8. SEE A2.4 REFLECTED CEILING PLAN AND MEP DRAWINGS FOR LOCATION OF EXHAUST VENTS RESTROOM HAND WASH SINKS SHALL BE EQUIPPED TO PROVIDE WATER AT A
- TEMPERATURE OF AT LEAST 100 DEGREES TO A MAX OF 120 DEGREES FAHRENHEIT THROUGH A MIXING VALVE OR COMBINATION FAUCET THAT MEETS ASSE 1070 PRODUCT STANDARD. THE WATER HEATER THERMOSTAT SHALL NOT BE CONSIDERED A MEANS FOR CONTROLLING THIS TEMPERATURE. SELF CLOSING OR METERING FAUCETS SHALL PROVIDE A FLOW OF WATER FOR AT
- LEAST 15 SECONDS. 10. AS REQUIRED BY CODE, PROVIDE FLOOR DRAINS IN THE MEN'S AND WOMEN'S RESTROOMS. DRAINS TO BE TRAP PRIMED.
- 11. SEE SHEET A2.4 FOR PLUMBING FIXTURE CALL OUTS IN TOILET ROOMS 12. PROVIDE KOALA KARE HORIZONTAL STAINLESS STEEL RECESS MOUNTED MODEL# KB110-SSRE BABY CHANGE STATION PER MANF RECOMMENDATIONS
- FOR BARRIER-FREE OPERATION 13. PROVIDE RECESS MOUNTED AUTOMATIC SENSOR ACTIVATED HAND DRYER, MODEL # R76-IC BY EXCEL DRYER. INSTALL PER MANF RECOMMENDATIONS FOR
- BARRIER-FREE OPERATION 14. PROVIDE RECESS MOUNTED PAPER TOWEL DISPENSER, MODEL # B-359 BY BOBRICK INSTALL PER MANF RECOMMENDATIONS FOR BARRIER-FREE
- OPERATION 15. PROVIDE PARTITION MOUNTED TOILET TISSUE DISPENSER BY BOBRICK,
- MODEL # B-386 OR SIMILAR. INSTALL PER MANF RECOMMENDATIONS FOR BARRIER-FREE OPERATION AT ACCESSIBLE WC COMPARTMENTS 16. PROVIDE PARTITION MOUNTED TOILET TISSUE DISPENSER BY BOBRICK, MODEL # B-386 OR SIMILAR. PROVIDE PARTITION MOUNTED SANITARY NAPKIN
- COMPARTMENTS 17. PROVIDE RECESSED TRASH BIN AND PAPER TOWEL DISPENSER BY BOBRICK, MODEL B-3808 OR SIMILAR. INSTALL PER MANF RECOMMENDATIONS FOR

DISPOSAL UNIT BY BOBRICK, MODEL B-354 OR SIMILAR. INSTALL PER MANF

RECOMMENDATIONS FOR BARRIER-FREE OPERATION AT ACCESSIBLE WC


BARRIER-FREE OPERATION AT ACCESSIBLE WC COMPARTMENTS 18. SEE M/P DRAWINGS FOR ADDITIONAL INFORMATION

PRE-OPERATIONS APPROVAL/PERMIT NOTES


1. FOOD SERVICE ESTABLISHMENT OWNER/OPERATOR TO ACQUIRE ALL PERMITS AND INSPECTIONS FROM CITY OF PORTLAND AND MULTNOMAH COUNTY HEALTH DEPARTMENTS PRIOR TO OPENING. 2. NO CHANGES SHALL BE MADE WITHOUT HEALTH DEPARTMENT APPROVAL.


3. UPON COMPLETION OF CONSTRUCTION AND BEFORE OPENING OF BUSINESS, THE OWNER/OPERATOR OF THE FOOD SERVICE ESTABLISHMENT SHALL: A. COMPLETE REQUIRED APPLICATION FOR THE ANNUAL OPERATIONS PERMIT IF

> CURRENT/VALID PERMIT DOES NOT ALREADY EXIST. B. OBTAIN A PRE-OPERATIONAL INSPECTION APPROVAL FROM THE HEALTH DEPARTMENT. INSPECTION TO BE SCHEDULED AT LEAST ONE WEEK IN ADVANCE OF OPENING AND ALL OTHER INSPECTIONS (PLUMBING, BUILDING, ETC.) ARE TO BE COMPLETED PRIOR TO SCHEDULING OF INSPECTION.

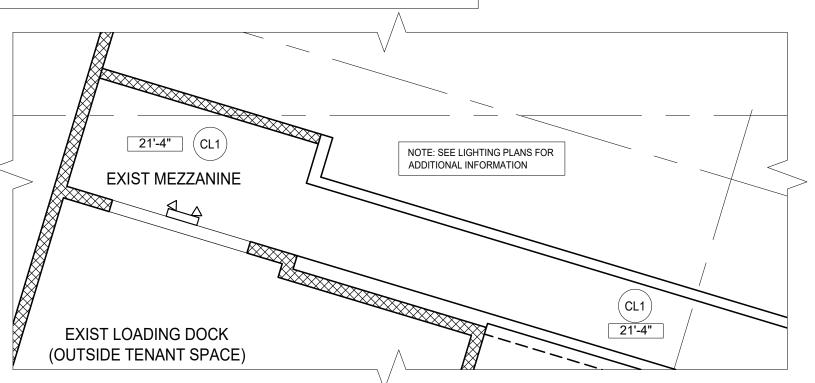

MEZZANINE REFLECTED CEILING PLAN

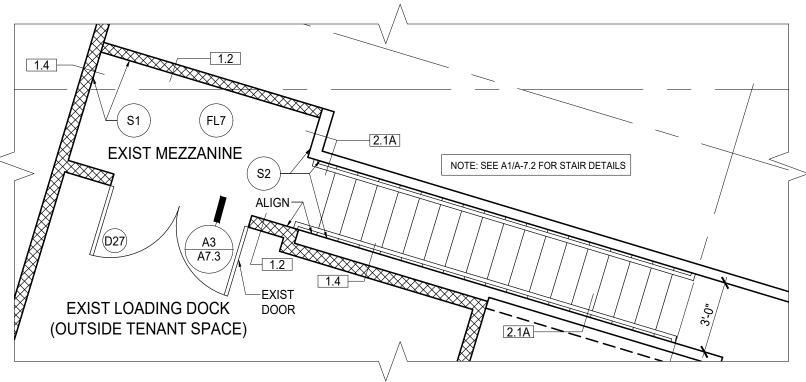

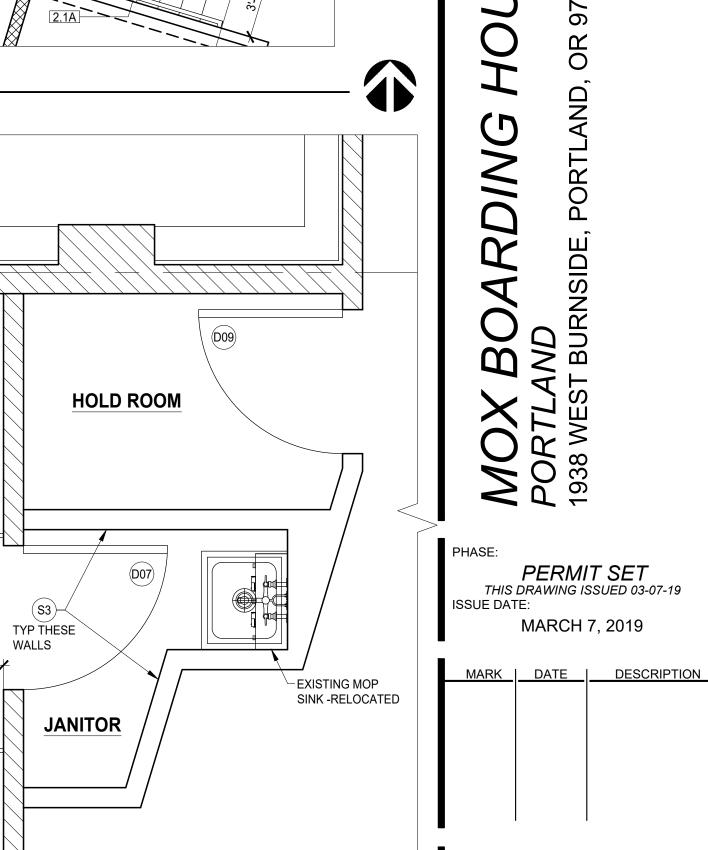

RETAIL STORAGE HALL

WALL-MOUNTED TOILET TYP, PROVIDE

BLOCKING PER MANUF. INSTALLATION MANUAL

PROJECT NO.

DRAWN BY: JAZ, TVL CHECKED BY:

PERMIT SET

THIS DRAWING ISSUED 03-07-19

MARCH 7, 2019

JUSTIN A ZIER

1121 EAST THOMAS STREET

SEATTLE, WA 98102, U.S.A.

VOICE 1-206-322-6249

WWW.DESIGNLEISURE.COM


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ZIER


SEATTLE, WA

SHEET NAME: ENLARGED PLANS MEZZANINE PLANS

SHEET NUMBER:

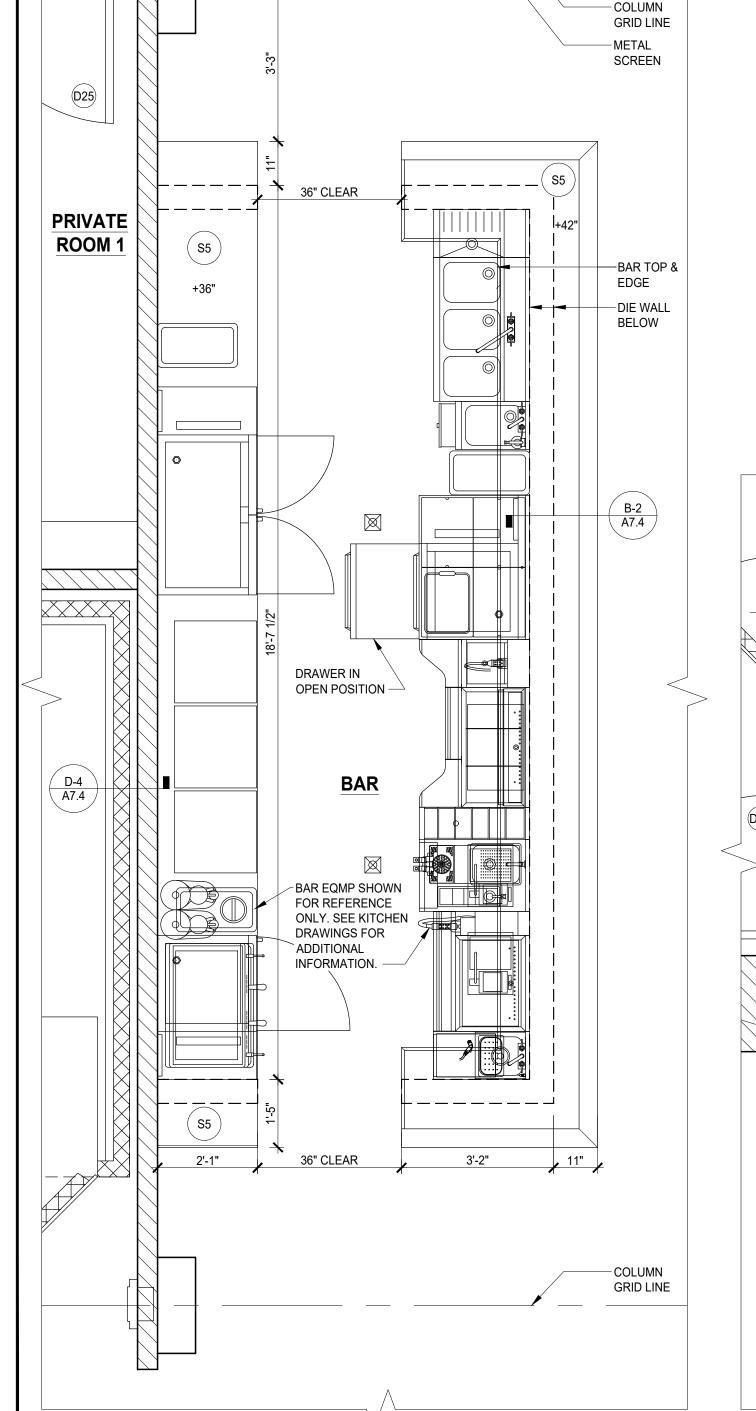



<u>\ ENLARGED BAR PLAN</u>

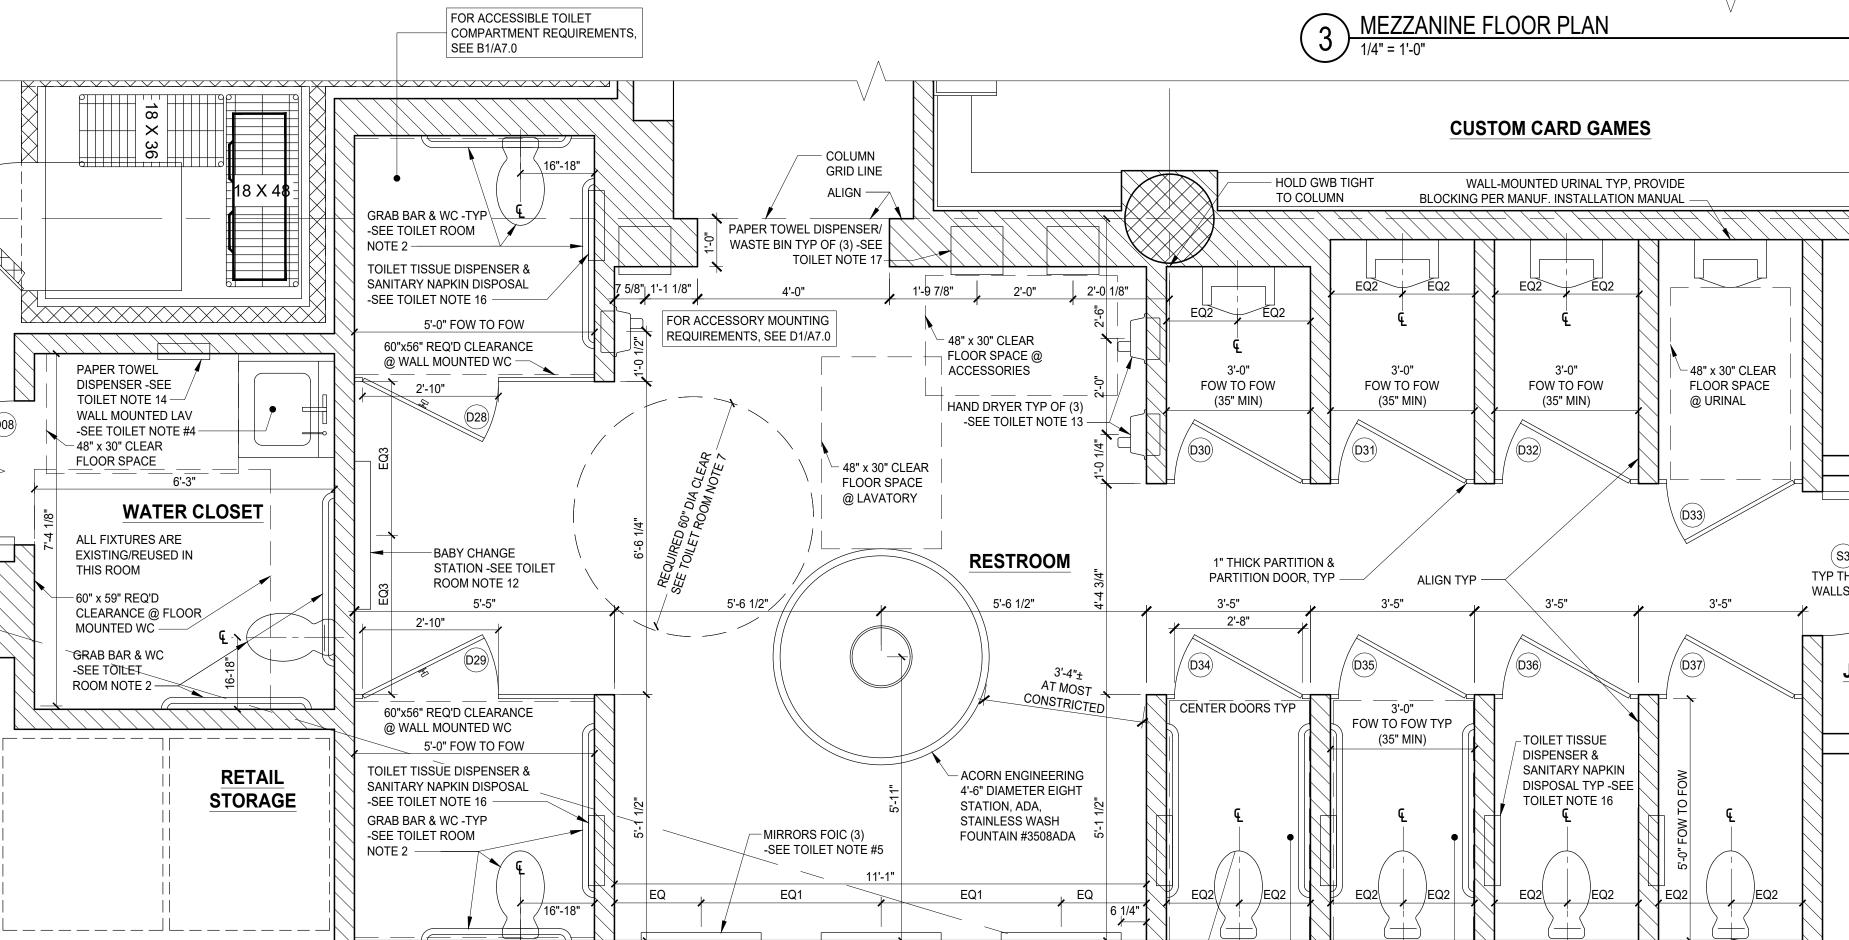



FOR AMBULATORY STALL


REQUIREMENTS, SEE A4/A7.0

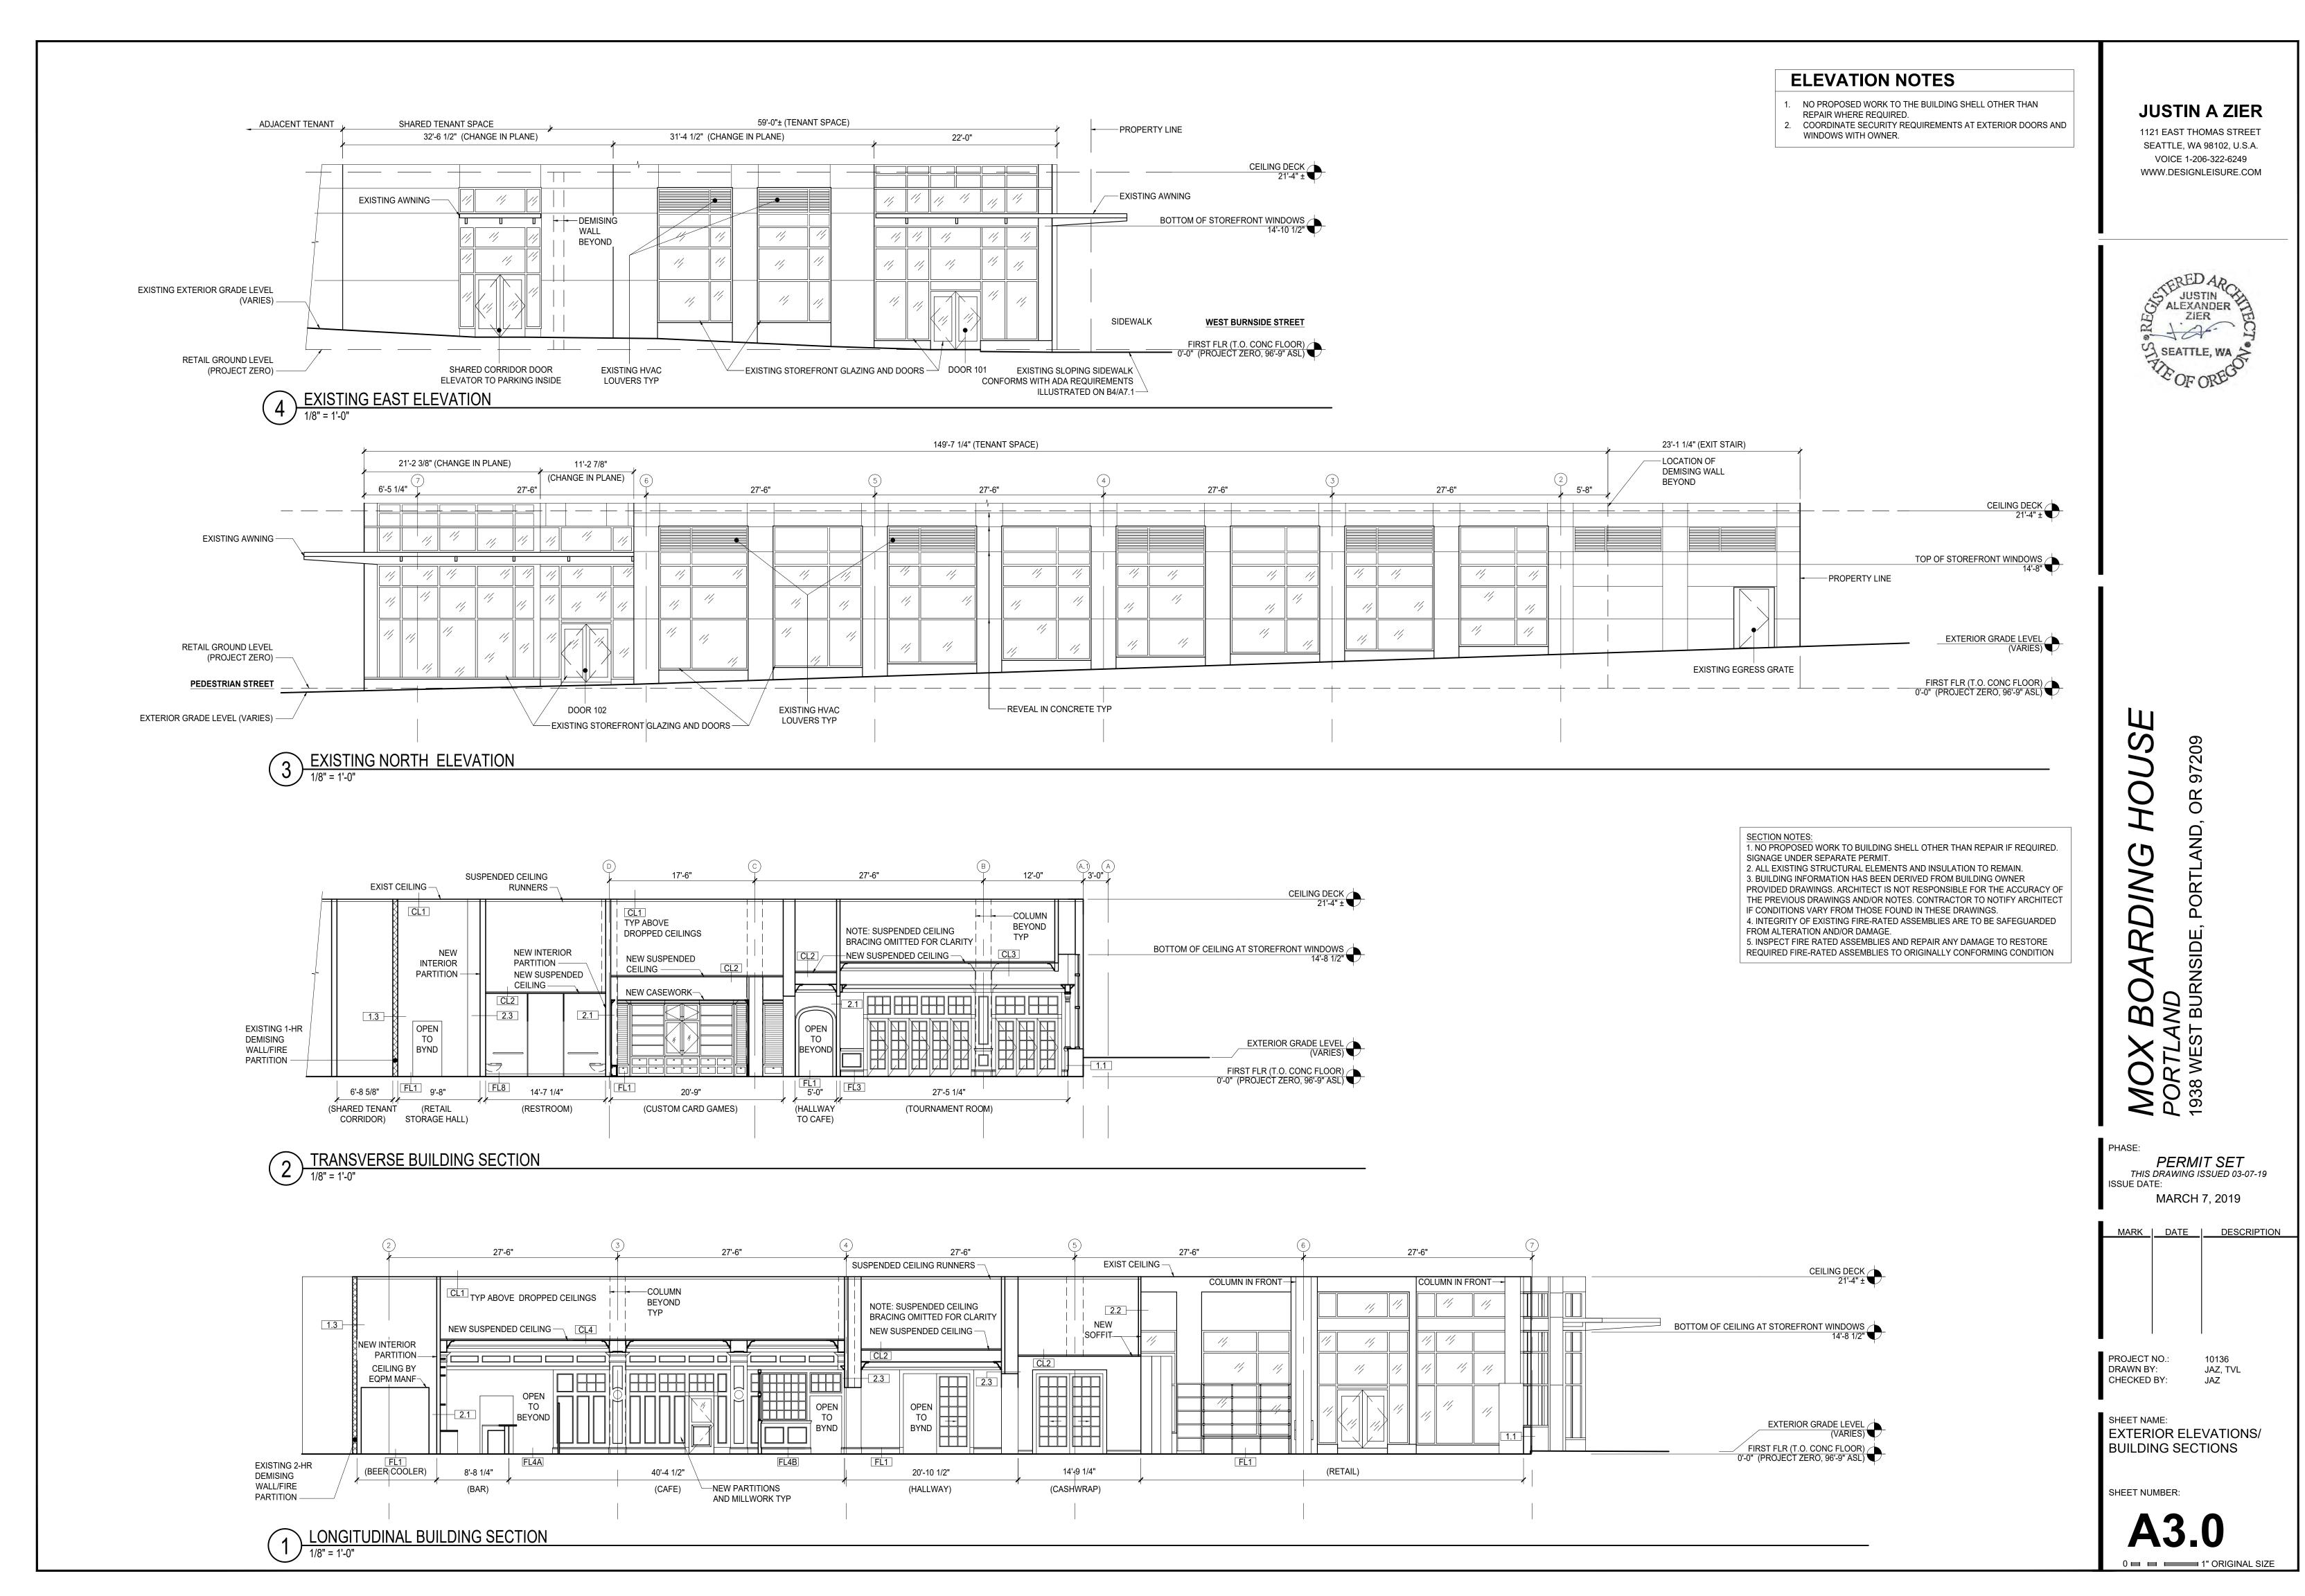

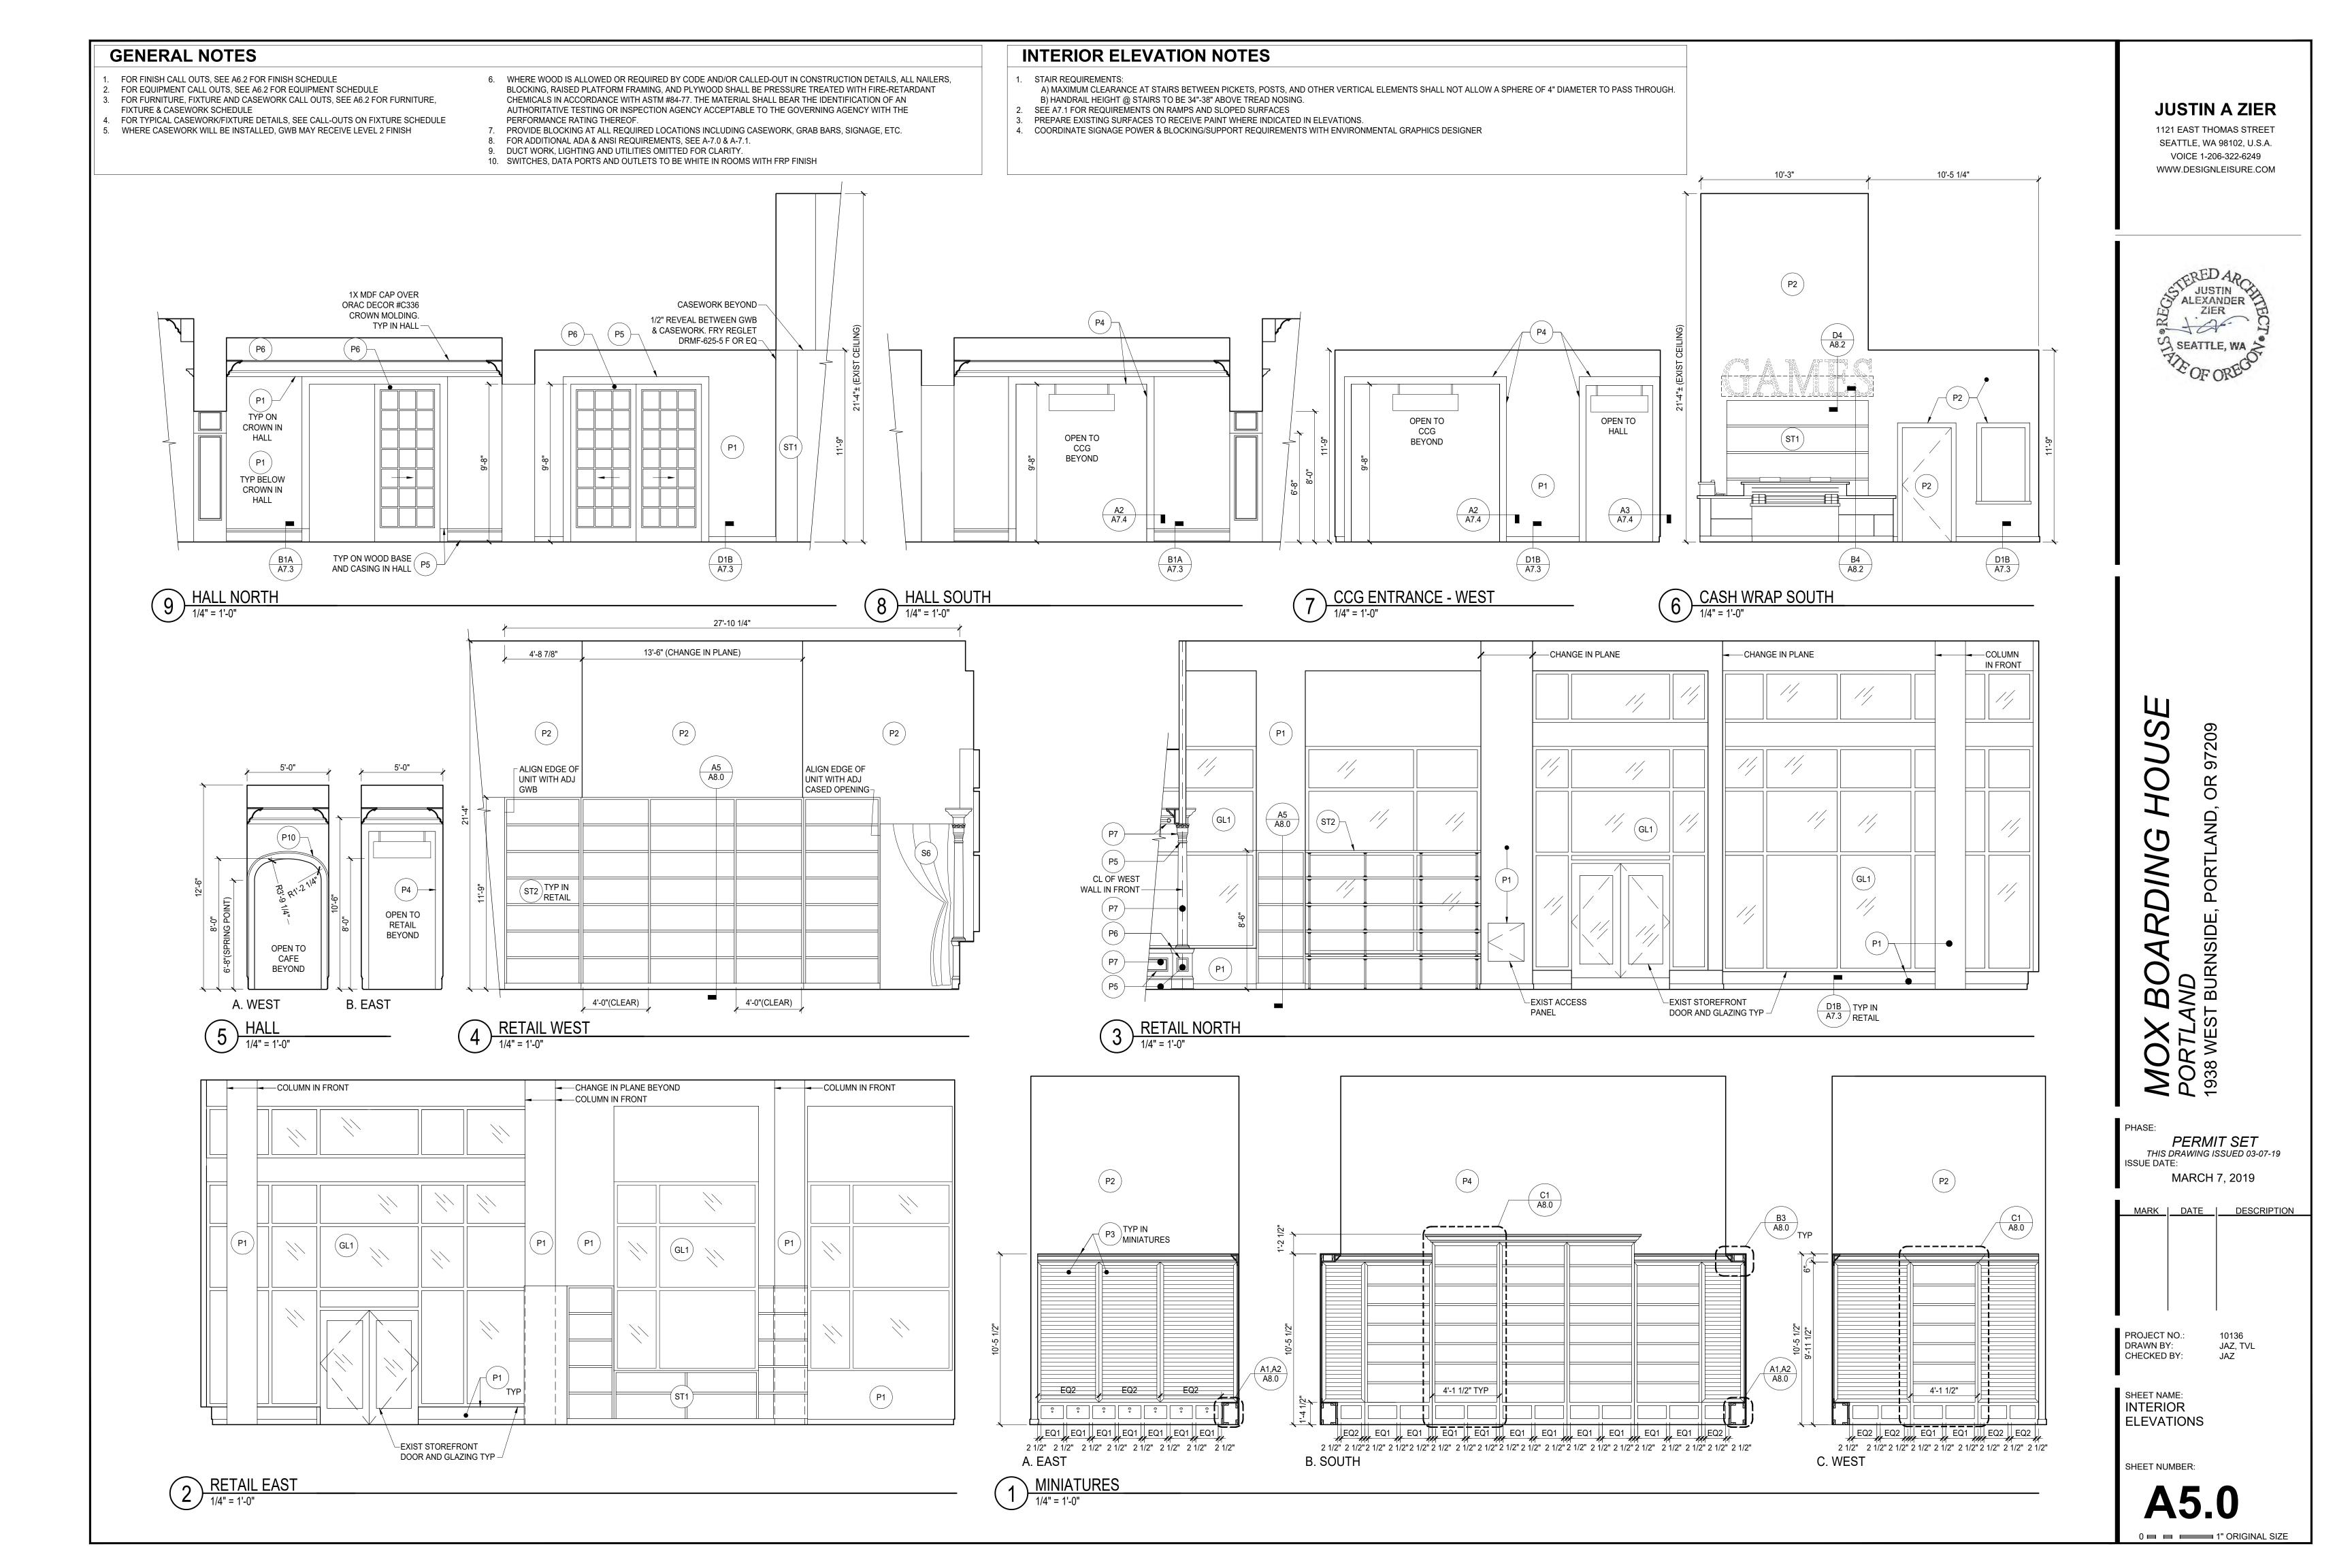

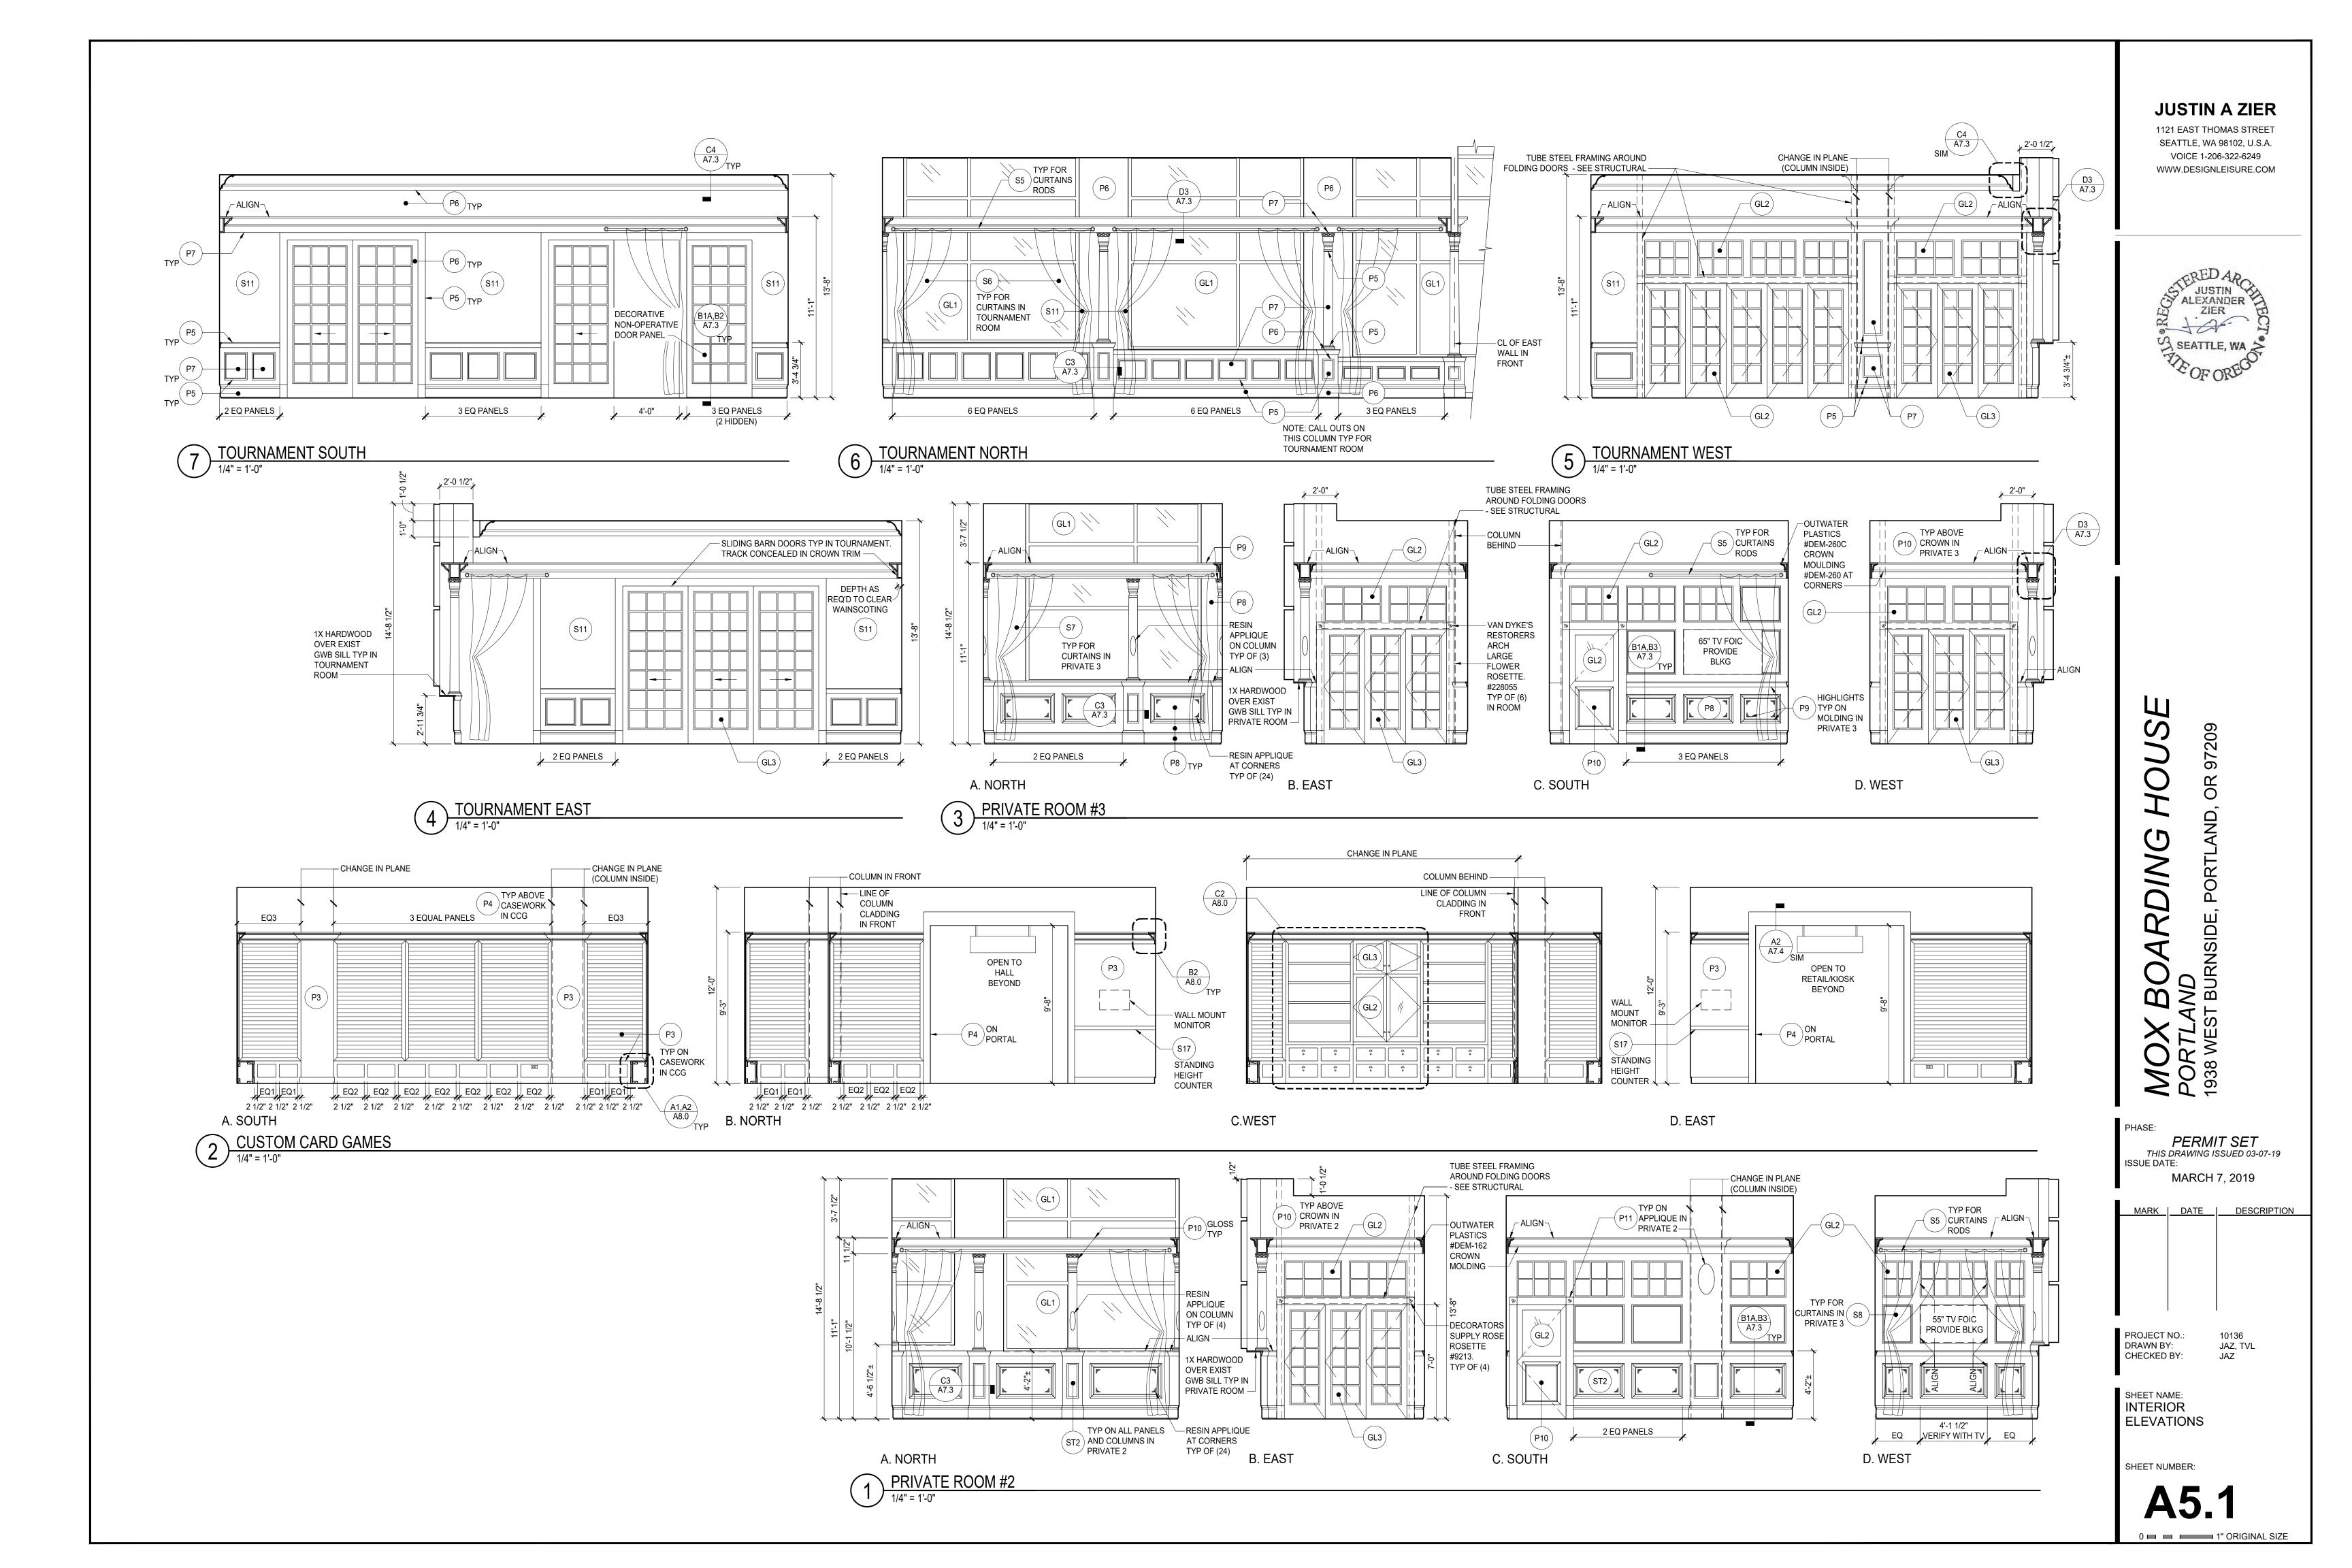

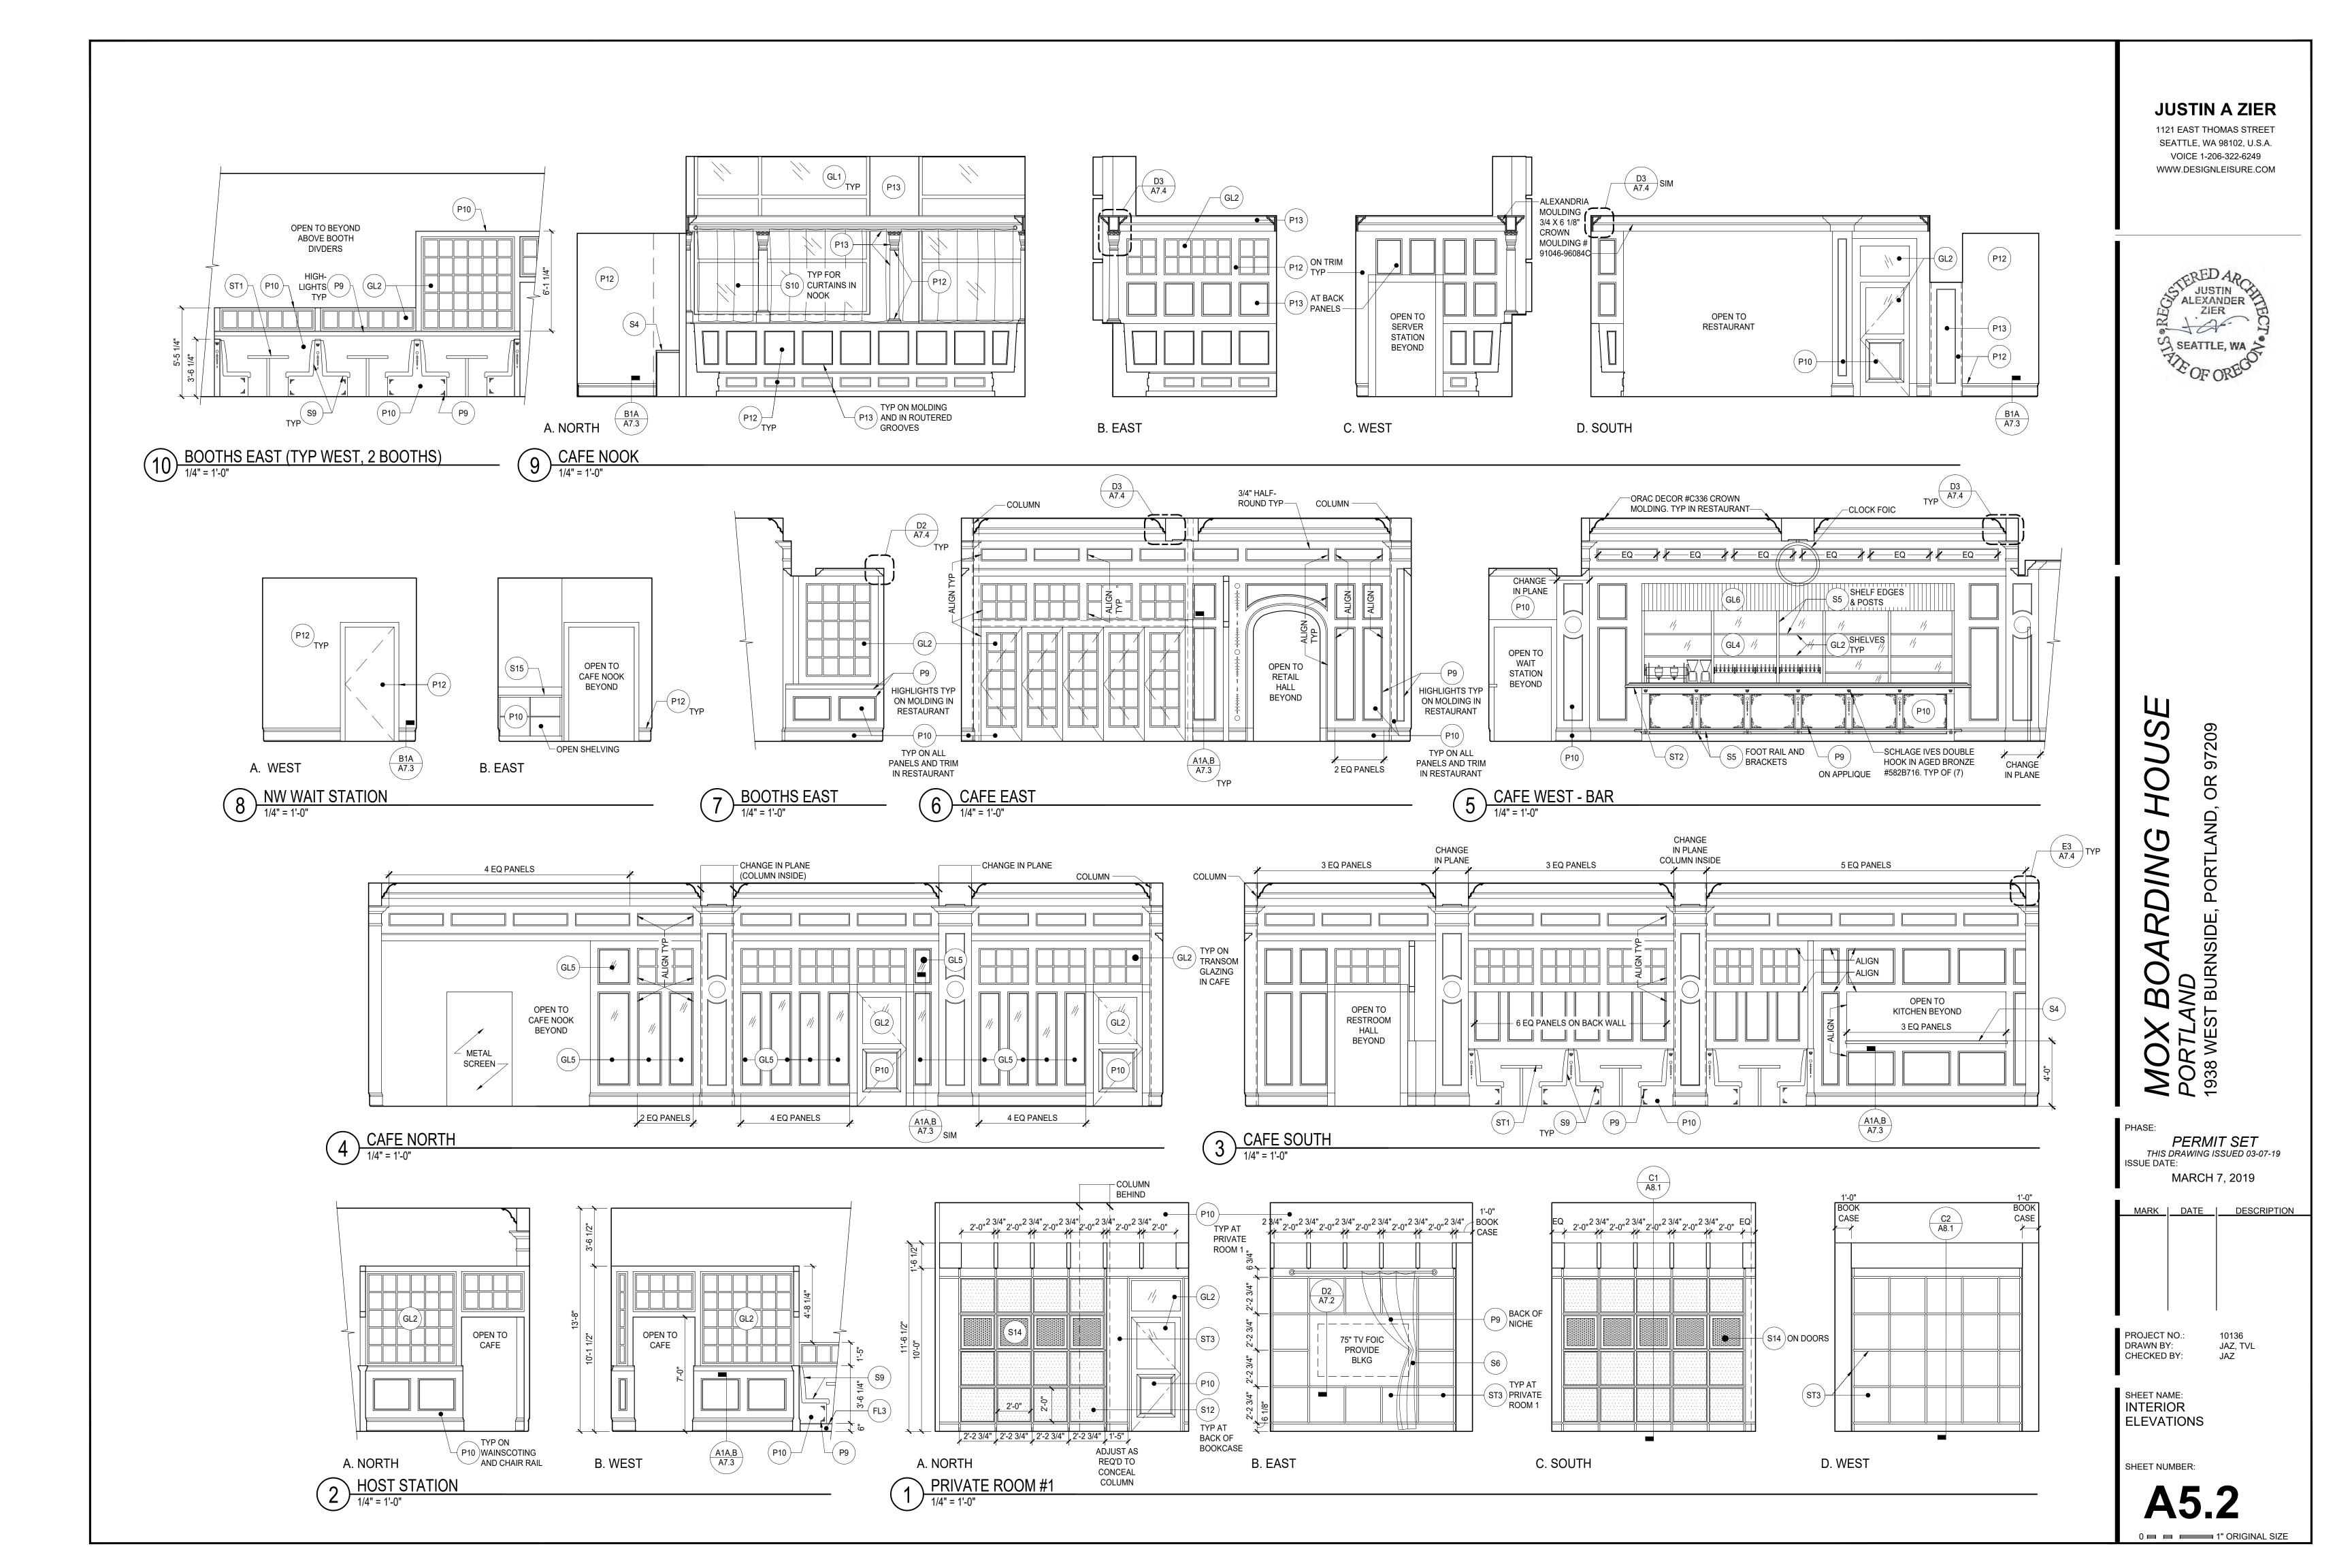

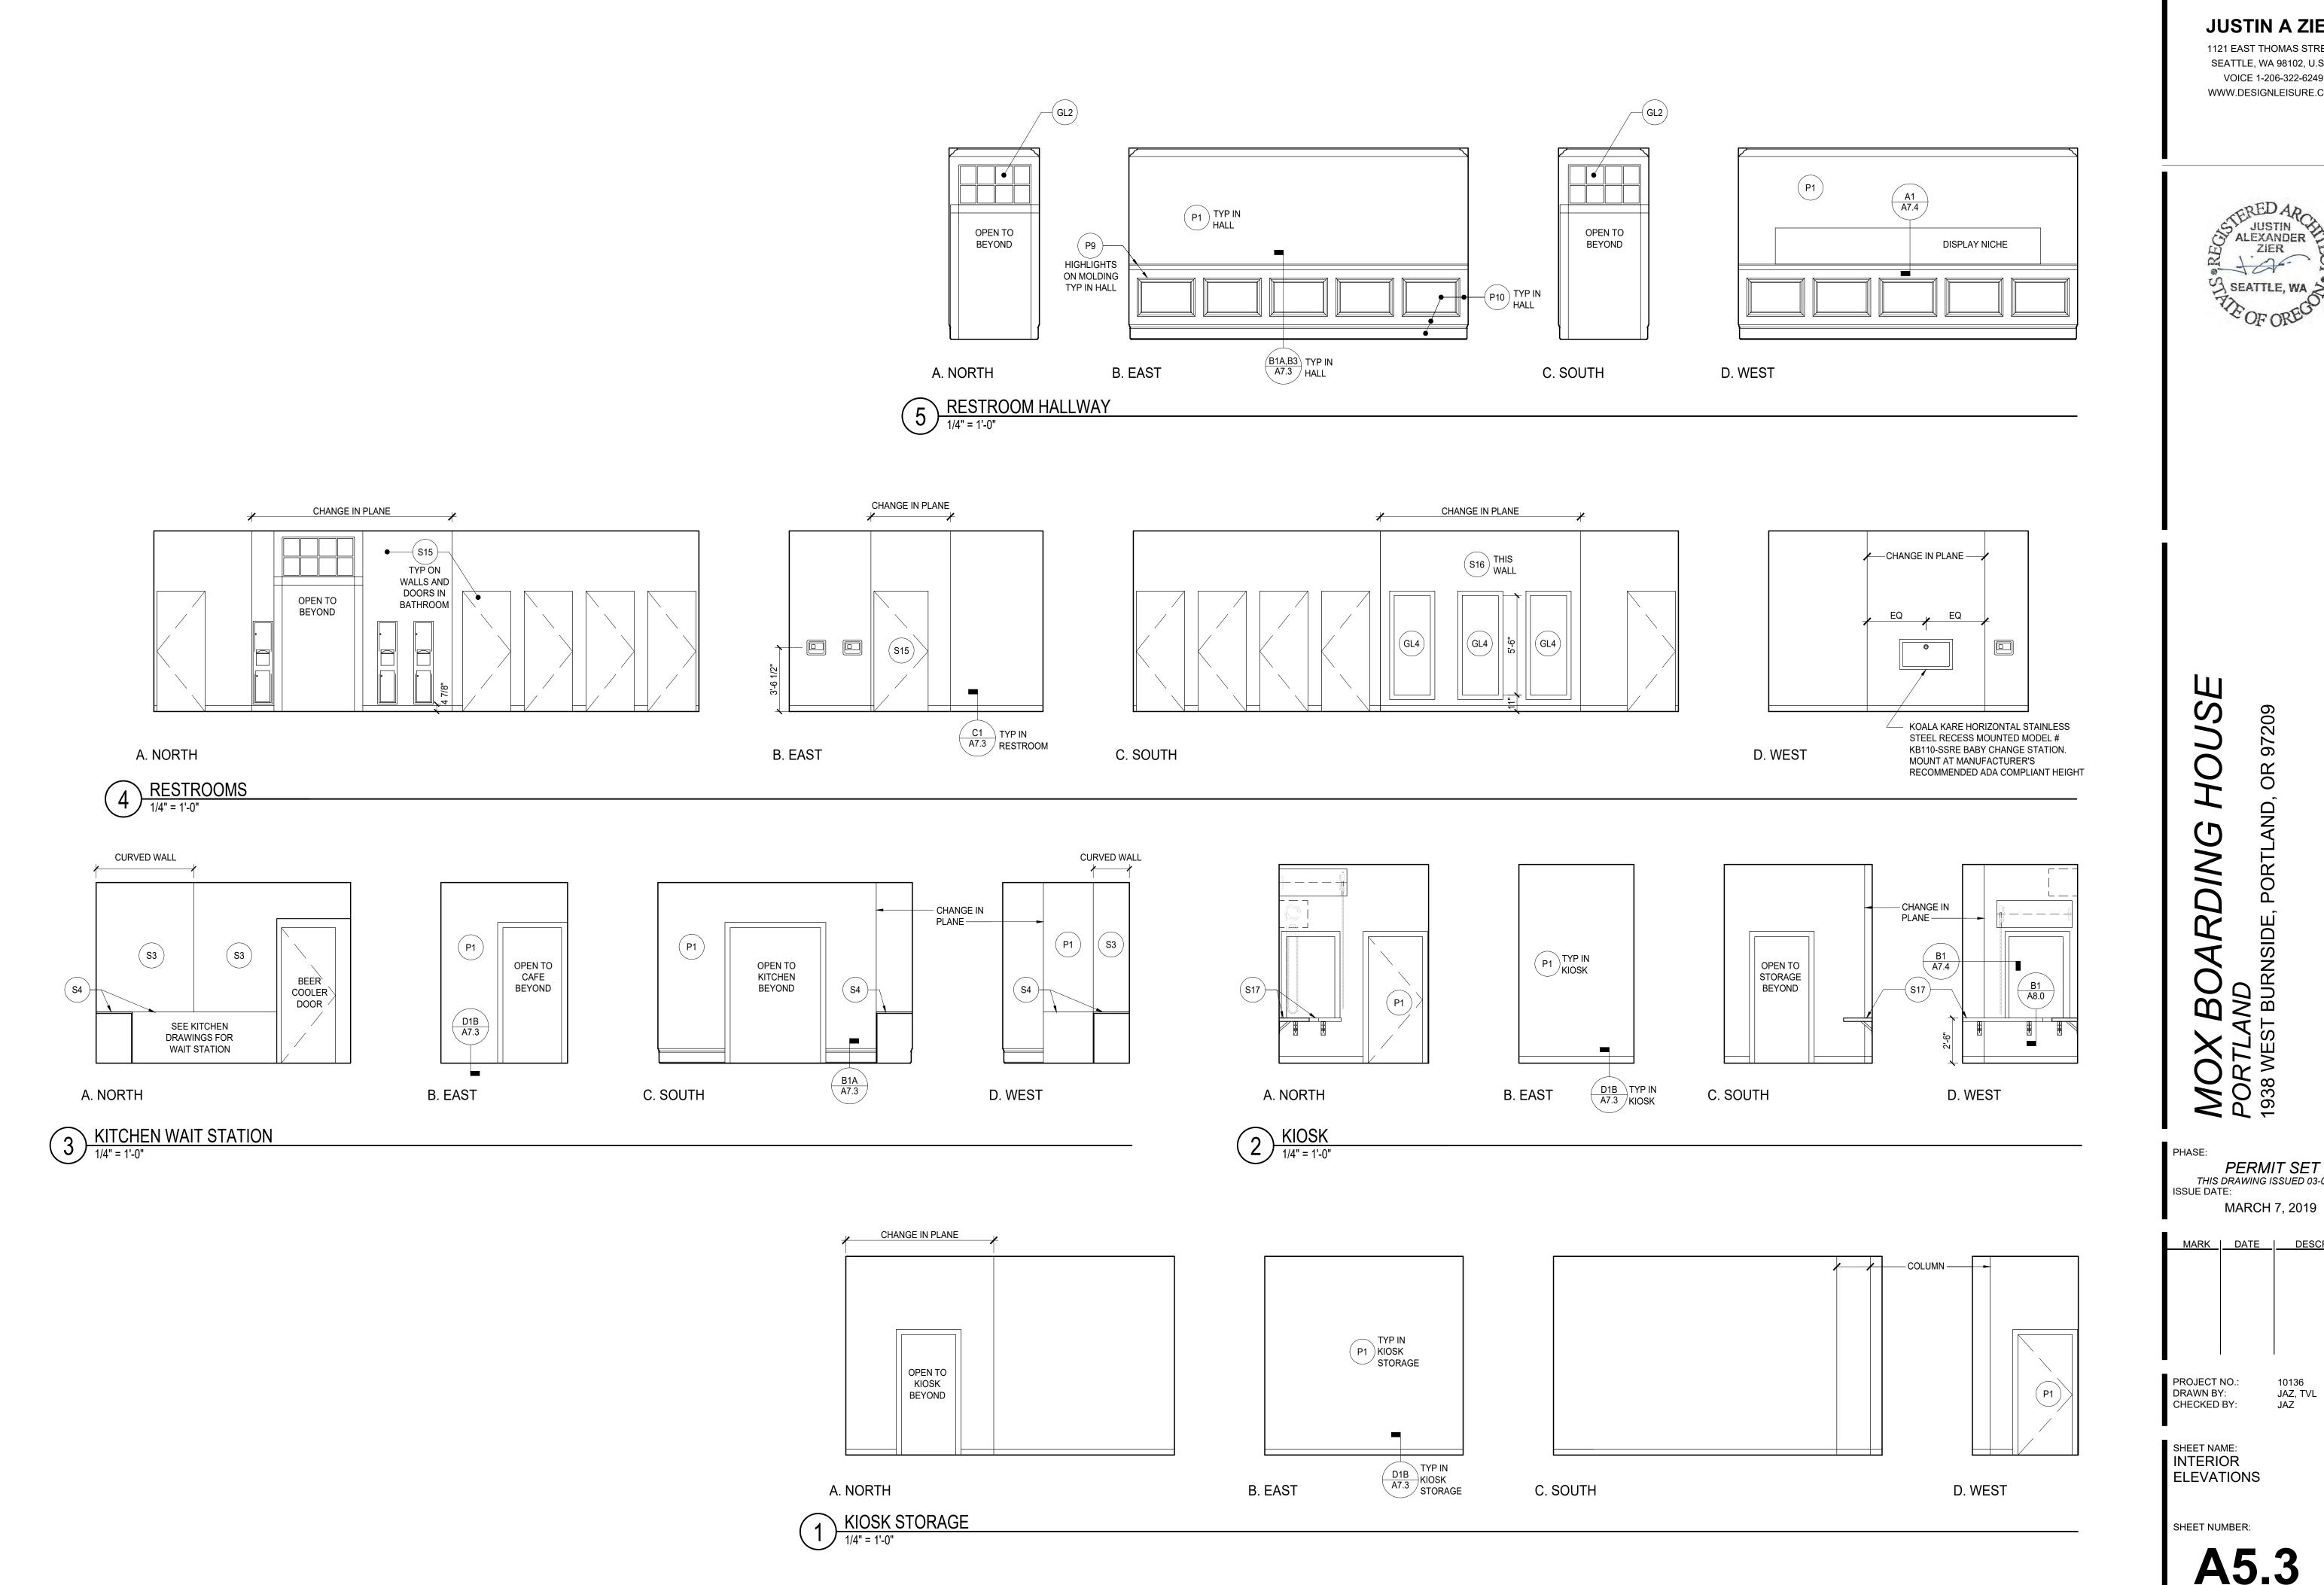


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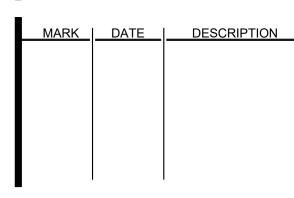
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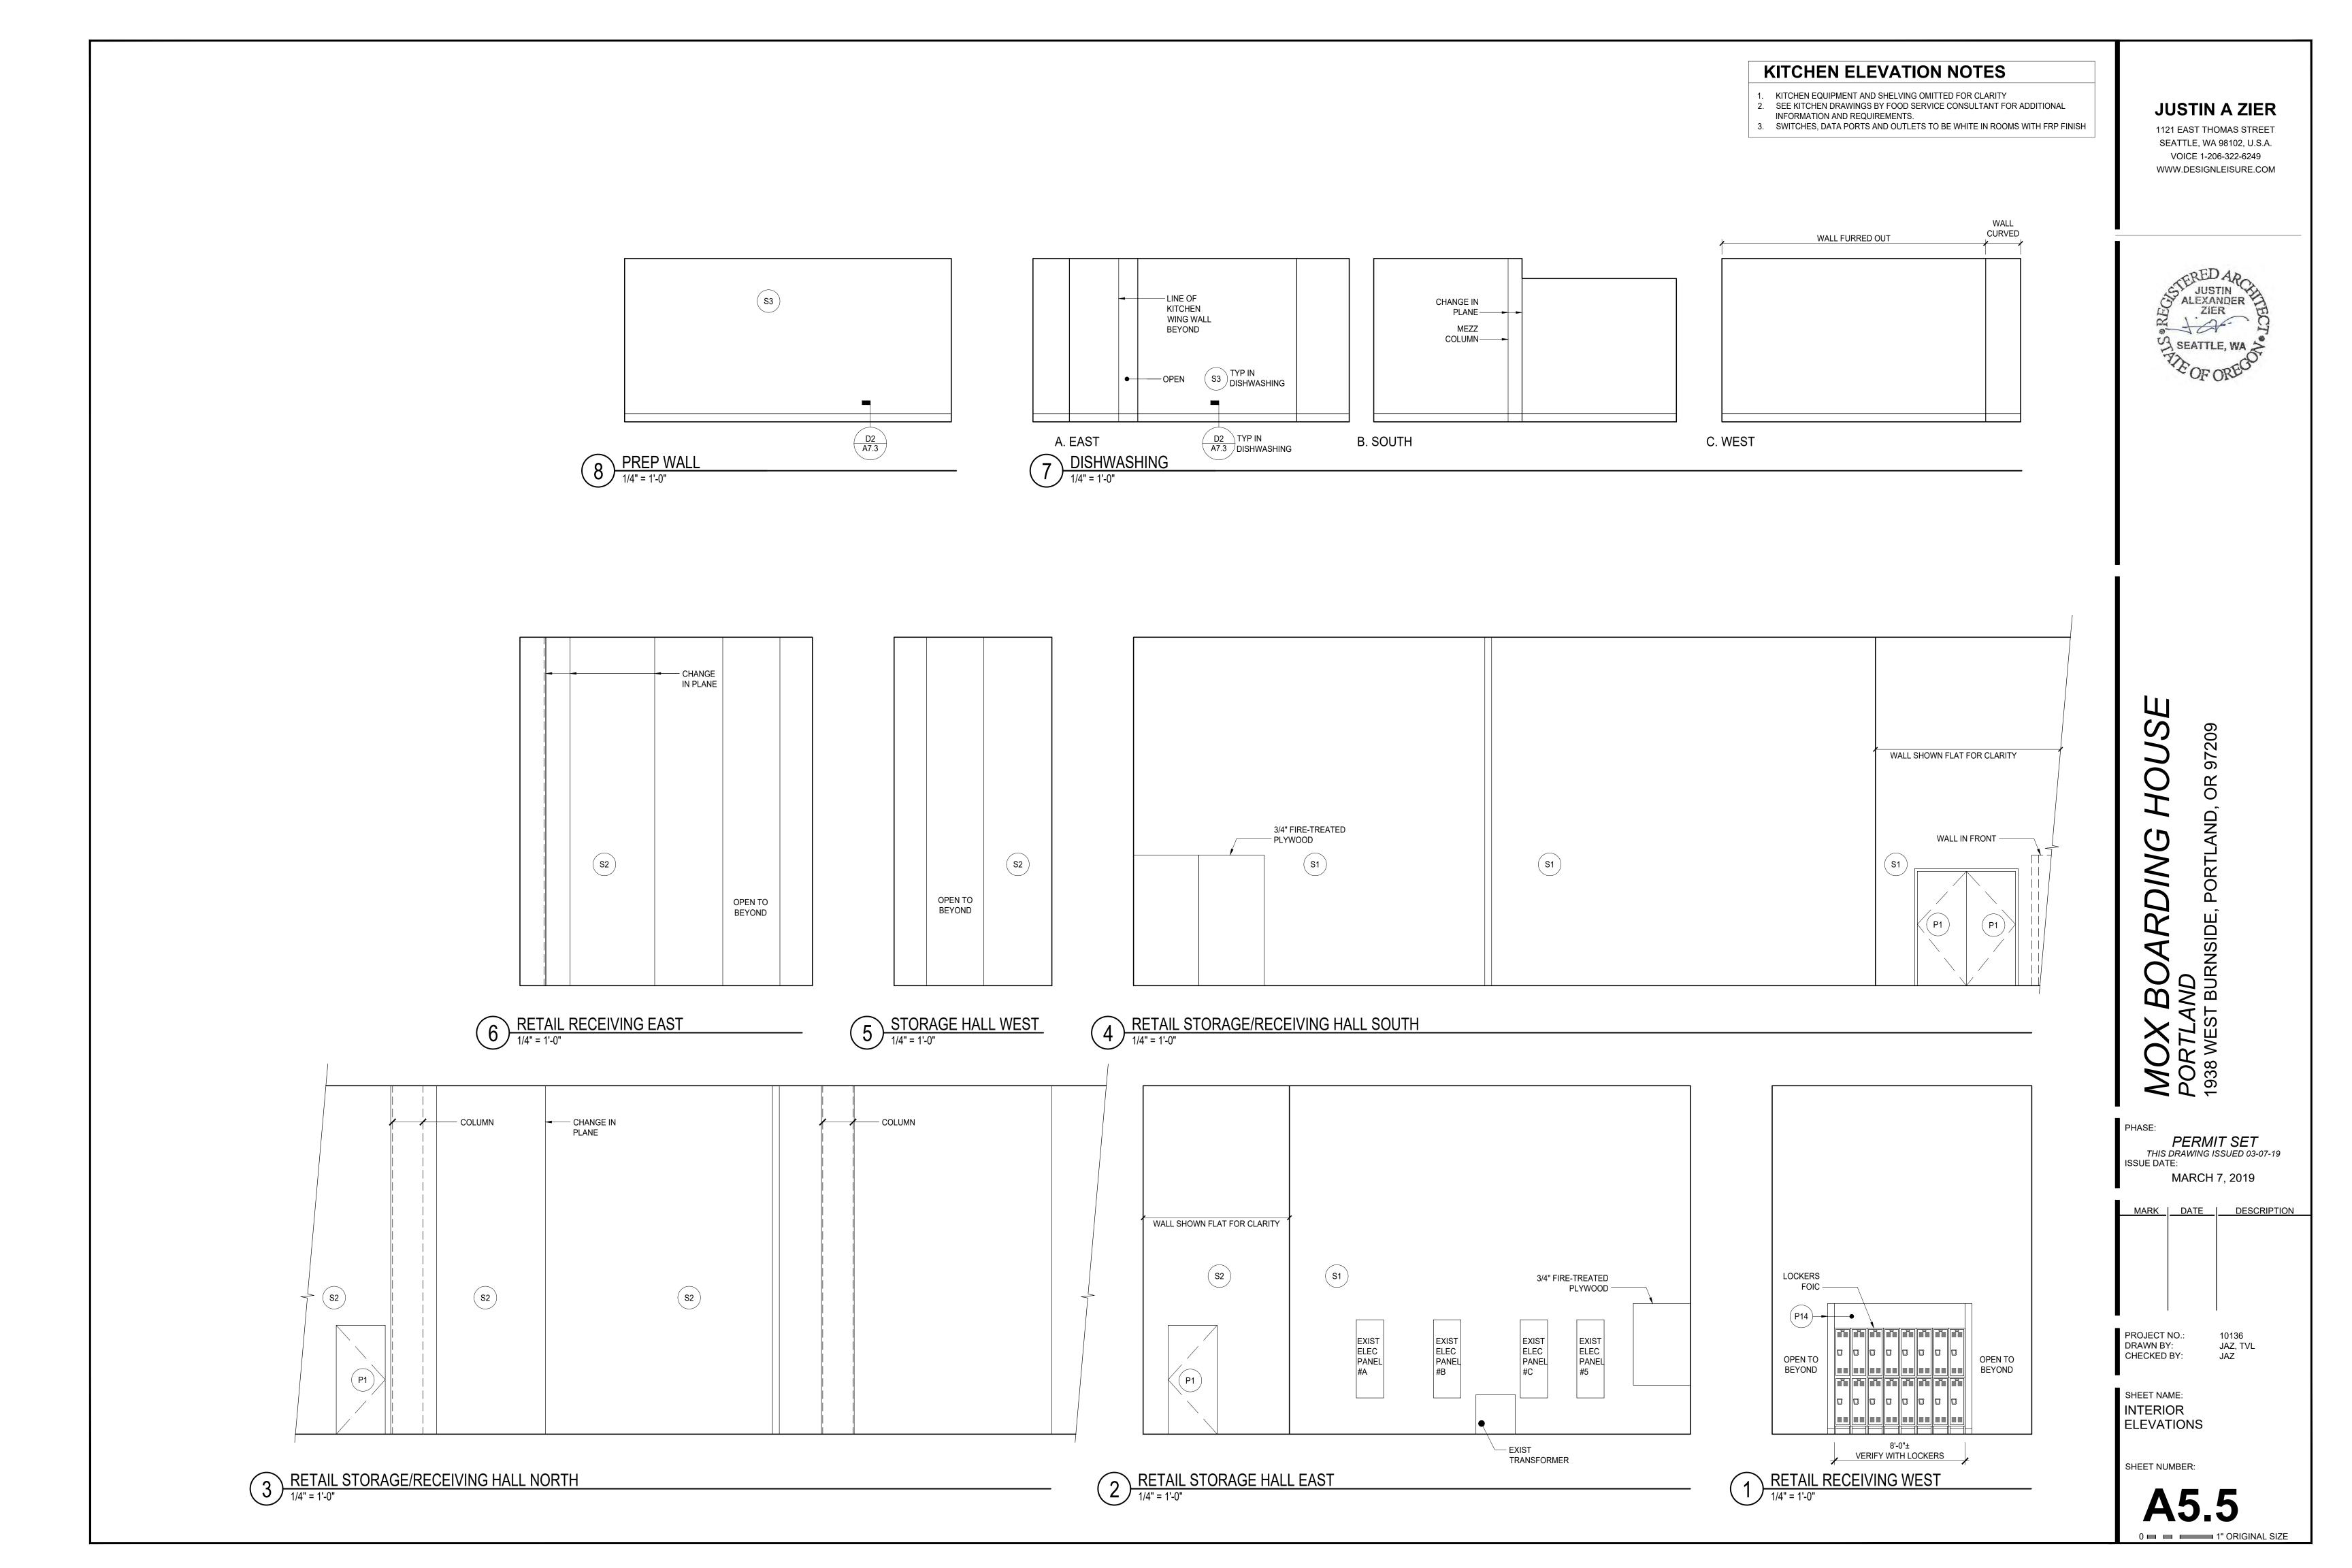



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☐ ☐ ☐ 1" ORIGINAL SIZE






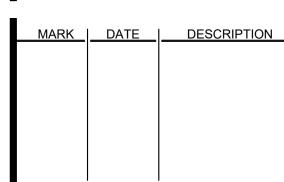

CLARKDIETRICH PROSTUD NON-COMPOSITE STUD LIMITING HEIGHTS—FULLY BRACED

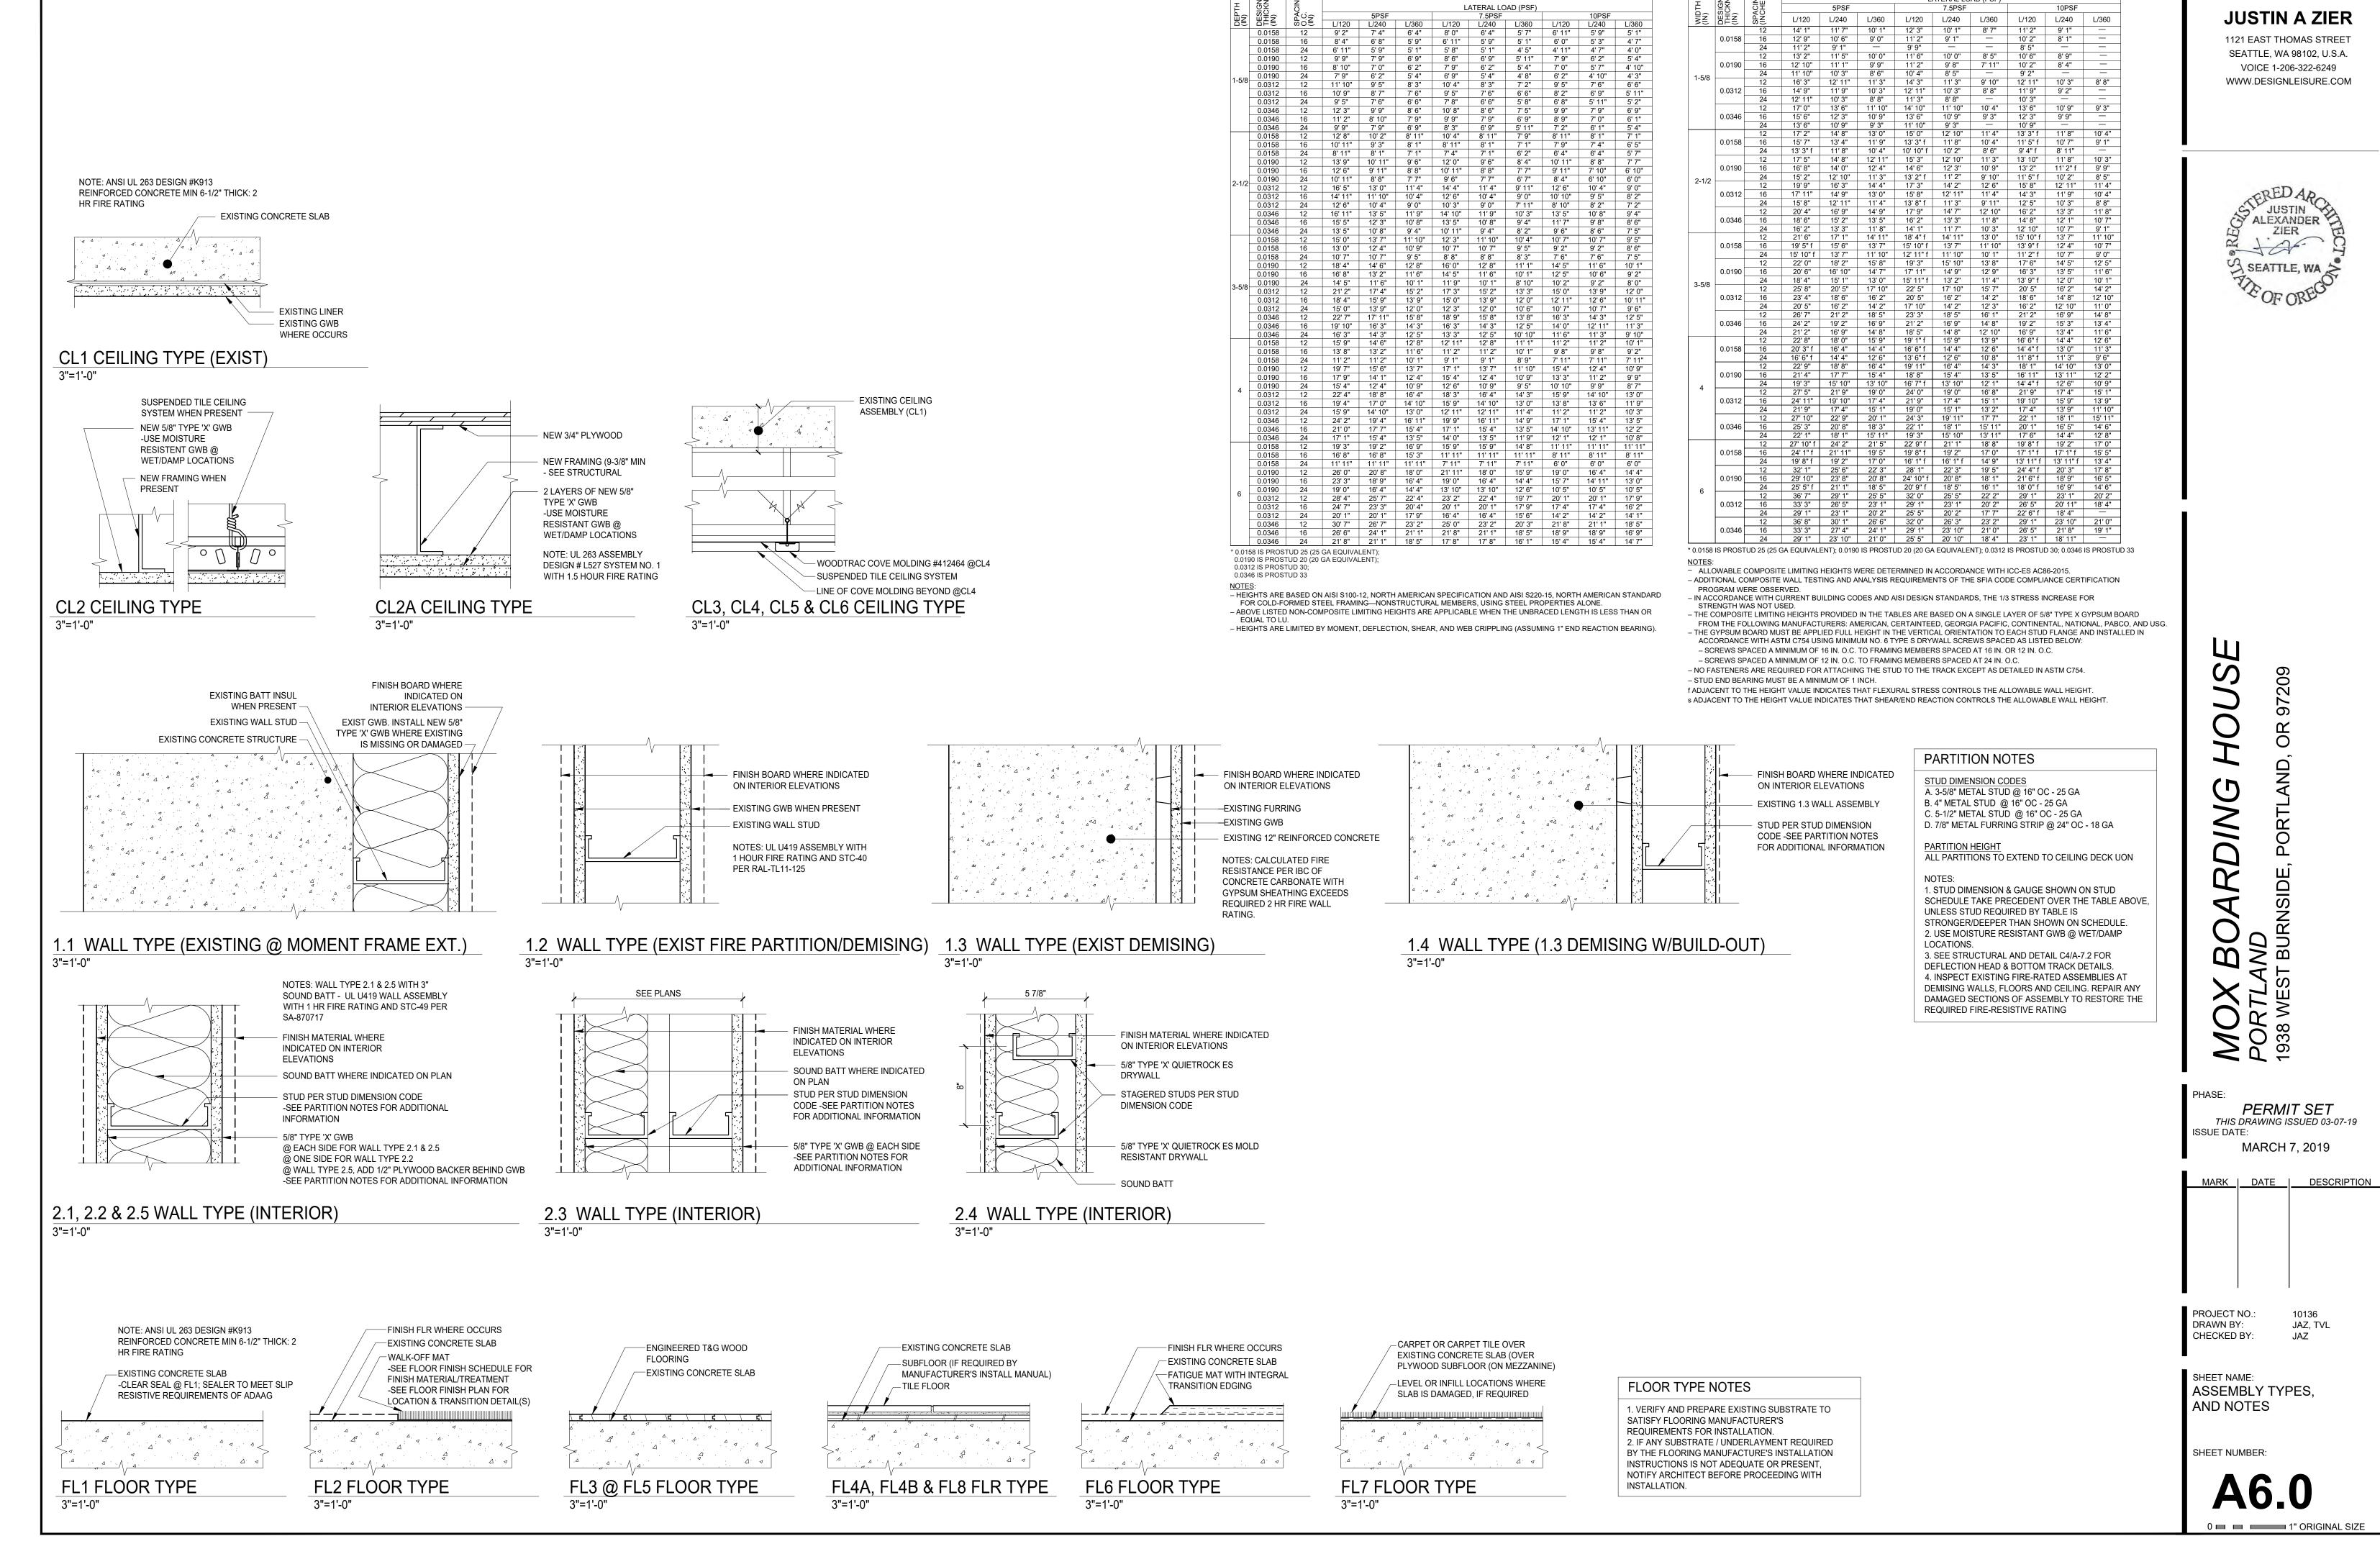CLARKDIETRICH PROSTUD COMPOSITE STUD LIMITING HEIGHTS WITH 5/8" TYPE X GYPSUM BOARD

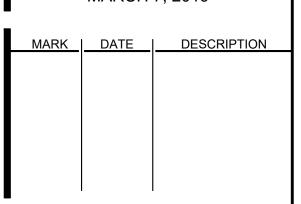

DOOR & WINDOW SCHEDULE

MANUFACTURERS:

FINISH HARDWARE NOTES:

1A = EXISTING 1B = EXISTING - REUSED/RELOCATED 17727 15TH AVENUE NE, (TEL: 888-221-0141, LACANTINADOORS.COM)

CLOSERS TO HAVE BALL-BEARING BUTTS.

REQUIRED AT DOORS IN RATED ASSEMBLIES (E.G. 1-HR WALLS).

DIE CAST OR ALUMINUM MECHANISMS WILL BE ACCEPTED.

2 = FRANK LUMBER 3 = LA CANTINA

REGULATIONS PER THE ADOPTED CODES AND REGULATIONS OF THE CITY, STATE AND FEDERAL GOVERNMENT.

ALL INTERIOR LOCKSETS AND PASSAGE SETS TO BE OMINIA LEVER LATCHSET #368, OR APPROVED EQUAL U.O.N.

SCHEDULED HEREIN AND TO REVIEW OWNER'S KEYING AND KEY CARD/BADGE READER REQUIREMENTS.

PROVIDE OWNER WITH ONE SET OF ADJUSTMENT TOOLS AND MAINTENANCE MANUALS FOR ALL DEVICES.

COORDINATE DOOR HARDWARE REQUIREMENTS WITH REQUIREMENTS OF BUILDING OWNER'S SECURITY SYSTEM.

ALL HARDWARE ITEMS TO BE FINISHED AS US15 SATIN NICKEL UNLESS NOTED OTHERWISE.

A) ALL HARDWARE SELECTED MUST CONFORM TO BUILDING AND FIRE CODES FOR EGRESS REQUIREMENTS. FIRE-RATED HARDWARE

WHERE A DOOR IS PART OF AN ACCESSIBLE ROUTE AND/OR EMERGENCY EGRESS/EXITING PATH, ALL DOOR HARDWARE AND

INSTALLATION THEREOF SHALL SATISFY BUILDING AND FIRE CODES FOR EGRESS/EXITING AND BARRIER FREE ACCESSIBILITY

EXTERIOR LOCKSETS AND LATCHSETS SHALL HAVE CYLINDRICAL STEEL CASE WITH NON-RUSTING INTERIOR CONSTRUCTION.

IF SHOWN, CLOSERS SHALL ALLOW DOOR TO SWING FULL LIMIT. MOUNT CLOSERS ON ROOM SIDE UNLESS NOTED OTHERWISE.

WROUGHT BOX STRIKES TO EXTEND NO MORE THAN 3/16" BEYOND FRAME OR TRIM. PROVIDE CUT-OUTS IN METAL DOORS.

BUTTS TO BE OF SUFFICIENT SIZE TO CLEAR TRIM. EXTERIOR OUT-SWINGING DOORS TO HAVE NON-REMOVABLE PINS. DOORS WITH

INTERIOR DOOR LOCKSETS AND LATCHES SHALL HAVE INTERIOR PARTS OF STEEL AND ZINC-DICHROMATIC PLATING. NO PLASTIC,

PRIOR TO SUBMITTING FINISH HARDWARE SUBMITTAL FOR REVIEW, MEET WITH OWNER AND ARCHITECT TO REVIEW HARDWARE AS

INSTALL DOOR HARDWARE AT MOUNTING HEIGHTS AS RECOMMENDED BY BHMA, UNO. ADJUSTMENTS AND TESTING AS REQUIRED BY INTERNATIONAL BUILDING CODE, OTHER GOVERNING AGENCY OR PER THE MUNICIPALITY'S CURRENTLY ADOPTED MODEL CODE.

SHORELINE, WA 98155 CONTACT: 1875 ORD WAY OCEANSIDE, CA 92056 LOCAL CONTACT: SHAWN CHRISTOPHERSON, TEL: 425-828-9736 1901, PUGET SOUND WOOD WINDOWS

4 = STILE WINDOWS & DOORS (TEL: 206-420-7681, STILEWINDOWS.COM) CONTACT: 11596 WATER TANK RD **BURLINGTON WA 98223** LOCAL CONTACT: SHAWN CHRISTOPHERSON, TEL: 425-828-9736 1901, PUGET SOUND WOOD WINDOWS

5 = McKEON DOOR 6 = BATHROOM PARTITION FABRICATOR TBD

P# = PAINT (SEE FINISH SCHEDULE)

ST# = STAINED AND SEALED (SEE FINISH SCHEDULE)

PRIVACY HINGE & CLOSURE

ABBREVIATIONS:

PR = PAINT READY

PF = PREFINISHED

SC = SOLID CORE

WD = WOOD

STL = STEEL

MF = PER MANUFACTURER

AAL = ANNODIZED ALUMINUM

TG = TEMPERED GLAZING

EX = EXISTING TO REMAIN

DC = DOOR CONTACTS, COORDINATE

BR = BADGE READER, COORDINATE

WITH SECURITY CONTRACTOR

WITH SECURITY CONTRACTOR

NA = NOT APPLICABLE

AL = ALUMINUM & GLASS

A = PANIC BAR WITH DEADBOLT B = PASSAGE OR CLOSET (ANSI F01) C = PRIVACY (ANSI F02) D = DUMMY E = CLASSROOM LOCK (ANSI F05)

LOCK FUNCTION:

F = STOREROOM LOCK (ANSI F07) G = MANUFACTURER'S LOCK AS PART OF ASSEMBLY H = DEADBOLT THUMBTURN (ANSI F17) I = OFFICE LOCK (ANSI F04)

J = EGRESS DOOR/PANIC BAR

BUTTS: HAGER, STANLEY LOCKS AND LATCHES: SCHLAGE PA = PAINT (SEE INTERIOR/EXTERIOR ELEVATIONS) SPECIAL LOCKS: ADAMS-RITE CLOSERS: LCN, NORTON EXIT ALARM LOCKS: ALARM LOCK

ACCEPTABLE MANUFACTURERS:

EXIT DEVICES: VON DUPRIN BOLTS, DOOR SCOPE, STOPS: IVES THRESHOLDS, DOOR BOTTOMS: PEMKO, REESE WEATHERSTRIPPING: PEMKO, REESE

HARDWARE GROUP:

HARDWARE GROUP 1: FURNISH ALL NECESSARY HARDWARE FOR A COMPLETE INSTALLATION. INCLUDING BUT NOT LIMITED TO THE FOLLOWING: 1-1/2 PAIR BUTTS, LOCK AS SPECIFIED, LEVER, WALL STOP. HARDWARE GROUP 2: FURNISH ALL NECESSARY HARDWARE FOR A COMPLETE INSTALLATION, INCLUDING BUT NOT LIMITED TO THE FOLLOWING: 3 PAIR BUTTS, LOCK AS SPECIFIED, LEVER, WALL STOP.

HARDWARE GROUP 3: BARN DOOR HARDWARE HARDWARE GROUP 4: ALL NECESSARY HARDWARE FOR A COMPLETE INSTALLATION OF A MULTI-FOLD DOOR

(PROVIDED BY MANUFACTURER) HARDWARE GROUP 5: ALL NECESSARY HARDWARE FOR A COMPLETE INSTALLATION OF A ROLL DOWN DOOR (PROVIDED BY MANUFACTURER)

HARDWARE GROUP 6: BATHROOM PARTITION DOOR HARDWARE

(D37) RESTROOM STALL

	OORS																
MARK	ROOM OR AREA	MANUF.	TYPE			SIZE		PAN <u>₹</u>		FRA			DWARE	DETAILS			NOTES
		DOOR	MODEL	DOOR	FRAME	WIDTH	HEIGHT	MATERIAL	FINISH	MATERIAL	FINISH	FUNCTION	GROUP	HEAD	SILL	JAMB	
(D01)	ENTRY	1A	EXISTING GLASS STOREFRONT	А	1	6'-0"	7'-0"	TG	NA	AL	MF	А	NA		A3/A-7.3		
D02	ENTRY	1A	EXISTING GLASS STOREFRONT	А	1	6'-0"	7'-0"	TG	NA	AL	MF	А	NA		A4/A-7.3		
D03	RISER ROOM	1A	EXISTING METAL DOOR	В	2	3'-0"	7'-0"	STL	P1	STL	P1	F	NA	D4/A-7.2		D5/A-7.2	P12 ON RETAIL SIDE ONLY
D04	KIOSK	2	SOLID PANEL	В	3	3'-0"	7'-0"	WD	P2/ P1	WD	P1/ P2	F	1	C5/A-7.2		C5/A-7.2	P2 ON RETAIL SIDE
D05	STOCK ROOM	1B	REUSED	С	2	3'-0"	6'-8"	MF	P1	WD	P2	F	1	D4/A-7.2		D4/A-7.2	VERIFY RO REQMTS W/DOOR
D06	RETAIL STORAGE HALL	2	SOLID PANEL	В	3	3'-0"	7'-0"	WD	P1	WD	P1	F	1	C5/A-7.2		C5/A-7.2	PAINTED ON RETAIL SIDE ONLY
D07	HOLD ROOM	1B	REUSED	С	2	3'-0"	6'-8"	MF	P1	STL	P1	F	1	D4/A-7.2		D4/A-7.2	VERIFY RO REQMTS W/DOOR
D08	JANITOR	2	SOLID PANEL	С	2	3'-0"	6'-8"	WD	P1/ S15	WD	P1/ P15	F	1	C5/A-7.2		C5/A-7.2	S15 ON RESTROOM SIDE
D09	EMPLOYEE WC	1B	REUSED	С	2	3'-0"	6'-8"	WD	P15	STL	P1	С	1	D5/A-7.2		D4/A-7.2	VERIFY RO REQMTS W/DOOR
D10	KITCHEN	1B	REUSED	С	2	3'-0"	6'-8"	WD	P1/ P15	STL	P1	В	1	D5/A-7.2		D4/A-7.2	P15 ON KITCHEN SIDE
D11	REAR EXIT	1A	EXISTING METAL DOUBLE DOOR	D	2	6'-0"	7'-0"	STL	P1	STL	P1	J	NA	D5/A-7.2	A4/A-7.3	D3/A-7.2	
D12	OFFICE	1B	REUSED	С	2	3'-0"	6'-8"	WD	P1	STL	P1	I	1	D4/A-7.2	A2A/A-7.3	D4/A-7.2	VERIFY RO REQMTS W/DOOR
D13	CLOSET	1B	REUSED	С	2	3'-0"	6'-8"	WD	P1	STL	P1	I	1	D4/A-7.2		D4/A-7.2	VERIFY RO REQMTS W/DOOR
D14	TOURNAMENT HALLWAY -W	2	FIXED PANEL	Е	3	4'-0"	9'-8"	TG	P6	WD	P5	NA	NA	NA	A2A/A-7.3 SIM	NA	FIXED PANEL TO MATCH D19
D15	TOURNAMENT STORAGE	2	TRIPLE SLIDING PANEL	Е	3	12'-0"	9'-8"	TG	P6	WD	P5	NA	3	C5/A-7.2 SIM		C5/A-7.2 SIM	1
D16	KIOSK ROLL-DOWN	5	ROLL-DOWN	F	3	2'-8"	4'-6"	AL	MF	WD	P2	G	5	C5/A-7.2 SIM		D1/A-7.4	
D17	KIOSK ROLL-DOWN	5	ROLL-DOWN	F	3	3'-0"	4'-6"	AL	MF	WD	P2	G	5	C5/A-7.2 SIM		D1/A-7.4	
D18	TOURNAMENT HALLWAY -E	2	DOUBLE SLIDING PANEL	E	3	8'-0"	9'-8"	TG	P6	WD	P5	NA	3	C5/A-7.2 SIM	A2A/A-7.3 SIM	C5/A-7.2 SIM	1
D19	TOURNAMENT HALLWAY -W	2	SINGLE SLIDING PANEL	E	3	4'-0"	9'-8"	TG	P6	WD	P5	NA	3	C5/A-7.2 SIM	A2A/A-7.3 SIM	C5/A-7.2 SIM	1
D20	TOURNAMENT WEST -S	3	5 PANEL FOLDING	G	4	12'-6"	7'-0"	TG	P10	WD	P5/ P10	I	4	C5/A-7.2		C5/A-7.2	
D21	TOURNAMENT WEST - N	3	3 PANEL FOLDING	G	4	7'-6"	7'-0"	TG	P10	WD	P5/ P8	I	4	C5/A-7.2		C5/A-7.2	
D22	PRIVATE ROOM 3	2	1/2-LITE 1 PANEL	Н	4	3'-0"	7'-0"	WD	P10	WD	P11	E	1	C5/A-7.2		C5/A-7.2	
D23	PRIVATE ROOM 2-3	3	3 PANEL FOLDING	G	4	7'-6"	7'-0"	TG	P10	WD	P8/ ST2	ı	4	C5/A-7.2		C5/A-7.2	
D24	PRIVATE ROOM 2	2	1/2-LITE 1 PANEL	Н	4	3'-0"	7'-0"	WD	P10	WD	P10	E	1	C5/A-7.2		C5/A-7.2	
D25	PRIVATE ROOM 1	2	1/2-LITE 1 PANEL	Н	5	3'-0"	7'-0"	WD	P10	WD	P10	E	1	C5/A-7.2		C5/A-7.2	
D26	STAIRWELL EXIT	1A	EXISTING METAL EXIT DOOR	K	3	3'-0"	7'-0"	STL	P12	STL	P12	J	NA	D5/A-7.2	A4/A-7.3	D3/A-7.2	EXIST RATED DOOR
D27	LOADING DOCK	1A	EXISTING METAL DOUBLE DOOR	D	3	6'-0"	7'-0"	STL	P1	STL	P1	J	NA	D5/A-7.2	A4/A-7.3	D3/A-7.2	EXIST RATED DOOR
D28	RESTROOM STALL	6	PARTITION DOOR	L	2	3'-0"	6'-8"	LAM	S15	AL		С	6				PRIVACY HINGE & CLOSURE
D29	RESTROOM STALL	6	PARTITION DOOR	L	2	3'-0"	6'-8"	LAM	S15	AL		С	6				PRIVACY HINGE & CLOSURE
D30	RESTROOM STALL	6	PARTITION DOOR	L	2	2'-10"	6'-8"	LAM	S15	AL		С	6				PRIVACY HINGE & CLOSURE
D31	RESTROOM STALL	6	PARTITION DOOR	L	2	2'-10"	6'-8"	LAM	S15	AL		С	6				PRIVACY HINGE & CLOSURE
D32	RESTROOM STALL	6	PARTITION DOOR	L	2	2'-10"	6'-8"	LAM	S15	AL		С	6				PRIVACY HINGE & CLOSURE
D33	RESTROOM STALL	6	PARTITION DOOR	L	2	2'-10"	6'-8"	LAM	S15	AL		С	6				PRIVACY HINGE & CLOSURE
D34	RESTROOM STALL	6	PARTITION DOOR	L	2	2'-10"	6'-8"	LAM	S15	AL		С	6				PRIVACY HINGE & CLOSURE
D35	RESTROOM STALL	6	PARTITION DOOR	L	2	2'-10"	6'-8"	LAM	S15	AL		С	6				PRIVACY HINGE & CLOSURE
D36	RESTROOM STALL	6	PARTITION DOOR	L	2	2'-10"	6'-8"	LAM	S15	AL		С	6				PRIVACY HINGE & CLOSURE
									1	1	1	1					


L 2 2'-10" 6'-8" LAM S15 AL

PARTITION DOOR


WINDOWS

MARK	MANF	SIZE	<u> </u>	
		WIDTH	НЕІСНТ	LITES (WxH)
(W01)	4	3'-6 1/4"	2'-2 1/2"	3x2
W02	4	3'-6 1/4"	2'-2 1/2"	3x2
(W03)	4	2'-9 3/8"	2'-2 1/2"	3x2
(W04)	4	2'-9 3/8"	2'-2 1/2"	3x2
W05	4	2'-9 3/8"	2'-2 1/2"	3x2
W06	4	2'-9 3/8"	2'-2 1/2"	3x2
W07	4	3'-7"	2'-2 1/2"	3x2
(W08)	4	3'-0"	2'-2 1/2"	3x2
(W09)	4	3'-1/2"	2'-2 1/2"	3x2
W10	4	3'-1/2"	2'-2 1/2"	3x2
W11)	4	5'-7"	1'-2"	6x1
W12	4	5'-7"	1'-2"	6x1
W13	4	5'-3 1/2"	5'-6 1/4"	6x5
W14)	4	5'-5 1/2"	5'-6 1/4"	6x5
W15	4	3'-6 1/2"	2'-2 1/2"	3x2
W16	4	5"	5'-6 1/4"	1x5
W17)	4	3'-6 1/2"	2'-2 1/2"	3x2
W18	4	3'-7 3/8"	2'-2 1/2"	3x2
W19	4	3'-7 3/8"	2'-2 1/2"	3x2
(W20)	4	3'-7 3/8"	2'-2 1/2"	3x2
(W21)	4	2'-4 3/4"	2'-2 1/2"	3x2
(W22)	4	2'-4 3/4"	2'-2 1/2"	3x2
(W23)	4	3'-11 1/2"	5'-8 1/4"	4x5
(W24)	4	3'-6 1/4"	2'-2 1/2"	3x2
(W25)	4	3'-6 1/4"	2'-2 1/2"	3x2
(W26)	4	3'-0"	2'-2 1/2"	3x2
(W27)	4	3'-1 1/4"	2'-2 1/2"	3x2
(W28)	4	3'-1 1/4"	2'-2 1/2"	3x2
(W29)	4	3'-5"	2'-2 1/2"	3x2
(W30)	4	1'-10"	2'-2 1/2"	2x2
(W31)	4	4'-1 1/2"	2'-2 1/2"	2x5
(W32)	4	1'-10"	2'-2 1/2"	2x2
(W33)	4	4'-0"	2'-2 1/2"	2X5

DOOR & WINDOW TYPES

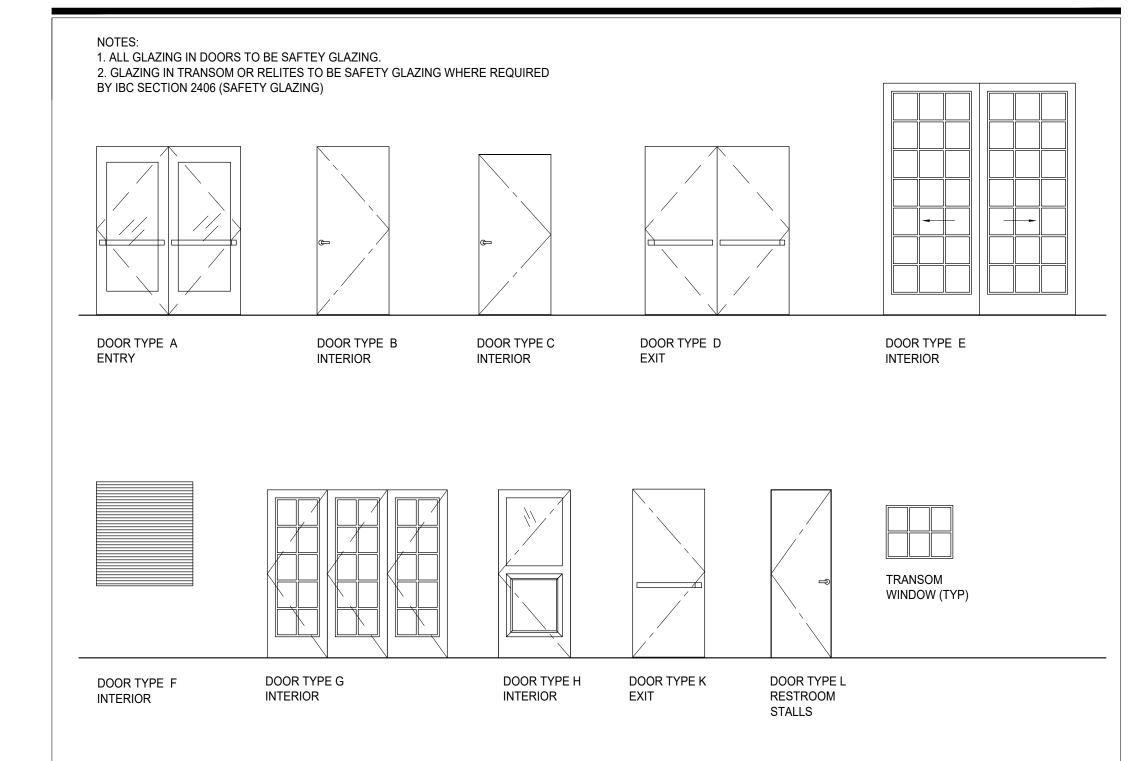

DOOR FRAME TYPES

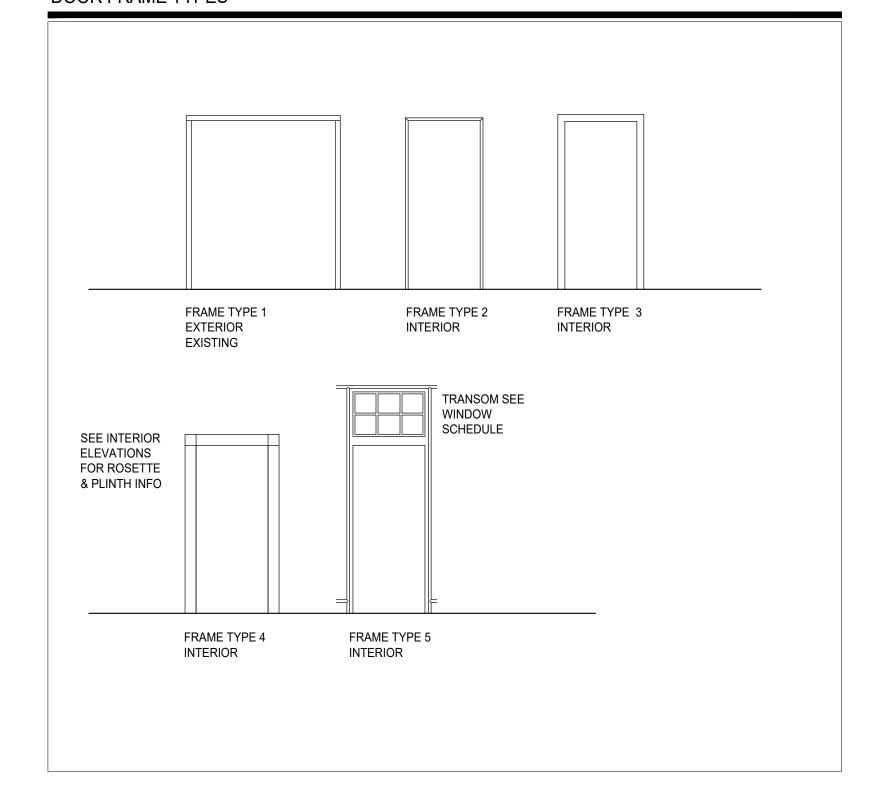

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PERMIT SET
THIS DRAWING ISSUED 03-07-19 ISSUE DATE:

	MARCH 7, 2019										
ĺ	MARK	DATE	DESCRIPTION								
		ı	ı								

DRAWN BY: CHECKED BY:

SHEET NAME:

DOOR & WINDOW SCHEDULE

JAZ, TVL

AND TYPES

SHEET NUMBER:

FINISH SCHEDULE

SYMBOL	H SCHEDULE	DESCRIPTION	FINISH	CONTACT	NOTE
FL1)		EXISTING CONCRETE FLOOR	CLEAR SEALED		SEALER TO MEET ADA SLIP
FL2	+ + + + + + + + + + + + + + + + + + +	MATSINC 6'-5" X 5'-0"' COCOA 5/8" WALK OFF MAT		MATSINC 800 628 7462	RESISTANCE REQ'S HIGH PROFILE BLACK VINYL
FL3		IN MEDIUM GRAY KENTWOOD ENGINEERED WOOD FLOOR - MILLTOWN COLLECTION		GREAT FLOORS 360 695 1231	NOSING
(FL4A)		BRUSHED OAK SILVERTON CARRARA WHITE 2" HEX MOSAIC HONED MARBLE TILE	HONED	STONE CENTER 714 635 4473	SEAL STONE & USE EXPOY GROU
(FL4B)		MODEL # C32XH CARRARA WHITE 2" HEX MOSAIC HONED MARBLE TILE W/ PATTERN	HONED	STONE CENTER	SEE DETAILS
FL5		MODEL # C32XH, N32XH, KENTWOOD ENGINEERED WOOD FLOOR CORNERSTONE COLLECTION		714 635 4473 GREAT FLOORS	FOR PATTERN
FL6		BRUSHED OAK ARLINGTON INTERNATIONAL COATINGS ICO-GUARD 51 - DARK GREY		360 695 1231 INTERNATIONAL COATINGS	OR APPROVED SUBSTITUTION
FL7		INTERFACE CARPET TILE COMMON THEME IN STEEL		800 624 8919 INTERFACE 800 634 6032	ASHLAR PATTERN
FL8		MODEL # CT112 PENTAL SEASTONE PORCELAIN 2" SQUARE MOSAIC TILE	MATTE	PENTAL 206 768 3200	
FL9		IN BLACK MATTE ROPPE RUBBER STAIR TREAD #80 IN BURNT UMBER #194 W/ MATCHING RISER		ROPPE 800 537 9527	OR EQUAL
CL1		EXISTING CEILING TO REMAIN	FLAT PAINT COLOR PER RCP		
CL2		GWB CEILING	FLAT PAINT COLOR PER RCP		SEE RCP FOR ADDITIONAL INFO
CL3		ACT CEILING	FLAT PAINT COLOR PER RCP	EXISTING	RESUSE EXIST TILE BEAMS & T'S CUT TILE INTO 2X
CL4)		ACT CEILING W/ RUNNER & CROSS TEE COVE MOLDING MODEL # 412464, 412875	FLAT PAINT COLOR PER RCP	WOOD TRAC 855 854 7465	RESUSE EXIST TILE BEAMS & T'S CUT TILE INTO 2X
CL5)		DECORATIVE 2X2 TIN CEILING ACP IN ANTIQUE WHITE	FERROP	BUILD.COM 800 375 3403	COT TILE INTO 2X.
CL6)		MODEL # Y53-01 DECORATIVE WOOD CEILING	STAIN		SEE DETAILS
CL7		ARMSTRONG KITCHEN ZONE 2X2 CEILING TILE IN WHITE MODEL # 673		ARMSTRONG 877 276 7876	OR EQ WASHABLE SCRATCH-RESISTA NT TILE
P1		SHERMAN WILLIAMS BALANCED BEIGE #SW-7037	EGGSHELL		FLAT ON CEILINGS
P2		BENJAMIN MOORE CLASSIC COLORS TOWNSEND HARBOR BROWN #HC-64	EGGSHELL		FLAT ON CEILINGS
P3		BENJAMIN MOORE COLOR PREVIEW IRON MOUNTAIN #2134-30	SEMI GLOSS		FLAT ON CEILINGS
P4		SHERMAN WILLIAMS TRICORN BLACK #SW-6258	EGGSHELL, GLOSS		FLAT ON CEILINGS
P5		BENJAMIN MOORE COLOR STORIES DEEP SECRET #CSP-625	SEMI GLOSS		
P6		BENJAMIN MOORE COLOR STORIES AFTER MIDNIGHT #CSP-630	SEMI GLOSS		
P7		BENJAMIN MOORE COLOR STORIES SUBWAY TILE #CSP-585	SEMI GLOSS		FLAT ON CEILINGS
P8		C2 PAINTS TOADSTOOL #C2-435	SEMI GLOSS		
P9		BENJAMIN MOORE STUDIO FINISHES BRONZE METALLIC #BRONZE-30	METALLIC		
P10		BENJAMIN MOORE COLOR PREVIEW JET BLACK # 2120-10	GLOSS		
P11		SHERMAN WILLIAMS SUN DRIED TOMATO #SW-7585	GLOSS		
P12		C2 PAINTS COUSTEAU #C2-713	SEMI GLOSS		
P13		BENJAMIN MOORE COLOR STORIES PERSPECTIVE #CSP-5	SEMI GLOSS		
P14		BENJAMIN MOORE COLOR STORIES WINDY CITY #CSP-150	EGGSHELL		
P15		BENJAMIN MOORE COLOR PREVIEW SUPER WHITE # OC-152	SEMI GLOSS		
ST1		DALY'S WOOD STAIN ENGLISH OAK #64	GLOSS	MILLER PAINT 503 233 4491	PROVIDE SAMPLES ON EACH WOOD TYPE
ST2		SANSIN WOOD STAIN MIDNIGHT #3428	MATTE	MILLER PAINT 503 233 4491	PROVIDE SAMPLES ON EACH WOOD TYPE
ST3		DALY'S WOOD STAIN WALNUT #41	GLOSS	MILLER PAINT 503 233 4491	PROVIDE SAMPLES ON EACH WOOD TYPE
S1		EXISTING FIRE-TAPED GWB	NONE		
S2		FIRE-TAPED GWB	NONE		
S3		FRP WALL BOARD 3/32" X 48" X 120" WHITE SHEET MARLITE # P 100 WHITE A	WHITE		OR EQUAL
S4 S4		STAINLESS STEEL		BARGREEN 800 525 0131	

SYMBOL		DESCRIPTION	FINISH	CONTACT	NOTE
S5		AGED BRASS			PROVIDE SAMPLES
S6		TRI KIS LEGACY VELVET REGENT ROCK # UHN-LV-07		LANETTE ALLEN TRI KIS 206 261 7698	
S7		TRI KIS LEGACY VELVET REGENT ROCK # UHN-LV-07		LANETTE ALLEN TRI KIS 206 261 7698	
S8		TRI KIS CROWN JEWEL ESPRESSO # UHV-CJ-18		LANETTE ALLEN TRI KIS 206 261 7698	
S9		BOLTAFLEX CONTRACT UPHOLSTERY GRAND SIERRA VINYL IN CHARCOAL # 519000		KEYSTON BROTHERS 206 575 1113	
S10		FABRICOIL WOVEN WIRE MESH 1/4" WEAVE IN SATIN BRONZE		CASCADE COIL DRAPERY 800 999 2645	OR EQUAL
S11)		MERINDA SNAKE PARTY WALLPAPER IN WHITE ON CHARCOAL		2MODERN.COM 888 222 4410	
S12		YORK BIANCA WALLPAPER # TD4719		WALLPAPER WAREHOUSE.COM 866 814 9672	
S13		LAMINAM FLIO PORCELAIN PANEL IN ORO # L2093		UNITED TILE 425 251 5290	
S14		PERFORATED BRONZE INFILL PANEL W/ CLASSIC HOLE PATTERN # CA823		RUDD 513 978 0764	OR EQUAL
S15		CHEMETAL 700 SERIES LAMINATE OILED BRONZE ALUMINUM # 721		CHEMETAL 503 253 2424	
S16		NABI VALOR DEEP EMERALD GLAZED CERAMIC MOSAIC TILE	SEALED	TILEBAR.COM 888 541 3840	DELOREAN GRAY EPOXY GROUT BY CUSTOM
S17		WILSONART LAMINATE ASIAN NIGHT #7949K-18	LINEARITY WITH AEON		
GL1)		EXISTING STOREFRONT GLAZING			
GL2	/// ///	CLEAR GLASS		TBD	USE TEMPERED WHERE REQ'D
GL3		FROSTED GLASS		TBD	USE TEMPERED WHERE REQ'D
GL4		MIRROR		TBD	
GL5	111 111	SPANCRAFT ANTIQUE MIRROR #55-ROYALE		SPANCRAFT 516 295 0055	
GL6		REEDED GLASS		GGI 800 431 2042	OR EQUAL TEMPERED

BREAK ROOM KITCHEN SCHEDULE

MANUFACTURERS: NOTE: CONTRACTOR TO INSTALL ALL EQUIPMENT, IKEA (UON) CABINETS AND ACCESSORIES UON						
PART#	MODEL	DESCRIPTION	COLOR	DIMENSIONS	QUANTITY	NOTES
90265388	SEKTION	BASE CABINET FRAME	WHITE	24"W x 24"D x 30"H	2	COVER PANEL ON LEFT
30265471	SEKTION	WALL CABINET FRAME	WHITE	36"W x 14-3/4"D x 20"H	2	COVER PANEL ON LEFT
10265453	SEKTION	WALL CABINET FRAME	WHITE	30"W x 14-3/4"D x 20"H	1	ABOVE FRIDGE, COVER PANEL ON RIGHT
60261527	SEKTION	SUSPENSION RAIL	GALVANIZED	84"L	2	
10265518	SEKTION	LEG	BLACK	4-1/2" (4PC/PKG)	2	
30355971	LERHYTTAN	TOEKICK	BLACK STAINED	84"L x 4-1/2"	3	
20266857	TINGSRYD	COVER PANEL	WOOD EFFECT BLACK	25"W x 36"H x 1/2"	1	BOTTOM LEFT
90266830	TINGSRYD	COVER PANEL	WOOD EFFECT BLACK	15"W x 32-1/2"H x 1/2"	2	TOP, CUT TO 20"T AND EDGE BAND CUT EDGE
60274983	SÄLJAN	COUNTERTOP	BLACK MINERAL EFFECT	74"W x 25-5/8"D X 1-1/2"	1	
30266866	TINGSRYD	DOOR	WOOD EFFECT BLACK	24"W x 30"H	2	LOWER
40266861	TINGSRYD	DOOR	WOOD EFFECT BLACK	18"W x 20"H	4	UPPER
20266838	TINGSRYD	DOOR	WOOD EFFECT BLACK	15"W x 20"H	2	UPPER ABOVE FRIDGE
265533	UTRUSTA	SHELF	WHITE	24"W x 24"D	1	
60204645	UTRUSTA	HINGE	SILVER	2PC/PKG	8	
60138759	LANSA	HANDLE	STAINESS STEEL	9-5/8" (2PC/PKG)	4	VERTICAL MOUNT
60324884	VATTUDALEN	SINGLE BOWL TOP MOUNT SINK	STAINESS STEEL	27-1/8"W x 18-1/2"D x 7-1/8"H	1	
50325426	LILLVIKEN	SINK STRAINER WITH STOPPER	STAINESS STEEL		1	
20317852	LILLVIKEN	LID	SILVER		1	
284579	SEKTION	REINFORCED VENTILATED TOP RAIL	GALVANIZED	24"L	1	
70085029	LAGAN	SINGLE LEVER KITCHEN FAUCET	CHROME PLATED		1	
04375085	FIXA	DIFFUSION BARRIER	CHROME PLATED	31-1/2"L x 3-1/8"	1	

PLUMBING SCHEDULE

	NOTE: 1. CONTRACTOR	TO PROVIDE ALL MATERIALS, FIXTURES AND EQUIPMEN	IT UON.				
MARK	TYPE	MODEL / DESCRIPTION	WIDTH	DEPTH	HEIGHT	QTY	CONTACT
PL1A	EMPLOYEE WC TOILET	EXISTING	27 1/2"	14 7/8"	27 7/8"	1	EXISTING - RELOCATED
PL1B	TOILET	FLUSHOMETER WALL MOUNT TOILET	27 1/2"	14 7/8"	27 7/8"	6	MALO SUA FERGUSON 206 767 7700
PL2	WASH FOUNTAIN	ACORN ENGINEERING WASH-WARE 4'6" DIAMETER 8 STATION ADA STAINLESS WASH FOUNTAIN MODEL # 3509ADA	54"	54"	44"	1	MALO SUA FERGUSON 206 767 7700
PL3	URINAL	FLUSHOMETER WALL MOUNT URINAL	12"	18"	24"	4	MALO SUA FERGUSON 206 767 7700
PL4	EMPLOYEE WC SINK	EXISTING				1	EXISTING - RELOCATED
PL5	EMPLOYEE WC FAUCET	EXISTING				1	EXISTING - RELOCATED
PL6	MOP SINK & FAUCET	EXISTING	1' 9 1/2"	1' 11 1/8"		1	EXISTING - RELOCATED
PL7	BREAK ROOM SINK	IKEA LATTUDALEN STAINLESS STEEL SINGLE BOWL TOP MOUNT SINK	18 1/2"	27 1/8"	7 1/8"	1	IKEA - FOIC
PL8	BREAK ROOM FAUCET	IKEA LAGAN CHROME SINGLE LEVER KITCHEN FAUCET				1	IKEA - FOIC
PL9	WATER HEATER	SEE KITCHEN EQUIPMENT SCHEDULE				1	BARGREEN ELLINGSON

EQUIPMENT SCHEDULE

	NOTE: 1. CONTRACTOR TO INSTALL ALL MATERIALS, FIXTURES AND EQUIPMENT UON. 2. SEE KITCHEN DRAWINGS FOR KITCHEN EQUIPMENT SCHEDULE						
MARK	TYPE	MODEL / DESCRIPTION	WIDTH	DEPTH	HEIGHT	QTY	CONTACT
E1	MICROWAVE	MAGIC CHEF MODEL # HMM990ST				1	FOIO
E2	REFRIGERATOR/ FREEZER	FROSTIG MODEL # 00377936	29 3/4"	30 5/8"	65 7/8"	1	IKEA - FOIC
(E3)	SERVER RACK	RACK SOLUTIONS LOCKING SERVER CABINET MODEL # RACK-151-42U	23 1/2"	39"	82"	1	FOIC

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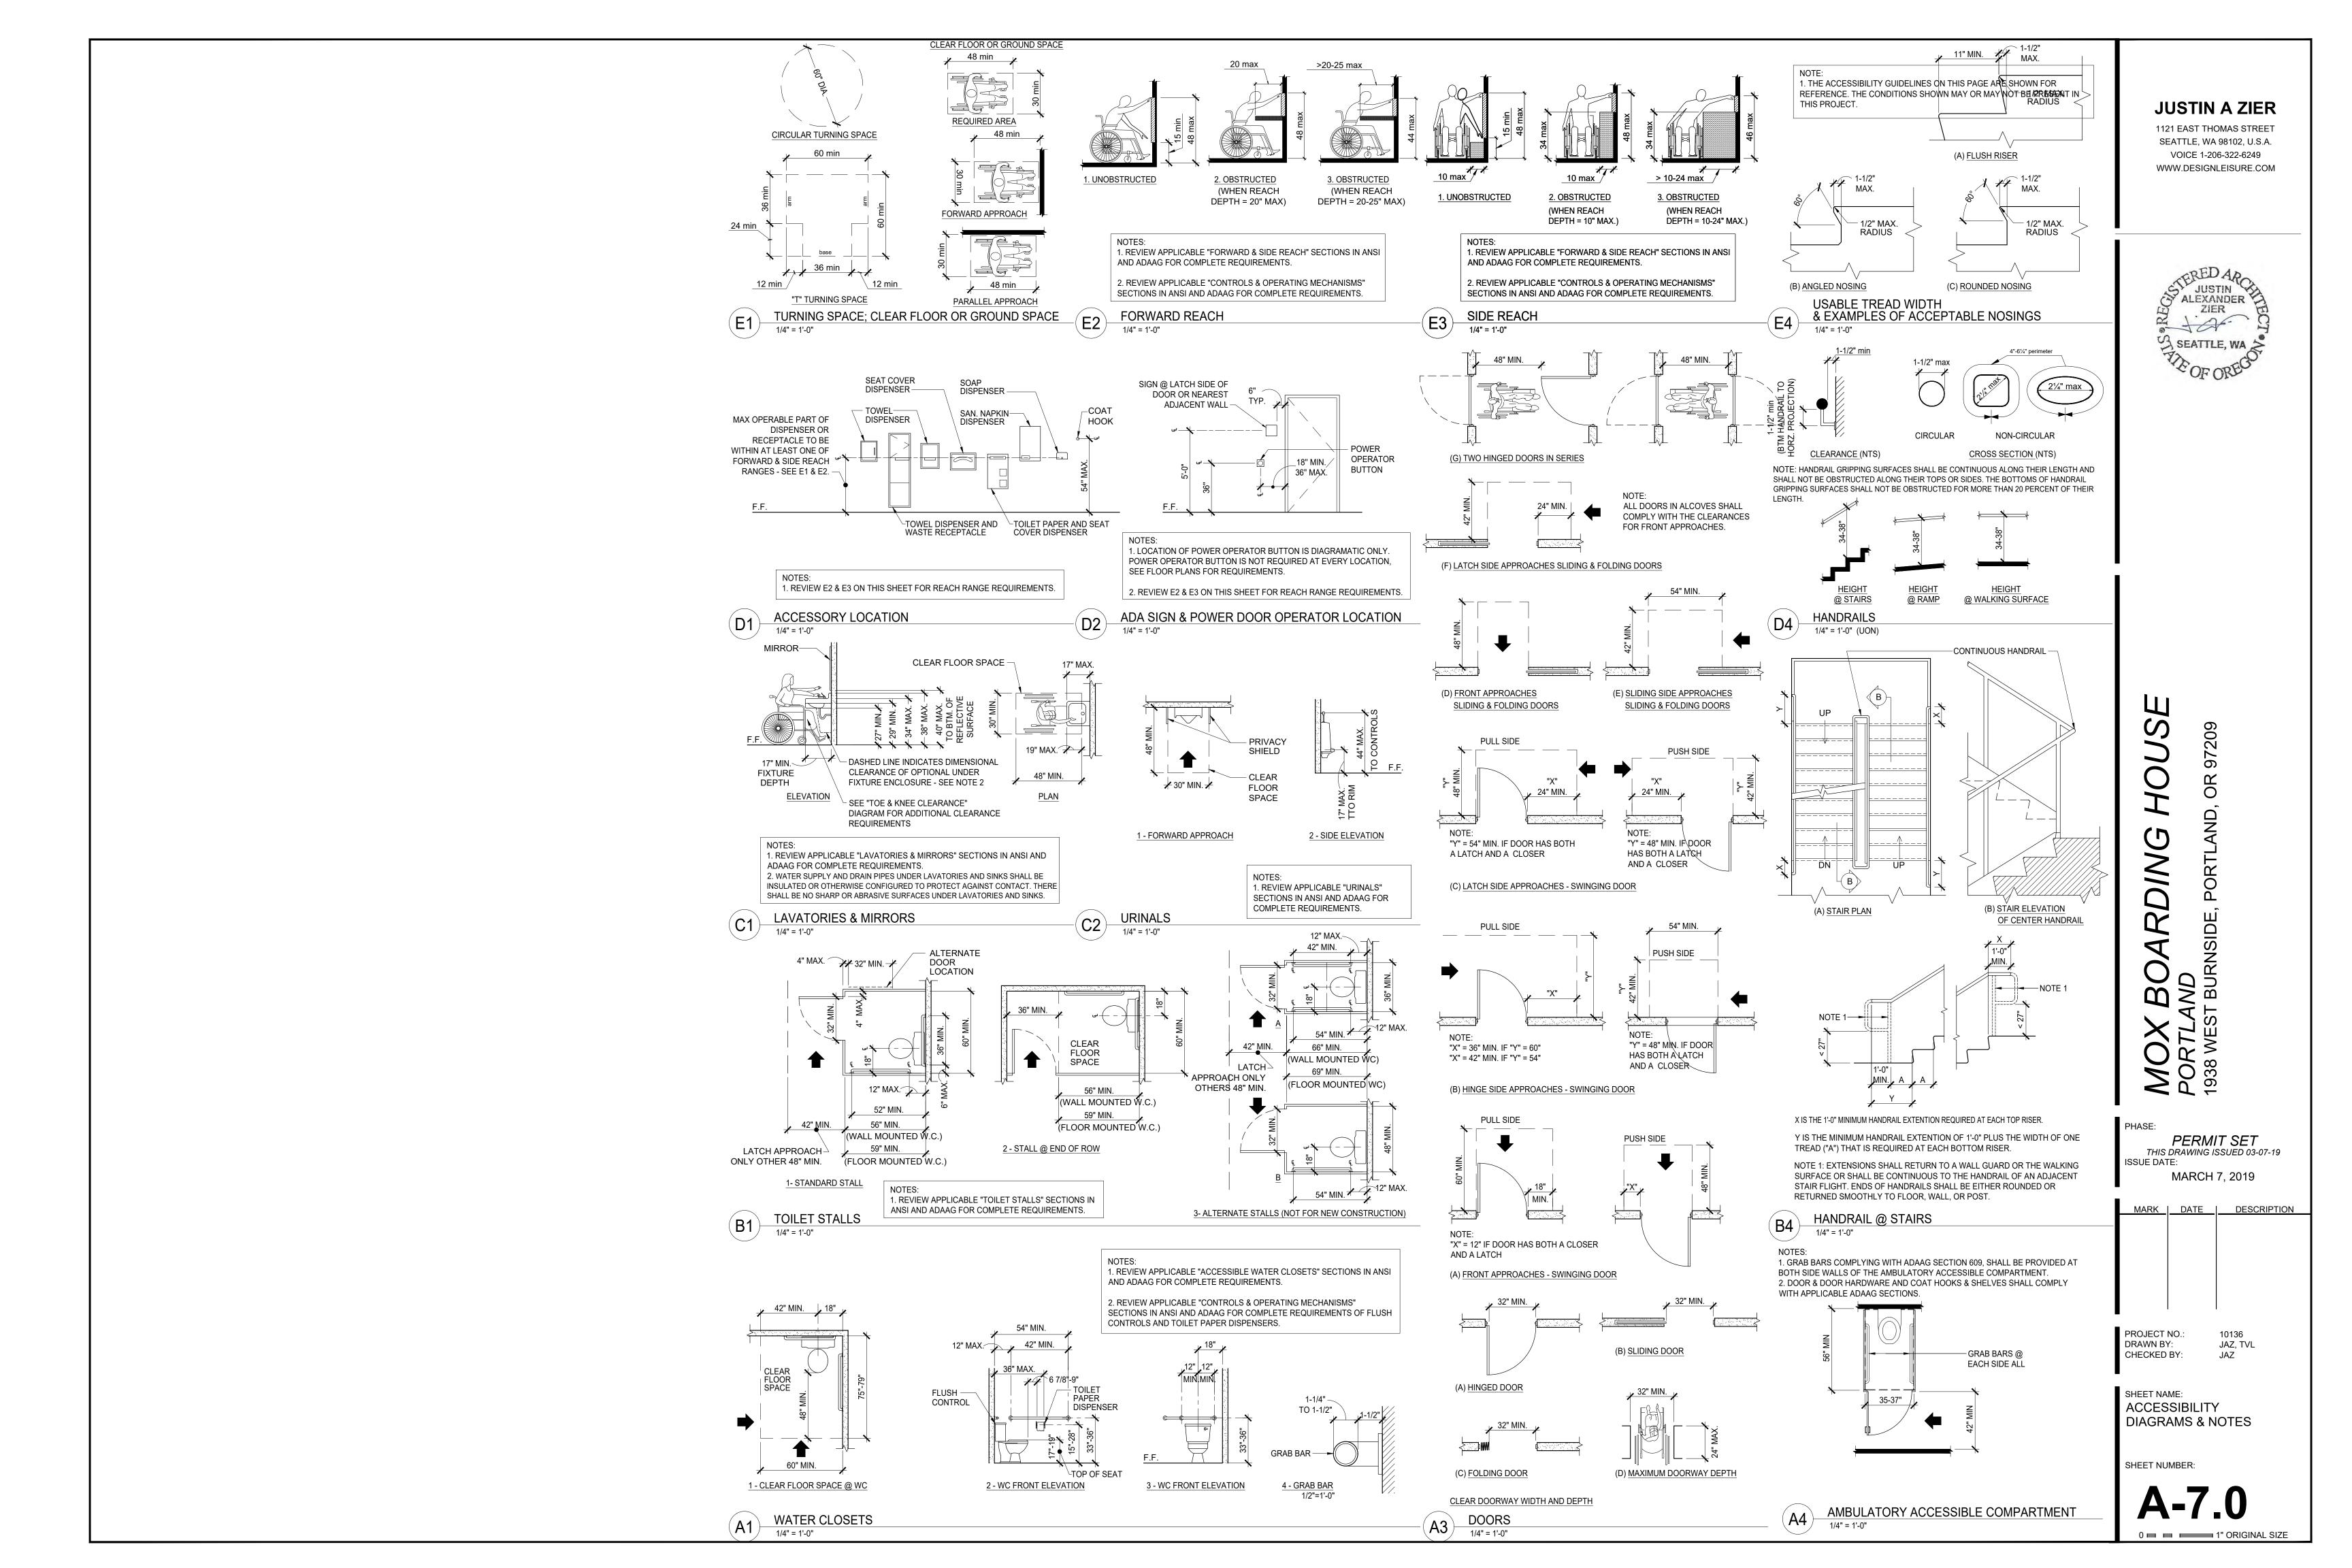



MOX BOARDING HOUS PORTLAND 1938 WEST BURNSIDE, PORTLAND, OR 97209


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MARK	DATE	DESCRIPTION
PROJECT DRAWN BY	/ :	10136 JAZ, TVL


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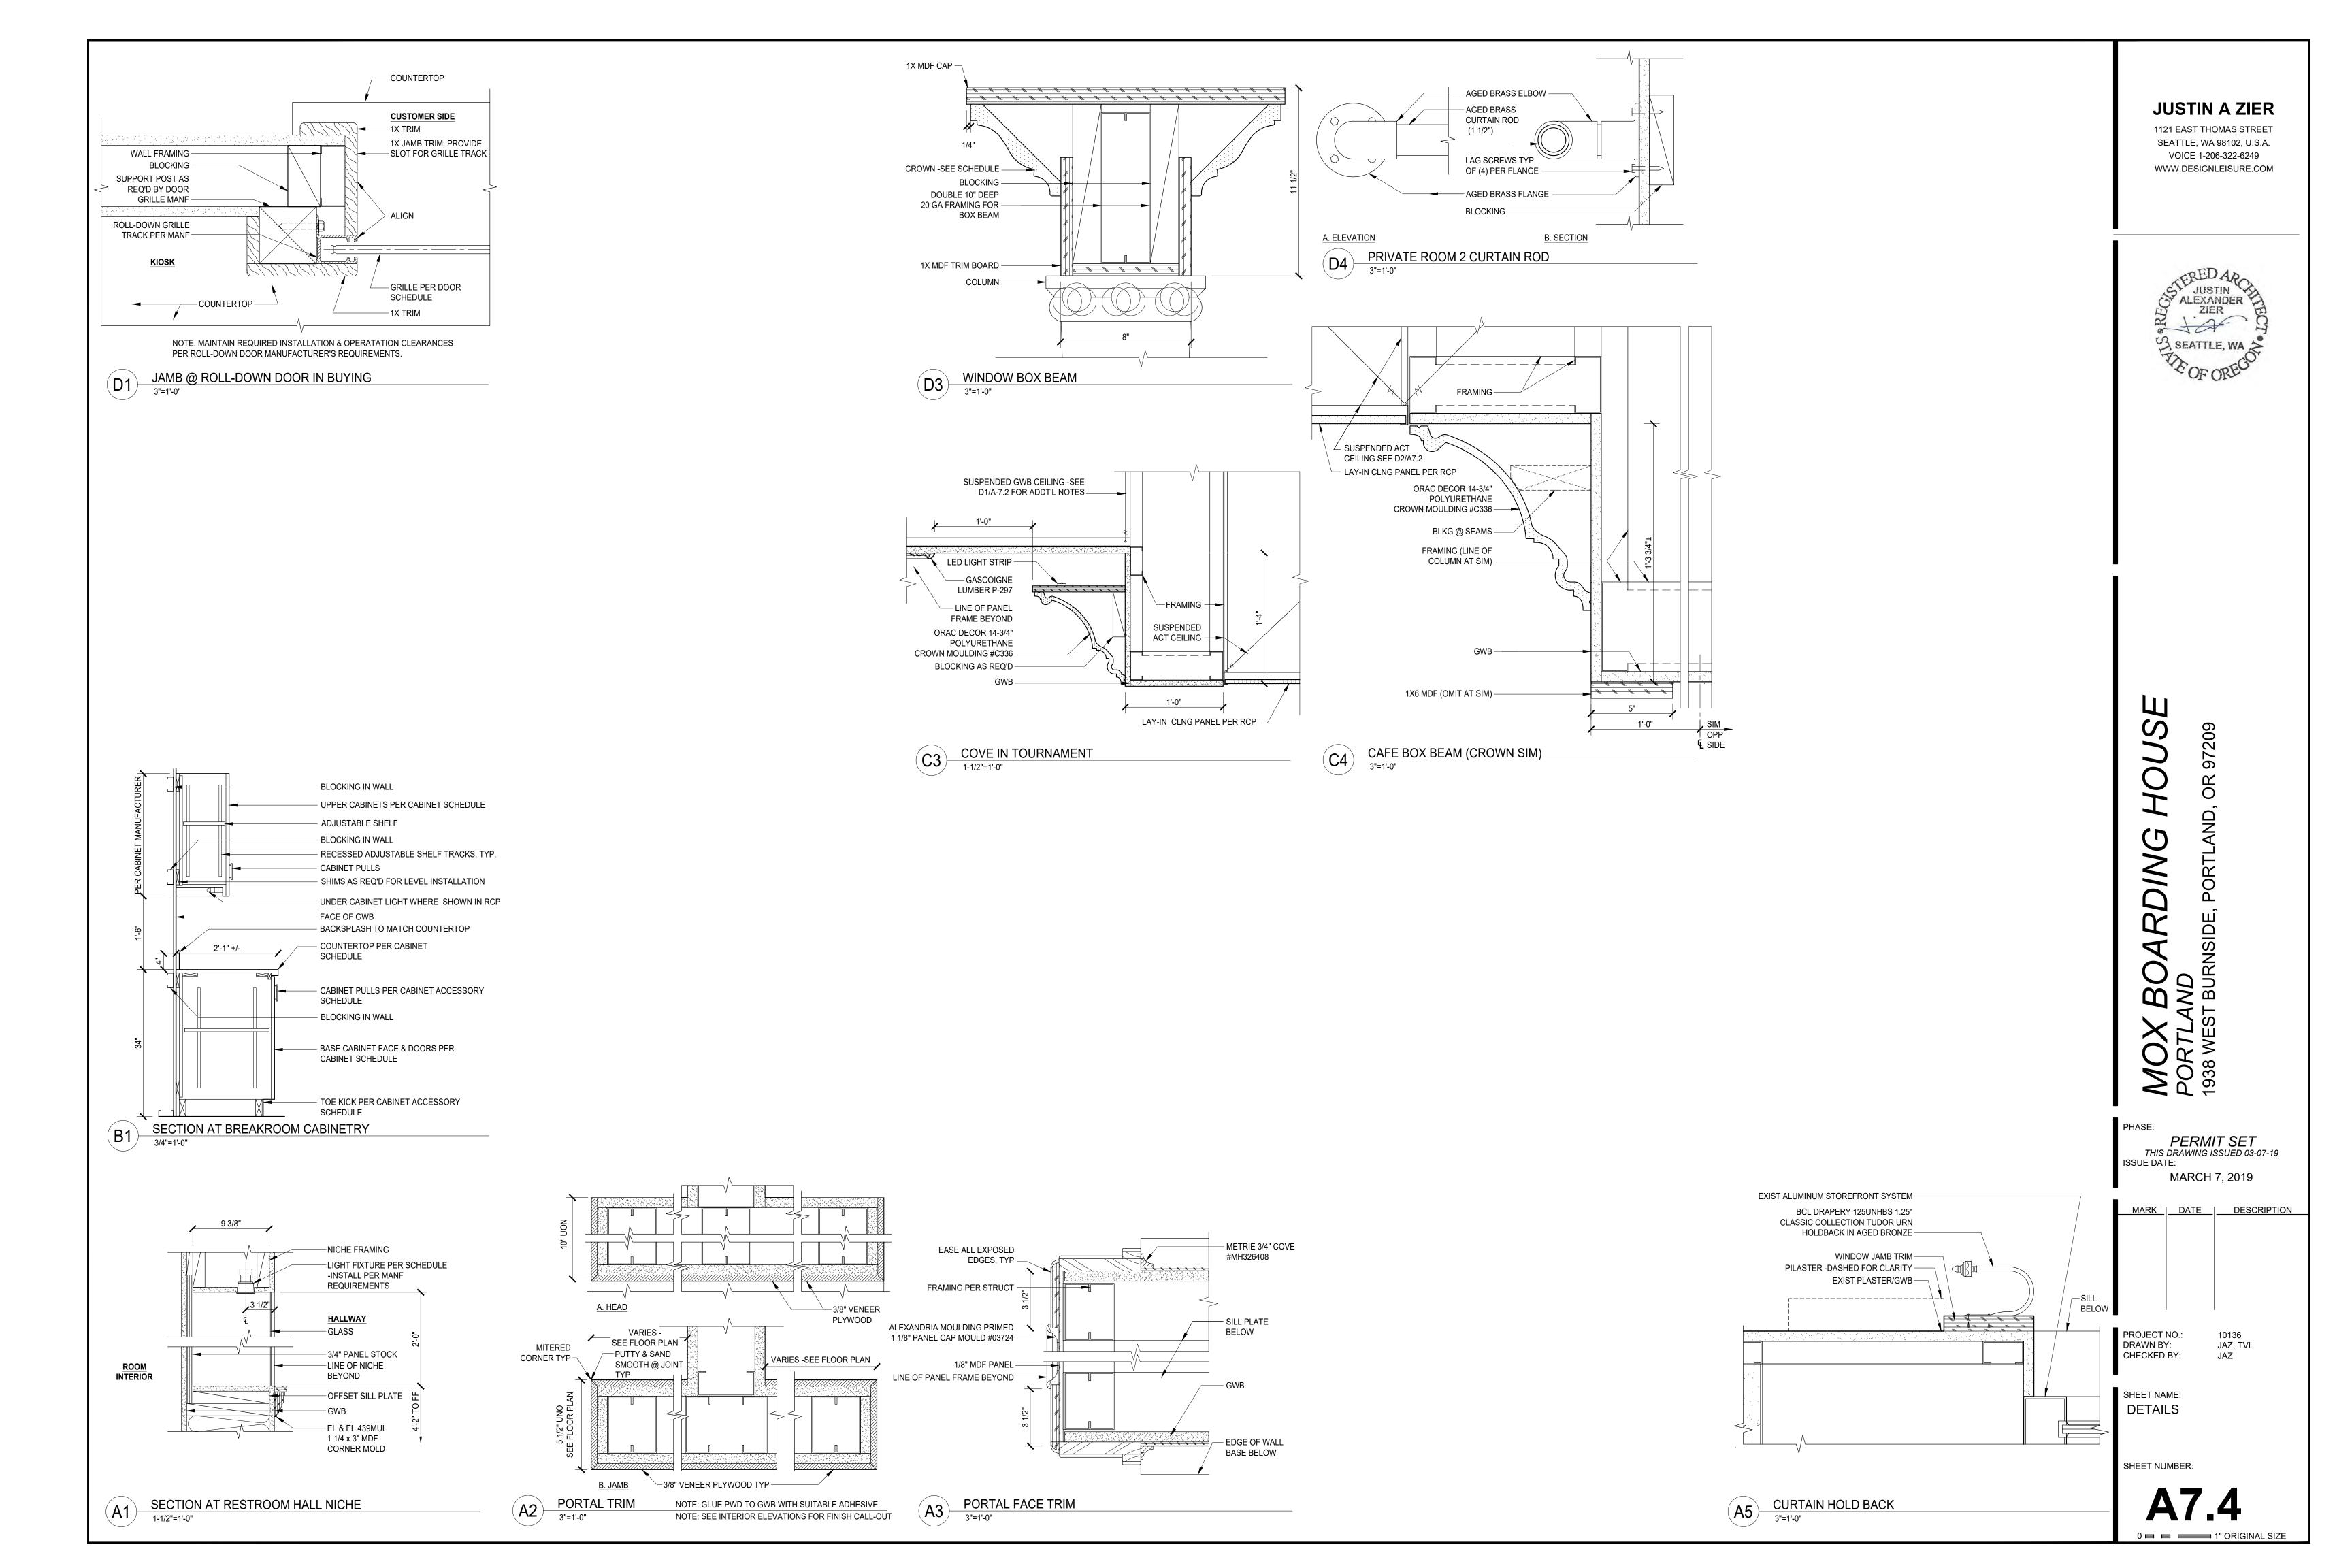
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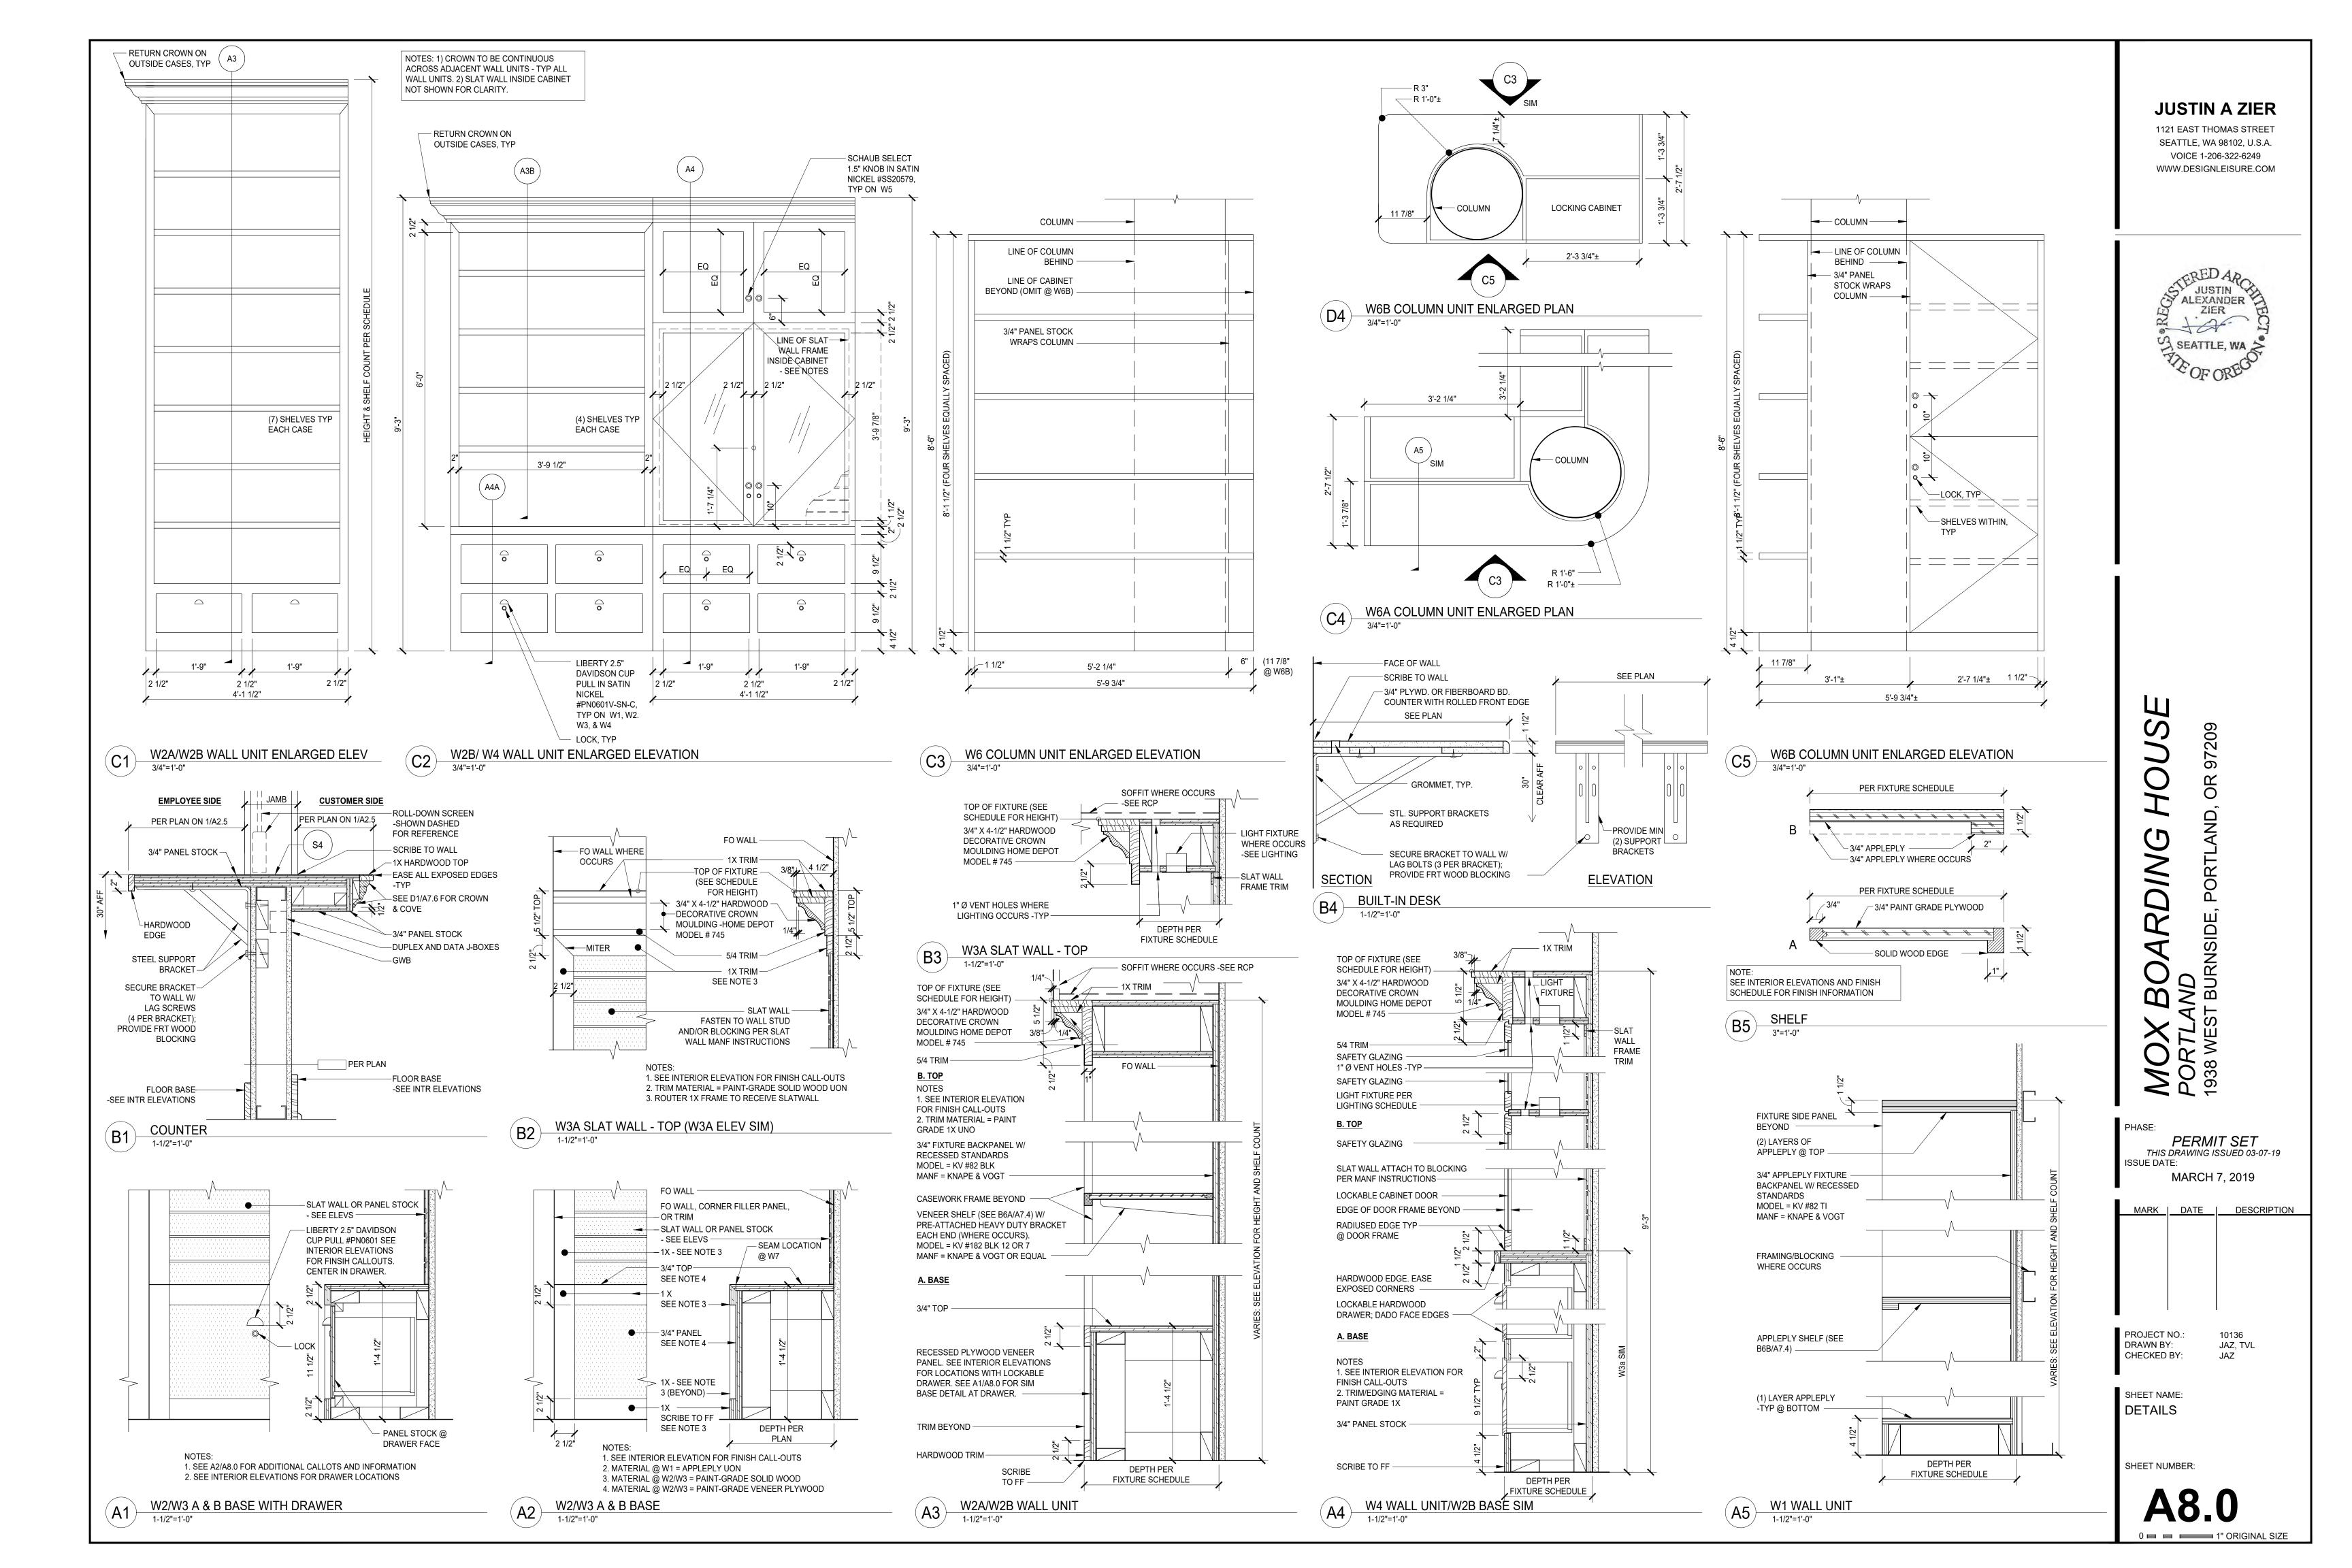








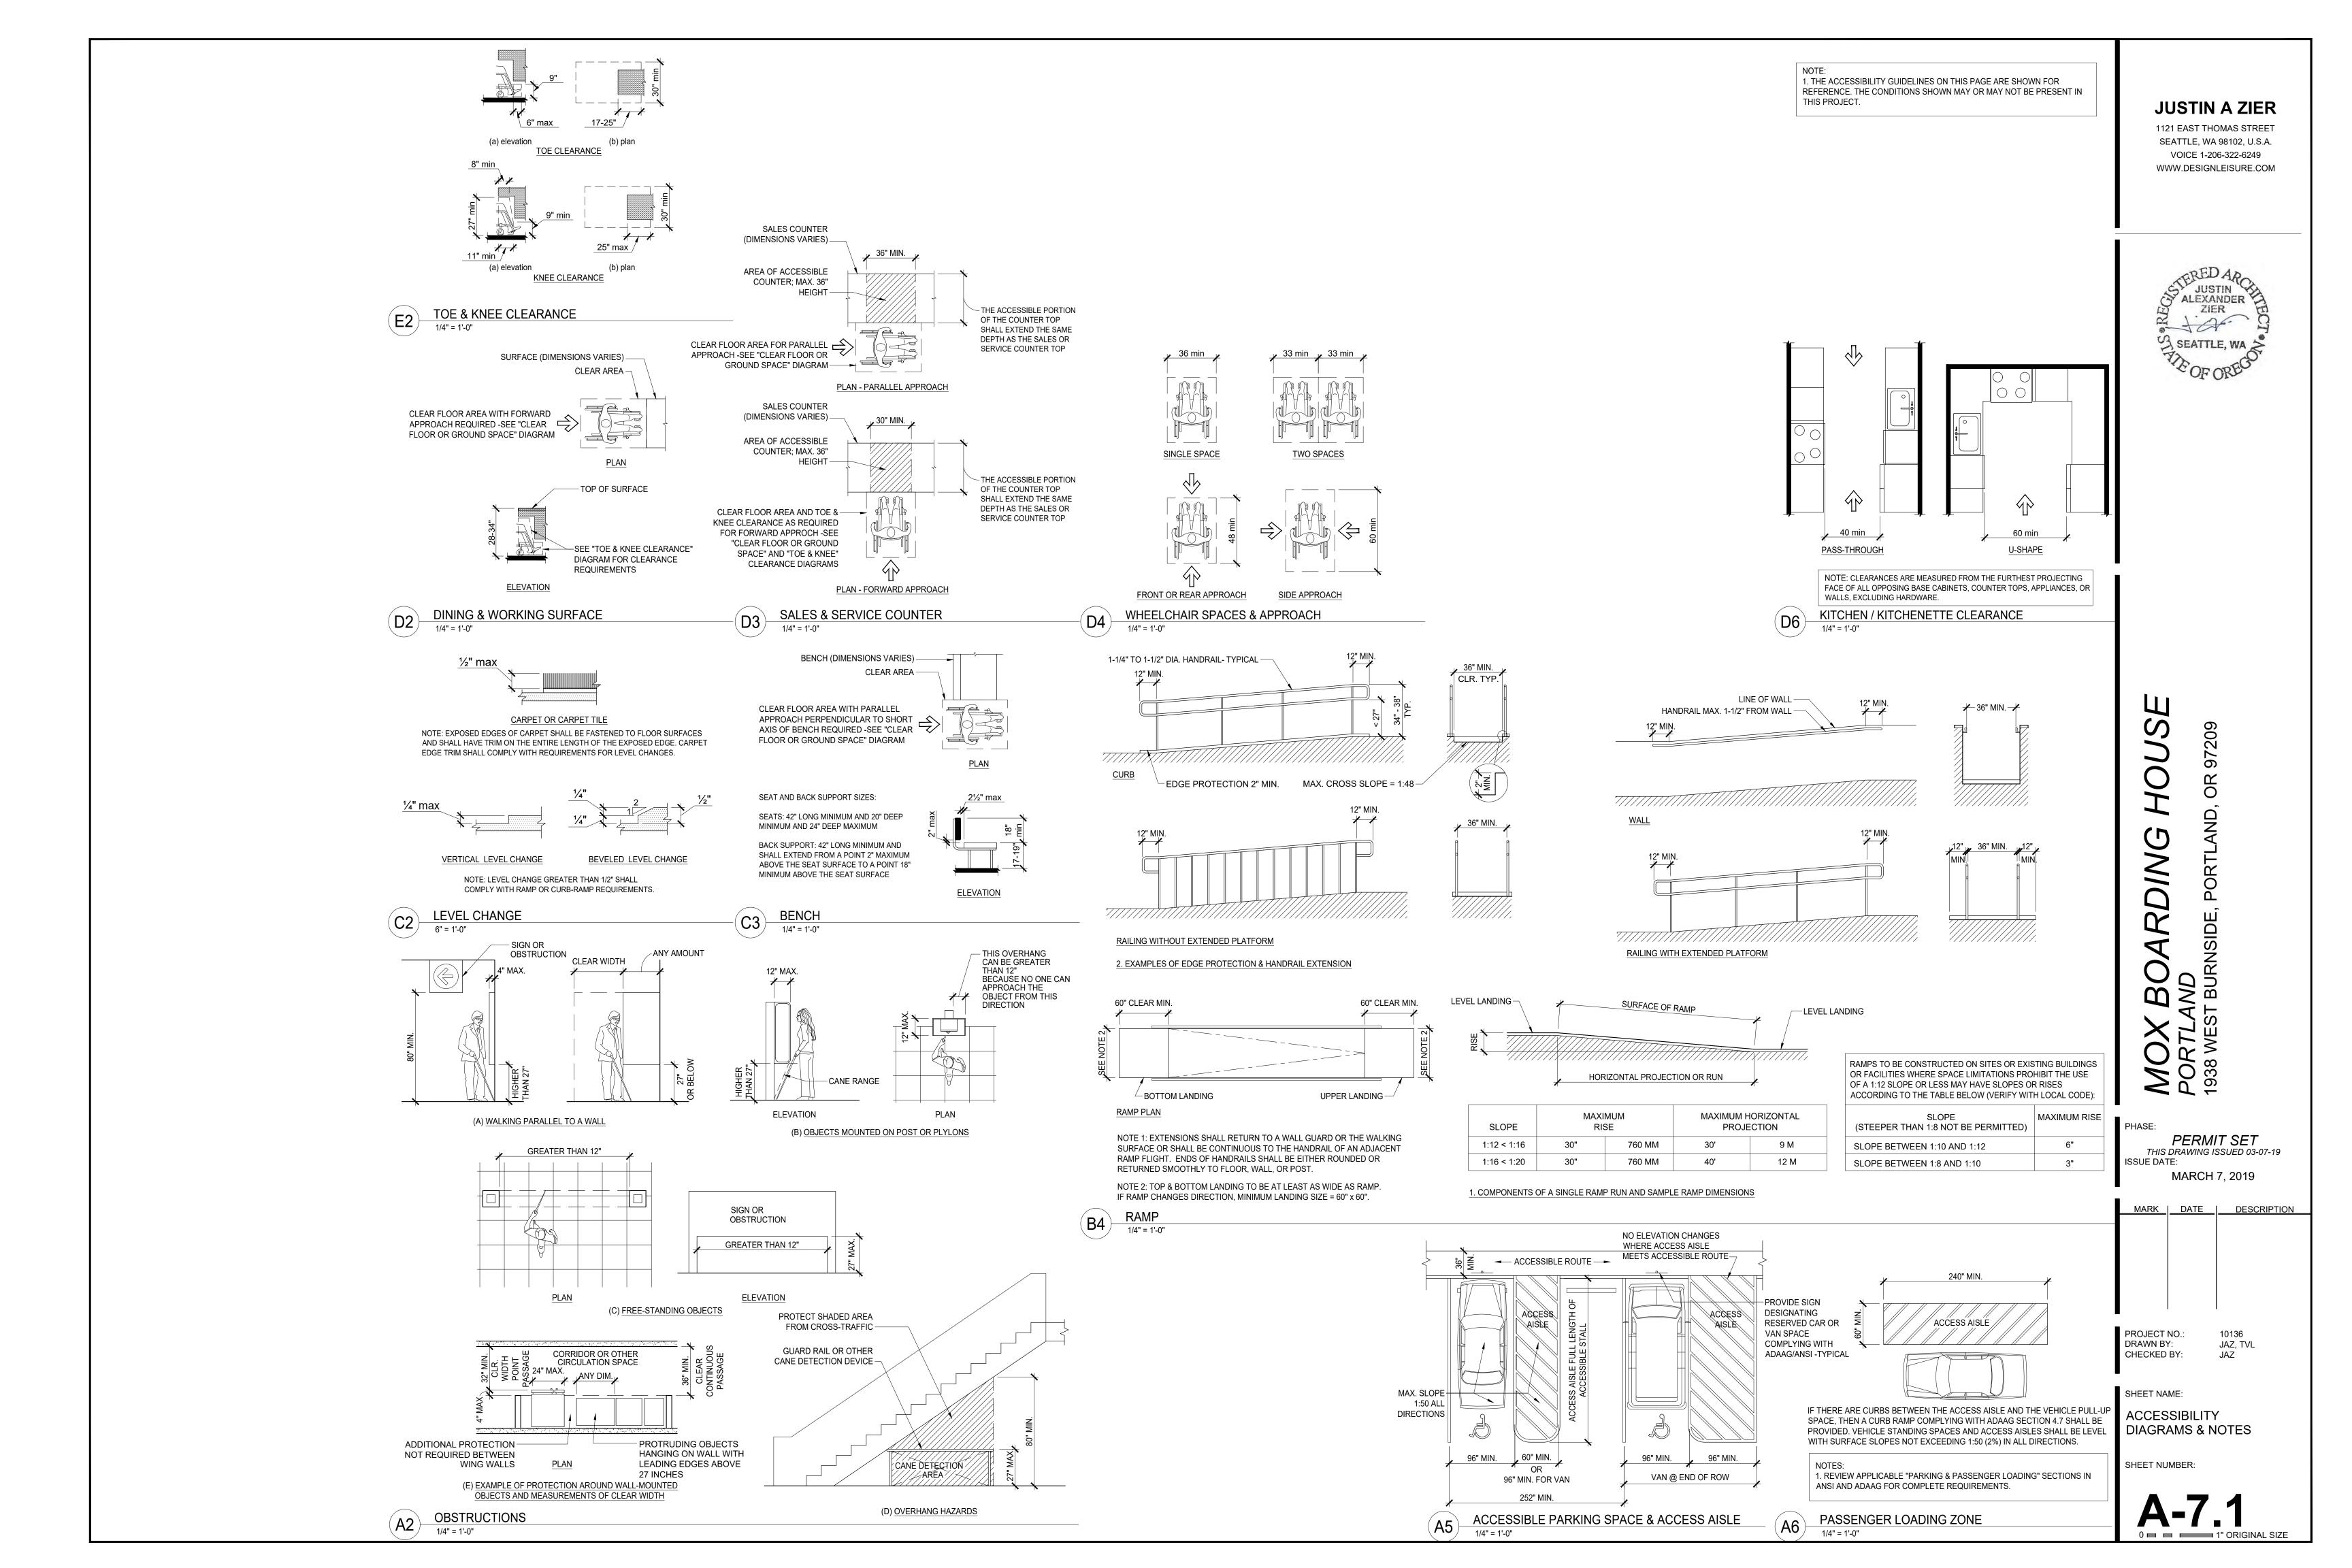

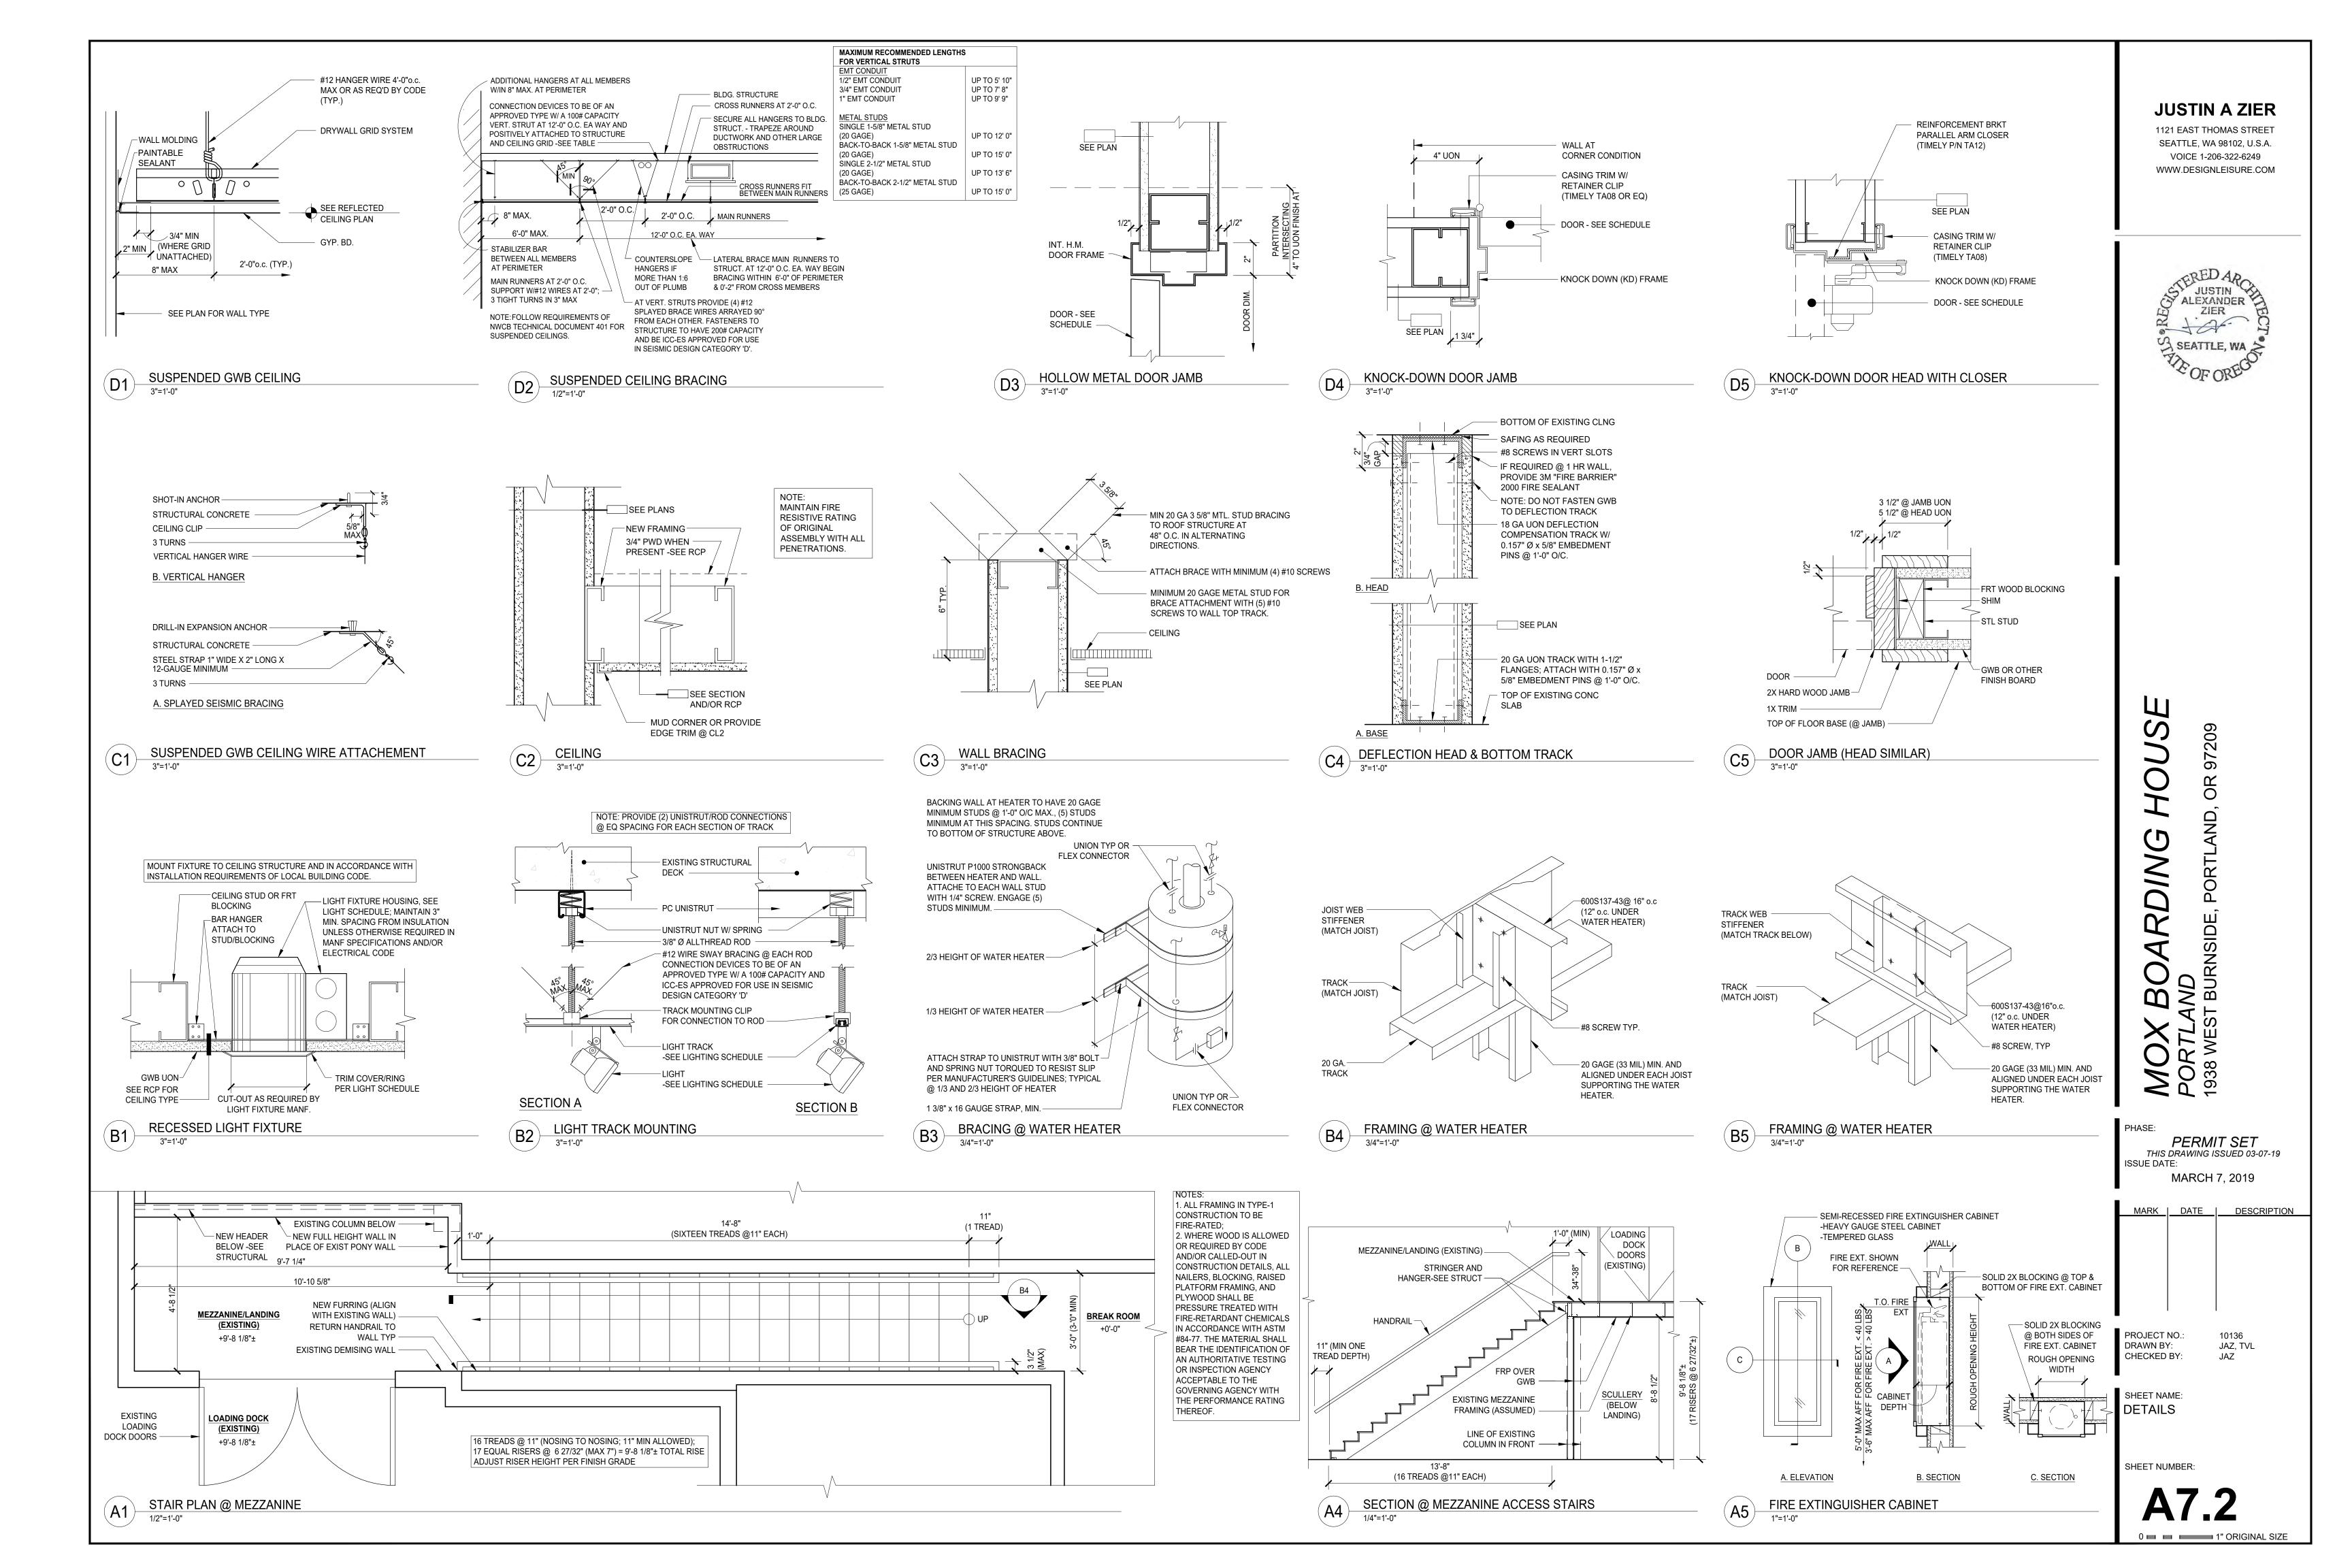

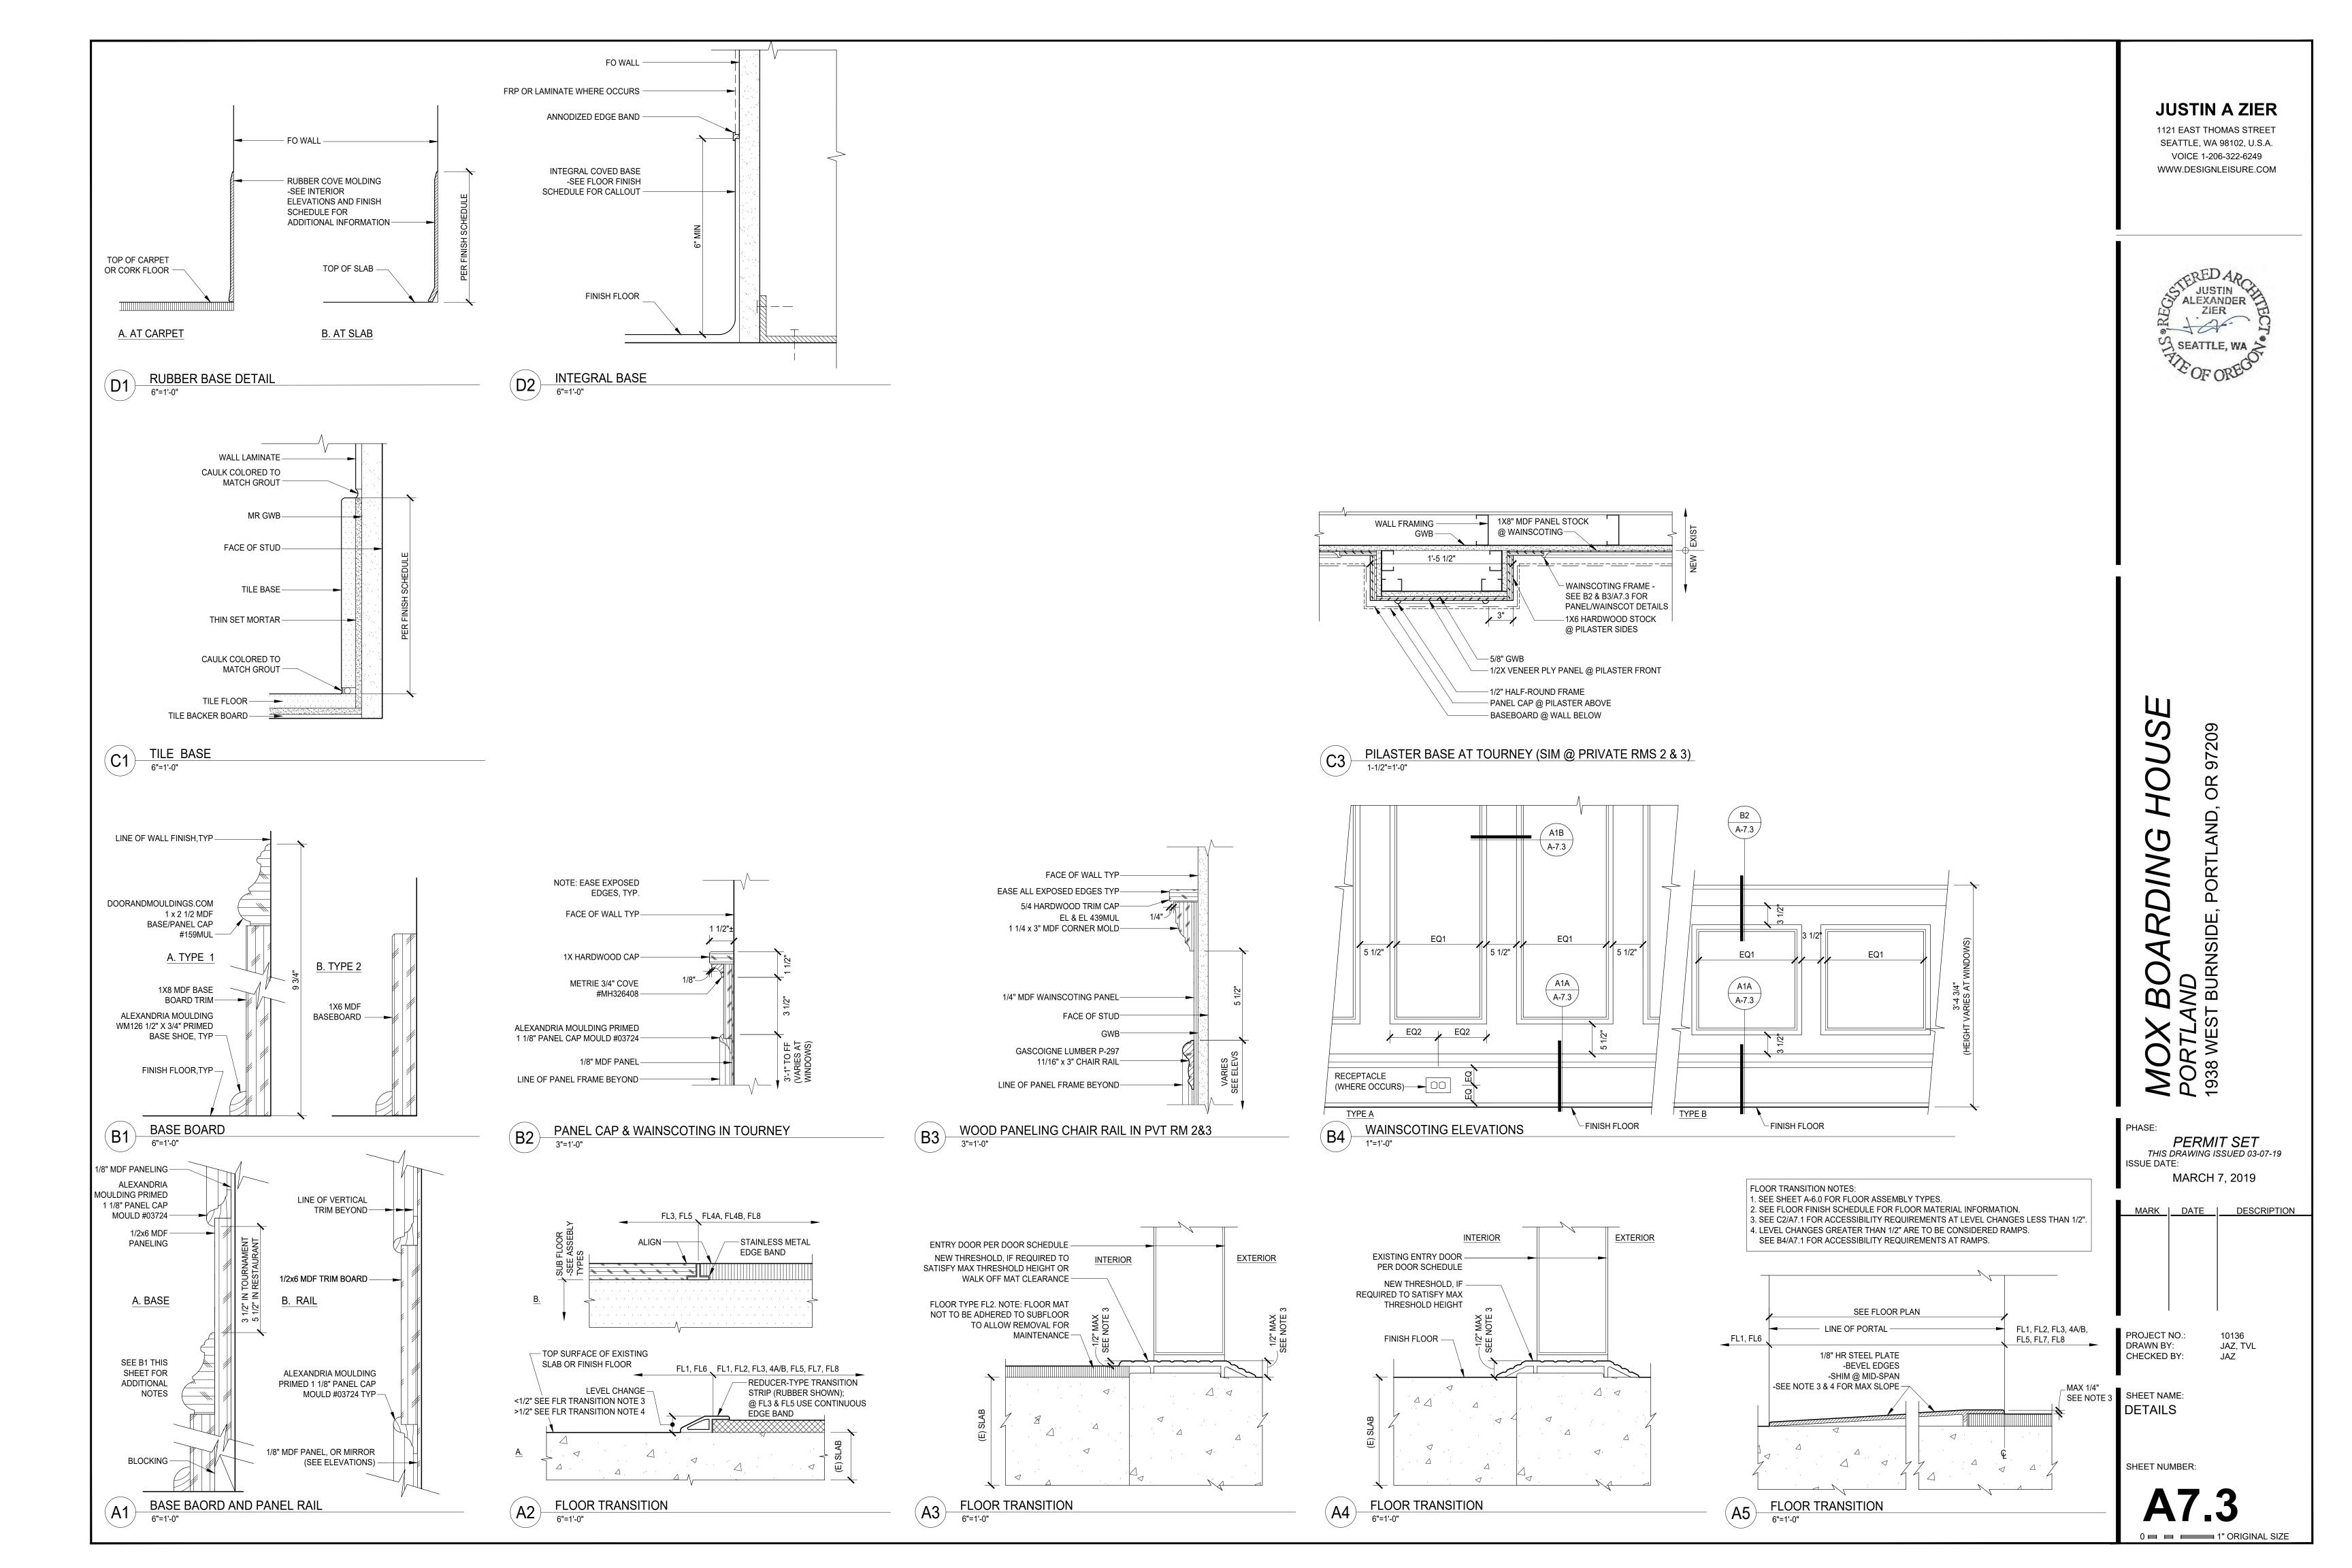

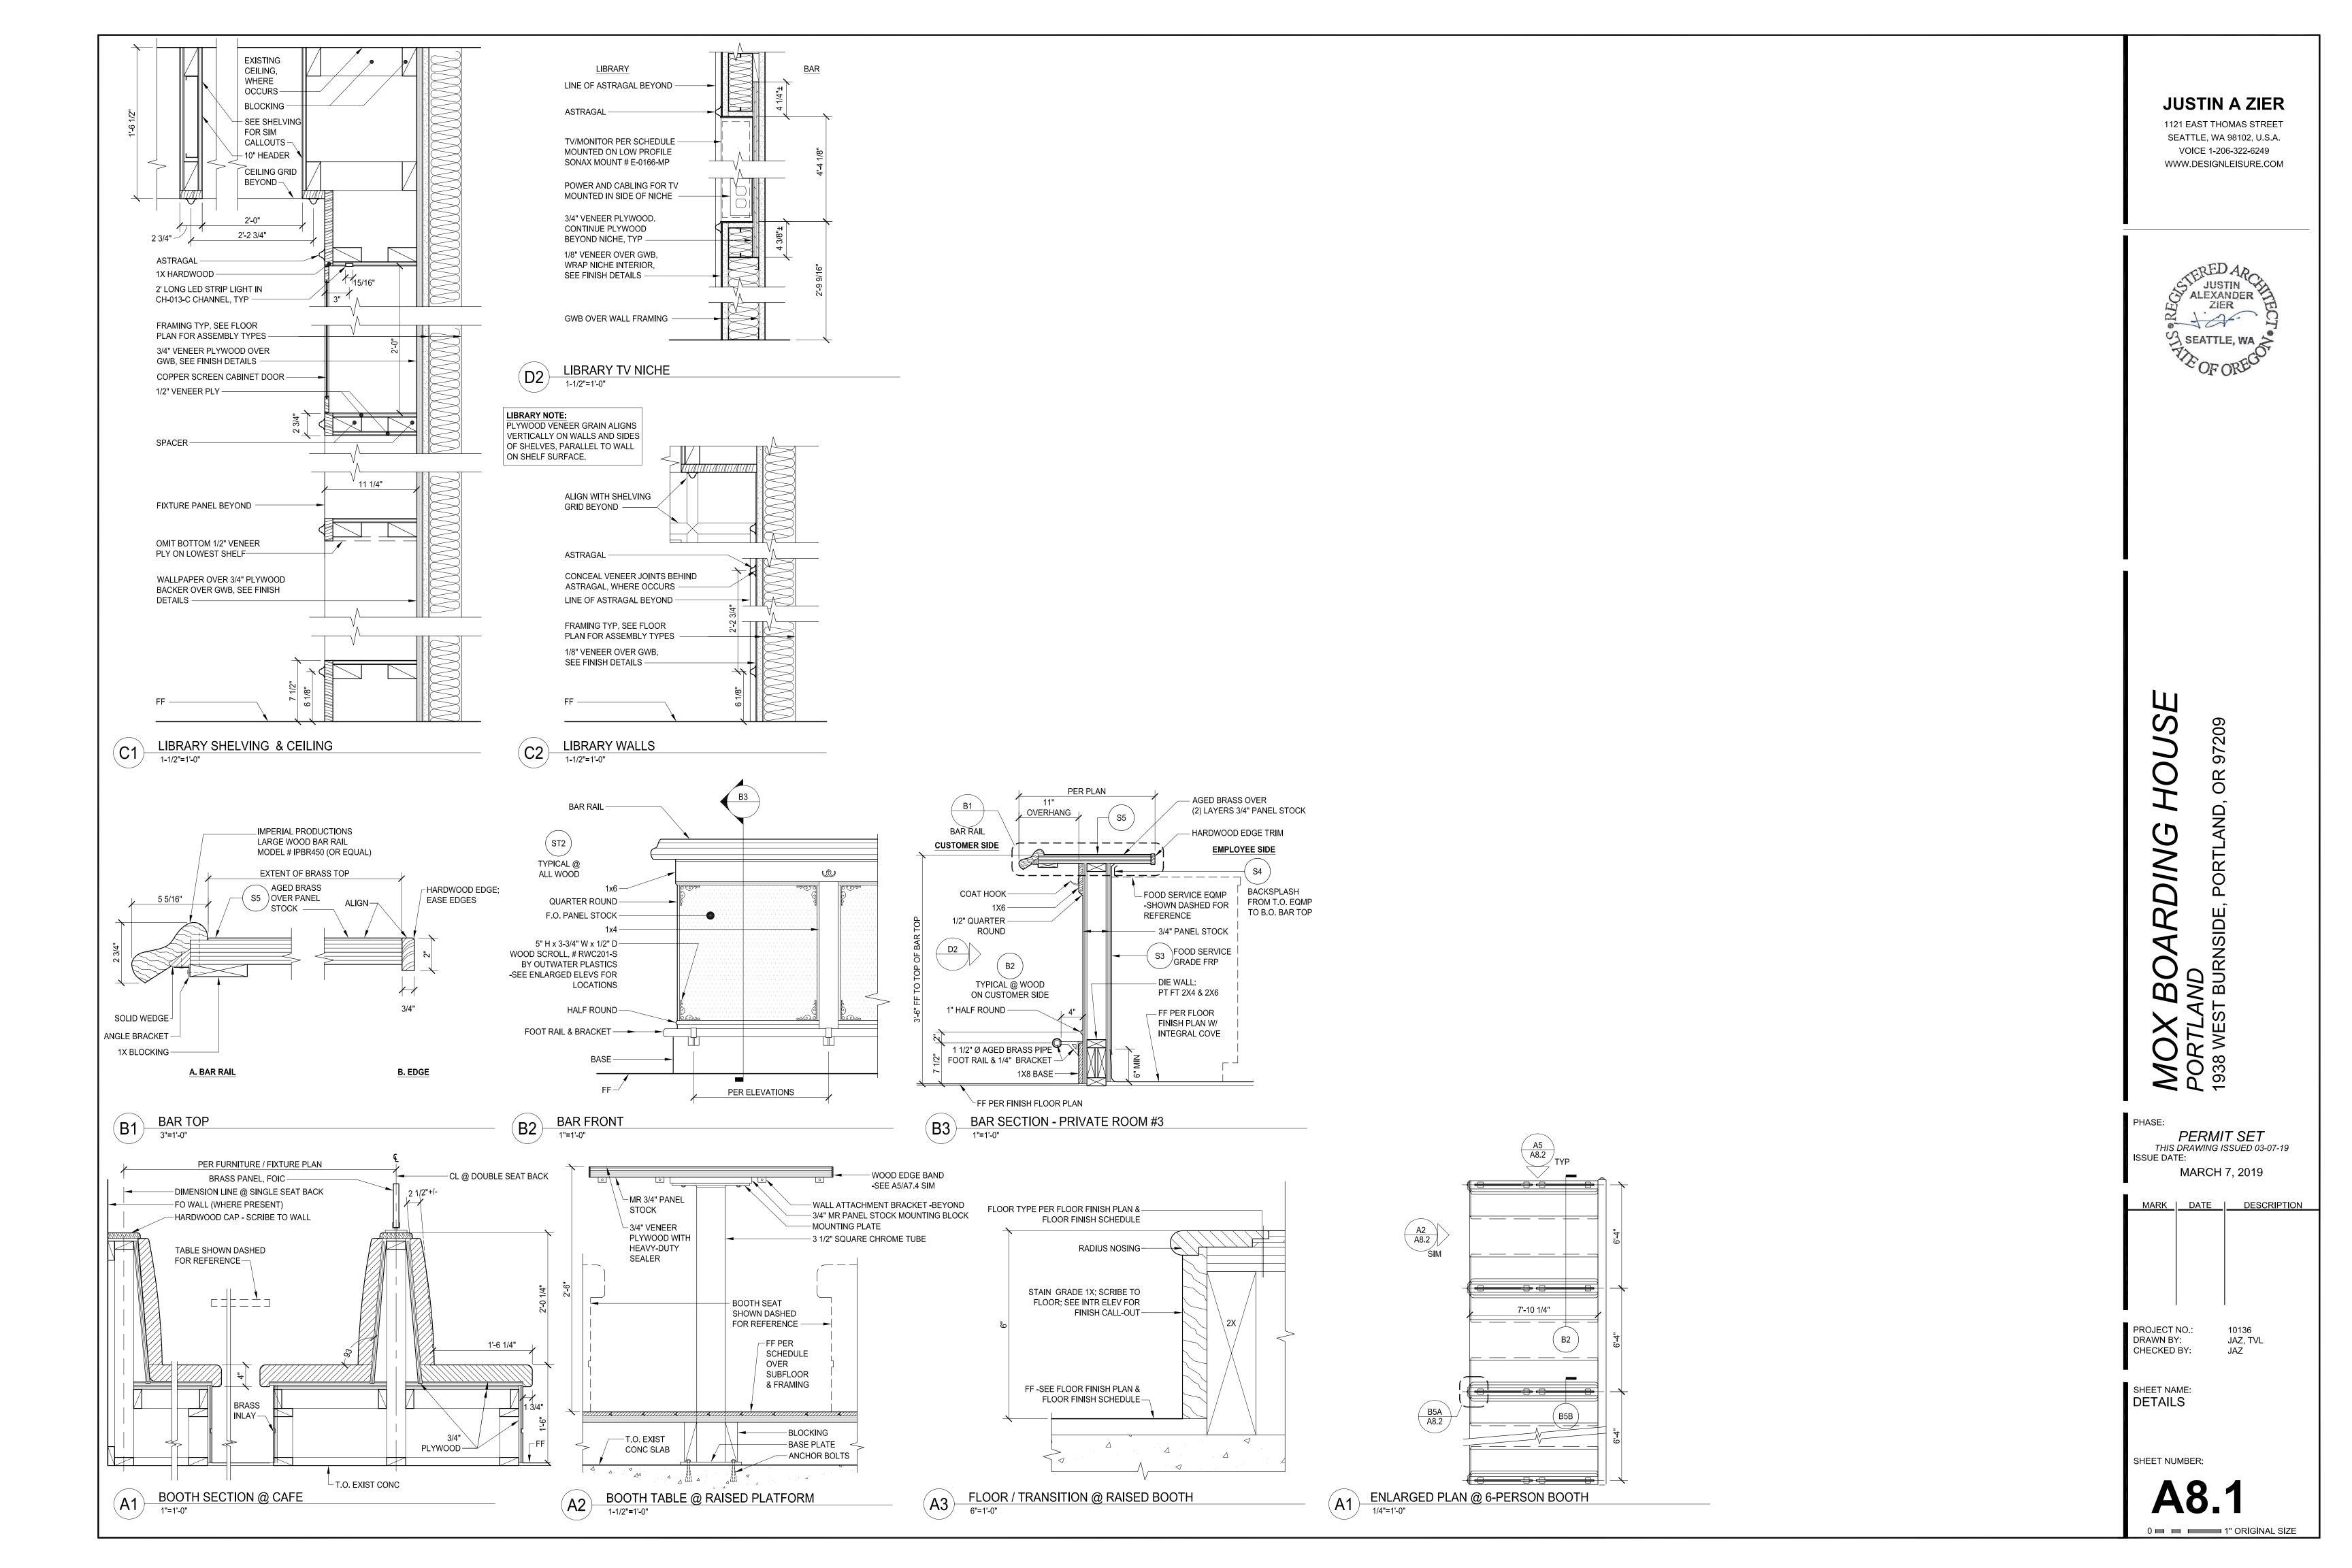

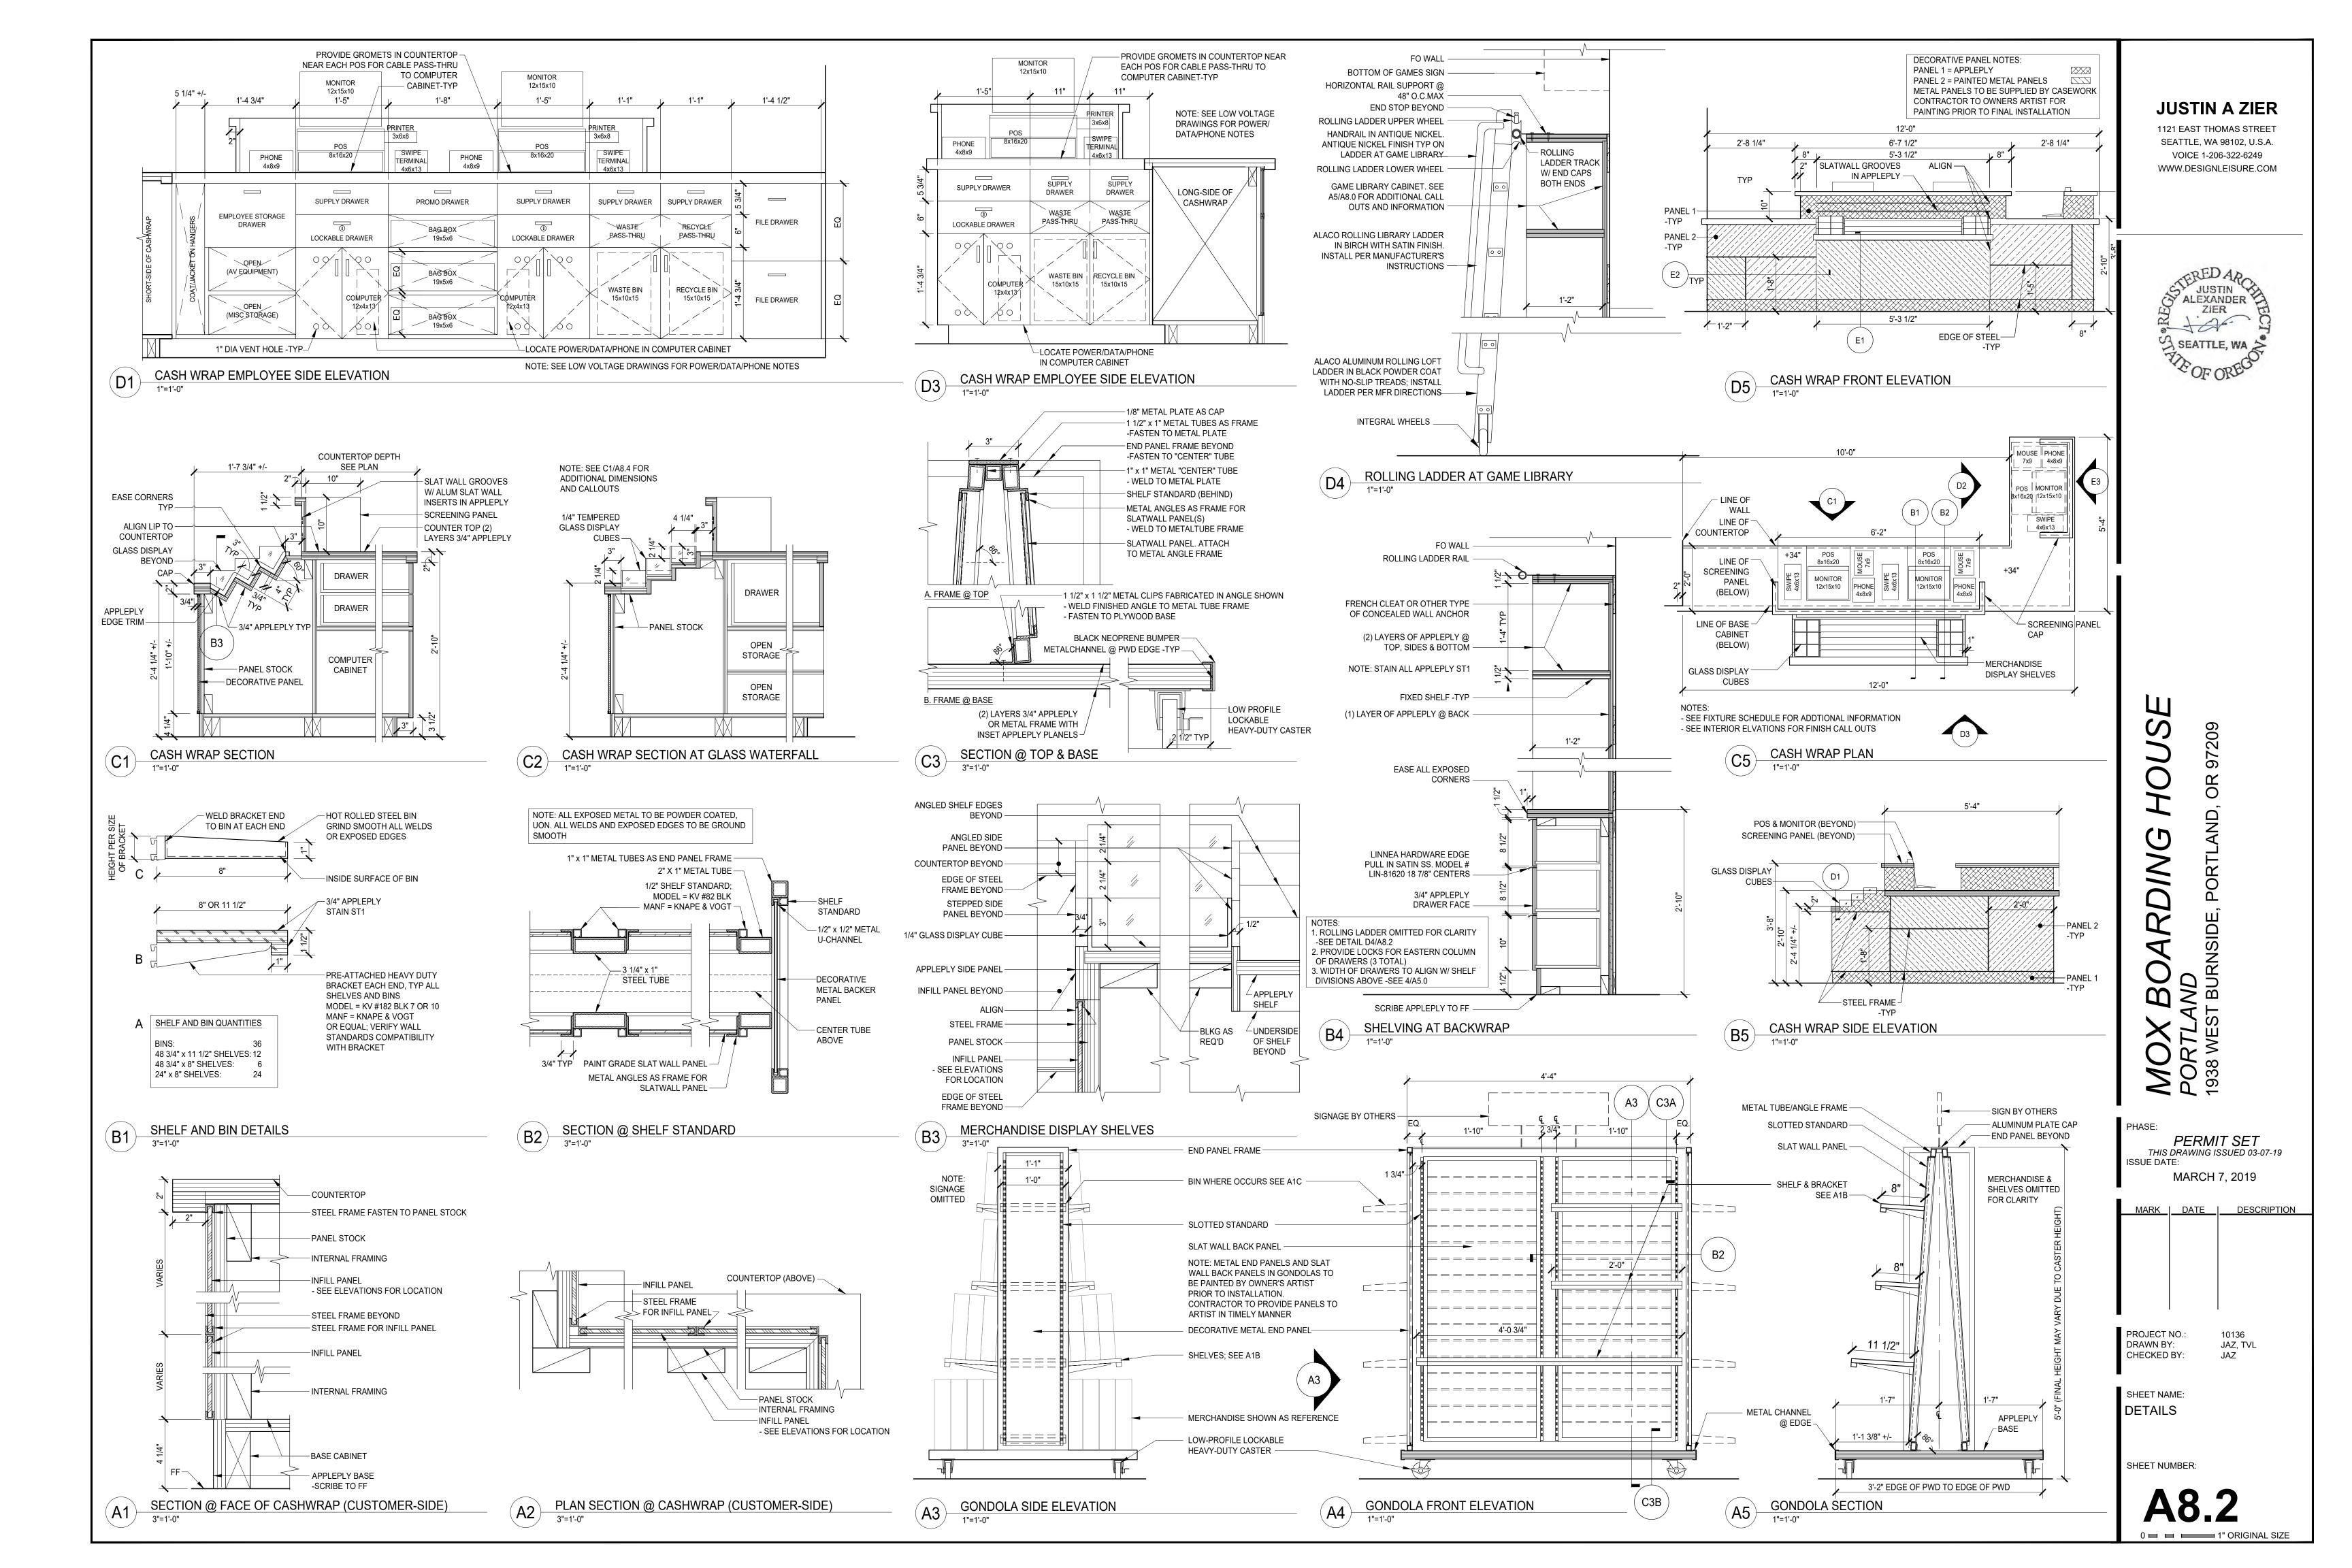

GENERAL STRUCTURAL NOTES:

CONFORM TO THE 2012 INTERNATIONAL BUILDING CODE AS AMENDED BY THE 2014 OREGON STRUCTURAL SPECIALTY CODE. REFERENCED HEREAFTER AS IBC.

DESIGN WAS BASED ON THE STRENGTH AND DEFLECTION CRITERIA OF THE IBC. IN ADDITION TO THE DEAD LOADS, THE FOLLOWING LOADS WERE USED FOR DESIGN, WITH LIVE LOADS REDUCED PER IBC:

FLOOR LIVE LOAD: 100 PSF CAPACITY PER ORIGINAL BUILDING PLANS

MINIMUM INTERIOR LATERAL LOAD: 5 PSF

SEISMIC IMPORTANCE FACTOR le: 1.0 SITE CLASS: D

SDS = 0.724

THE CONTRACTOR SHALL FIELD VERIFY ALL EXISTING CONDITIONS, DIMENSIONS AND ELEVATIONS. THE CONTRACTOR SHALL NOTIFY THE ARCHITECT/ENGINEER OF ANY DISCREPANCIES FROM CONDITIONS SHOWN ON THE DRAWINGS PRIOR TO THE START OF THE WORK.

TEMPORARY CONDITIONS:

THE CONTRACTOR SHALL BE RESPONSIBLE FOR STRUCTURAL STABILITY OF THE NEW AND EXISTING STRUCTURES AND WALLS DURING CONSTRUCTION. THE STRUCTURE SHOWN ON THE DRAWINGS HAS BEEN DESIGNED FOR STABILITY UNDER THE FINAL CONFIGURATION ONLY.

SHOP DRAWINGS SHALL BE SUBMITTED TO THE ARCHITECT/ENGINEER PRIOR TO FABRICATION AND CONSTRUCTION REGARDING ALL STRUCTURAL ITEMS, INCLUDING THE FOLLOWING:

IF THE SHOP DRAWINGS DIFFER FROM, OR ADD TO THE DESIGN OF THE STRUCTURAL DRAWINGS, THEY SHALL BE CLEARLY IDENTIFIED. ANY CHANGES TO THE STRUCTURAL DRAWINGS SHALL BE SUBMITTED TO THE ARCHITECT/ENGINEER AND ARE SUBJECT TO REVIEW AND ACCEPTANCE BY THE ENGINEER.

PROVIDE THE SUBMITTALS DIGITALLY (PDF FORMAT) TO THE ENGINEER FOR REVIEW. NECESSARY CORRECTIONS/COMMENTS WILL BE NOTED AND RETURNED.

NON-STRUCTURAL DEFERRED SUBMITTALS SUCH AS ARCHITECTURAL, MECHANICAL, SPRINKLER, AND FIRE ALARMS SHALL BE PER THE PROGRAM OUTLINED ON THE ARCHITECTURAL DRAWINGS.

CONCRETE SCREW ANCHORS SHALL BE "HILTI KWIK HUS-EZ" (OR ENGINEER APPROVED EQUIVALENT) INSTALLED PER MANUFACTURER'S GUIDELINES AND CURRENT ESR REPORT.

<u>EXISTING POST TENSION SLABS:</u>

SAWS OR CORE DRILLS SHALL NOT BE USED IN POST TENSIONED CONCRETE UNLESS SPECIFICALLY APRROVED BY THE ENGINEER OF RECORD.

POWER DRIVEN FASTENERS SHALL NOT PENETRATE THE SLAB MORE THAN 5/8"

FOR ANCHORS WITH EMBEDMENT GREATER THAN 3/4", ALL REINFORCING SHALL BE LOCATED PRIOR TO ANCHOR INSTALLATION. DO NOT CUT EXISTING REINFORCING. NOTIFY ENGINEER OF RECORD IF ALTERNATIVE DETAILING WILL BE REQUIRED TO AVOID EXISTING REINFORCEMENT PRIOR TO FABRICATION OF STEEL.

ALL MISCELLANEOUS STEEL: ASTM A36 (Fy=36,000 PSI), OR AS NOTED ASTM A572 (Fy=50 KSI)... SQUARE AND RECTANGULAR HSS: ASTM A500, GRADE "B" (Fy=46,000 PSI). ROUND HSS: ASTM A500, GRADE "B" (Fy=42,000 PSI).

ALL BOLTS: ASTM A325 UNLESS NOTED OTHERWISE.

WELDING: PER AWS STANDARDS. E70XX ELECTRODE AND BY CERTIFIED WELDERS. ALL STEEL TO HAVE SHOP COAT.

DESIGN, FABRICATION, AND ERECTION SHALL BE IN ACCORDANCE WITH THE "AISC SPECIFICATION FOR STRUCTURAL STEEL BUILDINGS". WELDING SHALL CONFORM TO THE AWS CODES FOR ARC AND GAS WELDING IN BUILDING CONSTRUCTION AND SHALL BE 3/16" MINIMUM UNLESS OTHERWISE NOTED. WELDING SHALL BE BY AWS CERTIFIED WELDERS. PREQUALIFIED WELDING PROCEDURES ARE TO BE USED, UNLESS AWS QUALIFICATION IS SUBMITTED TO THE ARCHITECT/ENGINEER PRIOR TO FABRICATION.

INSTALLATION AND TIGHTENING OF ALL BOLTS SHALL BE IN ACCORDANCE WITH THE "SPECIFICATIONS FOR STRUCTURAL JOINTS USING ASTM A325 OR A490 BOLTS". UNLESS NOTED OTHERWISE BOLTS SHALL BE INSTALLED IN ALL HOLES OF THE CONNECTION AND BROUGHT TO A SNUG-TIGHT CONDITION. SNUG TIGHT IS DEFINED AS THE TIGHTNESS THAT EXISTS WHEN THE PLIES OF THE JOINT ARE IN FIRM CONTACT. THIS MAY BE ATTAINED BY A FEW IMPACTS OF AN IMPACT WRENCH OR THE FULL EFFORT OF A MAN USING AN ORDINARY SPUD WRENCH.

THE DESIGN, INSTALLATION AND CONSTRUCTION OF COLD-FORMED CARBON OR LOW-ALLOY STEEL, STRUCTURAL AND NON-STRUCTURAL FRAMING, SHALL BE IN ACCORDANCE WITH THE MOST CURRENT STANDARDS FOR COLD-FORMED STEEL FRAMING - GENERAL PROVISIONS, AISI.

THE DESIGN, INSTALLATION AND CONSTRUCTION OF COLD-FORMED CARBON STEEL BOX AND BACK-TO-BACK HEADERS USED IN SINGLE-SPAN CONDITIONS FOR LOAD-CARRYING PURPOSES SHALL BE IN ACCORDANCE WITH THE STANDARDS FOR COLD-FORMED STEEL FRAMING - HEADER DESIGN PROVISIONS, AISI.

LIGHT-GAGE STEEL COMPONENTS SHALL HAVE THE FOLLOWING MINIMUM DESIGN STRENGTH UNLESS OTHERWISE NOTED IN THE PLANS: Fy=50,000 PSI FOR 54 AND 68 MIL STUDS.

Fy=33,000 PSI FOR 18 THROUGH 43 MIL STUDS.

FASTENING OF COMPONENTS SHALL BE WITH #10 SELF DRILLING SCREWS UNLESS NOTED OTHERWISE ON THE DRAWINGS. PENETRATION OF ALL SCREWS THROUGH JOINED MATERIALS SHOULD NOT BE LESS THAN 3 EXPOSED THREADS, INSTALLED AND TIGHTENED IN ACCORDANCE WITH THE SCREW MANUFACTURER'S RECOMMENDATIONS. THE STUDS SHALL BE SEATED FIRMLY IN BOTH THE TOP AND BOTTOM TRACKS. GYPSUM WALL BOARD OR PLYWOOD SHALL BE APPLIED TO EACH FACE OF STUD AND FASTENED WITH DRYWALL SCREWS AT A MAXIMUM OF 12" O/C UNLESS NOTED OTHERWISE.

SAWN LUMBER DESIGN IS BASED ON THE NATIONAL DESIGN SPECIFICATION, LATEST EDITION. SAWN LUMBER SHALL CONFORM TO WEST COAST LUMBER INSPECTION BUREAU OR WESTERN WOOD PRODUCTS ASSOCIATION GRADING RULES. UNLESS NOTED OTHERWISE ALL LUMBER SHALL BE 19% AT TIME OF FABRICATION AND DRIED TO A MAXIMUM OF 15% BEFORE INSTALLATION OF GYP. BOARD AND OF BRICK VENEER AND VERIFIED BY THE GENERAL CONTRACTOR. ALL WOOD IN PERMANENT CONTACT WITH CONCRETE OR CMU SHALL BE PRESSURE TREATED UNLESS AN APPROVED BARRIER IS PROVIDED. GRADES SHALL BE D.F. #2 OR BETTER AND FIRE TREATED WITH AN ARCHITECT/ENGINEER APPROVED PRODUCT UNLESS NOTED OTHERWISE ON THE PLANS.

FRAMING ACCESSORIES AND STRUCTURAL FASTENERS SHALL BE MANUFACTURED BY SIMPSON STRONG-TIE COMPANY (OR ENGINEER APPROVED EQUAL) AND OF THE SIZE AND TYPE SHOWN ON THE DRAWINGS AND ATTACHED PER MANUFACTURER'S REQUIREMENTS AND RECOMMENDATIONS UNLESS NOTED OTHERWISE. ALL FRAMING NAILS SHALL BE COMMON NAILS. NO BOX NAILS ALLOWED. FASTENERS AND ACCESSORIES IN CONTACT WITH PRESERVATIVE TREATED WOOD MUST BE HOT DIPPED GALVANIZED OR HAVE ZMAX COATING. ALL FASTENERS AND ACCESSORIES IN CONTACT WITH FIRE RETARDANT LUMBER MUST BE HOT-DIPPED GALVANIZED. DO NOT INSTALL 0.148" x 1 1/2" NAILS IN HANGERS UNLESS SPECIFICALLY NOTED ON THE PLANS & DETAILS.

SHEATHING PANELS SHALL CONFORM TO THE REQUIREMENTS OF VOLUNTARY PRODUCT STANDARD PS 1 OR PS 2, OR APA PRP-108 PERFORMANCE STANDARDS. UNLESS NOTED, PANELS SHALL BE APA RATED SHEATHING, EXPOSURE 1, OF THE THICKNESS AND SPAN RATING SHOWN ON THE DRAWINGS. INSTALLATION SHALL BE IN CONFORMANCE WITH APA RECOMMENDATIONS. ALLOW 1/8" SPACING AT PANEL ENDS AND EDGES, UNLESS OTHERWISE RECOMMENDED BY THE PANEL MANUFACTURER. ALL SHEATHING SHALL BE FIRE TREATED WITH AN ARCHITECT/ENGINEER APPROVED PRODUCT UNLESS NOTED OTHERWISE ON THE PLANS.

THE CONTRACTOR SHALL COORDINATE SEISMIC RESTRAINTS OF ELECTRICAL EQUIPMENT, MECHANICAL, PLUMBING, FIRE SPRINKLER, MACHINERY, AND ASSOCIATED PIPING WITH THE STRUCTURE. ANY CONNECTIONS TO STRUCTURE NOT CONFORMING TO SHEET METAL AND AIR CONDITIONING CONTRACTORS NATIONAL ASSOCIATION (SMACNA), OR SPECIFICALLY DETAILED ON THE MECHANICAL ENGINEER'S DRAWINGS, SHALL BE DESIGNED IN ACCORDANCE OF THESE GENERAL NOTES. BY AN ENGINEER REGISTERED IN THE STATE OF OREGON, AND SHALL BE SUBMITTED TO THE ARCHITECT/ENGINEER PRIOR TO FABRICATION.

ALL FLASHING AND WATERPROOFING SHALL BE BY OTHERS UNLESS NOTED OTHERWISE ON THE PLANS.

SPECIAL INSPECTIONS: IN ACCORDANCE WITH SECTION 1704 OF THE IBC AND APPLICABLE SECTIONS OF THE PROJECT SPECIFICATIONS. SPECIAL INSPECTIONS ARE TO BE PERFORMED BY AN INDEPENDENT TESTING LABORATORY EMPLOYED BY THE OWNER FOR THE AREAS INDICATED IN THE SPECIAL INSPECTION PROGRAM.

THE CONTRACTOR AND SPECIAL INSPECTOR SHALL NOTIFY THE ENGINEER OF RECORD OF ANY ITEM NOT COMPLYING WITH THE PROJECT SPECIFICATIONS AND/OR APPLICABLE CODES BEFORE PROCEEDING WITH ANY WORK INVOLVING THAT ITEM. THE ENGINEER OF RECORD WILL REVIEW THE ITEM AND DETERMINE ACCEPTABILITY. IF WORK INVOLVING THAT ITEM PROCEEDS WITHOUT THE APPROVAL OF THE ENGINEER OF RECORD THEN THE WORK WILL BE CONSIDERED NON-COMPLIANT.

SPECIAL INSPECTION PROGRAM					
ESTABLISHED PER 2012 IBC AS AMENDED BY THE 2014 OSSC SECTION 110 & CHAPTER 17					
ITEM	CONTINUOUS	PERIODIC	COMMENTS		
GENERAL STRUCTURA	L INSPECTION	S AS REQUIR	ED BY SECTION 110		
WOOD FRAMING			BY BUILDING OFFICIAL		
FINAL INSPECTION			BY BUILDING OFFICIAL		
	STEE				
IN A CCORDANCE WITH OSSC 1705.2 A NE	QUALITY ASS	SURANCE INSP	PECTION REQUIREMENTS OF AISC 360		
MATERIAL VERIFICATION OF HIGH STRENGTH		X	REFERENCE A PPLICA BLE A STM MA TERIA L		
BOLTS, NUTS, AND WASHERS			SPECIFICATIONS; AISC 360, SECTION A3.3		
MATERIAL VERIFICATION OF STRUCTURAL		х	AISC 360, SECTION M5.5 AND APPLICABLE		
STEEL			ASTM STANDARDS		
COMPLIANCE OF STEEL FRAME JOINTS TO		х			
CONSTRUCTION DOCUMENT DETAILS					
WEL	_ _DING: STRUCT	 TURAL STEEL	_		
MATERIAL VERIFICATION OF WELD FILLER					
MATERIALS		X	A ISC 360, SECTION A3.5, A WS A5 DOCUMENTS		
COMPLETE AND PARTIAL PENETRATION	Х		AWS D1.1,		
SINGLE PASS FILLETS ≤ 5/16"		Х			
	CONCRI				
EPOXY OR A DHESIVE A NCHOR PLACEMENT		Х	CONTINUOUS WHERE INDICATED ON DRAWINGS		
EXPANSION OR SCREW ANCHOR PLACEMENT		Х	CONTINUOUS WHERE INDICATED ON DRAWINGS		

DEFINITIONS:

- A. CONTINUOUS INSPECTION MEANS THAT THE SPECIAL INSPECTOR IS ON SITE AT ALL
- TIMES OBSERVING THE WORK REQUIRING SPECIAL INSPECTION.
- B. PERIODIC INSPECTION MEANS THAT THE SPECIAL INSPECTOR IS ON SITE AT TIME INTERVALS NECESSARY TO CONFIRM THAT THE WORK REQUIRING SPECIAL INSPECTION IS IN CONFORMANCE WITH A PPROVED PERMIT PLANS AND SPECIFICATIONS.

JUSTIN A ZIER

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PERMIT SET THIS DRAWING ISSUED 03-07-19 ISSUE DATE: MARCH 7, 2019

MARK DATE DESCRIPTION

TMR PROJECT NO.: 18352 DRAWN BY: CTT CHECKED BY: JKW

SHEET NAME: STRUCTURAL GENERAL NOTES AND SPECIAL **INSPECTION**

SHEET NUMBER:

0 = = 1" ORIGINAL SIZE

\\$2.1

KEYPLAN

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ND F BURNSIDE,

PERMIT SET THIS DRAWING ISSUED 03-07-19 ISSUE DATE:

MARCH 7, 2019 MARK DATE DESCRIPTION

TMR PROJECT NO.: 18352 DRAWN BY: CTT

CHECKED BY: JKW SHEET NAME:


STAIR FRAMING PLAN AND FOLDING DOOR ELEVATIONS

SHEET NUMBER:

0 = = 1" ORIGINAL SIZE


STAIR AND PLATFORM KEYNOTES:

- 1. FIRE TREATED WOOD STRINGERS PER DETAIL 1/S3.1.
- 2. BEARING WALL AT MID SPAN OF STRINGERS, SEE DETAIL 2/S3.1.
- 3. EXISTING PLATFORM FRAMING IS UNKNOWN. CONTRACTOR TO VERIFY AND NOTIFY ENGINEER OF FRAMING PRIOR TO CONSTRUCTION. COLD FORM METAL FLOOR JOISTS ASSUMED WITH PLYWOOD
- 4. EXISTING METAL STUD BEARING WALL ASSUMED (VERIFY AND NOTIFY ENGINEER). REMOVE EXISTING BEARING WALL AND PROVIDE NEW BOX HEADER PER DETAIL 5/S3.1. SUPPORT AT ENDS PER DETAIL 6/S3.1.
- 5. EXISTING COLD FORM STEEL LEDGER ASSUMED. VERIFY AND NOTIFY ENGINEER OF ATTACHMENTS TO STRUCTURE.
- 6. WALLS EACH SIDE OF STAIR, PER ARCH.

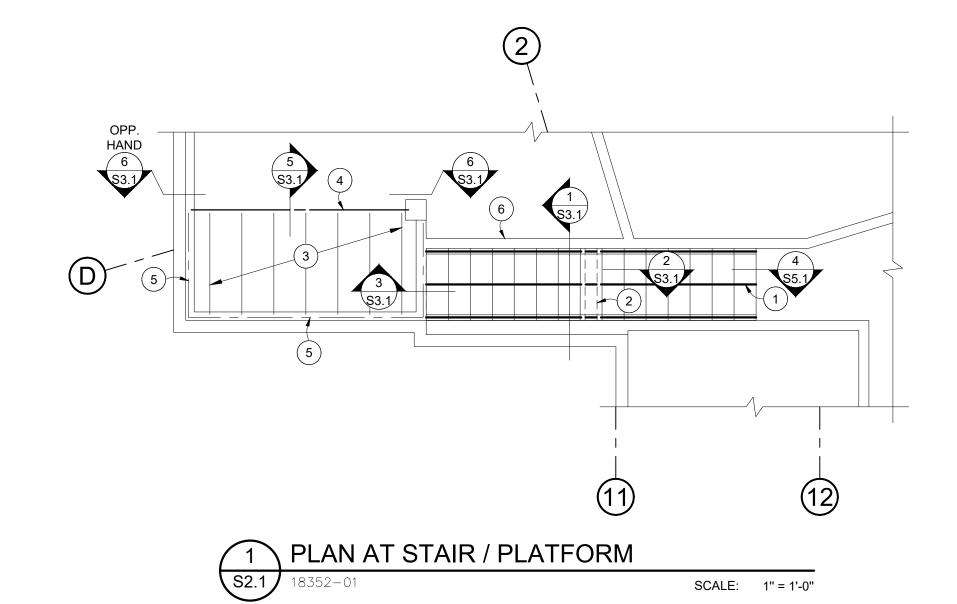


FOLDING DOOR ELEVATION KEYNOTES:

- 1. HSS 5x5x5/16 HEADER OVER OPENING.
- HSS 5x3x3/16 KING POST.
- 3. BOX HEADER: (2) 400S162-68 SIDE MEMBERS, 400T150-68 TRACKS TOP AND BOTTOM. ATTACH ALL FLANGES WITH #10 SCREWS @ 1'-0" O/C.
- 4. BOX STUD: (1) 400S250-68, (1) 400T250-68. ABOVE CEILING PROVIDE BLOCKING AND STRAPPING TO ADJACENT FRAMING PER KEYNOTE 9.
- 5. FOLDING PARTITION DOOR AND ATTACHMENTS TO THE PROVIDED STRUCTURE ARE BY THE DOOR
- 6. AT BOX STUD BASE PROVIDE MINIMUM 54 MIL BOTTOM TRACK WITH 1 ½" FLANGES. ATTACH TO BOX STUD WITH #10 SCREWS EACH SIDE. ATTACH TRACK TO PT SLAB WITH (4) HILTI 'X-U' PINS (0.157" Ø, 5/8" EMBEDMENT INTO CONCRETE) SPACED @ 3" O/C EACH WAY.
- 7. AT TOP OF BOX STUD PROVIDE MINIMUM 54 MIL SLOTTED DEFLECTION TRACK WITH FLANGE HEIGHT NECESSARY FOR A 1" DEFLECTION HEAD. ATTACH TO BOX STUD WITH #10 SCREW EACH SIDE. ATTACH TRACK TO PT SLAB WITH (4) HILTI 'X-U' PINS (0.157" Ø, 5/8" EMBEDMENT INTO CONCRETE) SPACED @ 3" O/C EACH WAY.
- 8. AS A MINIMUM PROVIDE A DOUBLE STUD BETWEEN WINDOWS (33 MIL) THAT IS CONTINUOUS FROM TOP OF DOOR HEADER TO BOTTOM OF SLAB ABOVE.
- 9. INFILL FRAMING TO BE MINIMUM 33 MIL AND SPACED @ 1'-4" O/C MAX. WHERE SHEATHING IS NOT APPLIED BOTH SIDES (ABOVE CEILING) THAN BLOCK AND STRAP ALL STUD FLANGES PER DETAIL
- 10. PROVIDED SLOTTED DEFLECTION TRACK AT TOP OF WALL WITH FLANGE HEIGHT NECESSARY FOR A 1" DEFLECTION HEAD (MINIMUM 33 MIL, CAN BE 54 MIL TO MATCH KEYNOTE 7). ATTACH TO EACH STUD WITH #10 SCREW EACH SIDE. ATTACH TO PT SLAB WITH HILTI 'X-U' PINS (0.157" Ø, 5/8" EMBEDMENT INTO CONCRETE) SPACED @ 1'-4" O/C.
- 11. SUPPORT BOX HEADER FROM STUDS BY RUNNING SIDE MEMBER FLANGES LONG AND SCREWING INTO SIDES OF BOX STUD, SIMILAR TO DETAIL 6/S3.1.

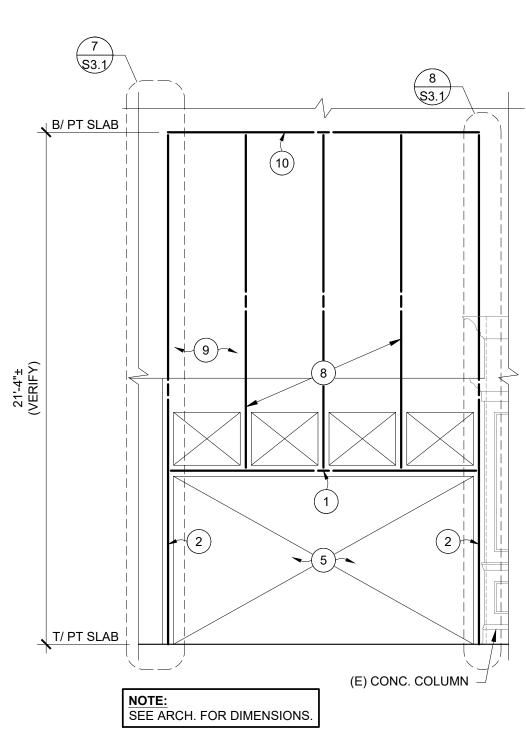

ELEVATION AT FOLDING DOOR SCALE: 1/4" = 1'-0"

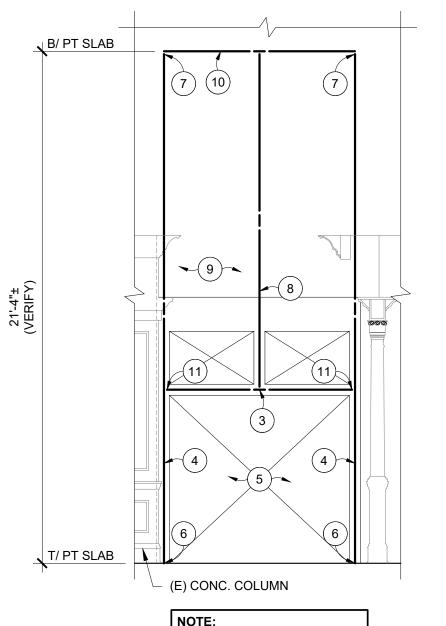


ELEVATION AT 12'-6" SOFFIT HEADER (3/A5.2) S2.1 SCALE: 1/4" = 1'-0"

9

4

NOTE: SEE ARCH. FOR DIMENSIONS. **ELEVATION AT FOLDING DOOR** SCALE: 1/4" = 1'-0"

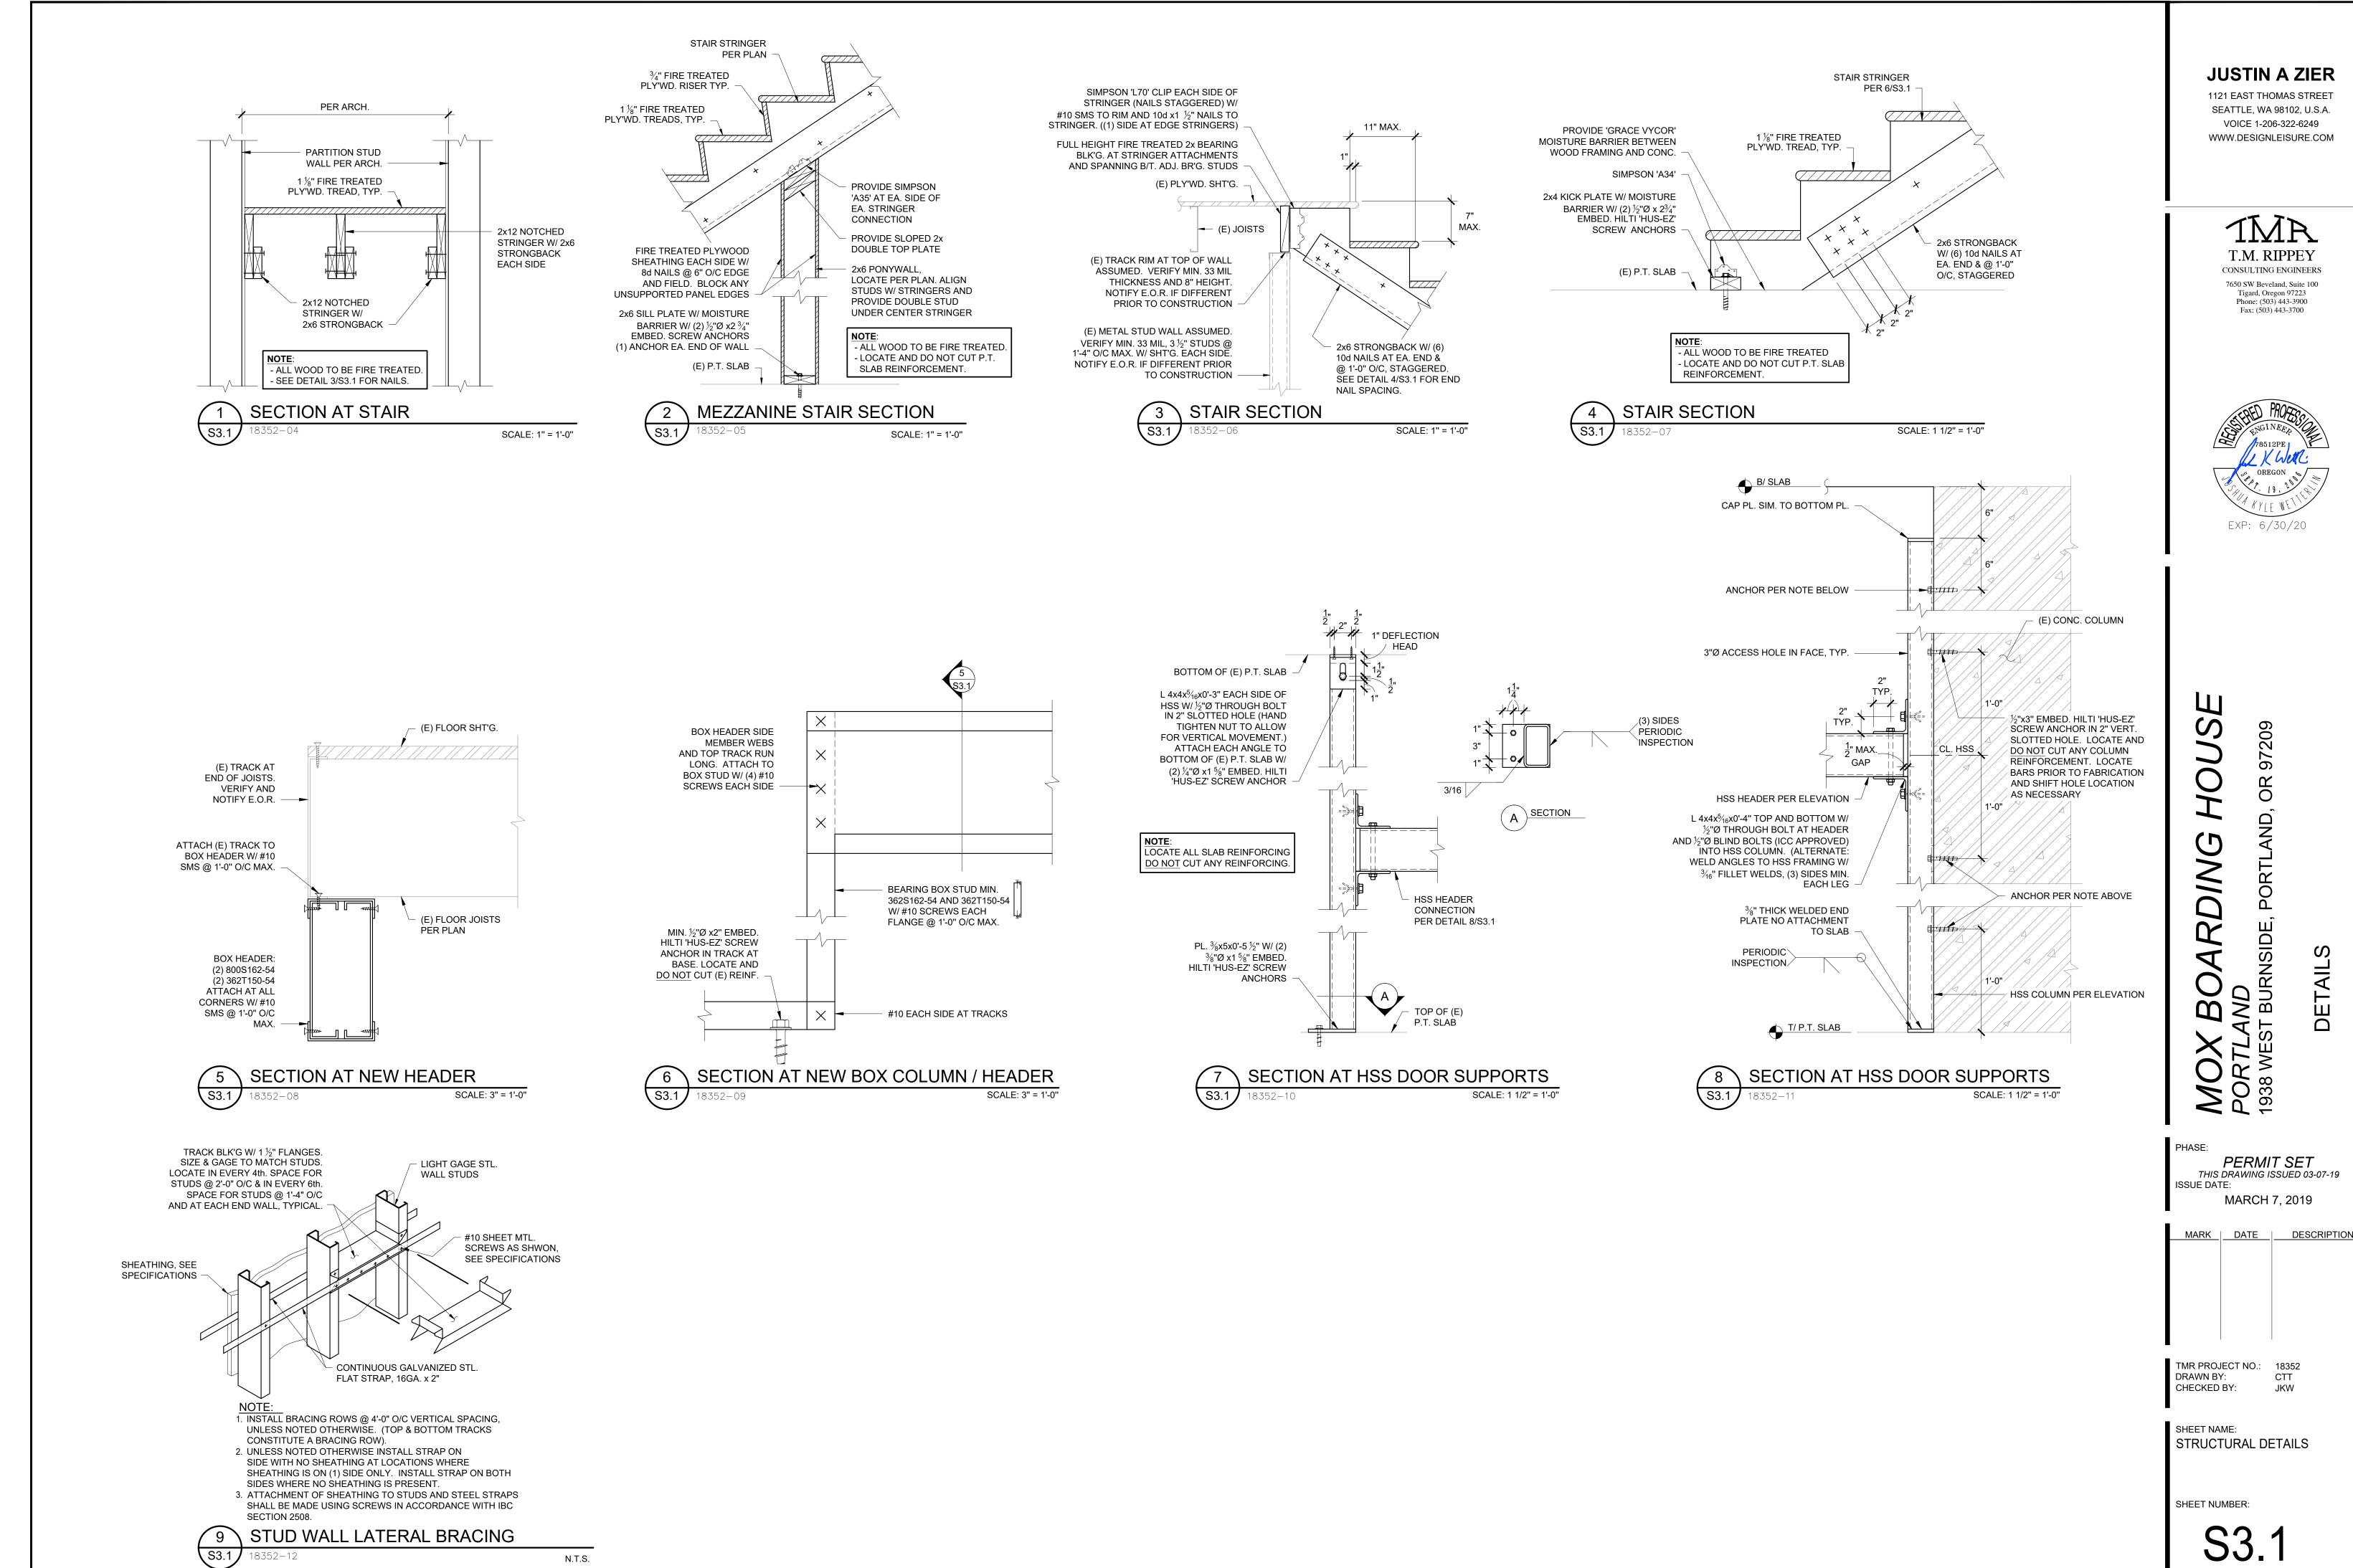

MARK DATE DESCRIPTION

0 = = 1" ORIGINAL SIZE

TYPE	LOCATION	IMAGE	DESCRIPTION	MANUFACTURER & MODEL	MOUNTING NOTES	LAMP	WATTS	VOLTS
C1	VARIOUS		7" ROUND SURFACE MOUNTED DOWNLIGHT WITH 1000 LUMEN 3000K LED LAMPING IN WHITE FINISH	JUNO LIGHTING: SLIMFORM JSF 7IN 30K 90CRI 120 FRPC WH		10W LED 3000K	10	120
F1	вон		1' X 4' SURFACE MOUNTED WRAP WITH LED LAMPING OR RE-USE EXISTING FIXTURES				40	120
F2	KITCHEN		2' X 2' RECESSED TROFFER WITH LED LAMPING WITH LENS SUITABLE FOR COMMERCIAL KITCHEN LOCATION	LITHONIA LIGHTING: 2' X 2' RECESSED TROFFER		35W LED 3000K	35	120
F3	KITCHEN		1' X 4' SURFACE MOUNTED WRAP WITH LED LAMPING WITH LENS SUITABLE FOR COMMERCIAL KITCHEN LOCATION	LITHONIA LIGHTING: 1' X 4' WRAP		32W LED 3000K	32	120
L1	COVES		LINEAR LED TAPE SYSTEM MOUNTED IN SMALL PROFILE CHANNEL WITH FROSTED LENS. COLOR TEMP AND OUTPUT TBD.	KELVIX LIGHTING: PH 300 SERIES - COLOR TBD CH-XXX		2.5W/FT	384	120/24
L2	COVES		LINEAR LED TAPE SYSTEM MOUNTED IN SMALL PROFILE CHANNEL WITH FROSTED LENS. COLOR TEMP AND OUTPUT TBD.	KELVIX LIGHTING: PH 300 SERIES - COLOR TBD CH-XXX		2.5W/FT	192	120/24
L3	COVES		LINEAR LED TAPE SYSTEM MOUNTED IN SMALL PROFILE CHANNEL WITH FROSTED LENS. COLOR TEMP AND OUTPUT TBD.	KELVIX LIGHTING: PH 300 SERIES - COLOR TBD CH-XXX		2.5W/FT	192	120/24
L4	HALL NICHE		LINEAR LED TAPE SYSTEM MOUNTED IN SMALL PROFILE CHANNEL WITH FROSTED LENS. COLOR TEMP AND OUTPUT TBD.	KELVIX LIGHTING: PH 300 SERIES - COLOR TBD CH-XXX		2.5W/FT	96	120/24
L5	CASEWORK		LINEAR LED TAPE SYSTEM MOUNTED IN SMALL PROFILE CHANNEL WITH FROSTED LENS. COLOR TEMP AND OUTPUT TBD.	KELVIX LIGHTING: PH 300 SERIES - COLOR TBD CH-XXX		2.5W/FT	96	120/24
L6	BACK BAR		LINEAR LED TAPE SYSTEM MOUNTED IN SMALL PROFILE CHANNEL WITH FROSTED LENS. COLOR TEMP AND OUTPUT TBD.	KELVIX LIGHTING: PH 300 SERIES - COLOR TBD CH-XXX		2.5W/FT	96	120/24
L7	BAR FACE		LINEAR LED TAPE SYSTEM MOUNTED IN SMALL PROFILE CHANNEL WITH FROSTED LENS. COLOR TEMP AND OUTPUT TBD.	KELVIX LIGHTING: PH 300 SERIES - COLOR TBD CH-XXX		2.5W/FT	96	120/24
M1	VARIOUS		2 1/2" DIA. CYLINDER TRACK HEAD WITH INTEGRAL LED DRIVER AND DIMMABLE 3000K LED LAMPING WITH NARROW FLOOD BEAM IN BLACK FINISH WITH HEXCELL LOUVER MOUNTED ON CANOPY MONOPOINT MOUNT. CONFIRM EXTENSION WAND LENGTH WITH ARCHITECT PRIOR TO ORDER.	JUNO LIGHTING: TL381L-30K-80CRI-NFL-BL HCLBL 200 TLRW-XX-BL		13W LED 3000K	13	120/12
P1	TOURNAMENT ROOM		60" DIA. DECORATIVE CHANDELIER	RESTORATION HARDWARE: FOUCAULT'S ORB SMOKE CRYSTAL CHANDELIER 60"		(25) E12 BULBS RETROFIT LED	125	120
P2	ccg		DECORATIVE STEM MOUNTED PENDANT	REJUVENATION LIGHTING: ROSE CITY 4" FITTER ROD / #A7008 10" FACETED ETCHED GLOBE / #B0043		LED RETROFIT A19 WARM-DIM	12	120
P3	RETAIL			PATHWAY LIGHTING:			35	120
P4	RESTROOM		LARGE DECORATIVE CRYSTAL CHANDELIER	ELEGANT LIGHTING: CENTURY 17-LIGHT, THREE-TIER CRYSTAL CHANDELIER #V1900G30C/SS		(17) E12 BULBS LED RETROFIT	85	120
P5	PRIVATE ROOM 2		CORD AND SOCKET PENDANT FOR EXPOSED LED RETROFIT BULB	TECH LIGHTING: SOCO PENDANT OR SIMILAR		LED RETROFIT WARM-DIM	9	120
R1	VARIOUS		ADJUSTABLE ROUND RECESSED DOWNLIGHT WITH 1323 DELIVERED LUMEN DIMMABLE 3000K LED LAMPING WITH FLANGED FLAT TRIM WITH 15 DEGREE OPTIC. CONFIRM FINISH WITH ARCHITECT. FIXTURE SHALL HAVE EMERGENCY BACKUP OPTION, TO BE USED AS REQUIRED.	AMERLUX LIGHTING: HORNET HDL-HP-R-NC-A17-T-18-VOLT-DIM HDL-HP-RA-A17-T-FINISH-SP-30		18W LED 3000K	18	120
R2	VARIOUS		SAME AS R1 WITH 28 DEGREE OPTIC			18W LED 3000K	18	120
R3	VARIOUS		SAME AS R1 WITH 45 DEGREE OPTIC			18W LED 3000K	18	120

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R4	CASEWORK & SOFFITS		LOW VOLTAGE RECESSED PUCK LIGHT WITH LED LAMPING FOR MOUNTING IN CASEWORK SHELVES AND SOFFITS	JUNO LIGHTING: USTLR1-30K-80CRI OR SIMILAR		4W LED	4	120/12
S1	RESTAURANT		DECORATIVE SCONCE	REJUVENATION LIGHTING: IRONSIDE SCONCE #A3160		LED RETROFIT A19 WARM-DIM	12	120
S2	RESTAURANT BOOTHS		DECORATIVE SCONCE	TBD		LED RETROFIT WARM-DIM	12	120
S 3	RESTAURANT BOOTHS		DECORATIVE SCONCE	TBD		LED RETROFIT WARM-DIM	12	120
T1	RETAIL		ON CIRCUIT LINE VOLTAGE TRACK IN BLACK FINISH MOUNTED TO UNI-STRUT. CONFIRM COMPATIBILITY OF JUNO TRACK WITH AMERLUX TRACK HEADS.	JUNO LIGHTING: T-XX-BL	MOUNT TRACK ON UNI- STRUT AT 12'-0" A.F.F.			120
T1a	RETAIL		LINE VOLTAGE TRACK HEAD WITH VERTICAL TRANSFORMER WITH DIMMABLE 3000K LED LAMPING WITH 23 DEGREE BEAM SPREAD WITH SNOOT AND CROSS BLADE LOUVER IN BLACK FINISH	AMERLUX LIGHTING: C3MV-21-LED-BT-CT-120-NF-30-SN-CB		21W LED 3000К	21	120
T1b	RETAIL		LINE VOLTAGE TRACK HEAD WITH VERTICAL TRANSFORMER WITH DIMMABLE 3000K LED LAMPING WITH WALL WASH BEAM SPREAD WITH VISOR DOWN ACCESSORY IN BLACK FINISH	AMERLUX LIGHTING: MURV-19-LED-BT-CT-120-WW-30-VISD		19W LED 3000K	19	120
T1c	ELEC RM	SilverBuller	CURRENT LIMITING SUB-PANEL FCR LINE VOLTAGE TRACK IF REQUIRED PER ENERGY CODE, CONFIRM WITH ELECTRICAL CONTRACTOR.	JUNO LIGHTING: SILVER BULLET CURRENT LIMITING SUB-PANEL		(11) 4A CKTS	5280	120
T2	VARIOUS		LOW VOLTAGE TRACK IN BLACK FINISH. REMOTE TRANSFORMER RQUIRED. ELECTRICAL CONTRACTOR RESPONSIBLE FOR ALL PARTS AND PIECES FOR COMPLETE SYSTEM.	JUNO LIGHTING: TRAC 12/25 TLVR-XX-BL REMOTE TRANSFORMER				120
T2a	VARIOUS		LOW VOLTAGE MINI CYLINDER WITH DIMMABLE 3000K LED LAMPING IN BLACK FINISH.	JUNO LIGHTING: TL114 G2 30K 80CRI NFL		6.6W LED 3000K	6.6	120/12
T2b	VARIOUS	P	REMOTE MAGNETIC TRANSFORMAER	JUNO LIGHTING: MAGNETIC TRANSFORMER			75	120/12
T2c	VARIOUS		REMOTE MAGNETIC TRANSFORMAER	JUNO LIGHTING: MAGNETIC TRANSFORMER			150	120/12
Т3	PRIVATE ROOM 1		STEM MOUNTED LOW VOLTAGE TRACK IN BLACK FINISH. ELECTRICAL CONTRACTOR RESPONSIBLE FOR ALL PARTS AND PIECES FOR COMPLETE SYSTEM.	JUNO LIGHTING: TRAC 12/25 TLVR-XX-BL REMOTE TRANSFORMER	TRACK SHALL BE STEM MOUNTED ABOVE CUSTOM WOOD CEILING GRID, CONFIRM STEM LENGTH WITH ARCHITECT			120/12
ТЗа	PRIVATE ROOM 1		2 1/2" DIA. CYLINDER TRACK HEAD WITH INTEGRAL LED DRIVER AND DIMMABLE 3000K LED LAMPING WITH NARROW FLOOD BEAM IN BLACK FINISH WITH HEXCELL LOUVER MOUNTED FROM TRACK WITH 24 INCH EXTENSION WAND (CONFIRM LENGTH PRIOR TO ORDER).	JUNO LIGHTING: TL381L-30K-80CRI-NFL-BL HCLBL 200 TLRW-24IN-BL	TRACK HEADS SHALL BE MOUNTED FROM TRACK ON EXTENSION WANDS TO BOTTOM OF 24 INCH DEEP CUSTOM WOOD CEILING GRID.	13W LED 3000К	13	120/12
T3c	VARIOUS	þ	REMOTE MAGNETIC TRANSFORMER	JUNO LIGHTING:			240	120/12
T3d	VARIOUS	P	REMOTE MAGNETIC TRANSFORMER	JUNO LIGHTING:			75	120/12
X1	VARIOUS	EXIT	EXIT SIGNS WITH INTEGRAL BUGEYES. FINAL SELECTION TO BE CONFIRMED BY ELECTRICAL CONTRACTOR AND ARCHITECT.	LITHONIA LIGHTING: ECC LED COMBO			4	120
X2	VARIOUS	EXIT)	EXIT SIGNS. FINAL SELECTION TO BE CONFIRMED BY ELECTRICAL CONTRACTOR AND ARCHITECT.	LITHONIA LIGHTING: LED EXIT SIGN			1	120
Х3	VARIOUS		EMERGENCY BUGEYE FIXTURES. FINAL SELECTION TO BE CONFIRMED BY ELECTRICAL CONTRACTOR AND ARCHITECT.	Lithonia Lighting: Eu2C			4	120

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LIGHTING DESIGNS, INC.

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THIS DRAWING ISSUED 03-07-19
ISSUE DATE:

MARK	DATE	DESCRIPTION


MARCH 7, 2019

PROJECT NO.: DRAWN BY: CHECKED BY:

SHEET NAME: LIGHTING FIXTURE SCHEDULE

SHEET NUMBER:

0 - Toriginal size

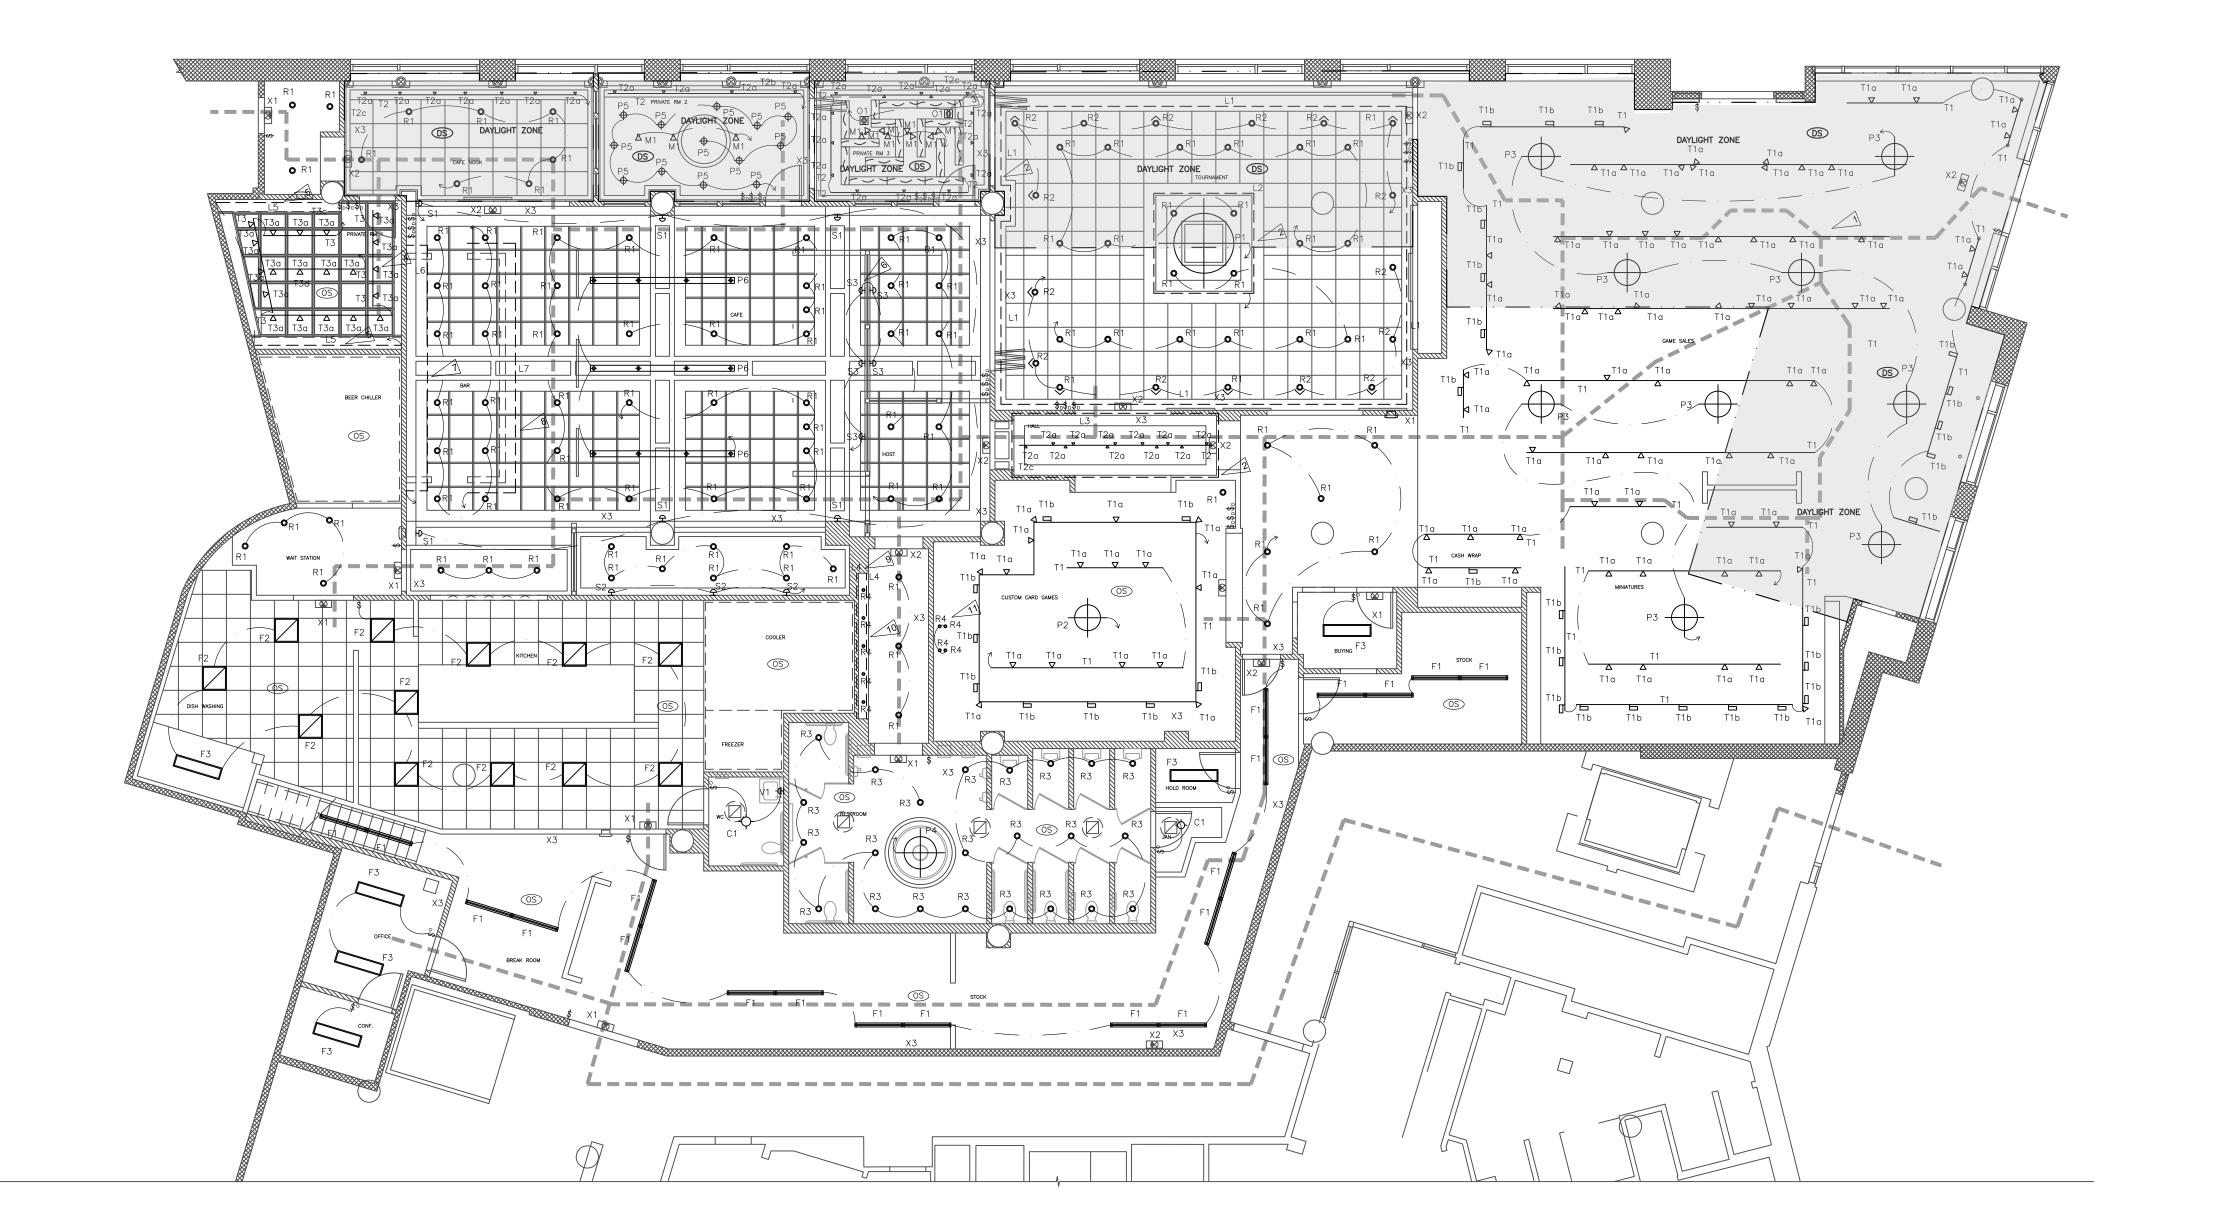

FIRST FLOOR LIGHTING PLAN

1 SCALE: 1/8" = 1'-0"

LIGHTING SYMBOL LEGEND

- RECESSED DOWNLIGHT
- 어 WALL MOUNTED CYLINDER DOWNLIGHT
- RECESSED FAN LIGHT
- ← SCONCE

 ← SCOOP UPLIGHT

 ← SCOOP
- a STEP LIGHT
- → SURFACE MOUNT
- → SURFACE MC
 → PENDANT

▼ TRACK HEAD

- 4 MONOPOINT
- TRACK/RAIL/LINEAR LED

SURFACE MOUNT WRAP

RECESSED 2X2 TROFFER

- WELL LIGHT
- HALF SWITCHED WALL OUTLET
- DUPLEX CEILING OUTLET
- LOW VOLTAGE TRANSFORMER/DRIVER⑤ CEILING MOUNTED OCCUPANCY SENSOR⑥ CEILING MOUNTED DAYLIGHT SENSOR
- \$ ON/OFF SWITCH \$ DIMMER SWITCH
- \$° OCCUPANCY / VACANCY SWITCH
- \$F FAN TIMER SWITCH
- \$3 WAY SWITCH
- \$* LIGHTING CONTROL KEYPAD

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OX BOARDING HOUSE

PHASE:

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THIS DRAWING ISSUED 03-07-19
ISSUE DATE:

MARCH 7, 2019

1		, =
MARK	DATE	DESCRIPTION

PROJECT NO.: 10136 DRAWN BY: CHECKED BY:


SHEET NAME:
LIGHTING PLAN

SHEET NUMBER:

LD0.2


GENERAL LIGHTING NOTES


- 1. ELECTRICAL CONTRACTOR SHALL BE RESPONSIBLE FOR COMPLIANCE WITH ALL APPLICABLE ENERGY CODES INCLUDING BUT NOT LIMITED TO DAYLIGHT CONTROL ZONES, OCCUPANCY SENSOR LOCATIONS AND TIME CONTROLS.
- 2. DAYLIGHT ZONES, DAYLIGHT SENSORS AND CIRCUITING SHOWN FOR INTENT. ELECTRICAL CONTRACTOR SHALL CONFIRM DAYLIGHT SENSOR LOCATIONS PRIOR TO INSTALLATION.
- 3. OCCUPANCY/VACANCY SENSOR SWITCHES SHOWN FOR INTENT. ELECTRICAL CONTRACTOR SHALL DETERMINE TYPE OF SENSOR (WALL, CEILING, ETC.) AND EXACT LOCATION OF ALL SENSORS.
- 4. LIGHTING CONTROL SYSTEM SHALL PROVIDE AUTOMATIC SHUTOFF CONTROL AS REQUIRED BY ENERGY CODE. REQUIREMENTS SHALL BE CONFIRMED BY ELECTRICAL CONTRACTOR.
- 5. EGRESS PATH SHOWN ON PLAN. EMERGENCY LIGHTING SHALL PROVIDE INITIAL ILLUMINATION OF NOT LESS THAN AN AVERAGE OF ONE FOOT CANDLE AND A MINIMUM AT ANY POINT OF 0.1 FOOT CANDLE MEASURED ALONG THE PATH OF EGRESS AT FLOOR LEVEL. ELECTRICAL CONTRACTOR SHALL BE RESPONSIBLE FOR COMPLIANCE WITH ALL EGRESS LIGHTING. EMERGENCY LIGHTING SHALL BE ON BATTERY BACKUP.
- 6. PROVIDE ADEQUATE BLOCKING FOR ALL FIXTURES PRIOR TO INSTALLATION.
- 7. ELECTRICAL CONTRACTOR SHALL CONFIRM COMPATIBILITY OF ALL DIMMERS WITH LIGHTING FIXTURE LAMP SOURCES, DRIVERS, TRANSFORMERS, AND BALLASTS PRIOR TO ORDER AND INSTALLATION.
- 8. SEE ARCHITECTURAL DRAWINGS AND FIXTURE SCHEDULE FOR MOUNTING HEIGHTS. CONTACT LIGHTING DESIGNER TO CONFIRM/RESOLVE ANY QUESTIONS ABOUT MOUNTING LOCATIONS AND/OR CONFLICTS WITH HVAC, SITE CONDITIONS, ETC.
- 9. CONFIRM DIMMING AND CONTROL SCENE REQUIREMENTS WITH OWNER AND ARCHITECT PRIOR TO INSTALLATION.
- 10. ELECTRICAL CONTRACTOR SHALL PROVIDE SUBMITTALS FOR ALL FIXTURES, AND CONTROL DEVICES, AND A CONTROL LAYOUT/PLAN FOR LIGHTING DESIGNER APPROVAL PRIOR TO ORDER, AND PRIOR TO ROUGH—IN. ANY PROPOSED FIXTURE SUBSTITUTIONS MUST BE APPROVED BY LIGHTING DESIGNER AND ARCHITECT PRIOR TO ORDER.
- 11. FIELD VERIFY LOCATIONS OF ALL DIMMERS, SWITCHES, AND KEYPADS WITH ARCHITECT PRIOR TO ROUGH-IN AND INSTALLATION.

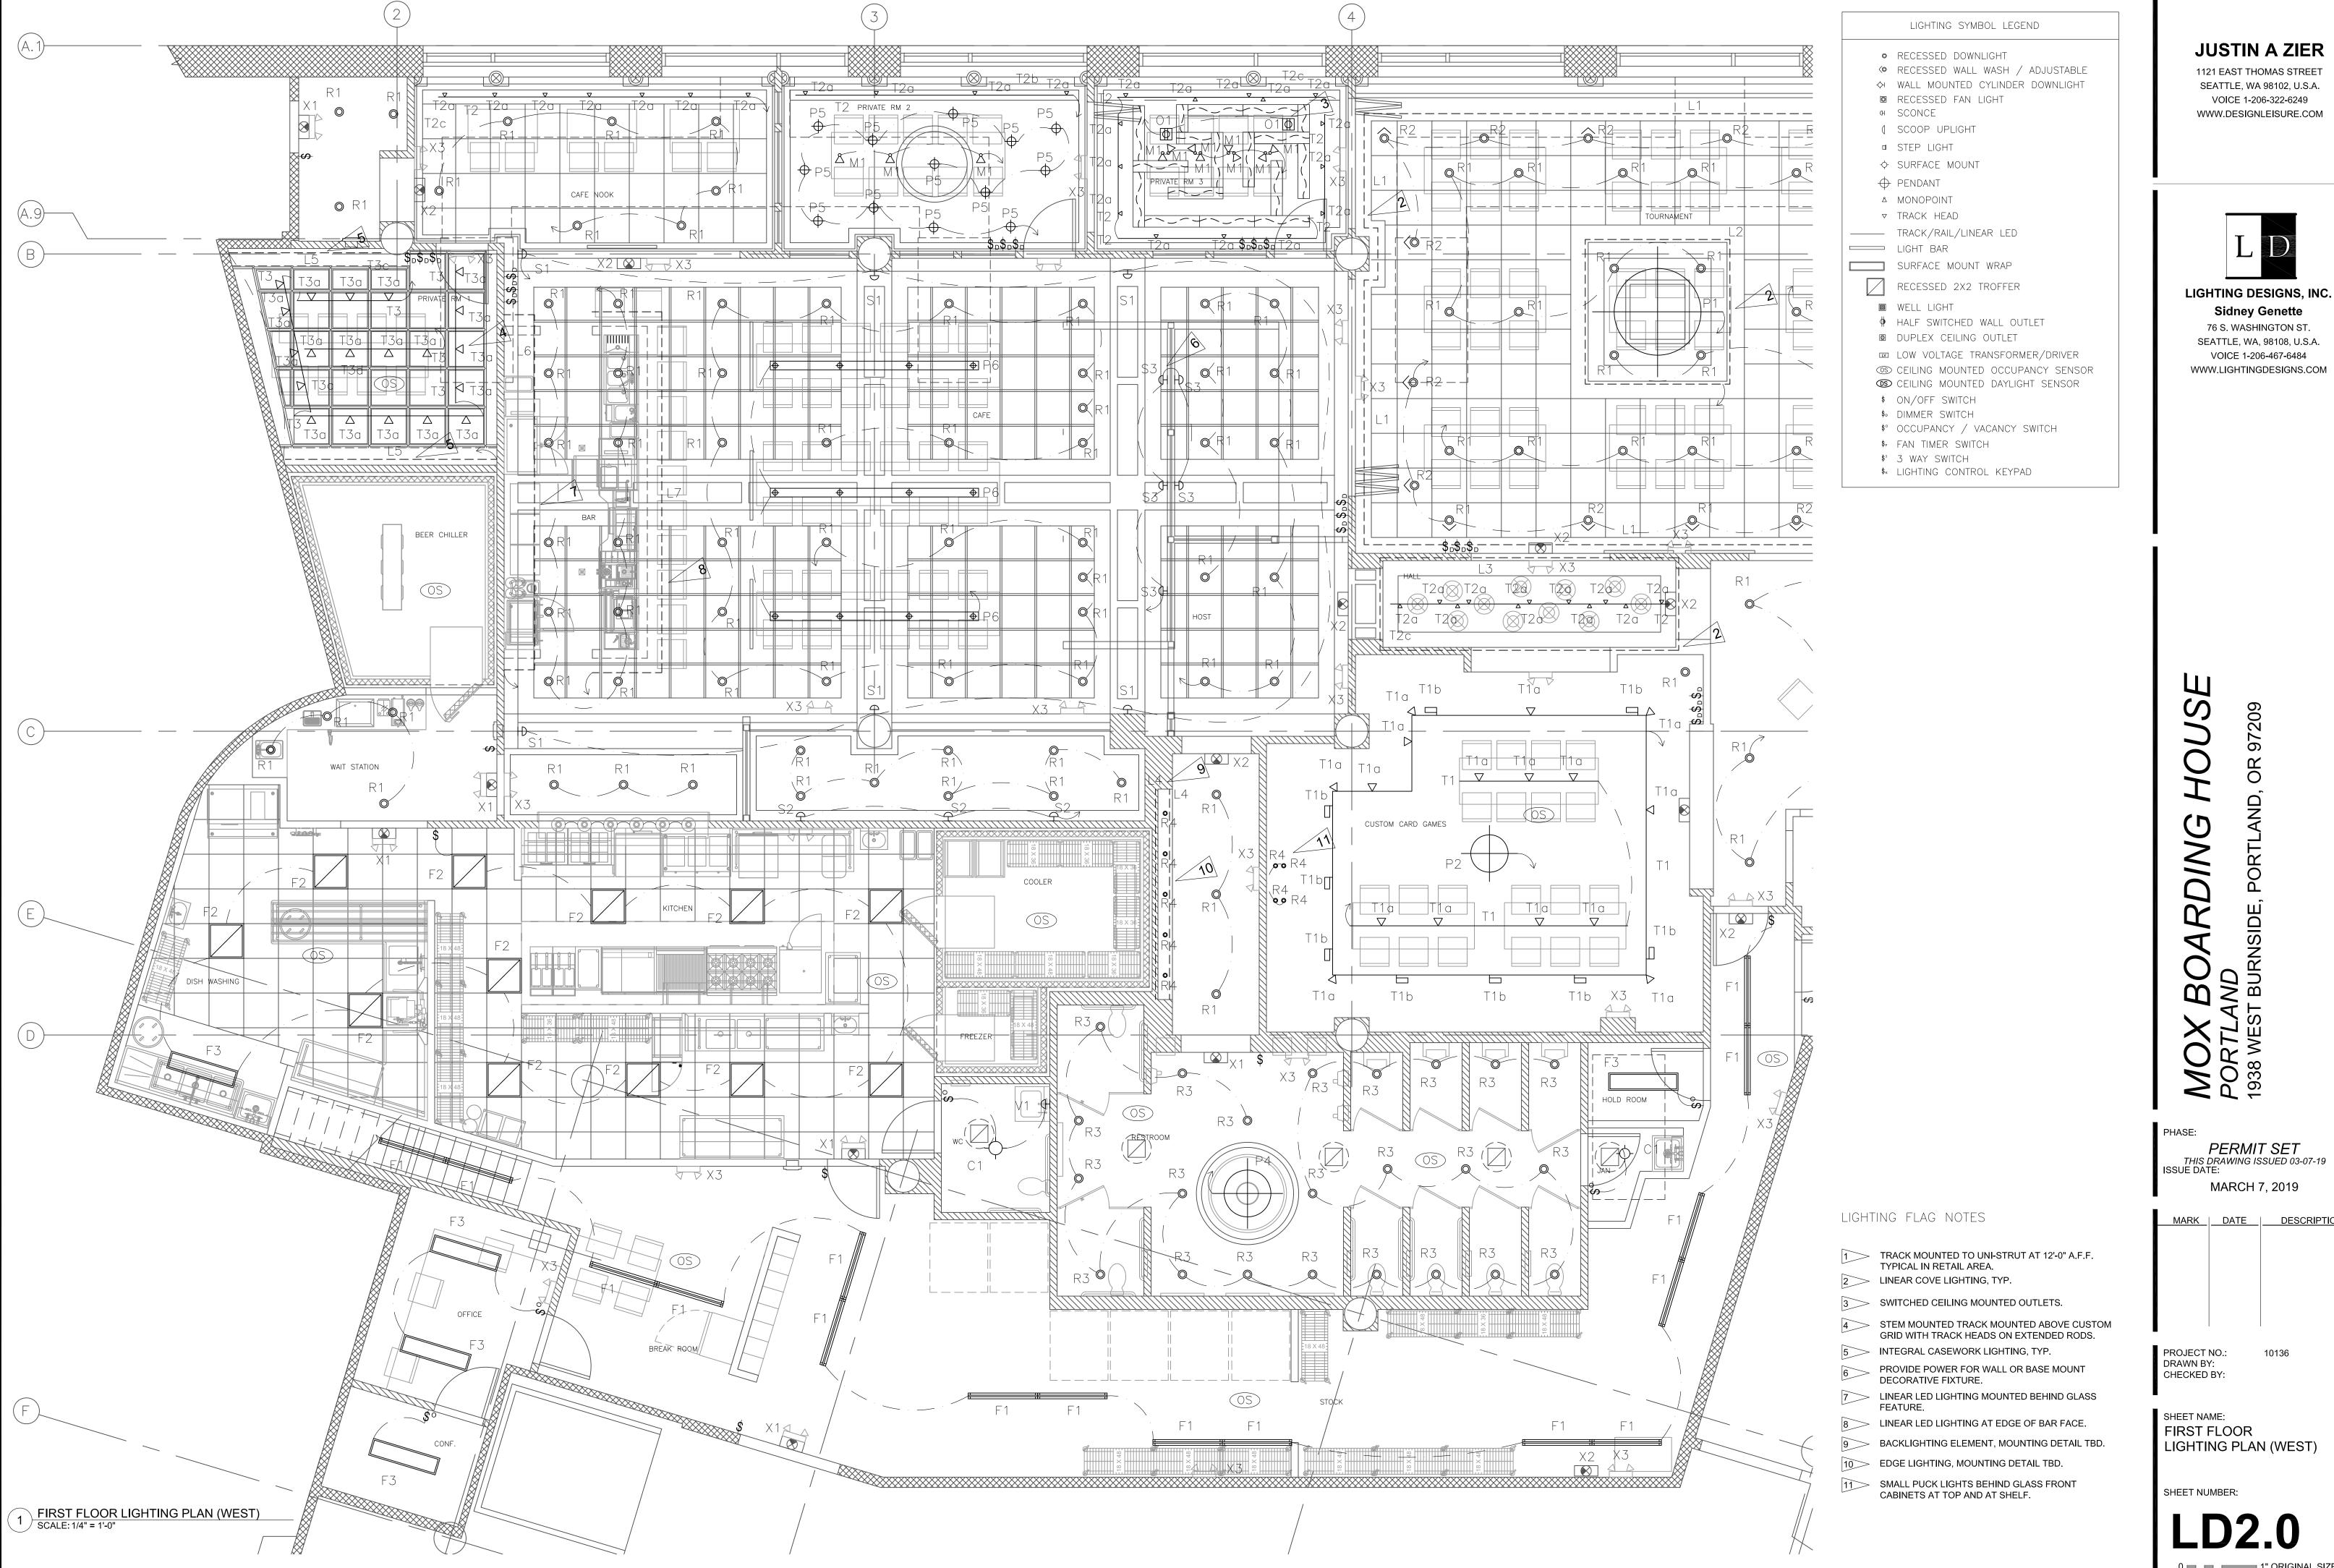

ISSUE DAT	E:						
MARCH 7, 2019							
MARK	DATE	DESCRIPTIO					

MARK	DATE	DESCRIPTION

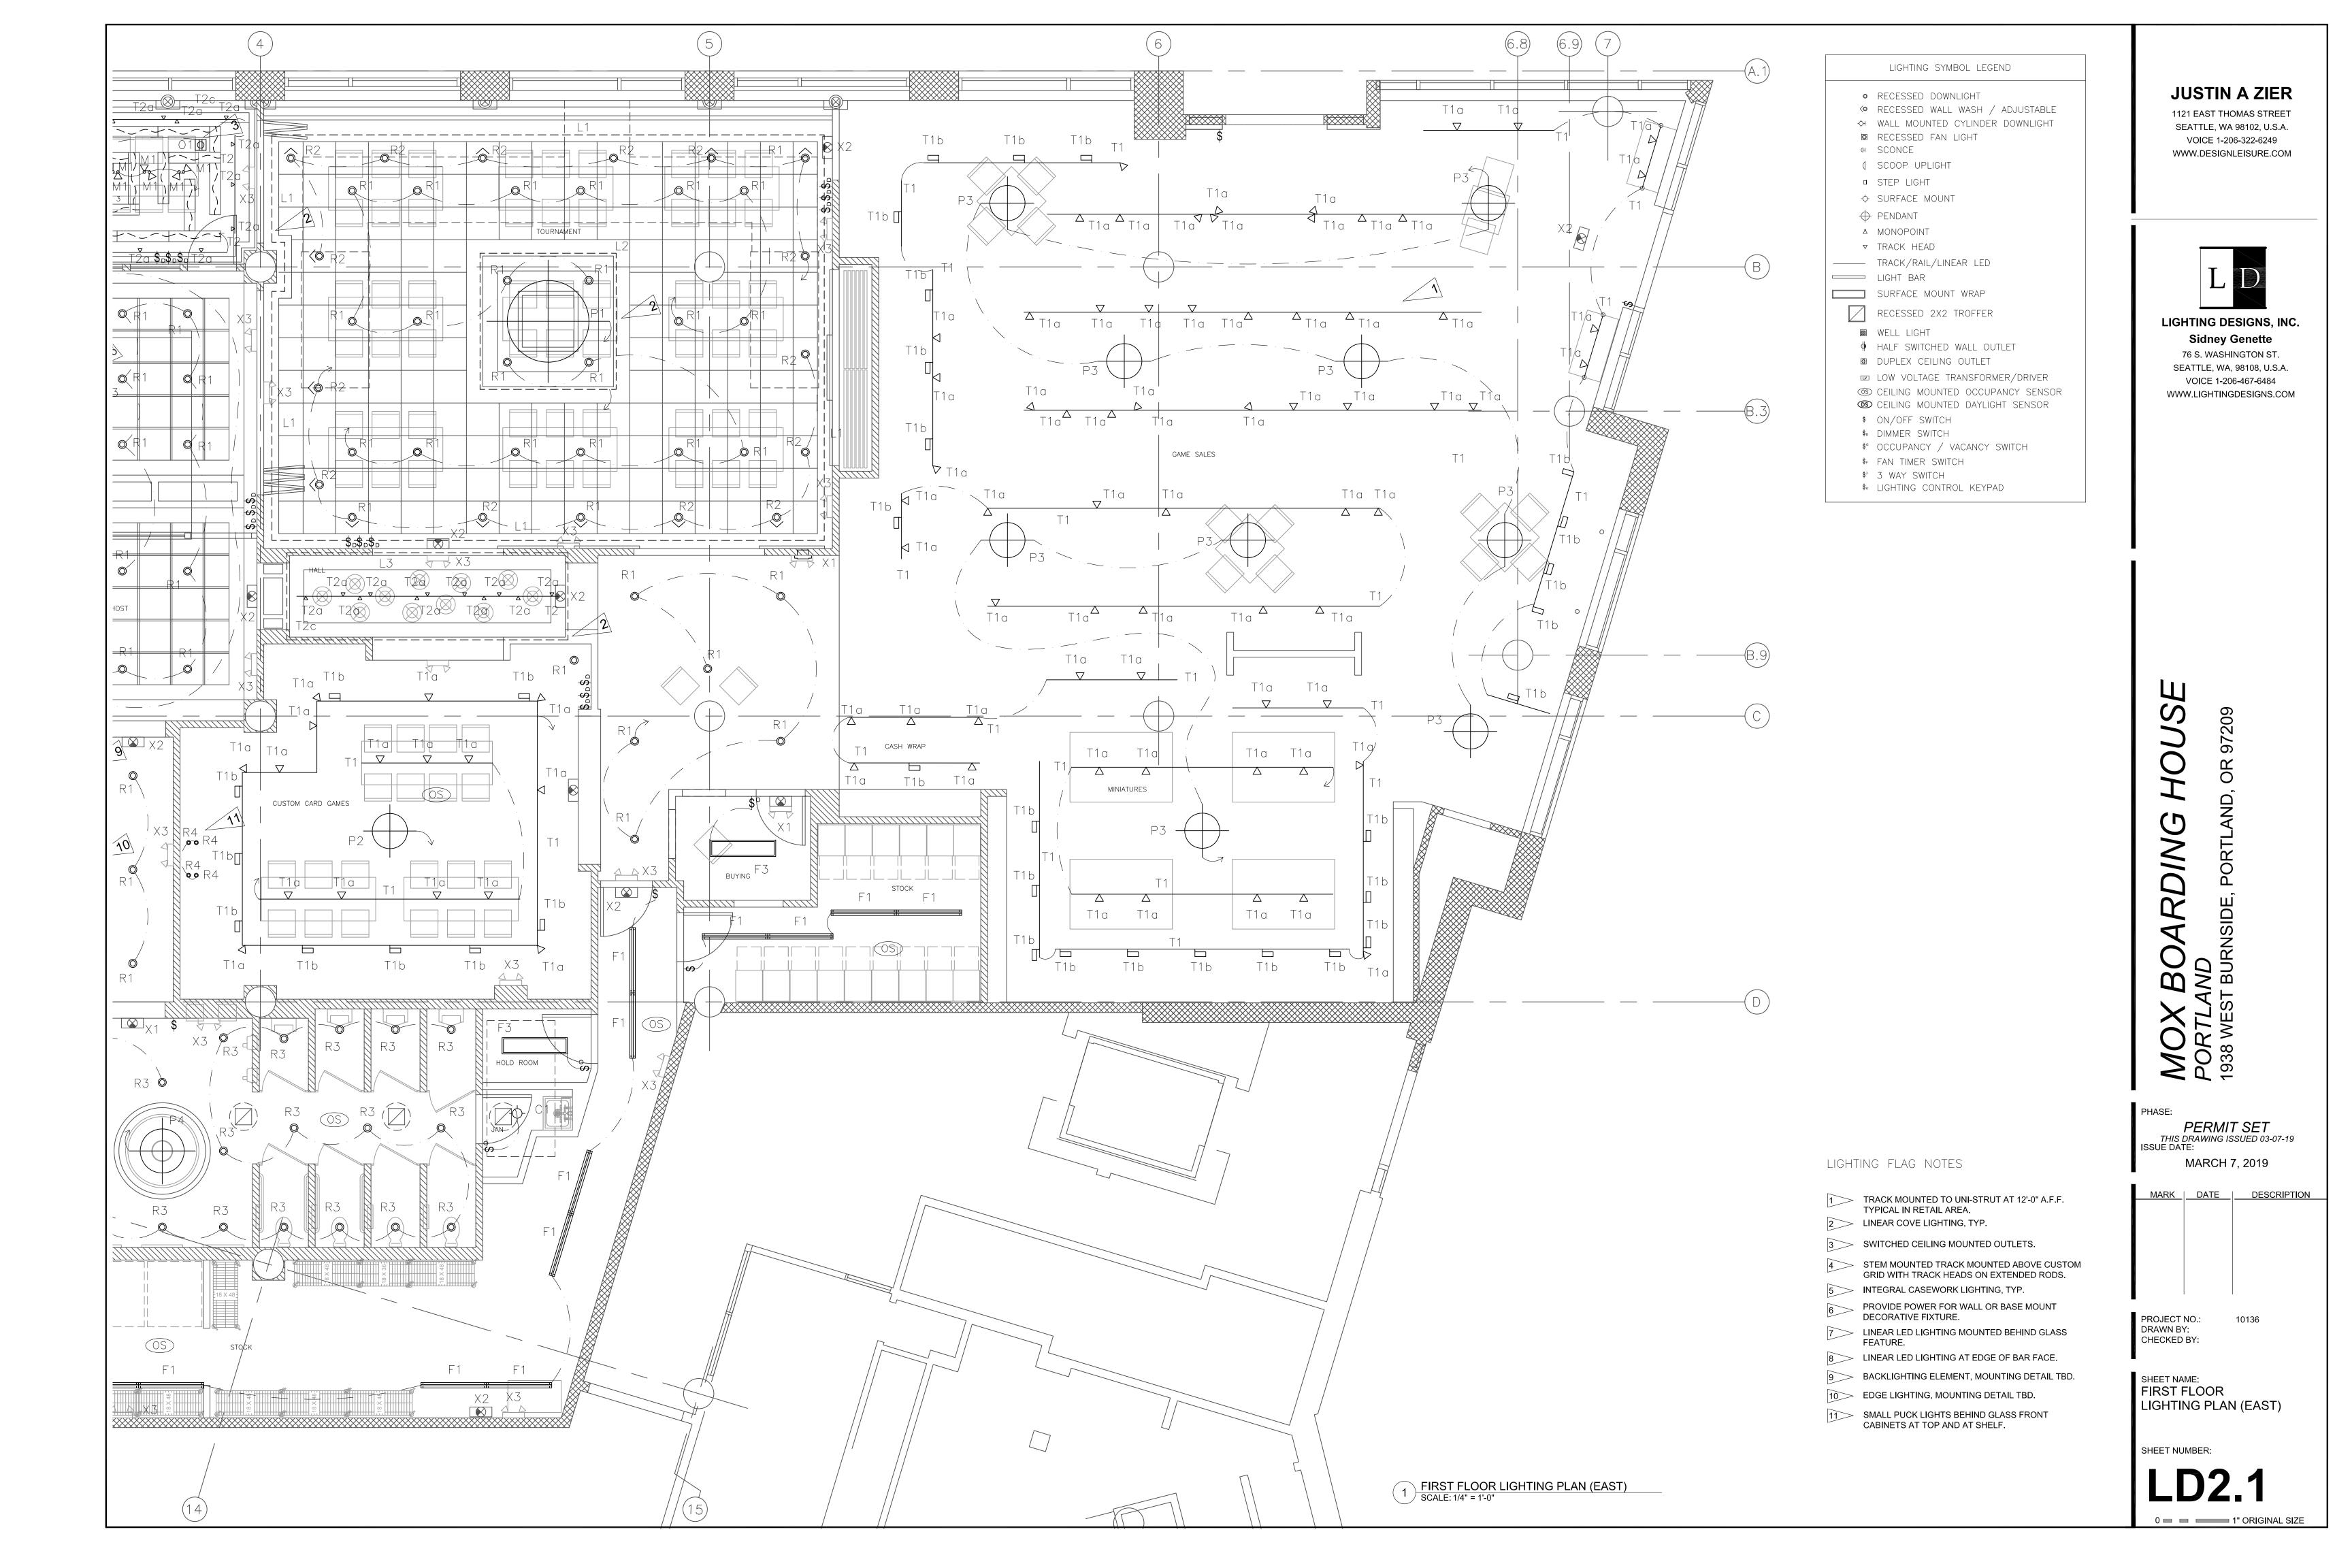

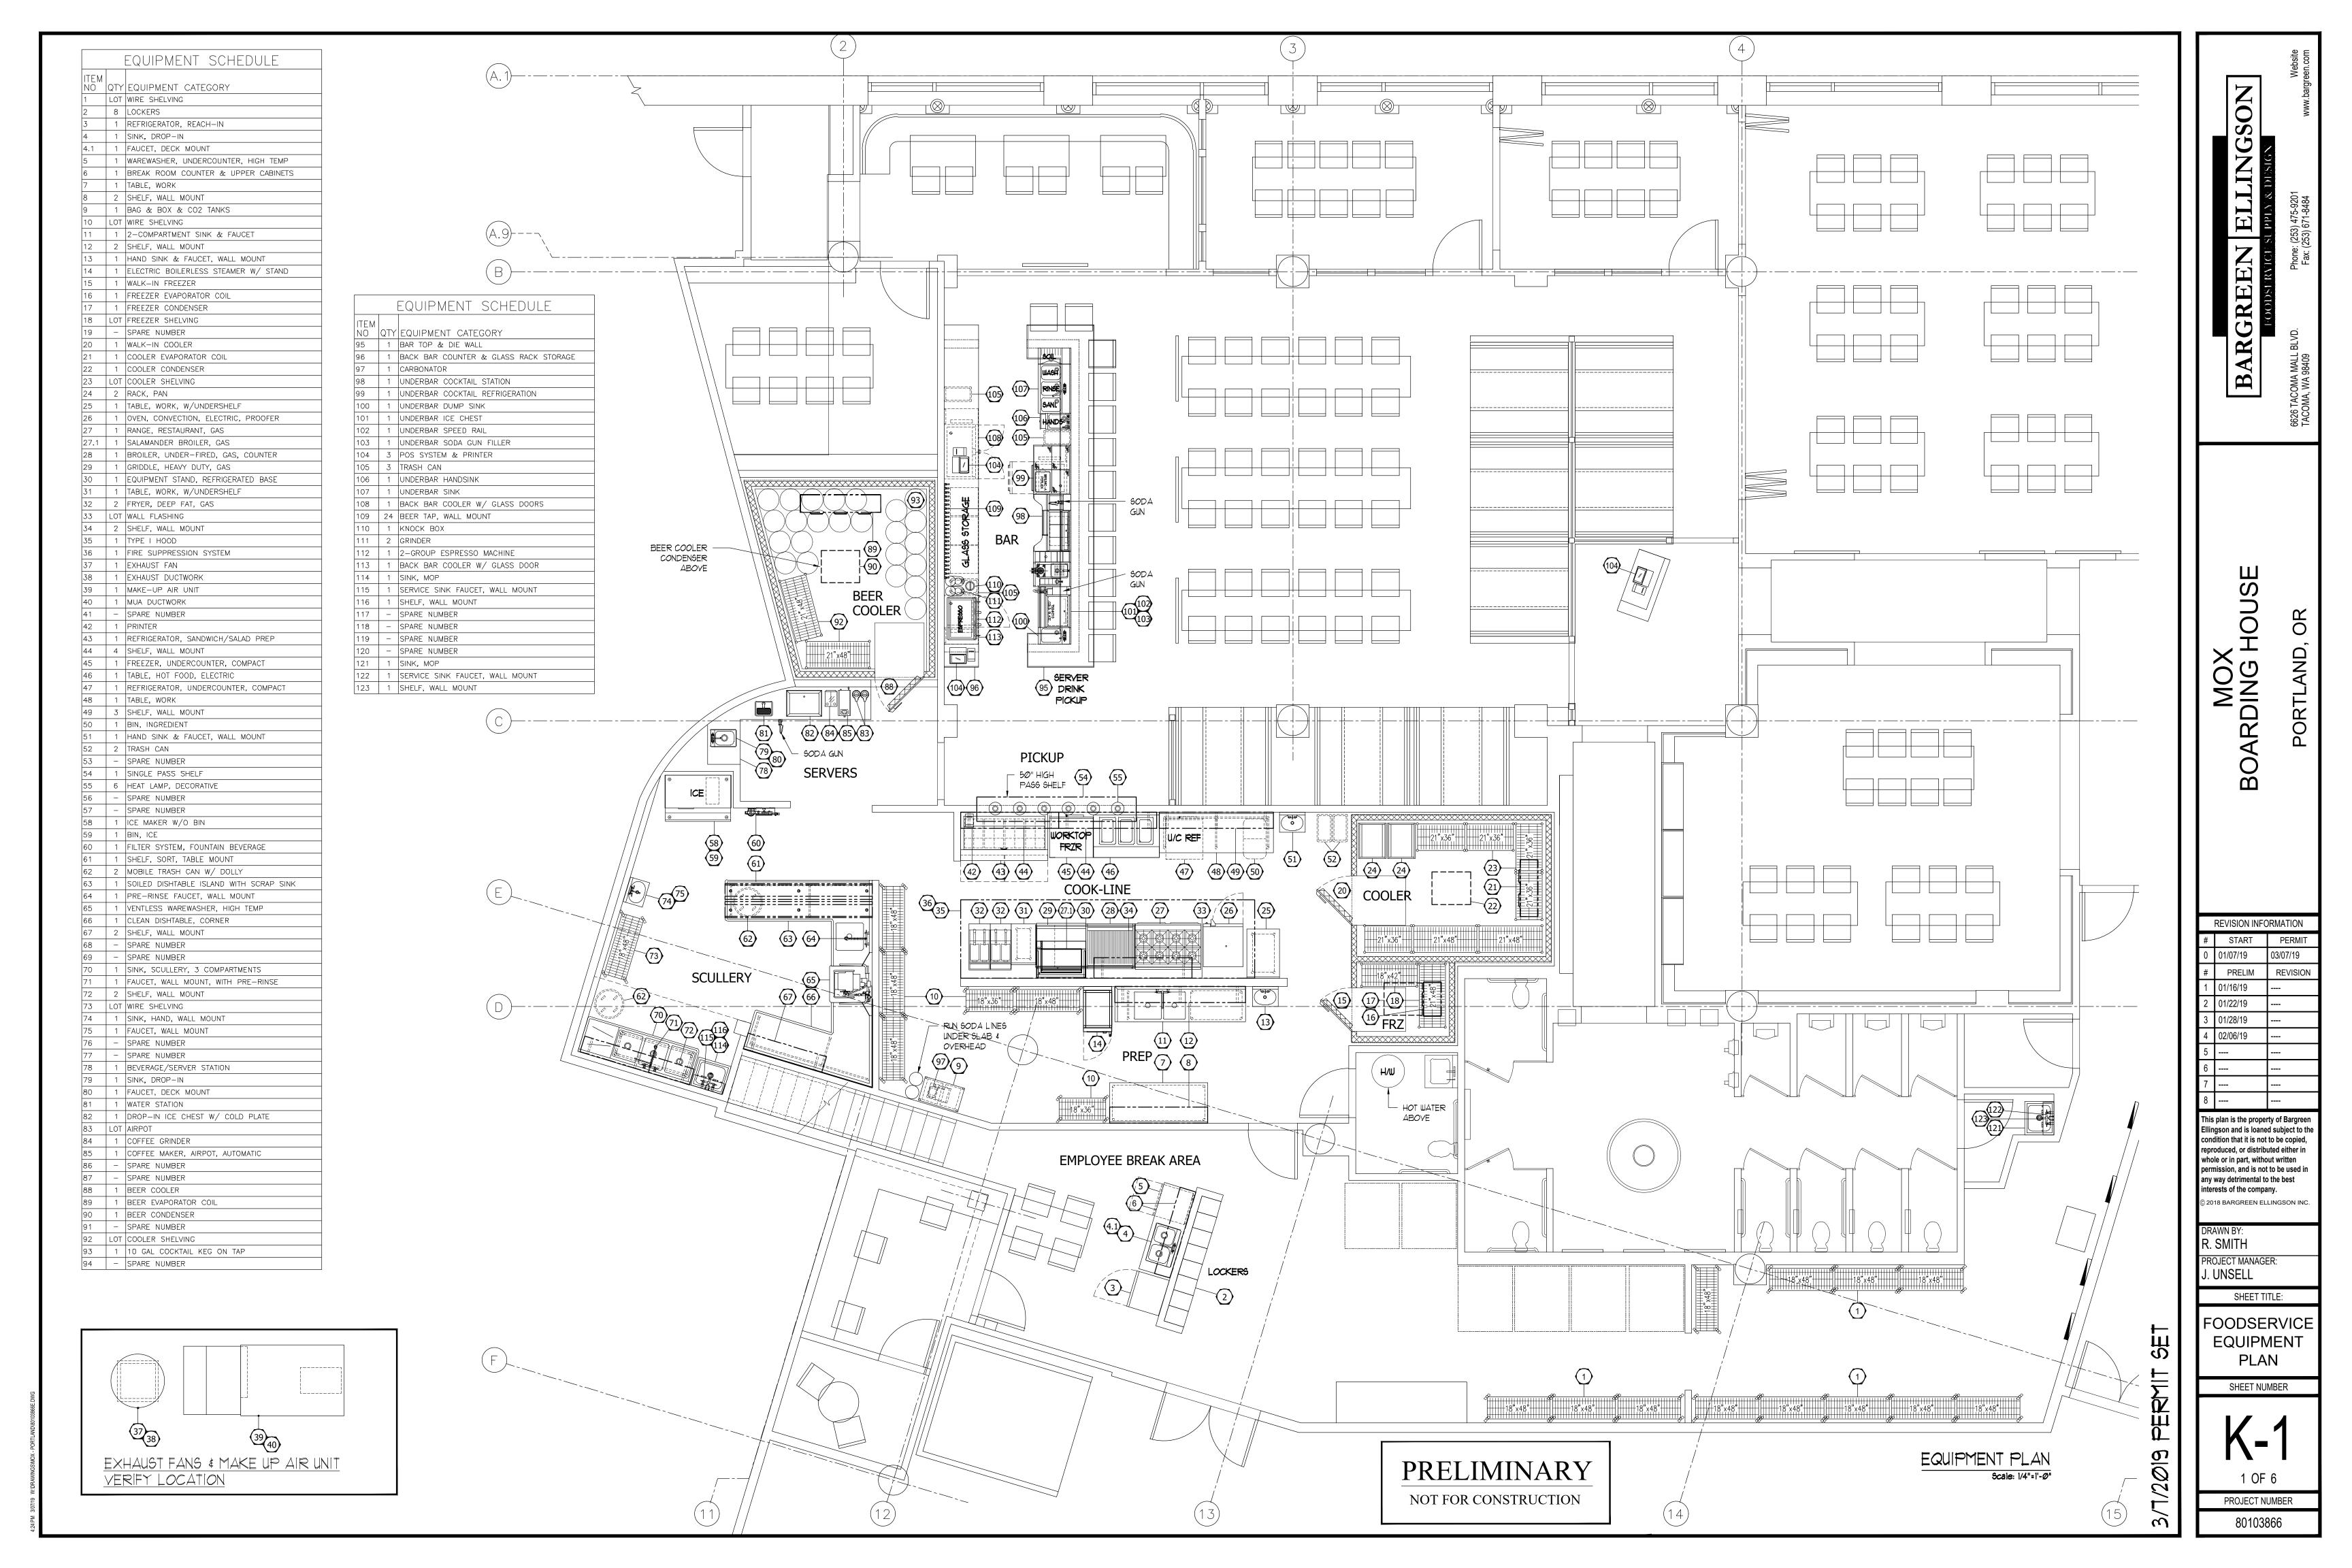

GENERAL NOTES

- I. IT SHALL BE NOTED BY THE GENERAL CONTRACTOR AND ALL SUB-CONTRACTORS THAT THIS SET OF PLANS AND THE INFORMATION CONTAINED WITHIN IN NO WAY RELIEVES SAID PARTIES OF THEIR RESPONSIBILITY TO INVESTIGATE AND COMPLY WITH ALL APPLICABLE CODES AND ORDINANCES AND TO PERFORM ALL WORK TO THE HIGHEST STANDARDS.
- 2. IT SHALL BE THE RESPONSIBILITY OF THE GENERAL CONTRACTOR AND ALL SUB-CONTRACTORS TO VERIFY THE ACTUAL SPACE AND MECHANICAL REQUIREMENTS OF ALL ITEMS SHOWN AS FUTURE, NIC, SUPPLIED BY "OTHERS", ETC., WITH THE OWNER PRIOR TO ROUGH-IN AND CONNECTION.
- 3. IT IS THE RESPONSIBILITY OF THE GENERAL CONTRACTOR TO IMMEDIATELY NOTIFY THE KITCHEN EQUIPMENT CONTRACTOR IN WRITING OF ANY CHANGES TO THE BUILDING THAT AFFECT EQUIPMENT PLACEMENT AND SIZES (I.E., WALL CHANGES, WATER HEATER LOCATIONS, ELECTRICAL PANELS, ETC).
- 4. SUITABLE WALL BACKING AS SHOWN ON THESE PLANS AND AS REQUIRED BY THE OWNER SHALL BE PROVIDED AND INSTALLED BY THE GENERAL CONTRACTOR.
- 5. THE GENERAL CONTRACTOR SHALL PROVIDE FLOOR, WALL, CEILING AND ROOF PENETRATIONS, INCLUDING, BUT NOT LIMITED TO THOSE REQUIRED FOR: MAKE-UP AIR, CLASS II EXHAUST DUCTS, FIRE-RATED SHAFTS FOR CLASS I EXHAUST DUCTS.
- 6. THE GENERAL CONTRACTOR SHALL PROVIDE CONDUIT AND SLEEVES FOR REFRIGERATION LINES, SYRUP, CARBON DIOXIDE GAS, BEER LINES, LIQUOR LINES, AND DATA LINES. CONDUIT SHALL BE CIRCULAR PVC EQUAL TO THE DIAMETER INDICATED ON PLANS. ALL BENDS SHALL HAVE A MINIMUM RADIUS OF TWENTY-FOUR INCHES.
- 1. THE GENERAL CONTRACTOR SHALL PROPERLY SEAL ALL WALL AND FLOOR PENETRATIONS AFTER THE INSTALLATION OF RELATED EQUIPMENT AND FURNISHING ITEMS.
- 8. ALL DIMENSIONS SHOWN ARE FROM FACE OF FINISHED WALL OR FLOOR.
- 9. ALL UTILITY ROUGH-INS SHOWN ON THESE PLANS ARE SUBJECT TO CHANGE PENDING FINAL EQUIPMENT SELECTION AND LOCATION.
- IØ. ALL UTILITY ROUGH-INS, FINAL CONNECTIONS, AND HOOK-UPS SHALL BE PROVIDED AND PERFORMED BY THE RESPECTIVE LICENSED SUB-CONTRACTORS IN COMPLIANCE WITH APPLICABLE NATIONAL AND LOCAL CODES.
- 11. SEISMIC BRACING INFORMATION, IF REQUIRED, IS NOT INDICATED ON THESE PLANS NOR IS IT PROVIDED BY THE KITCHEN EQUIPMENT CONTRACTOR UNLESS OTHERWISE SPECIFIED HEREIN.
- 12. WHERE EQUIPMENT PRODUCES NOISE THAT MAY VIBRATE THROUGH WALLS TO ANY PUBLIC AND/OR DINING AREAS, THE GENERAL CONTRACTOR SHALL PROVIDE AND INSTALL ADEQUATE SOUND PROOFING IN WALLS.

			EQUIP	MENT SCHEDULE					<u> </u>		1	1				
ITEM NO 1		EQUIPMENT CATEGORY WIRE SHELVING	MANUFACTURER BY OWNER	MODEL NUMBER BY OWNER	AMPS	AH.	VOLTS	PHASE	DIRECT	NEMA	COLD WATER SIZE (IN)	HOT WATER SIZE (IN)	DIRECT DRAIN SIZE (IN)	INDIR DRAIN SIZE (IN)	GAS SIZE (IN)	МВТОН
2	8	LOCKERS	BY OWNER	BY OWNER												
3	1	REFRIGERATOR, REACH-IN	BY OWNER	BY OWNER	VFY		VFY	1	X	VERIFY						
4	1	SINK, DROP-IN	BY OWNER	BY OWNER									VFY			
4.1 5	1	FAUCET, DECK MOUNT	BY OWNER BY OWNER	BY OWNER BY OWNER	VFY		VFY	1	X		VFY	VFY		VFY		
6	1	WAREWASHER, UNDERCOUNTER, HIGH TEMP BREAK ROOM COUNTER & UPPER CABINETS	MILLWORK	BY OTHERS	VET		VFT		^			VFY		VFT		
7	1	TABLE, WORK	FUTURE	FUTURE												
8	2	SHELF, WALL MOUNT	FUTURE	FUTURE												
9	1	BAG & BOX & CO2 TANKS	BY OTHERS	BY OTHERS												
10	LOT	WIRE SHELVING	CENTAUR	WIRE SHELVING UNIT												
11	1	2-COMPARTMENT SINK & FAUCET	EXISTING	BY OWNER							0.5	0.5		1.5		
12	2	SHELF, WALL MOUNT	PACIFIC STAINLESS PRODUCTS	WSH9612DD							0.5	0.5	4.5			
13 14	1	HAND SINK & FAUCET, WALL MOUNT ELECTRIC BOILERLESS STEAMER W/ STAND	EXISTING FUTURE (VULCAN)	BY OWNER FUTURE (MINI—JET)	14.9		208	3		L15-30F	0.5	0.5	1.5			
15	1	WALK-IN FREEZER	THERMAL RITE	CUSTOM	15.0		120	1	_	L13-301						
16	1	FREEZER EVAPORATOR COIL	THERMAL RITE	TBD	4.5		208-230	_	X					1		
17	1	FREEZER CONDENSER	THERMAL RITE	TBD	8.6		208-230	1	Х							
18	LOT	FREEZER SHELVING	CENTAUR	GREEN EPOXY SHELVING												
19	_	SPARE NUMBER														
20	1	WALK-IN COOLER	THERMAL RITE	CUSTOM	15.0		120	1								
21	1	COOLER EVAPORATOR COIL COOLER CONDENSER	THERMAL RITE	TBD	2.0		115		X					1		
22 23	LOT	COOLER SHELVING	THERMAL RITE CENTAUR	TBD GREEN EPOXY SHELVING	6.3		208-230	1	^					\vdash		
24		RACK, PAN	NEW AGE INDUSTRIAL	1331												
25	1	TABLE, WORK, W/UNDERSHELF	PACIFIC STAINLESS PRODUCTS	WKT2436A6S												
26	1	OVEN, CONVECTION, ELECTRIC, PROOFER	MOFFAT	E32D5-P8M	28.0		208	1	Х		0.75					
					11.6		120	1	X	5-15P	0.75					
27	1	RANGE, RESTAURANT, GAS	VULCAN	48SS-8B-N											1	286
27.1	1	SALAMANDER BROILER, GAS	VULCAN	36IRB-N										,	0.75	30
														+		
28	1	BROILER, UNDER-FIRED, GAS, COUNTER	VULCAN	VACB36	2.0		120	1		5 15D					0.75	102
29	1 1 1	GRIDDLE, HEAVY DUTY, GAS	VULCAN	VCCG36-AC	2.0		120	1		5-15P						102 90
29 30	1 1 1	GRIDDLE, HEAVY DUTY, GAS EQUIPMENT STAND, REFRIGERATED BASE	VULCAN DELFIELD		2.0		120 115	1		5-15P 5-15P					0.75	
29	1 1 1 1 2	GRIDDLE, HEAVY DUTY, GAS	VULCAN	VCCG36-AC F2973CP				1 1 1		5-15P					0.75	
29 30 31	1 1 1 1 2 LOT	GRIDDLE, HEAVY DUTY, GAS EQUIPMENT STAND, REFRIGERATED BASE TABLE, WORK, W/UNDERSHELF	VULCAN DELFIELD PACIFIC STAINLESS PRODUCTS	VCCG36-AC F2973CP WKT1830A4S	2.9		115	1 1 1	X	5-15P					0.75	90
29 30 31 32 33 34		GRIDDLE, HEAVY DUTY, GAS EQUIPMENT STAND, REFRIGERATED BASE TABLE, WORK, W/UNDERSHELF FRYER, DEEP FAT, GAS WALL FLASHING SHELF, WALL MOUNT	VULCAN DELFIELD PACIFIC STAINLESS PRODUCTS EXISTING PACIFIC PACIFIC STAINLESS PRODUCTS	VCCG36-AC F2973CP WKT1830A4S BY OWNER CUSTOM STAINLESS WSH7215DD	2.9		115 VFY	1 1 1	X	5-15P					0.75	90
29 30 31 32 33 34 35	LOT	GRIDDLE, HEAVY DUTY, GAS EQUIPMENT STAND, REFRIGERATED BASE TABLE, WORK, W/UNDERSHELF FRYER, DEEP FAT, GAS WALL FLASHING SHELF, WALL MOUNT TYPE I HOOD	VULCAN DELFIELD PACIFIC STAINLESS PRODUCTS EXISTING PACIFIC PACIFIC STAINLESS PRODUCTS EXISTING	VCCG36-AC F2973CP WKT1830A4S BY OWNER CUSTOM STAINLESS WSH7215DD BY OWNER	2.9 VFY		115 VFY VFY		X	5-15P					0.75	90
29 30 31 32 33 34 35 36	LOT	GRIDDLE, HEAVY DUTY, GAS EQUIPMENT STAND, REFRIGERATED BASE TABLE, WORK, W/UNDERSHELF FRYER, DEEP FAT, GAS WALL FLASHING SHELF, WALL MOUNT TYPE I HOOD FIRE SUPPRESSION SYSTEM	VULCAN DELFIELD PACIFIC STAINLESS PRODUCTS EXISTING PACIFIC PACIFIC STAINLESS PRODUCTS EXISTING EXISTING EXISTING	VCCG36-AC F2973CP WKT1830A4S BY OWNER CUSTOM STAINLESS WSH7215DD BY OWNER BY OWNER	VFY VFY VFY		VFY VFY VFY	1	X X X X	5-15P					0.75	90
29 30 31 32 33 34 35 36 37	LOT	GRIDDLE, HEAVY DUTY, GAS EQUIPMENT STAND, REFRIGERATED BASE TABLE, WORK, W/UNDERSHELF FRYER, DEEP FAT, GAS WALL FLASHING SHELF, WALL MOUNT TYPE I HOOD FIRE SUPPRESSION SYSTEM EXHAUST FAN	VULCAN DELFIELD PACIFIC STAINLESS PRODUCTS EXISTING PACIFIC PACIFIC STAINLESS PRODUCTS EXISTING EXISTING EXISTING BY OWNER	VCCG36-AC F2973CP WKT1830A4S BY OWNER CUSTOM STAINLESS WSH7215DD BY OWNER BY OWNER BY OWNER	2.9 VFY		VFY VFY VFY		X X X X	5-15P					0.75	90
29 30 31 32 33 34 35 36	LOT	GRIDDLE, HEAVY DUTY, GAS EQUIPMENT STAND, REFRIGERATED BASE TABLE, WORK, W/UNDERSHELF FRYER, DEEP FAT, GAS WALL FLASHING SHELF, WALL MOUNT TYPE I HOOD FIRE SUPPRESSION SYSTEM	VULCAN DELFIELD PACIFIC STAINLESS PRODUCTS EXISTING PACIFIC PACIFIC STAINLESS PRODUCTS EXISTING EXISTING EXISTING	VCCG36-AC F2973CP WKT1830A4S BY OWNER CUSTOM STAINLESS WSH7215DD BY OWNER BY OWNER	VFY VFY VFY		VFY VFY VFY	1	X X X X X	5-15P					0.75	90
29 30 31 32 33 34 35 36 37 38	LOT	GRIDDLE, HEAVY DUTY, GAS EQUIPMENT STAND, REFRIGERATED BASE TABLE, WORK, W/UNDERSHELF FRYER, DEEP FAT, GAS WALL FLASHING SHELF, WALL MOUNT TYPE I HOOD FIRE SUPPRESSION SYSTEM EXHAUST FAN EXHAUST DUCTWORK	VULCAN DELFIELD PACIFIC STAINLESS PRODUCTS EXISTING PACIFIC PACIFIC STAINLESS PRODUCTS EXISTING EXISTING EXISTING BY OWNER BY HVAC	VCCG36-AC F2973CP WKT1830A4S BY OWNER CUSTOM STAINLESS WSH7215DD BY OWNER BY OWNER BY OWNER BY OWNER BY OWNER	2.9 VFY VFY VFY VFY		VFY VFY VFY VFY	1 VFY	X X X X X	5-15P					0.75	90
29 30 31 32 33 34 35 36 37 38 39 40 41	LOT	GRIDDLE, HEAVY DUTY, GAS EQUIPMENT STAND, REFRIGERATED BASE TABLE, WORK, W/UNDERSHELF FRYER, DEEP FAT, GAS WALL FLASHING SHELF, WALL MOUNT TYPE I HOOD FIRE SUPPRESSION SYSTEM EXHAUST FAN EXHAUST DUCTWORK MAKE—UP AIR UNIT MUA DUCTWORK SPARE NUMBER	VULCAN DELFIELD PACIFIC STAINLESS PRODUCTS EXISTING PACIFIC PACIFIC STAINLESS PRODUCTS EXISTING EXISTING EXISTING BY OWNER BY HVAC BY OWNER	VCCG36-AC F2973CP WKT1830A4S BY OWNER CUSTOM STAINLESS WSH7215DD BY OWNER BY OWNER BY OWNER BY OWNER BY OWNER BY HVAC BY OWNER BY HVAC	VFY VFY VFY VFY VFY		VFY VFY VFY VFY	1 VFY	X	5-15P VFY					0.75	90
29 30 31 32 33 34 35 36 37 38 39 40 41	LOT 2 1 1 1 1 1 1 1 1	GRIDDLE, HEAVY DUTY, GAS EQUIPMENT STAND, REFRIGERATED BASE TABLE, WORK, W/UNDERSHELF FRYER, DEEP FAT, GAS WALL FLASHING SHELF, WALL MOUNT TYPE I HOOD FIRE SUPPRESSION SYSTEM EXHAUST FAN EXHAUST DUCTWORK MAKE—UP AIR UNIT MUA DUCTWORK SPARE NUMBER PRINTER	VULCAN DELFIELD PACIFIC STAINLESS PRODUCTS EXISTING PACIFIC PACIFIC STAINLESS PRODUCTS EXISTING EXISTING BY OWNER BY HVAC BY OWNER BY HVAC BY OWNER BY HVAC BY OWNER	VCCG36-AC F2973CP WKT1830A4S BY OWNER CUSTOM STAINLESS WSH7215DD BY OWNER BY OWNER BY OWNER BY OWNER BY OWNER BY HVAC BY OWNER BY HVAC BY OWNER	2.9 VFY VFY VFY VFY 15.0		VFY VFY VFY VFY	1 VFY	X X X X X	5-15P VFY					0.75	90
29 30 31 32 33 34 35 36 37 38 39 40 41 42 43	LOT 2 1 1 1 1 1 1 1 1 1 1 1 1 1 1 1	GRIDDLE, HEAVY DUTY, GAS EQUIPMENT STAND, REFRIGERATED BASE TABLE, WORK, W/UNDERSHELF FRYER, DEEP FAT, GAS WALL FLASHING SHELF, WALL MOUNT TYPE I HOOD FIRE SUPPRESSION SYSTEM EXHAUST FAN EXHAUST DUCTWORK MAKE-UP AIR UNIT MUA DUCTWORK SPARE NUMBER PRINTER REFRIGERATOR, SANDWICH/SALAD PREP	VULCAN DELFIELD PACIFIC STAINLESS PRODUCTS EXISTING PACIFIC PACIFIC STAINLESS PRODUCTS EXISTING EXISTING BY OWNER BY HVAC BY OWNER BY HVAC BY OWNER BY HVAC BY OWNER BY HVAC	VCCG36-AC F2973CP WKT1830A4S BY OWNER CUSTOM STAINLESS WSH7215DD BY OWNER BY OWNER BY OWNER BY OWNER BY OWNER BY HVAC BY OWNER BY HVAC BY OWNER BY HVAC BY OWNER BY HVAC	VFY VFY VFY VFY VFY	0.5	VFY VFY VFY VFY VFY	1 VFY VFY	X	5-15P VFY					0.75	90
29 30 31 32 33 34 35 36 37 38 39 40 41 42 43 44	LOT 2 1 1 1 1 1 1 1 1	GRIDDLE, HEAVY DUTY, GAS EQUIPMENT STAND, REFRIGERATED BASE TABLE, WORK, W/UNDERSHELF FRYER, DEEP FAT, GAS WALL FLASHING SHELF, WALL MOUNT TYPE I HOOD FIRE SUPPRESSION SYSTEM EXHAUST FAN EXHAUST DUCTWORK MAKE—UP AIR UNIT MUA DUCTWORK SPARE NUMBER PRINTER REFRIGERATOR, SANDWICH/SALAD PREP SHELF, WALL MOUNT	VULCAN DELFIELD PACIFIC STAINLESS PRODUCTS EXISTING PACIFIC PACIFIC STAINLESS PRODUCTS EXISTING EXISTING BY OWNER BY OWNER BY HVAC BY HVAC BY OWNER DELFIELD PACIFIC STAINLESS PRODUCTS	VCCG36-AC F2973CP WKT1830A4S BY OWNER CUSTOM STAINLESS WSH7215DD BY OWNER BY OWNER BY OWNER BY OWNER BY HVAC BY OWNER BY HVAC BY OWNER BY HVAC BY OWNER BY HVAC	2.9 VFY VFY VFY VFY 15.0 12.0		VFY VFY VFY VFY 120 115	1 VFY VFY	X	5-15P VFY 5-15P					0.75	90
29 30 31 32 33 34 35 36 37 38 39 40 41 42 43 44 45	LOT 2 1 1 1 1 1 1 1 1 1 1 1 1 1 1 1	GRIDDLE, HEAVY DUTY, GAS EQUIPMENT STAND, REFRIGERATED BASE TABLE, WORK, W/UNDERSHELF FRYER, DEEP FAT, GAS WALL FLASHING SHELF, WALL MOUNT TYPE I HOOD FIRE SUPPRESSION SYSTEM EXHAUST FAN EXHAUST DUCTWORK MAKE—UP AIR UNIT MUA DUCTWORK SPARE NUMBER PRINTER REFRIGERATOR, SANDWICH/SALAD PREP SHELF, WALL MOUNT FREEZER, UNDERCOUNTER, COMPACT	VULCAN DELFIELD PACIFIC STAINLESS PRODUCTS EXISTING PACIFIC PACIFIC STAINLESS PRODUCTS EXISTING EXISTING BY OWNER BY HVAC BY OWNER BY HVAC BY OWNER DELFIELD PACIFIC STAINLESS PRODUCTS PACIFIC STAINLESS PRODUCTS DELFIELD	VCCG36-AC F2973CP WKT1830A4S BY OWNER CUSTOM STAINLESS WSH7215DD BY OWNER BY OWNER BY OWNER BY OWNER BY HVAC	2.9 VFY VFY VFY VFY 15.0 12.0 2.6	0.5	VFY VFY VFY VFY 120 115	1 VFY VFY	X	5-15P VFY 5-15P 5-15P	0.5			VFY	0.75	90
29 30 31 32 33 34 35 36 37 38 39 40 41 42 43 44 45 46	LOT 2 1 1 1 1 1 1 1 1 1 1 1 1 1 1 1	GRIDDLE, HEAVY DUTY, GAS EQUIPMENT STAND, REFRIGERATED BASE TABLE, WORK, W/UNDERSHELF FRYER, DEEP FAT, GAS WALL FLASHING SHELF, WALL MOUNT TYPE I HOOD FIRE SUPPRESSION SYSTEM EXHAUST FAN EXHAUST DUCTWORK MAKE—UP AIR UNIT MUA DUCTWORK SPARE NUMBER PRINTER REFRIGERATOR, SANDWICH/SALAD PREP SHELF, WALL MOUNT FREEZER, UNDERCOUNTER, COMPACT TABLE, HOT FOOD, ELECTRIC	VULCAN DELFIELD PACIFIC STAINLESS PRODUCTS EXISTING PACIFIC PACIFIC STAINLESS PRODUCTS EXISTING EXISTING BY OWNER BY OWNER BY HVAC BY HVAC BY OWNER DELFIELD PACIFIC STAINLESS PRODUCTS	VCCG36-AC F2973CP WKT1830A4S BY OWNER CUSTOM STAINLESS WSH7215DD BY OWNER BY OWNER BY OWNER BY OWNER BY HVAC BY OWNER BY HVAC BY OWNER BY HVAC BY OWNER BY HVAC	2.9 VFY VFY VFY VFY 15.0 12.0	0.3	VFY VFY VFY VFY 120 115	1 VFY VFY	X	5-15P VFY 5-15P 5-15P 6-20P	0.5			VFY	0.75	90
29 30 31 32 33 34 35 36 37 38 39 40 41 42 43 44 45	LOT 2 1 1 1 1 1 1 1 1 1 1 1 1 1 1 1	GRIDDLE, HEAVY DUTY, GAS EQUIPMENT STAND, REFRIGERATED BASE TABLE, WORK, W/UNDERSHELF FRYER, DEEP FAT, GAS WALL FLASHING SHELF, WALL MOUNT TYPE I HOOD FIRE SUPPRESSION SYSTEM EXHAUST FAN EXHAUST DUCTWORK MAKE—UP AIR UNIT MUA DUCTWORK SPARE NUMBER PRINTER REFRIGERATOR, SANDWICH/SALAD PREP SHELF, WALL MOUNT FREEZER, UNDERCOUNTER, COMPACT	VULCAN DELFIELD PACIFIC STAINLESS PRODUCTS EXISTING PACIFIC PACIFIC STAINLESS PRODUCTS EXISTING EXISTING BY OWNER BY OWNER BY HVAC BY OWNER BY HVAC BY OWNER DELFIELD PACIFIC STAINLESS PRODUCTS PACIFIC STAINLESS PRODUCTS DELFIELD DELFIELD	VCCG36-AC F2973CP WKT1830A4S BY OWNER CUSTOM STAINLESS WSH7215DD BY OWNER BY OWNER BY OWNER BY OWNER BY HVAC	2.9 VFY VFY VFY VFY 15.0 12.0 2.6 15.0		VFY VFY VFY VFY 120 115 115 208	1 VFY VFY	X	5-15P VFY 5-15P 5-15P 6-20P	0.5			VFY	0.75	90
29 30 31 32 33 34 35 36 37 38 39 40 41 42 43 44 45 46 47	LOT 2 1 1 1 1 1 1 1 1 1 1 1 1 1 1 1	GRIDDLE, HEAVY DUTY, GAS EQUIPMENT STAND, REFRIGERATED BASE TABLE, WORK, W/UNDERSHELF FRYER, DEEP FAT, GAS WALL FLASHING SHELF, WALL MOUNT TYPE I HOOD FIRE SUPPRESSION SYSTEM EXHAUST FAN EXHAUST DUCTWORK MAKE—UP AIR UNIT MUA DUCTWORK SPARE NUMBER PRINTER REFRIGERATOR, SANDWICH/SALAD PREP SHELF, WALL MOUNT FREEZER, UNDERCOUNTER, COMPACT TABLE, HOT FOOD, ELECTRIC REFRIGERATOR, UNDERCOUNTER, COMPACT	VULCAN DELFIELD PACIFIC STAINLESS PRODUCTS EXISTING PACIFIC PACIFIC STAINLESS PRODUCTS EXISTING EXISTING BY OWNER BY OWNER BY HVAC BY OWNER BY HVAC BY OWNER DELFIELD DELFIELD DELFIELD DELFIELD	VCCG36-AC F2973CP WKT1830A4S BY OWNER CUSTOM STAINLESS WSH7215DD BY OWNER BY OWNER BY OWNER BY OWNER BY HVAC BY OWNER D4464N-24M WSH7212DD GUF32BP-D EHEI48C GUR27BP-D	2.9 VFY VFY VFY VFY 15.0 12.0 2.6 15.0	0.3	VFY VFY VFY VFY 120 115 115 208	1 VFY VFY	X	5-15P VFY 5-15P 5-15P 6-20P	0.5			VFY	0.75	90
29 30 31 32 33 34 35 36 37 38 39 40 41 42 43 44 45 46 47 48 49 50	LOT 2 1 1 1 1 1 1 1 1 1 1 1 1 1 1 1 1 1 1	GRIDDLE, HEAVY DUTY, GAS EQUIPMENT STAND, REFRIGERATED BASE TABLE, WORK, W/UNDERSHELF FRYER, DEEP FAT, GAS WALL FLASHING SHELF, WALL MOUNT TYPE I HOOD FIRE SUPPRESSION SYSTEM EXHAUST FAN EXHAUST DUCTWORK MAKE—UP AIR UNIT MUA DUCTWORK SPARE NUMBER PRINTER REFRIGERATOR, SANDWICH/SALAD PREP SHELF, WALL MOUNT FREEZER, UNDERCOUNTER, COMPACT TABLE, HOT FOOD, ELECTRIC REFRIGERATOR, UNDERCOUNTER, COMPACT TABLE, WORK SHELF, WALL MOUNT BIN, INGREDIENT	VULCAN DELFIELD PACIFIC STAINLESS PRODUCTS EXISTING PACIFIC STAINLESS PRODUCTS EXISTING EXISTING BY OWNER BY OWNER BY HVAC BY OWNER BY HVAC BY OWNER DELFIELD PACIFIC STAINLESS PRODUCTS DELFIELD PACIFIC STAINLESS PRODUCTS PACIFIC STAINLESS PRODUCTS CAMBRO	VCCG36-AC F2973CP WKT1830A4S BY OWNER CUSTOM STAINLESS WSH7215DD BY OWNER BY OWNER BY OWNER BY OWNER BY HVAC BY OWNER BY HVAC BY OWNER BY HVAC BY OWNER GURSTER D4464N-24M WSH7212DD GUF32BP-D EHEI48C GUR27BP-D WKT8430A4O WSH8412DD IBS27148	2.9 VFY VFY VFY VFY 15.0 12.0 2.6 15.0	0.3	VFY VFY VFY VFY 120 115 115 208	1 VFY VFY	X	5-15P VFY 5-15P 5-15P 6-20P				VFY	0.75	90
29 30 31 32 33 34 35 36 37 38 39 40 41 42 43 44 45 46 47 48 49 50 51	LOT 2 1 1 1 1 1 1 1 1 1 1 1 1 1 1 1 1 1 1	GRIDDLE, HEAVY DUTY, GAS EQUIPMENT STAND, REFRIGERATED BASE TABLE, WORK, W/UNDERSHELF FRYER, DEEP FAT, GAS WALL FLASHING SHELF, WALL MOUNT TYPE I HOOD FIRE SUPPRESSION SYSTEM EXHAUST FAN EXHAUST DUCTWORK MAKE—UP AIR UNIT MUA DUCTWORK SPARE NUMBER PRINTER REFRIGERATOR, SANDWICH/SALAD PREP SHELF, WALL MOUNT FREEZER, UNDERCOUNTER, COMPACT TABLE, HOT FOOD, ELECTRIC REFRIGERATOR, UNDERCOUNTER, COMPACT TABLE, WORK SHELF, WALL MOUNT BIN, INGREDIENT HAND SINK & FAUCET, WALL MOUNT	VULCAN DELFIELD PACIFIC STAINLESS PRODUCTS EXISTING PACIFIC PACIFIC STAINLESS PRODUCTS EXISTING EXISTING BY OWNER BY HVAC BY OWNER BY HVAC BY OWNER DELFIELD PACIFIC STAINLESS PRODUCTS DELFIELD DELFIELD PACIFIC STAINLESS PRODUCTS PACIFIC STAINLESS PRODUCTS CAMBRO EXISTING	VCCG36-AC F2973CP WKT1830A4S BY OWNER CUSTOM STAINLESS WSH7215DD BY OWNER BY OWNER BY OWNER BY OWNER BY HVAC BY OWNER D4464N-24M WSH7212DD GUF32BP-D EHEI48C GUR27BP-D WKT8430A4O WSH8412DD IBS27148 BY OWNER	2.9 VFY VFY VFY VFY 15.0 12.0 2.6 15.0	0.3	VFY VFY VFY VFY 120 115 115 208	1 VFY VFY	X	5-15P VFY 5-15P 5-15P 6-20P	0.5	0.5	1.5	VFY	0.75	90
29 30 31 32 33 34 35 36 37 38 39 40 41 42 43 44 45 46 47 48 49 50 51 52	LOT 2 1 1 1 1 1 1 1 1 1 1 1 1 1 1 1 1 1 1	GRIDDLE, HEAVY DUTY, GAS EQUIPMENT STAND, REFRIGERATED BASE TABLE, WORK, W/UNDERSHELF FRYER, DEEP FAT, GAS WALL FLASHING SHELF, WALL MOUNT TYPE I HOOD FIRE SUPPRESSION SYSTEM EXHAUST FAN EXHAUST DUCTWORK MAKE—UP AIR UNIT MUA DUCTWORK SPARE NUMBER PRINTER REFRIGERATOR, SANDWICH/SALAD PREP SHELF, WALL MOUNT FREEZER, UNDERCOUNTER, COMPACT TABLE, HOT FOOD, ELECTRIC REFRIGERATOR, UNDERCOUNTER, COMPACT TABLE, WORK SHELF, WALL MOUNT BIN, INGREDIENT HAND SINK & FAUCET, WALL MOUNT TRASH CAN	VULCAN DELFIELD PACIFIC STAINLESS PRODUCTS EXISTING PACIFIC STAINLESS PRODUCTS EXISTING EXISTING BY OWNER BY OWNER BY HVAC BY OWNER BY HVAC BY OWNER DELFIELD PACIFIC STAINLESS PRODUCTS DELFIELD PACIFIC STAINLESS PRODUCTS PACIFIC STAINLESS PRODUCTS CAMBRO	VCCG36-AC F2973CP WKT1830A4S BY OWNER CUSTOM STAINLESS WSH7215DD BY OWNER BY OWNER BY OWNER BY OWNER BY HVAC BY OWNER BY HVAC BY OWNER BY HVAC BY OWNER GURSTER D4464N-24M WSH7212DD GUF32BP-D EHEI48C GUR27BP-D WKT8430A4O WSH8412DD IBS27148	2.9 VFY VFY VFY VFY 15.0 12.0 2.6 15.0	0.3	VFY VFY VFY VFY 120 115 115 208	1 VFY VFY	X	5-15P VFY 5-15P 5-15P 6-20P		0.5	1.5	VFY	0.75	90
29 30 31 32 33 34 35 36 37 38 39 40 41 42 43 44 45 46 47 48 49 50 51 52 53	LOT 2 1 1 1 1 1 1 1 1 1 1 1 1 1 1 1 1 1 1	GRIDDLE, HEAVY DUTY, GAS EQUIPMENT STAND, REFRIGERATED BASE TABLE, WORK, W/UNDERSHELF FRYER, DEEP FAT, GAS WALL FLASHING SHELF, WALL MOUNT TYPE I HOOD FIRE SUPPRESSION SYSTEM EXHAUST FAN EXHAUST DUCTWORK MAKE—UP AIR UNIT MUA DUCTWORK SPARE NUMBER PRINTER REFRIGERATOR, SANDWICH/SALAD PREP SHELF, WALL MOUNT FREEZER, UNDERCOUNTER, COMPACT TABLE, HOT FOOD, ELECTRIC REFRIGERATOR, UNDERCOUNTER, COMPACT TABLE, WORK SHELF, WALL MOUNT BIN, INGREDIENT HAND SINK & FAUCET, WALL MOUNT TRASH CAN SPARE NUMBER	VULCAN DELFIELD PACIFIC STAINLESS PRODUCTS EXISTING PACIFIC STAINLESS PRODUCTS EXISTING EXISTING BY OWNER BY OWNER BY HVAC BY OWNER BY HVAC BY OWNER DELFIELD PACIFIC STAINLESS PRODUCTS DELFIELD DELFIELD PACIFIC STAINLESS PRODUCTS PACIFIC STAINLESS PRODUCTS CAMBRO EXISTING RUBBERMAID	VCCG36-AC F2973CP WKT1830A4S BY OWNER CUSTOM STAINLESS WSH7215DD BY OWNER BY OWNER BY OWNER BY OWNER BY HVAC BY OWNER BY HVAC BY OWNER BY HVAC BY OWNER GUF32BP-D EHEI48C GUR27BP-D WKT8430A4O WSH8412DD IBS27148 BY OWNER SLIM JIM	2.9 VFY VFY VFY VFY 15.0 12.0 2.6 15.0	0.3	VFY VFY VFY VFY 120 115 115 208	1 VFY VFY	X	5-15P VFY 5-15P 5-15P 6-20P		0.5	1.5	VFY	0.75	90
29 30 31 32 33 34 35 36 37 38 39 40 41 42 43 44 45 46 47 48 49 50 51 52 53 54	LOT 2 1 1 1 1 1 1 1 1 1 1 1 1 1 1 1 1 1 1	GRIDDLE, HEAVY DUTY, GAS EQUIPMENT STAND, REFRIGERATED BASE TABLE, WORK, W/UNDERSHELF FRYER, DEEP FAT, GAS WALL FLASHING SHELF, WALL MOUNT TYPE I HOOD FIRE SUPPRESSION SYSTEM EXHAUST FAN EXHAUST DUCTWORK MAKE—UP AIR UNIT MUA DUCTWORK SPARE NUMBER PRINTER REFRIGERATOR, SANDWICH/SALAD PREP SHELF, WALL MOUNT FREEZER, UNDERCOUNTER, COMPACT TABLE, HOT FOOD, ELECTRIC REFRIGERATOR, UNDERCOUNTER, COMPACT TABLE, WORK SHELF, WALL MOUNT BIN, INGREDIENT HAND SINK & FAUCET, WALL MOUNT TRASH CAN	VULCAN DELFIELD PACIFIC STAINLESS PRODUCTS EXISTING PACIFIC PACIFIC STAINLESS PRODUCTS EXISTING EXISTING BY OWNER BY HVAC BY OWNER BY HVAC BY OWNER DELFIELD PACIFIC STAINLESS PRODUCTS DELFIELD DELFIELD PACIFIC STAINLESS PRODUCTS PACIFIC STAINLESS PRODUCTS CAMBRO EXISTING	VCCG36-AC F2973CP WKT1830A4S BY OWNER CUSTOM STAINLESS WSH7215DD BY OWNER BY OWNER BY OWNER BY OWNER BY HVAC BY OWNER D4464N-24M WSH7212DD GUF32BP-D EHEI48C GUR27BP-D WKT8430A4O WSH8412DD IBS27148 BY OWNER	2.9 VFY VFY VFY VFY 15.0 12.0 2.6 15.0 3.2	0.3	VFY VFY VFY VFY 120 115 115 208	1 VFY VFY 1 1 1 1 1 1 1 1 1 1 1 1 1 1 1 1 1 1 1	X	5-15P VFY 5-15P 5-15P 6-20P		0.5	1.5	VFY	0.75	90
29 30 31 32 33 34 35 36 37 38 39 40 41 42 43 44 45 46 47 48 49 50 51 52 53 54 55 56	LOT 2 1 1 1 1 1 1 1 1 1 1 1 1 1 1 1 1 1 1	GRIDDLE, HEAVY DUTY, GAS EQUIPMENT STAND, REFRIGERATED BASE TABLE, WORK, W/UNDERSHELF FRYER, DEEP FAT, GAS WALL FLASHING SHELF, WALL MOUNT TYPE I HOOD FIRE SUPPRESSION SYSTEM EXHAUST FAN EXHAUST DUCTWORK MAKE—UP AIR UNIT MUA DUCTWORK SPARE NUMBER PRINTER REFRIGERATOR, SANDWICH/SALAD PREP SHELF, WALL MOUNT FREEZER, UNDERCOUNTER, COMPACT TABLE, HOT FOOD, ELECTRIC REFRIGERATOR, UNDERCOUNTER, COMPACT TABLE, WORK SHELF, WALL MOUNT BIN, INGREDIENT HAND SINK & FAUCET, WALL MOUNT TRASH CAN SPARE NUMBER SINGLE PASS SHELF	VULCAN DELFIELD PACIFIC STAINLESS PRODUCTS EXISTING PACIFIC STAINLESS PRODUCTS EXISTING EXISTING BY OWNER BY OWNER BY HVAC BY OWNER BY HVAC BY OWNER DELFIELD PACIFIC STAINLESS PRODUCTS DELFIELD DELFIELD PACIFIC STAINLESS PRODUCTS PACIFIC STAINLESS PRODUCTS PACIFIC STAINLESS PRODUCTS CAMBRO EXISTING RUBBERMAID	VCCG36-AC F2973CP WKT1830A4S BY OWNER CUSTOM STAINLESS WSH7215DD BY OWNER BY OWNER BY OWNER BY OWNER BY HVAC BY OWNER BY HVAC BY OWNER BY HVAC BY OWNER GUF32BP-D EHEI48C GUR27BP-D WKT8430A4O WSH8412DD IBS27148 BY OWNER SLIM JIM CUSTOM	2.9 VFY VFY VFY VFY 15.0 12.0 2.6 15.0	0.3	VFY VFY VFY VFY 120 115 115 208 115	1 VFY VFY 1 1 1 1 1 1 1 1 1 1 1 1 1 1 1 1 1 1 1	X	5-15P VFY 5-15P 5-15P 6-20P		0.5	1.5	VFY	0.75	90
29 30 31 32 33 34 35 36 37 38 39 40 41 42 43 44 45 46 47 48 49 50 51 52 53 54 55 56 57	LOT 2 1 1 1 1 1 1 1 1 1 1 1 1 1 1 1 1 1 1	GRIDDLE, HEAVY DUTY, GAS EQUIPMENT STAND, REFRIGERATED BASE TABLE, WORK, W/UNDERSHELF FRYER, DEEP FAT, GAS WALL FLASHING SHELF, WALL MOUNT TYPE I HOOD FIRE SUPPRESSION SYSTEM EXHAUST FAN EXHAUST DUCTWORK MAKE—UP AIR UNIT MUA DUCTWORK SPARE NUMBER PRINTER REFRIGERATOR, SANDWICH/SALAD PREP SHELF, WALL MOUNT FREEZER, UNDERCOUNTER, COMPACT TABLE, HOT FOOD, ELECTRIC REFRIGERATOR, UNDERCOUNTER, COMPACT TABLE, WORK SHELF, WALL MOUNT BIN, INGREDIENT HAND SINK & FAUCET, WALL MOUNT TRASH CAN SPARE NUMBER SINGLE PASS SHELF HEAT LAMP, DECORATIVE SPARE NUMBER SPARE NUMBER	VULCAN DELFIELD PACIFIC STAINLESS PRODUCTS EXISTING PACIFIC STAINLESS PRODUCTS EXISTING EXISTING BY OWNER BY OWNER BY HVAC BY OWNER BY HVAC BY OWNER DELFIELD PACIFIC STAINLESS PRODUCTS DELFIELD DELFIELD PACIFIC STAINLESS PRODUCTS PACIFIC STAINLESS PRODUCTS PACIFIC STAINLESS PRODUCTS CAMBRO EXISTING RUBBERMAID	VCCG36-AC F2973CP WKT1830A4S BY OWNER CUSTOM STAINLESS WSH7215DD BY OWNER BY OWNER BY OWNER BY OWNER BY HVAC BY OWNER BY HVAC BY OWNER BY HVAC BY OWNER GUF32BP-D EHEI48C GUR27BP-D WKT8430A4O WSH8412DD IBS27148 BY OWNER SLIM JIM CUSTOM	2.9 VFY VFY VFY VFY 15.0 12.0 2.6 15.0 3.2	0.3	VFY VFY VFY VFY 120 115 115 208 115	1 VFY VFY 1 1 1 1 1 1 1 1 1 1 1 1 1 1 1 1 1 1 1	X	5-15P VFY 5-15P 5-15P 6-20P	0.5		1.5	VFY	0.75	90
29 30 31 32 33 34 35 36 37 38 39 40 41 42 43 44 45 46 47 48 49 50 51 52 53 54 55 56 57 58	LOT 2 1 1 1 1 1 1 1 1 1 1 1 1 1 1 1 1 1 1	GRIDDLE, HEAVY DUTY, GAS EQUIPMENT STAND, REFRIGERATED BASE TABLE, WORK, W/UNDERSHELF FRYER, DEEP FAT, GAS WALL FLASHING SHELF, WALL MOUNT TYPE I HOOD FIRE SUPPRESSION SYSTEM EXHAUST FAN EXHAUST DUCTWORK MAKE—UP AIR UNIT MUA DUCTWORK SPARE NUMBER PRINTER REFRIGERATOR, SANDWICH/SALAD PREP SHELF, WALL MOUNT FREEZER, UNDERCOUNTER, COMPACT TABLE, HOT FOOD, ELECTRIC REFRIGERATOR, UNDERCOUNTER, COMPACT TABLE, WORK SHELF, WALL MOUNT BIN, INGREDIENT HAND SINK & FAUCET, WALL MOUNT TRASH CAN SPARE NUMBER SINGLE PASS SHELF HEAT LAMP, DECORATIVE SPARE NUMBER ICE MAKER W/O BIN	VULCAN DELFIELD PACIFIC STAINLESS PRODUCTS EXISTING PACIFIC PACIFIC STAINLESS PRODUCTS EXISTING EXISTING BY OWNER BY HVAC BY OWNER BY HVAC BY OWNER DELFIELD PACIFIC STAINLESS PRODUCTS DELFIELD DELFIELD DELFIELD PACIFIC STAINLESS PRODUCTS PACIFIC STAINLESS PRODUCTS CAMBRO EXISTING RUBBERMAID STAINLESS HATCO	VCCG36-AC F2973CP WKT1830A4S BY OWNER CUSTOM STAINLESS WSH7215DD BY OWNER BY OWNER BY OWNER BY OWNER BY HVAC BY OWNER BY HVAC BY OWNER BY HVAC BY OWNER GUF32BP-D EHEI48C GUR27BP-D WKT8430A4O WSH8412DD IBS27148 BY OWNER SLIM JIM CUSTOM DLH-725-SR	2.9 VFY VFY VFY VFY 15.0 12.0 2.6 15.0 3.2	0.3	VFY VFY VFY VFY 120 115 115 208 115	1 VFY VFY 1 1 1 1 1 1 1 1 1 1 1 1 1 1 1 1 1 1 1	X	5-15P VFY 5-15P 5-15P 6-20P			1.5	0.75	0.75	90
29 30 31 32 33 34 35 36 37 38 39 40 41 42 43 44 45 46 47 48 49 50 51 52 53 54 55 56 57	LOT 2 1 1 1 1 1 1 1 1 1 1 1 1 1 1 1 1 1 1	GRIDDLE, HEAVY DUTY, GAS EQUIPMENT STAND, REFRIGERATED BASE TABLE, WORK, W/UNDERSHELF FRYER, DEEP FAT, GAS WALL FLASHING SHELF, WALL MOUNT TYPE I HOOD FIRE SUPPRESSION SYSTEM EXHAUST FAN EXHAUST DUCTWORK MAKE—UP AIR UNIT MUA DUCTWORK SPARE NUMBER PRINTER REFRIGERATOR, SANDWICH/SALAD PREP SHELF, WALL MOUNT FREEZER, UNDERCOUNTER, COMPACT TABLE, HOT FOOD, ELECTRIC REFRIGERATOR, UNDERCOUNTER, COMPACT TABLE, WORK SHELF, WALL MOUNT BIN, INGREDIENT HAND SINK & FAUCET, WALL MOUNT TRASH CAN SPARE NUMBER SINGLE PASS SHELF HEAT LAMP, DECORATIVE SPARE NUMBER SPARE NUMBER	VULCAN DELFIELD PACIFIC STAINLESS PRODUCTS EXISTING PACIFIC STAINLESS PRODUCTS EXISTING EXISTING BY OWNER BY OWNER BY HVAC BY OWNER BY HVAC BY OWNER DELFIELD PACIFIC STAINLESS PRODUCTS DELFIELD DELFIELD PACIFIC STAINLESS PRODUCTS PACIFIC STAINLESS PRODUCTS CAMBRO EXISTING RUBBERMAID STAINLESS HATCO	VCCG36-AC F2973CP WKT1830A4S BY OWNER CUSTOM STAINLESS WSH7215DD BY OWNER BY OWNER BY OWNER BY OWNER BY HVAC BY OWNER BY HVAC BY OWNER BY HVAC BY OWNER GUF32BP-D EHEI48C GUR27BP-D WKT8430A4O WSH8412DD IBS27148 BY OWNER SLIM JIM CUSTOM DLH-725-SR	2.9 VFY VFY VFY VFY 15.0 12.0 2.6 15.0 3.2	0.3	115 VFY VFY VFY VFY 120 115 115 208 115	1 VFY VFY 1 1 1 1 1 1 1 1 1 1 1 1 1 1 1 1 1 1 1	X	5-15P VFY 5-15P 5-15P 6-20P	0.5		1.5		0.75	90

	1	I	EQUIP	MENT SCHEDULE						Т	-	1				
ΓΕΜ 10	_	EQUIPMENT CATEGORY SHELF, SORT, TABLE MOUNT	MANUFACTURER PACIFIC STAINLESS PRODUCTS	MODEL NUMBER TMSR108D	AMPS	НР	VOLTS	PHASE	PLUG	NEMA	COLD WATER SIZE (IN)	HOT WATER SIZE (IN)	DIRECT DRAIN SIZE (IN)		GAS SIZE (IN)	MBTUH
2		MOBILE TRASH CAN W/ DOLLY	RUBBERMAID	FG263200GRAY												
<u> </u>	+	SOILED DISHTABLE ISLAND WITH SCRAP SINK	PACIFIC	CUSTOM STAINLESS									1.5			
 4	-	PRE-RINSE FAUCET, WALL MOUNT	T & S BRASS	B-0133-01-CR							0.5	0.5				
5	+	VENTLESS WAREWASHER, HIGH TEMP	HOBART US FOODSERVICE	AM15VLT-2	45.4		208-240	3 X			0.5	0.5		1.5		
3	1	CLEAN DISHTABLE, CORNER	PACIFIC	CUSTOM STAINLESS												
7	2	SHELF, WALL MOUNT	PACIFIC STAINLESS PRODUCTS	WSH6012DD												
3		SPARE NUMBER														
3		SPARE NUMBER														
<u>.</u>	+	SINK, SCULLERY, 3 COMPARTMENTS	EXISTING	BY OWNER							2 -	0.5	1.5	1.5		<u> </u>
1	+	FAUCET, WALL MOUNT, WITH PRE-RINSE	EXISTING	BY OWNER							0.5	0.5				
2	_	SHELF, WALL MOUNT WIRE SHELVING	PACIFIC STAINLESS PRODUCTS	WSH8412DD WIRE SHELVING UNIT												
3 4		SINK, HAND, WALL MOUNT	CENTAUR EAGLE GROUP/METAL MASTERS										1.5			\vdash
4 5	+	FAUCET, WALL MOUNT	T & S BRASS	B-1146-CR				++			0.5	0.5	٠,٠			
5 6		SPARE NUMBER						+			3.0	٥.٠				
 7		SPARE NUMBER						++								
З	_	BEVERAGE/SERVER STATION	MILLWORK	BY OTHERS				+								
9	+	SINK, DROP-IN	PACIFIC	CUSTOM STAINLESS				$\dagger \dagger$					1.5			
С	1	FAUCET, DECK MOUNT	T & S BRASS	B-1141-CR							0.5	0.5				
1	1	WATER STATION	T & S BRASS	B-1230-12							0.5			1.25		
2	1	DROP-IN ICE CHEST W/ COLD PLATE	PERLICK	DI24IC10										0.5		
3		AIRPOT	BY OWNER	BY OWNER		·										
4		COFFEE GRINDER	BY OWNER	BY OWNER	VFY		VFY	1	1 1	VERIFY						<u> </u>
5		COFFEE MAKER, AIRPOT, AUTOMATIC	BY OWNER	BY OWNER	VFY		VFY	1	X	VERIFY	0.25					<u> </u>
Б 	+	SPARE NUMBER						++								<u> </u>
7	+	SPARE NUMBER	THEOMAL SITE	CUSTOM	455		4.5.5	1								<u> </u>
8	+	BEER COOLER	THERMAL RITE	CUSTOM	15.0		120	1 X						-		
9	-	BEER EVAPORATOR COIL BEER CONDENSER	THERMAL RITE THERMAL RITE	TBD	2.7 9.8		208-230 208-230	+-+						1		
1	-	SPARE NUMBER	THERWAL THE		9.8		208-230	+++^								
2		COOLER SHELVING	EAGLE	GREEN EPOXY SHELVING												
<u>-</u> 3	1	10 GAL COCKTAIL KEG ON TAP	PERLICK	KCAST-10-DD	15.0		120	1	X :	5-15P						
4	-	SPARE NUMBER														
5	1	BAR TOP & DIE WALL	MILLWORK	BY OTHERS												
6	1	BACK BAR COUNTER & GLASS RACK STORAGE	MILLWORK	BY OTHERS												
7	1	CARBONATOR	BY OTHERS	BY OTHERS	VFY		120	1	X :	5-15P	0.375					
8	1	UNDERBAR COCKTAIL STATION	PERLICK	PTE68-B							(2).5	(2).5		1.5		
9	1	UNDERBAR COCKTAIL REFRIGERATION	PERLICK	BBS36C	3.2	0.2	120	1	X :	5-15P				1		
00	1	UNDERBAR DUMP SINK	PERLICK	TSD12HS							0.5	0.5		1.5		<u> </u>
01	1	UNDERBAR ICE CHEST	PERLICK	TS24IC10										0.5		<u> </u>
02	1	UNDERBAR SPEED RAIL	PERLICK	SR-S30A												<u> </u>
03		UNDERBAR SODA GUN FILLER	PERLICK	TS6SGB	150		100	+								<u> </u>
25	+	POS SYSTEM & PRINTER	BY OWNER	BY OWNER	15.0		120	1	X							<u> </u>
05 06	3	TRASH CAN UNDERBAR HANDSINK	RUBBERMAID PERLICK	SLIM JIM TS12HSN				++			0.5	0.5	1,5			
06	1	UNDERBAR SINK	PERLICK	TSD43R				++			0.5	0.5	1,0	1.5		
)/)8	_	BACK BAR COOLER W/ GLASS DOORS	PERLICK	BBSN52**R	5.5	0.2	120	1	X :	5-15P	0.0	٠.٥		1.0		
09	_	BEER TAP, WALL MOUNT	BY OTHERS	BY OTHERS	0.0	~	.20	++	' '							
10	1	KNOCK BOX	VOLLRATH	E06064-KB				++								
11	2	GRINDER	BY OWNER	BY OWNER	VFY		VFY	1	X	VFY						
12	1	2-GROUP ESPRESSO MACHINE	BY OWNER	BY OWNER	VFY		VFY	1	×	VFY	VFY			VFY		
13	1	BACK BAR COOLER W/ GLASS DOOR	PERLICK	BBS36**L	3.2	0.2	120	1	Χ :	5-15P						
4	1	SINK, MOP	PACIFIC	MS201606-CML		_				_			2			
15		SERVICE SINK FAUCET, WALL MOUNT	T & S BRASS	B-0655-BSTR							0.5	0.5				<u> </u>
16		SHELF, WALL MOUNT	PACIFIC	USH24												
17		SPARE NUMBER														
18	-	SPARE NUMBER														
19	-	SPARE NUMBER														
20	+	SPARE NUMBER	DACIFIC	W5201605 CV"				++								
21	1	SINK, MOP	PACIFIC	MS201606-CML	1 1								2			<u> </u>
22	1	SERVICE SINK FAUCET, WALL MOUNT	T & S BRASS	B-0655-BSTR							0.5	0.5		l	I	1

RGREEN ELLINGSON ROODSTRINGS SUPPLY & DUSIGN

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4 02/06/19

DRAWN BY:
R. SMITH
PROJECT MANAGER:
J. UNSELL

SHEET TITLE:

EQUIPMENT
SCHEDULE

SHEET NUMBER

K-2

PROJECT NUMBER 80103866

3

ELECTRICAL NOTES PER NATIONAL AND LOCAL CODES. 4. THE ELECTRICAL CONTRACTOR SHALL PROVIDE FUSED DISCONNECTS FOR 5. ALL ELECTRICAL ROUGH-IN WORK AND ALL FINAL CONNECTIONS FOR ALL AVAILABLE VOLTAGE AND PHASE. INSTALLED BY ELECTRICIAN. CONTRACTOR BOX FOR EACH ICE MACHINE HEAD. AUTHORITIES. REGISTERS, PRINTERS, COMPUTERS, SOUND SYSTEM, ETC. INCLUDING CONDUIT FLOORS TO CENTER LINE OF ELECTRICAL OUTLET BOXES. HEIGHTS ARE NOT TO BE TAKEN FROM CURBS OR PLATFORMS.

BOXES, ETC. LOCATED UNDER ANY CLASS I EXHAUST HOOD SO AS TO DISCONNECT UPON ACTIVATION OF THE FIRE SUPPRESSION SYSTEM. 14. ELECTRICAL CONTRACTOR SHALL VERIFY REQUIREMENTS OF CASH

1. ALL ELECTRICAL ROUGH-IN WORK AND FINAL CONNECTIONS TO ALL FOOD SERVICE AND RELATED EQUIPMENT AS SHOWN ON THE KITCHEN EQUIPMENT CONTRACTOR'S PLANS TO BE PERFORMED BY THE ELECTRICAL CONTRACTOR 2. THE ELECTRICAL CONTRACTOR SHALL PROVIDE AND INSTALL STAINLESS STEEL OUTLET AND RECEPTACLE COVERS IN SERVICE AREAS. 3. THE ELECTRICAL CONNECTIONS, SPECIFICATIONS AND DIMENSIONS SHOWN ON MENU BOARDS, TELEPHONE AND DATA LINES, ETC.

THESE PLANS ARE FOR FOOD SERVICE EQUIPMENT ONLY. SEE THE ARCHITECT'S PLAN SET FOR ADDITIONAL ELECTRICAL REQUIREMENTS INCLUDING OFFICE,

EQUIPMENT HOOK-UPS AS REQUIRED BY CODE AND LABELING.

ITEMS SHOWN AND SPECIFIED ON THESE PLANS BY BARGREEN ELLINGSON SHALL BE PERFORMED BY THE ELECTRICAL CONTRACTOR

6. UNLESS OTHERWISE SPECIFIED IN THESE PLANS OR OTHER WRITTEN CONTRACTS, IT SHALL BE THE RESPONSIBILITY OF THE ELECTRICAL CONTRACTOR TO PROVIDE ALL ELECTRICAL-TYPE MATERIALS INCLUDING, BUT NOT LIMITED TO: WIRING, SWITCHES, DISCONNECTS, FLEX, CONDUIT, CONTACTORS, TRANSFORMERS, THERMAL OVERLOAD PROTECTORS, MAGNETIC STARTERS, SHUNT TRIP BREAKERS, ELECTRICAL PANELS, CORDS, PLUGS, COVERS, ETC.

1. ELECTRICAL CONTRACTOR SHALL PROVIDE THE KITCHEN EQUIPMENT CONTRACTOR WITH ELECTRICAL PANEL(S) SIZE AND LOCATION ALONG WITH

8. ANY LOW YOLTAGE WIRING FOR REMOTE WALK-IN CONTROL PANEL TO BE

9. THE ELECTRICAL CONTRACTOR SHALL FURNISH AND INSTALL ALL ELECTRICAL COMPONENTS FOR WALK-IN REFRIGERATORS AND FREEZERS INCLUDING, BUT NOT LIMITED TO: LIGHTS, DOOR VENTS, SOLENOIDS, TIME CLOCKS, DEFROST CIRCUITS DOOR HEATER, AND INTERCONNECTIONS BETWEEN REMOTE COMPRESSORS AND INTERIOR MOUNTED EVAPORATOR COILS. ELECTRICAL SHALL ALSO PROVIDE DISCONNECTS AND THERMO-OVERLOAD PROTECTION FOR COMPRESSORS.

10. THE ELECTRICAL CONTRACTOR SHALL PROVIDE AND INSTALL HEAT TAPE ON DRAIN LINES IN DANGER OF FREEZING. VERIFY LENGTH WITH REFRIGERATION

11. THE ELECTRICAL CONTRACTOR SHALL PROVIDE DISCONNECTS AT THE POWER


12. IT SHALL BE THE RESPONSIBILITY OF THE ELECTRICAL CONTRACTOR TO PROVIDE INTERCONNECT SWITCHING BETWEEN THE KITCHEN HOOD EXHAUST FANS AND THE KITCHEN MAKE-UP AIR SYSTEMS AS REQUIRED PER LOCAL CODE AND

13. IT SHALL BE THE RESPONSIBILITY OF THE ELECTRICAL CONTRACTOR TO PROVIDE ELECTRICAL CONTACTORS ON ALL ELECTRICAL OUTLETS, JUNCTION

RUNS AND DEDICATED / ISOLATED OUTLET REQUIREMENTS. 15. ALL DIMENSIONS SHOWN ARE FROM GRID LINES, FINISHED WALLS OR FINISHED

16. TEMPERATURE SENSORS RELATED TO THE HOOD SYSTEM, AND INTENDED TO BE INSTALLED IN THE KITCHEN SPACE, SHALL BE INSTALLED BY THE ELECTRICAL CONTRACTOR ACCORDING TO THE MANUFACTURER'S SPECIFICATIONS.

ELECTRICAL LEGEND SYMBOL DESCRIPTION JUNCTION BOX 120 VOLT OUTLET (DCO) 208 VOLT OUTLET (SCO) \odot ELECTRICAL STUB FLOOR OUTLET Ф DEDICATED / ISOLATED SWITCH LIGHT FIXTURE FIELD CONNECTION HEAT TAPE MOTOR Ŧ THERMOSTAT ⑤ SOLENOID P.O.S. NETWORK CONNECTION 120V/14/15 AMP CONVENIENCE OUTLET VERIFY CONN. TYPE & POWER REQ. \triangleleft PHONE

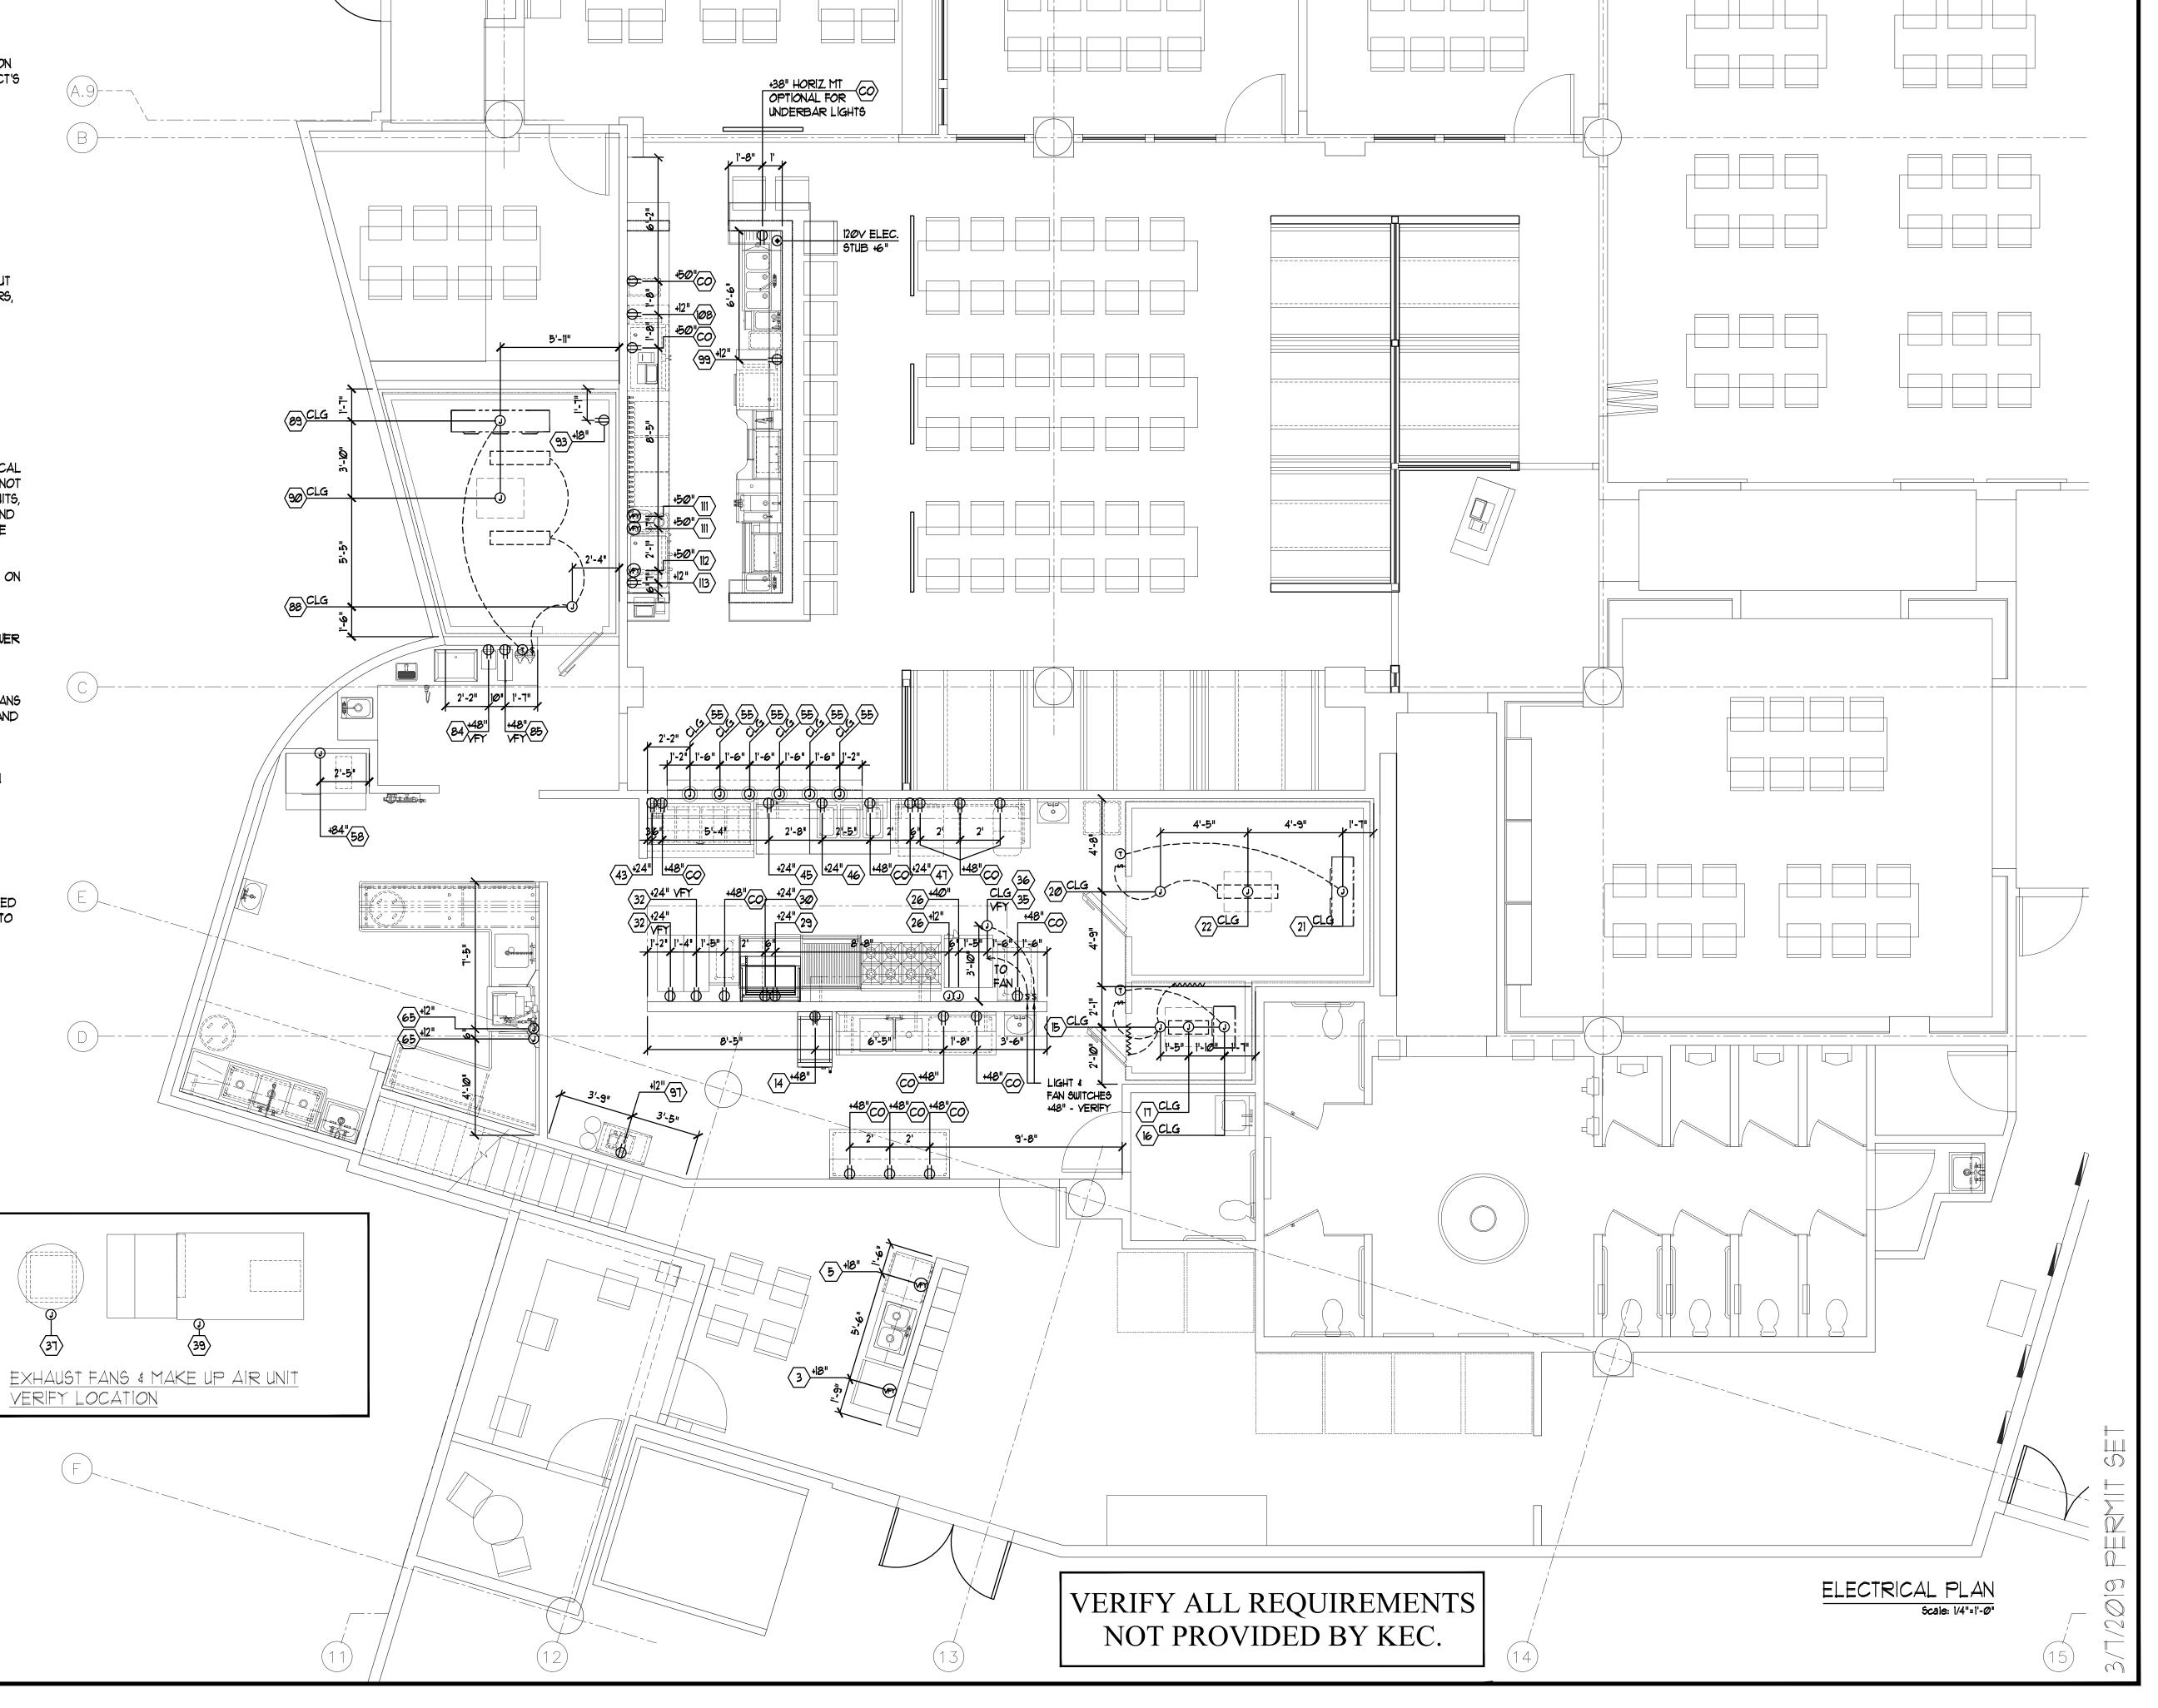

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REVISION INFORMATION 01/16/19 01/22/19 01/28/19 02/06/19

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R. SMITH PROJECT MANAGER:

J. UNSELL SHEET TITLE:

ELECTRICAL ROUGH-IN PLAN

SHEET NUMBER

3 OF 6 PROJECT NUMBER

80103866

PLUMBING NOTES

- 1. ALL PLUMBING ROUGH-IN WORK AND FINAL CONNECTIONS TO ALL FOOD SERVICE AND RELATED EQUIPMENT AS SHOWN ON THE KITCHEN EQUIPMENT CONTRACTOR'S PLANS TO BE PERFORMED BY THE PLUMBING CONTRACTOR PER NATIONAL AND LOCAL CODES.
- 2. UNLESS OTHERWISE SPECIFIED IN THESE PLANS OR OTHER WRITTEN CONTRACTS, IT SHALL BE THE RESPONSIBILITY OF THE PLUMBING CONTRACTOR TO PROVIDE ALL PLUMBING-TYPE MATERIALS INCLUDING VALVES, TRAPS, LINE STRAINERS, FLOOR SINK COVERS, PRESSURE REGULATORS, SIPHON BREAKERS, ETC.
- 3. PLUMBING CONTRACTOR SHALL SIZE, FURNISH AND INSTALL ALL GREASE TRAPS OR INTERCEPTORS AS REQUIRED AND COORDINATE SIZES AND LOCATIONS WITH KITCHEN EQUIPMENT CONTRACTOR.
- 4. PLUMBING CONTRACTOR SHALL FURNISH AND INSTALL ALL GAS SHUT-OFF YALVES FOR EACH PIECE OF EQUIPMENT WITH PERMANENT I.D. TAGS AS WELL AS THE MAIN GAS YALVE(S).
- 5. PLUMBING CONTRACTOR SHALL FURNISH AND INSTALL ALL DIRECT SINK WASTE LINES AND ALL INDIRECT EQUIPMENT WASTE LINES AS SHOWN ON PLANS PER LOCAL CODES, INCLUDING TRAPS, TAIL PIECES, LINE STRAINERS, AND WALK-IN CONDENSATE WASTE LINES, AS REQUIRED. INDIRECT WASTE LINE ROUTING THROUGH CABINETS SHALL BE IN A MANNER SO AS TO MAXIMIZE USABLE STORAGE SPACE.
- 6. ALL DRAIN LINES FROM EQUIPMENT REQUIRING CONDENSATION REMOVAL SHALL BE RUN IN COPPER AND TO BE PROVIDED BY THE PLUMBER.
- 7. ALL INDIRECT WASTE LINES TO HAVE A 2" MINIMUM AIR GAP ABOVE FLOOD RIM OF RECEIVING FIXTURE.
- 8. THE PLUMBING CONTRACTOR SHALL PROVIDE AND INSTALL INSULATION MATERIAL ON ALL DRAINLINES FROM ICE BINS, ICE PANS, ETC., SO AS TO ELIMINATE CONDENSATION FORMATION.
- 9. FLOOR SINKS SHALL BE FURNISHED AND INSTALLED BY THE PLUMBING CONTRACTOR IN LOCATIONS SHOWN, AND SUPPLIED WITH 3/4 GRATE OR AS SPECIFIED. AREA DRAINS, IF REQUIRED, SHALL BE VERIFIED WITH THE ARCHITECT.
- 10. IT SHALL BE THE RESPONSIBILITY OF THE GENERAL CONTRACTOR TO VERIFY THAT THE LOCATIONS FOR ALL MECHANICAL REQUIREMENTS WHICH REQUIRE FLOOR PENETRATIONS DO NOT CONFLICT WITH STRUCTURAL MEMBERS IN THE
- 11. THE GENERAL CONTRACTOR SHALL SUPERVISE THE LOCATION OF ALL FLOOR DRAINS ON THE JOB SITE SO AS TO ENSURE THE BEST SLOPE POSSIBLE OF THE SURROUNDING FLOOR TO THESE DRAINS.
- 12. PLUMBER SHALL FURNISH AND INSTALL PRESSURE REDUCING YALVE(S) AT DISHWASHER(S), GLASS WASHER(S), STEAMER(S) AND OTHER EQUIPMENT, AS REQUIRED.
- 13. IT SHALL BE THE RESPONSIBILITY OF THE PLUMBING CONTRACTOR TO FURNISH AND INSTALL ALL WATER HEATERS FOR THIS PROJECT AND TO ENSURE ADEQUATE WATER SUPPLY FOR THE FOOD SERVICE EQUIPMENT. WATER TEMPERATURE TO THE DISHWASHER SHALL BE 140°. COORDINATE LOCATION OF WATER HEATER WITH KITCHEN EQUIPMENT CONTRACTOR.
- 14. THE PLUMBING CONNECTIONS, SPECIFICATIONS AND DIMENSIONS SHOWN ON THESE PLANS ARE FOR FOOD SERVICE EQUIPMENT ONLY. SEE ARCHITECT'S PLAN SET FOR ALL OTHER PLUMBING REQUIREMENTS FOR THIS PROJECT.

TYPICAL GAS CONNECTION

5/8" GYP. WALL W/ S/S
WALL LINER, TYP.


GAS PIPE SIZED PER
MF. SPECIFICATIONS

FLEXIBLE GAS LINE
TO EQUIP., SIZED
PER MFG.
SPECIFICATION.
ALLOW ENOUGH
SLACK LINE TO PULL
EQUIP. 24" MIN. FROM
WALL, TYP.

PLUMBING LEGEND

RESTRAINING CABLE

r						
SYMBOL	DESCRIPTION					
•	HOT WATER SUPPLY					
0	COLD WATER SUPPLY					
Φ	DIRECT WASTE					
Ð	FILTERED WATER					
•	PLUMBING STUB					
	FLOOR SINK, NO GRATE					
	FLOOR SINK, 1/2 GRATE					
	FLOOR SINK, 3/4 GRATE					
\otimes	FUNNEL DRAIN					
	AREA / FLOOR DRAIN					
•	GAS CONNECTION					
0	BEVERAGE CONDUIT STUB-UP					
•	STEAM CONNECTION					
	FIELD CONNECTION / DRAIN LINE					
₽	VERIFY CONN. SIZE & REQ.					

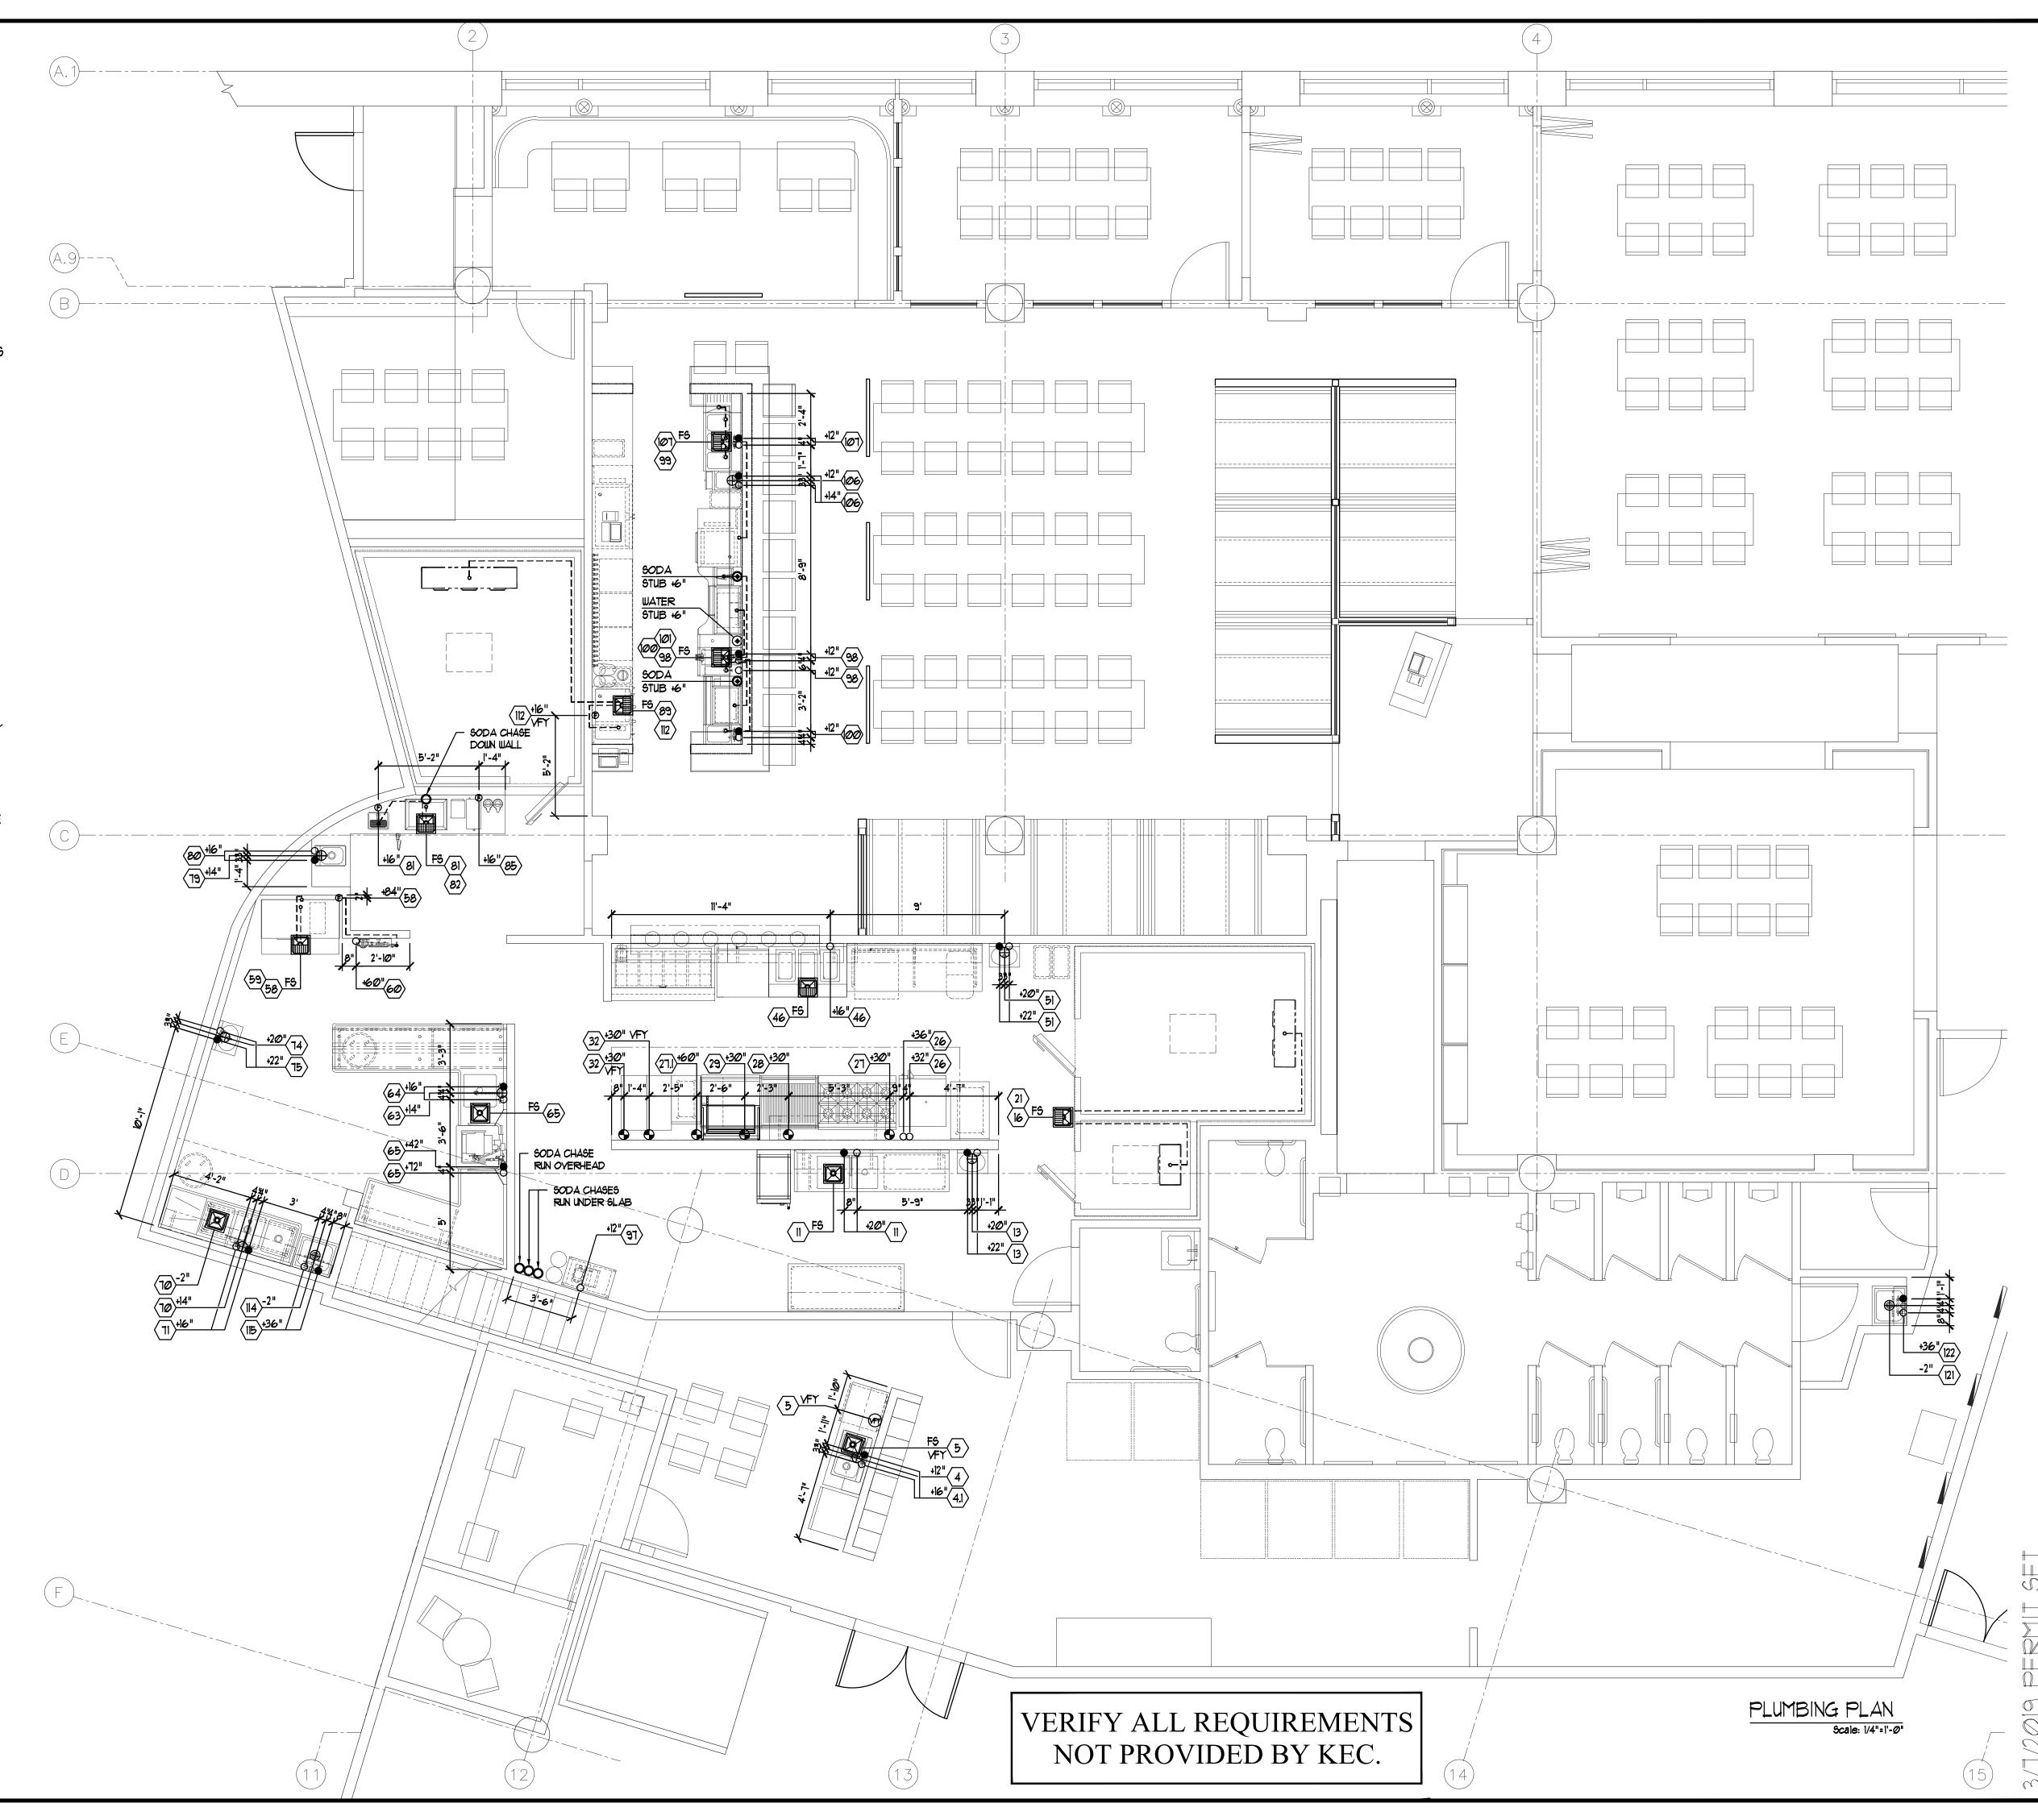

BARGREEN ELLINGSON
FOODSTRVICE SUPPLY & DESIGN
6626 TACOMA MALL BLVD.
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START PERMIT
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PRELIM REVISION
1 01/16/19 ---2 01/22/19 ---3 01/28/19 ---4 02/06/19 ---5 ---- ---6 ---- ---7 ----

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DRAWN BY:
R. SMITH
PROJECT MANAGER:
J. UNSELL

SHEET TITLE:


PLUMBING ROUGH-IN PLAN

SHEET NUMBER

K-4

4 OF 6
PROJECT NUMBER

80103866

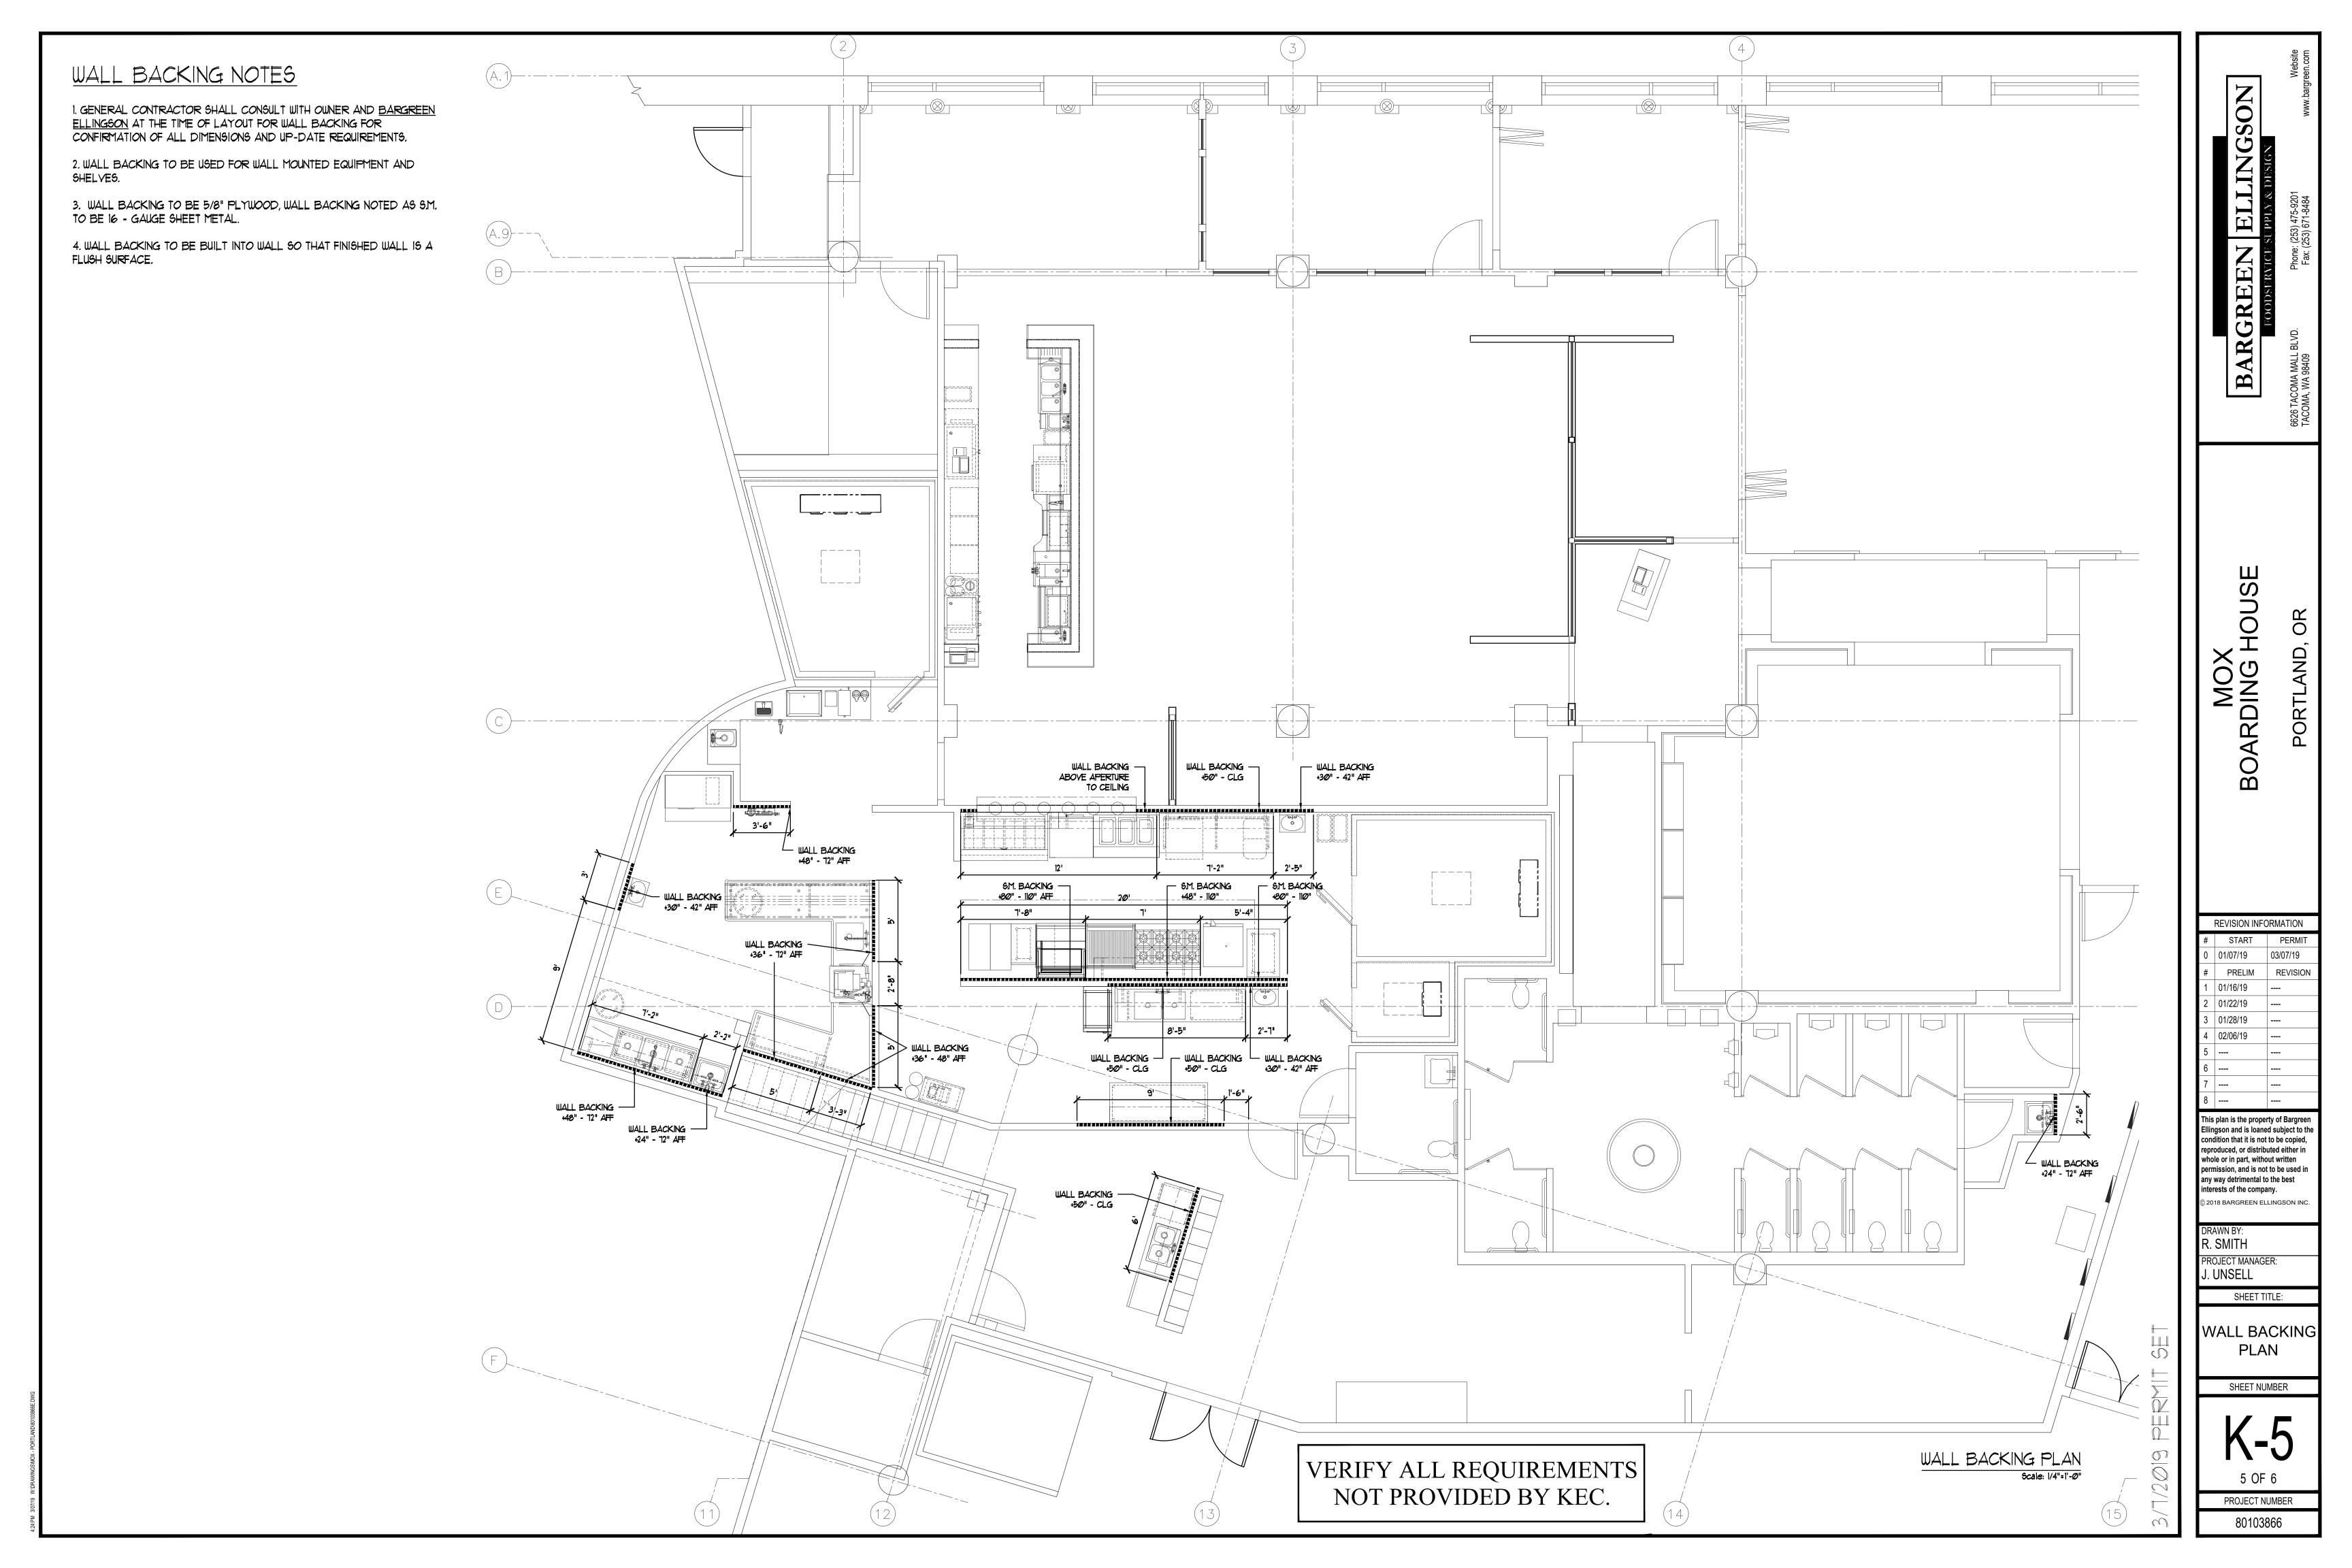


UNDERSLAB NOTES

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UNDERSLAB LEGEND

5YMBOL	DESCRIPTION
	FLOOR SINK, NO GRATE
	FLOOR SINK, 1/2 GRATE
	FLOOR SINK, 3/4 GRATE
\oplus	DIRECT WASTE
	AREA / FLOOR DRAIN
0	BEVERAGE CONDUIT STUB-UP
•	ELECTRICAL STUB
•	PLUMBING STUB
	FIELD CONNECTION

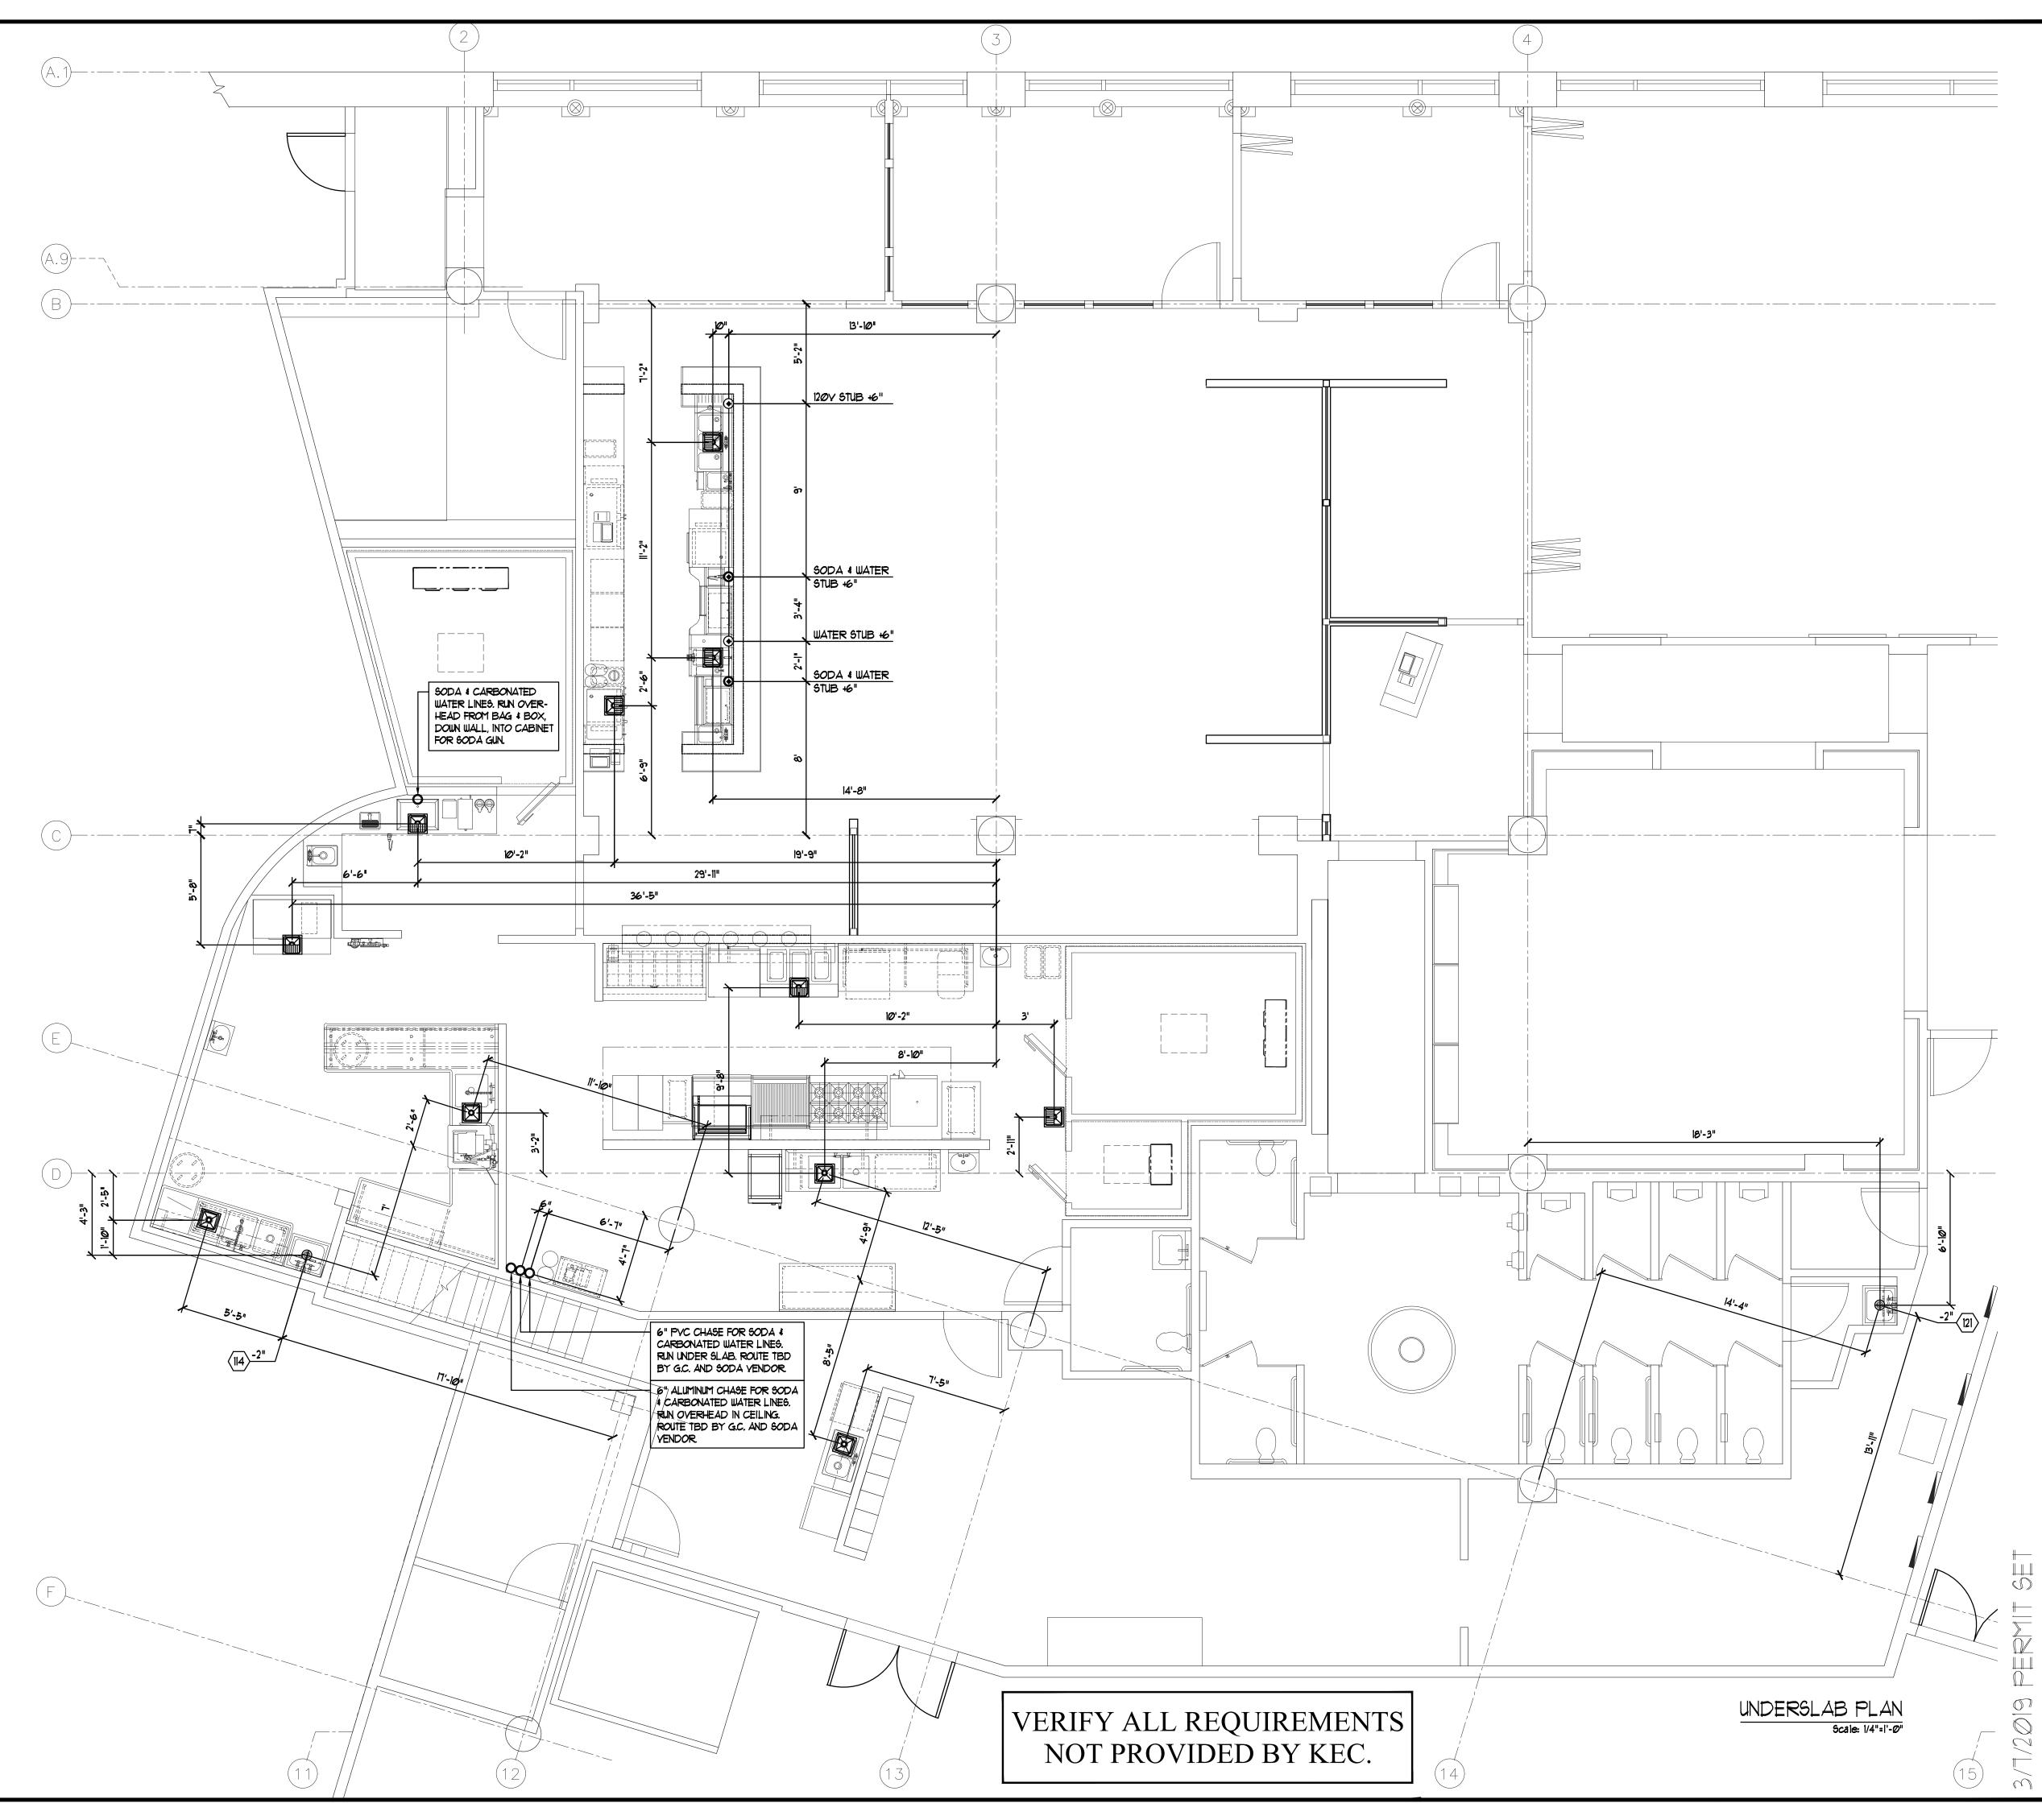

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2018 BARGREEN ELLINGSON IN

SHEET TITLE:

UNDERSLAB

ROUGH-IN

PLAN

SHEET NUMBER

6 OF 6

PROJECT NUMBER

80103866

interests of the company.

PROJECT MANAGER:

DRAWN BY: R. SMITH

J. UNSELL

01/16/19 01/22/19 01/28/19 02/06/19