Development Services

From Concept to Construction





Phone: 503-823-7300 Email: bds@portlandoregon.gov 1900 SW 4th Ave, Portland, OR 97201 More Contact Info (http://www.portlandoregon.gov//bds/article/519984)

APPEAL SUMMARY	
Status: Decision Rendered	
Appeal ID: 20227	Project Address: 3714 SW Macadam Ave
Hearing Date: 4/10/19	Appellant Name: Jeancarlo Saenz
Case No.: B-024	Appellant Phone: 9727269400
Appeal Type: Building	Plans Examiner/Inspector: Maureen McCafferty, Joe Thornton
Project Type: commercial	Stories: 8 Occupancy: R-2, M, S-2, A-3 Construction Type: Type I-A & Type III-A
Building/Business Name: E2 - Block 40	Fire Sprinklers: Yes - Thorughout
Appeal Involves: Erection of a new structure	LUR or Permit Application No.: 17-110666-LU
Plan Submitted Option: pdf [File 1]	Proposed use: Mix-use building

Appeal item 1

Code Section	OSSC 508.2 Accessory occupancies & 311.1 Storage Group S
Requires	Per Section 508.2, Accessory occupancies are those occupancies that are ancillary to the main occupancy of the building or portion thereof. Aggregate accessory occupancies shall not occupy more than 10 percent of the building area of the story in which they are located and shall not exceed the tabular values in Table 503, without building area increases in accordance with Section 506 for such accessory occupancies. Per Section 508.2.2, accessory occupancies shall be individually classified in accordance with Section 302.1
Proposed Design	The proposed design is an 8-story mixed-use high-rise multi-family building, with 5 levels of Type III-A construction over 3 level of Type I-A construction at grade. There is 1 level of below-grade parking, also of Type I-A construction. This project proposed to use the provisions of the 2015 IBC for accessory occupancies (section 508.2) and accessory storage spaces (section 311.1.1). The 2015 IBC changes the limitations of section 508.2.1 by creating two sections to limit height (508.2.2) and building area (508.2.3) Per Section 508.2.2, the allowable height and number of stories of the building containing accessory occupancies shall be in accordance with Section 504 for the main occupancy of the building. Per section 508.2.3, the allowable area of the building shall be based on the applicable provisions of Section 506 for the main occupancy of the building. Aggregate accessory occupancies shall not occupy more than 10 percent of the floor area of the story in which they are located and shall not exceed the tabular values for nonsprinklered buildings in table 506.2 for wash such accessory occupancy.

Appeals | The City of Portland, Oregon

All the levels in type III-A have a main occupancy classification of R-2, which also has accessory uses in the form of storage closets (S-1), a roof terrace (A-3), and a Club room (A-3). These accessory occupancies meet all the previsions set by the 2015 IBC for height and area per section 508.2.2 and 508.2.3, as proven in the attached exhibits.

The proposed design also classifies all storage rooms that are accessory occupancies to the R-2 to be classified as part of that occupancy and not as a S-1 occupancy. Per Section 311.1.1 of the 2015 IBC, a room or space used for storage purposes that is less that 100 square feet in area and accessory to another occupancy shall be classified as part of that occupancy. The aggregate area of such rooms or spaces shall not exceed the allowable area limits of Section 508.2.

Reason for alternative This project includes occupancies that exceed the tabular values for stories on table 503 of the 2014 OSSC. S-1 and A-3 occupancies are limited to 3 stories per this table and we are currently proposing to use them on up to two additional levels.

Both the 2015 and 2018 IBC acknowledge that accessory occupancies does not represent a greater risk for the main occupancy if they are limit by the requirements for height, stories and percentage of area of the main occupancy they serve as an accessory use.

The new versions of the code also clarify storage rooms as part of accessory spaces and how they should be classified. Since storage rooms provided in this project are small and accessory spaces to the residential units, they can be classified as R-2 also and not S-1.


The proposed design meets all the criteria set by the 2015 IBC as presented on the attached exhibits.

APPEAL DECISION

Accessory occupancy classification per 2015 IBC: Granted provided all provisions of 2015 IBC Sections 508.2.2 and 508.2.3 are met.

The Administrative Appeal Board finds with the conditions noted, that the information submitted by the appellant demonstrates that the approved modifications or alternate methods are consistent with the intent of the code; do not lessen health, safety, accessibility, life, fire safety or structural requirements; and that special conditions unique to this project make strict application of those code sections impractical.

Pursuant to City Code Chapter 24.10, you may appeal this decision to the Building Code Board of Appeal within 180 calendar days of the date this decision is published. For information on the appeals process and costs, including forms, appeal fee, payment methods and fee waivers, go to www.portlandoregon.gov/bds/appealsinfo, call (503) 823-7300 or come in to the Development Services Center.

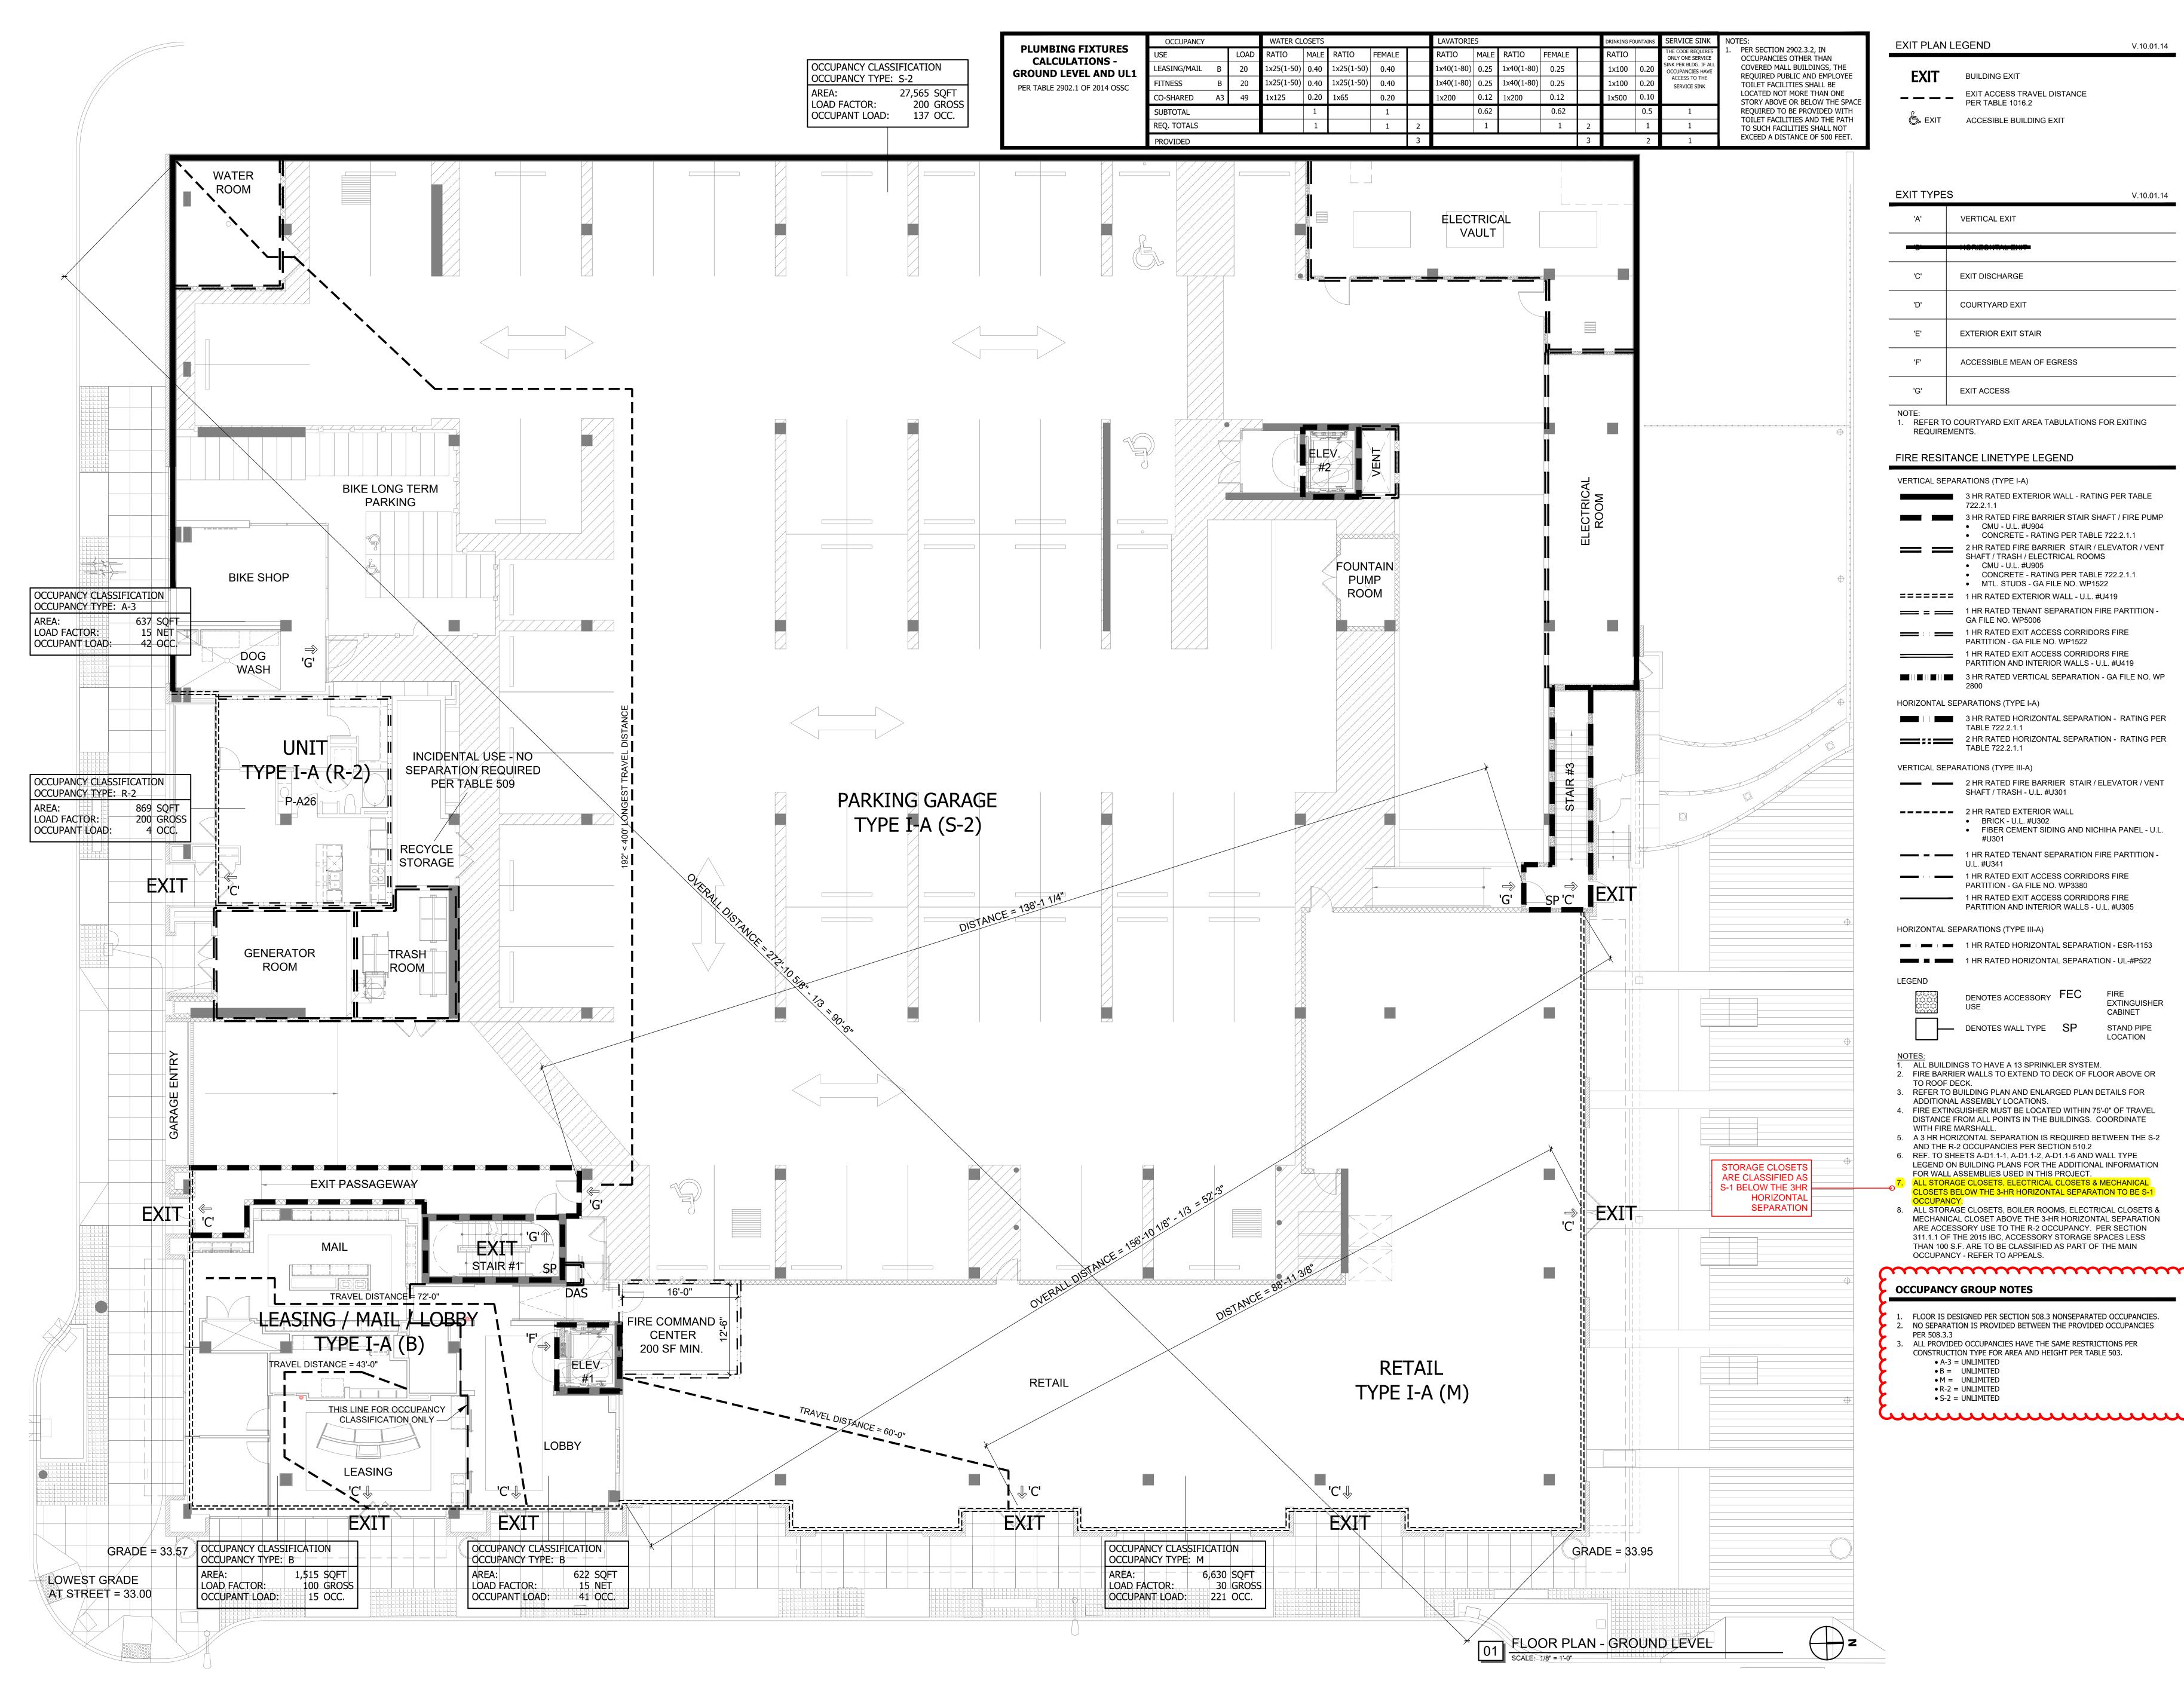

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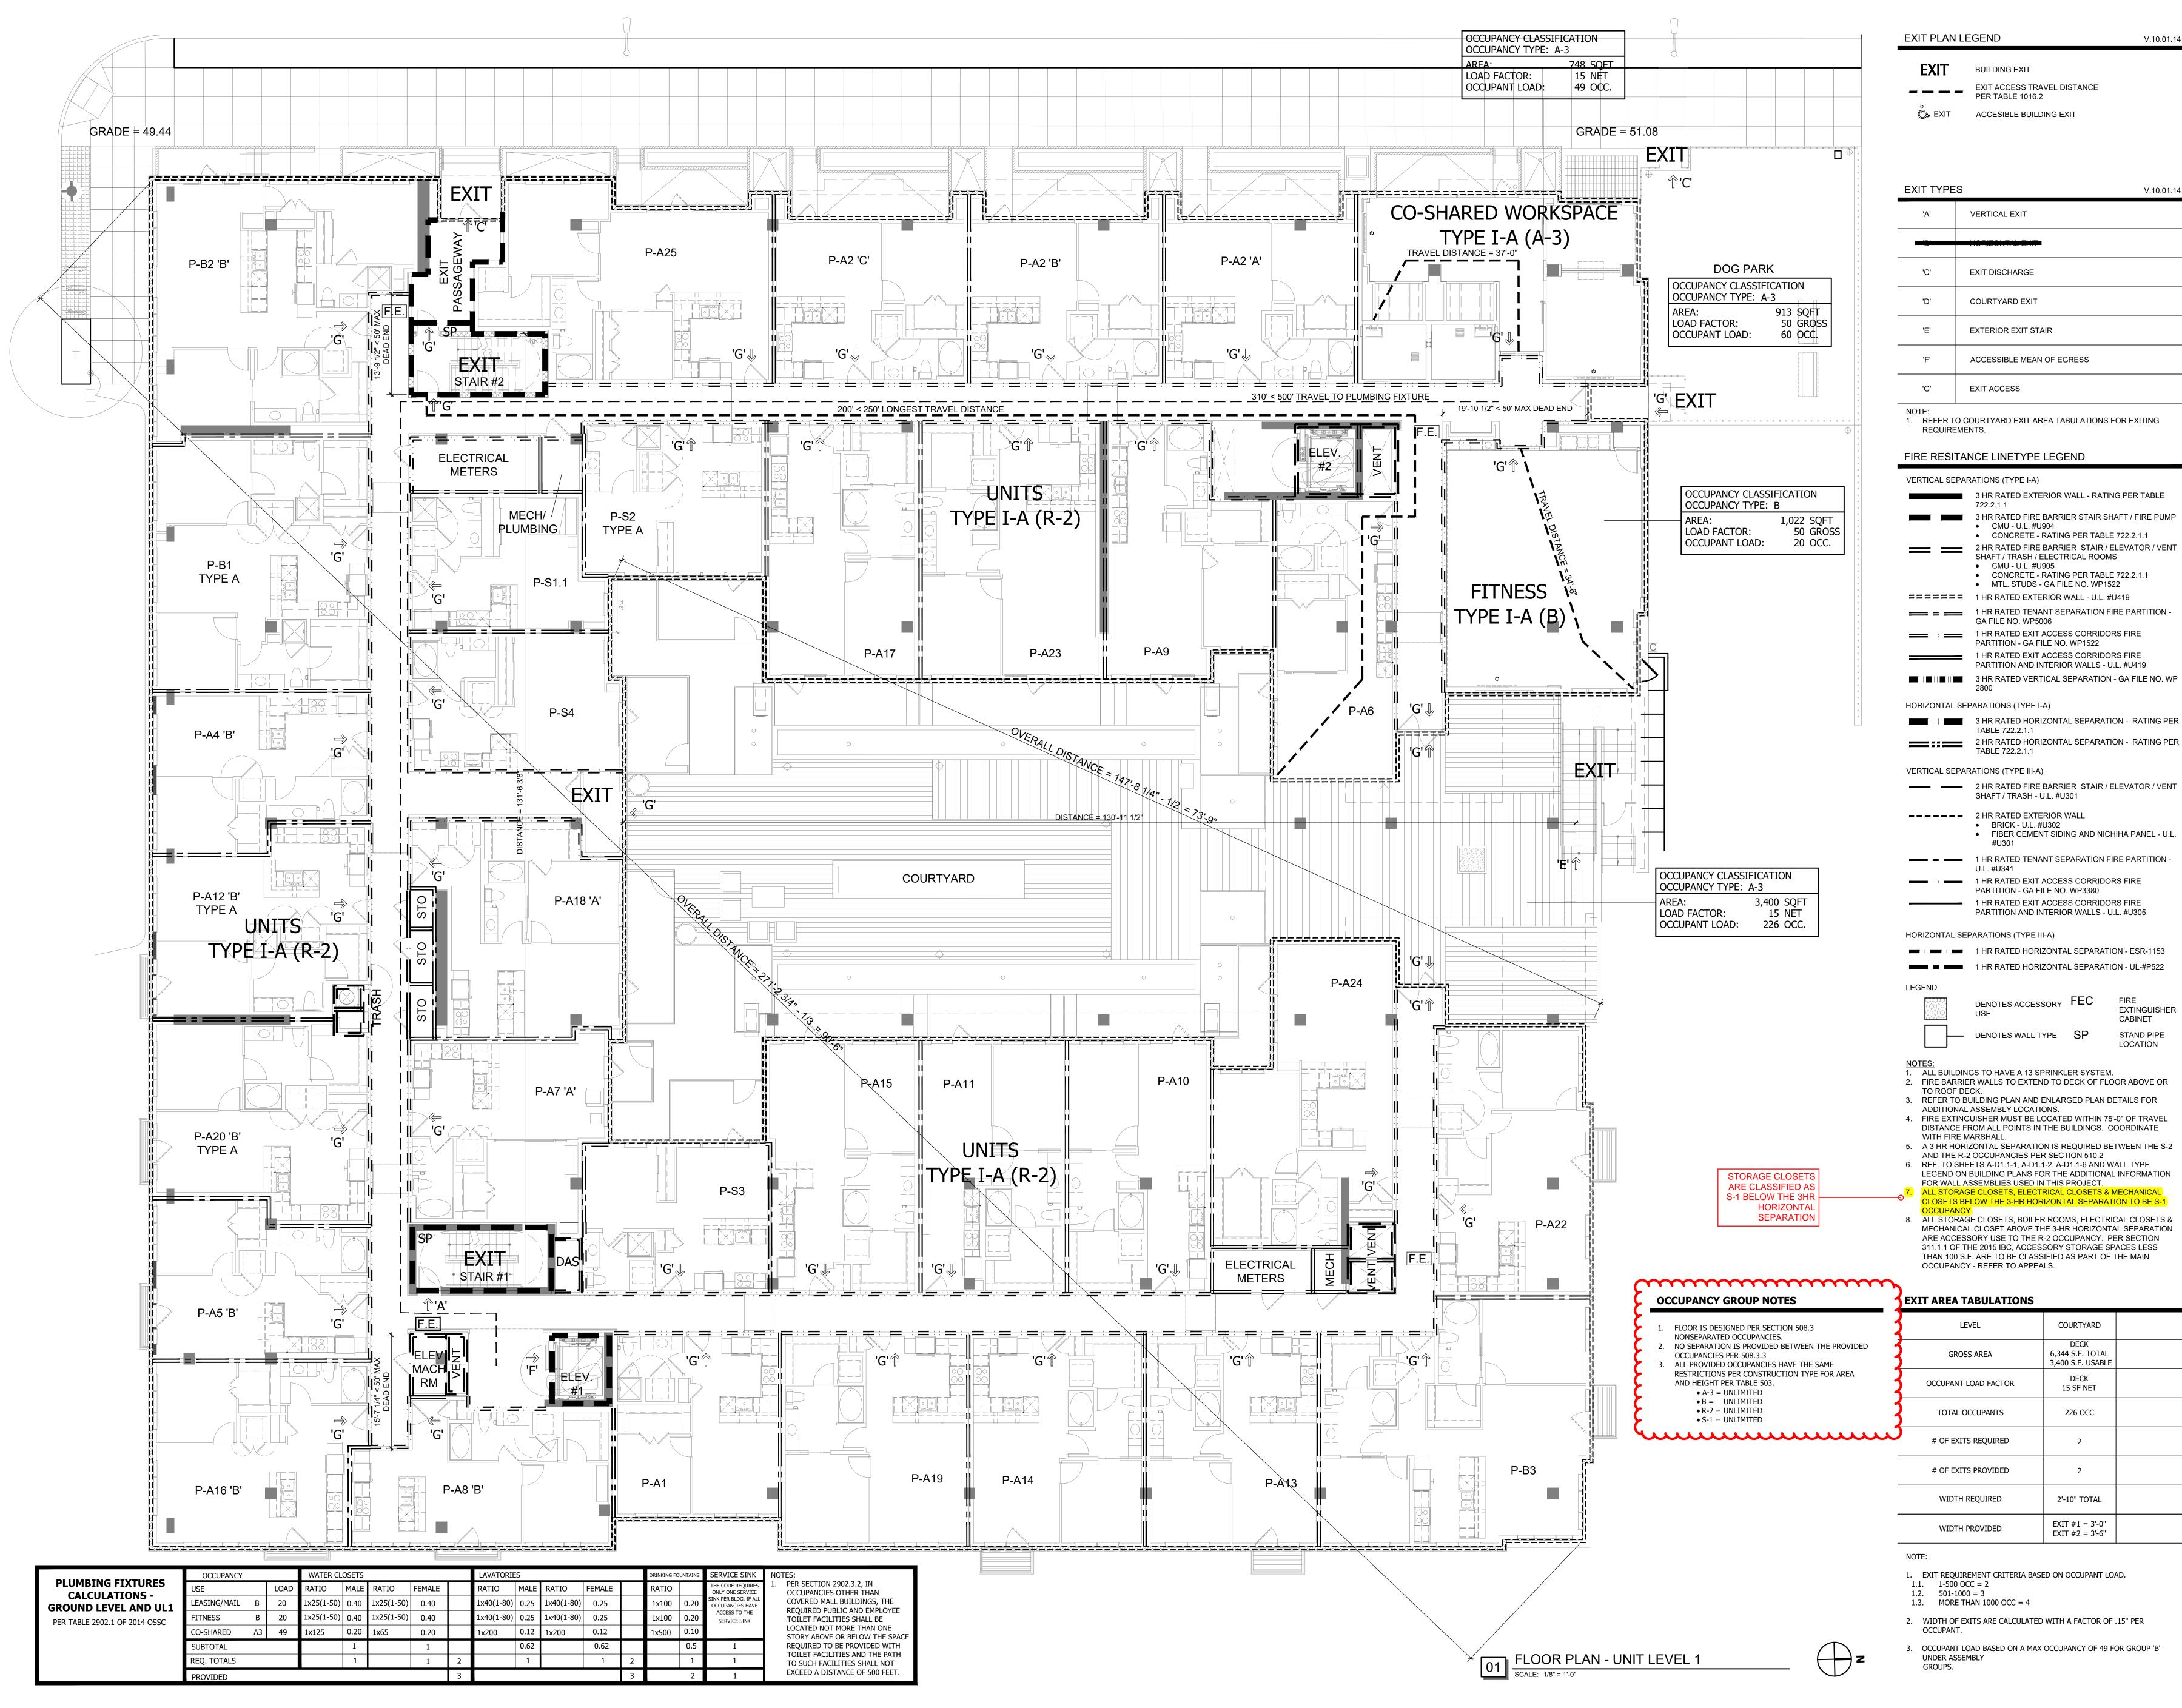


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E2 BLOCK 40 PORTLAND OREGON

ALAMO MANHA	TTAN
Issue Set:	04.09.18
Permit Set Issue:	07.20.18
Bid Set Issue:	01.14.19
Construction Set Issue:	
Project ID 17065	
Drawing No.	
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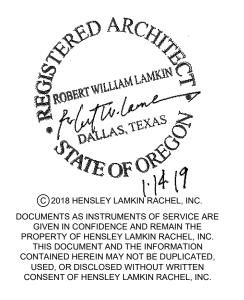
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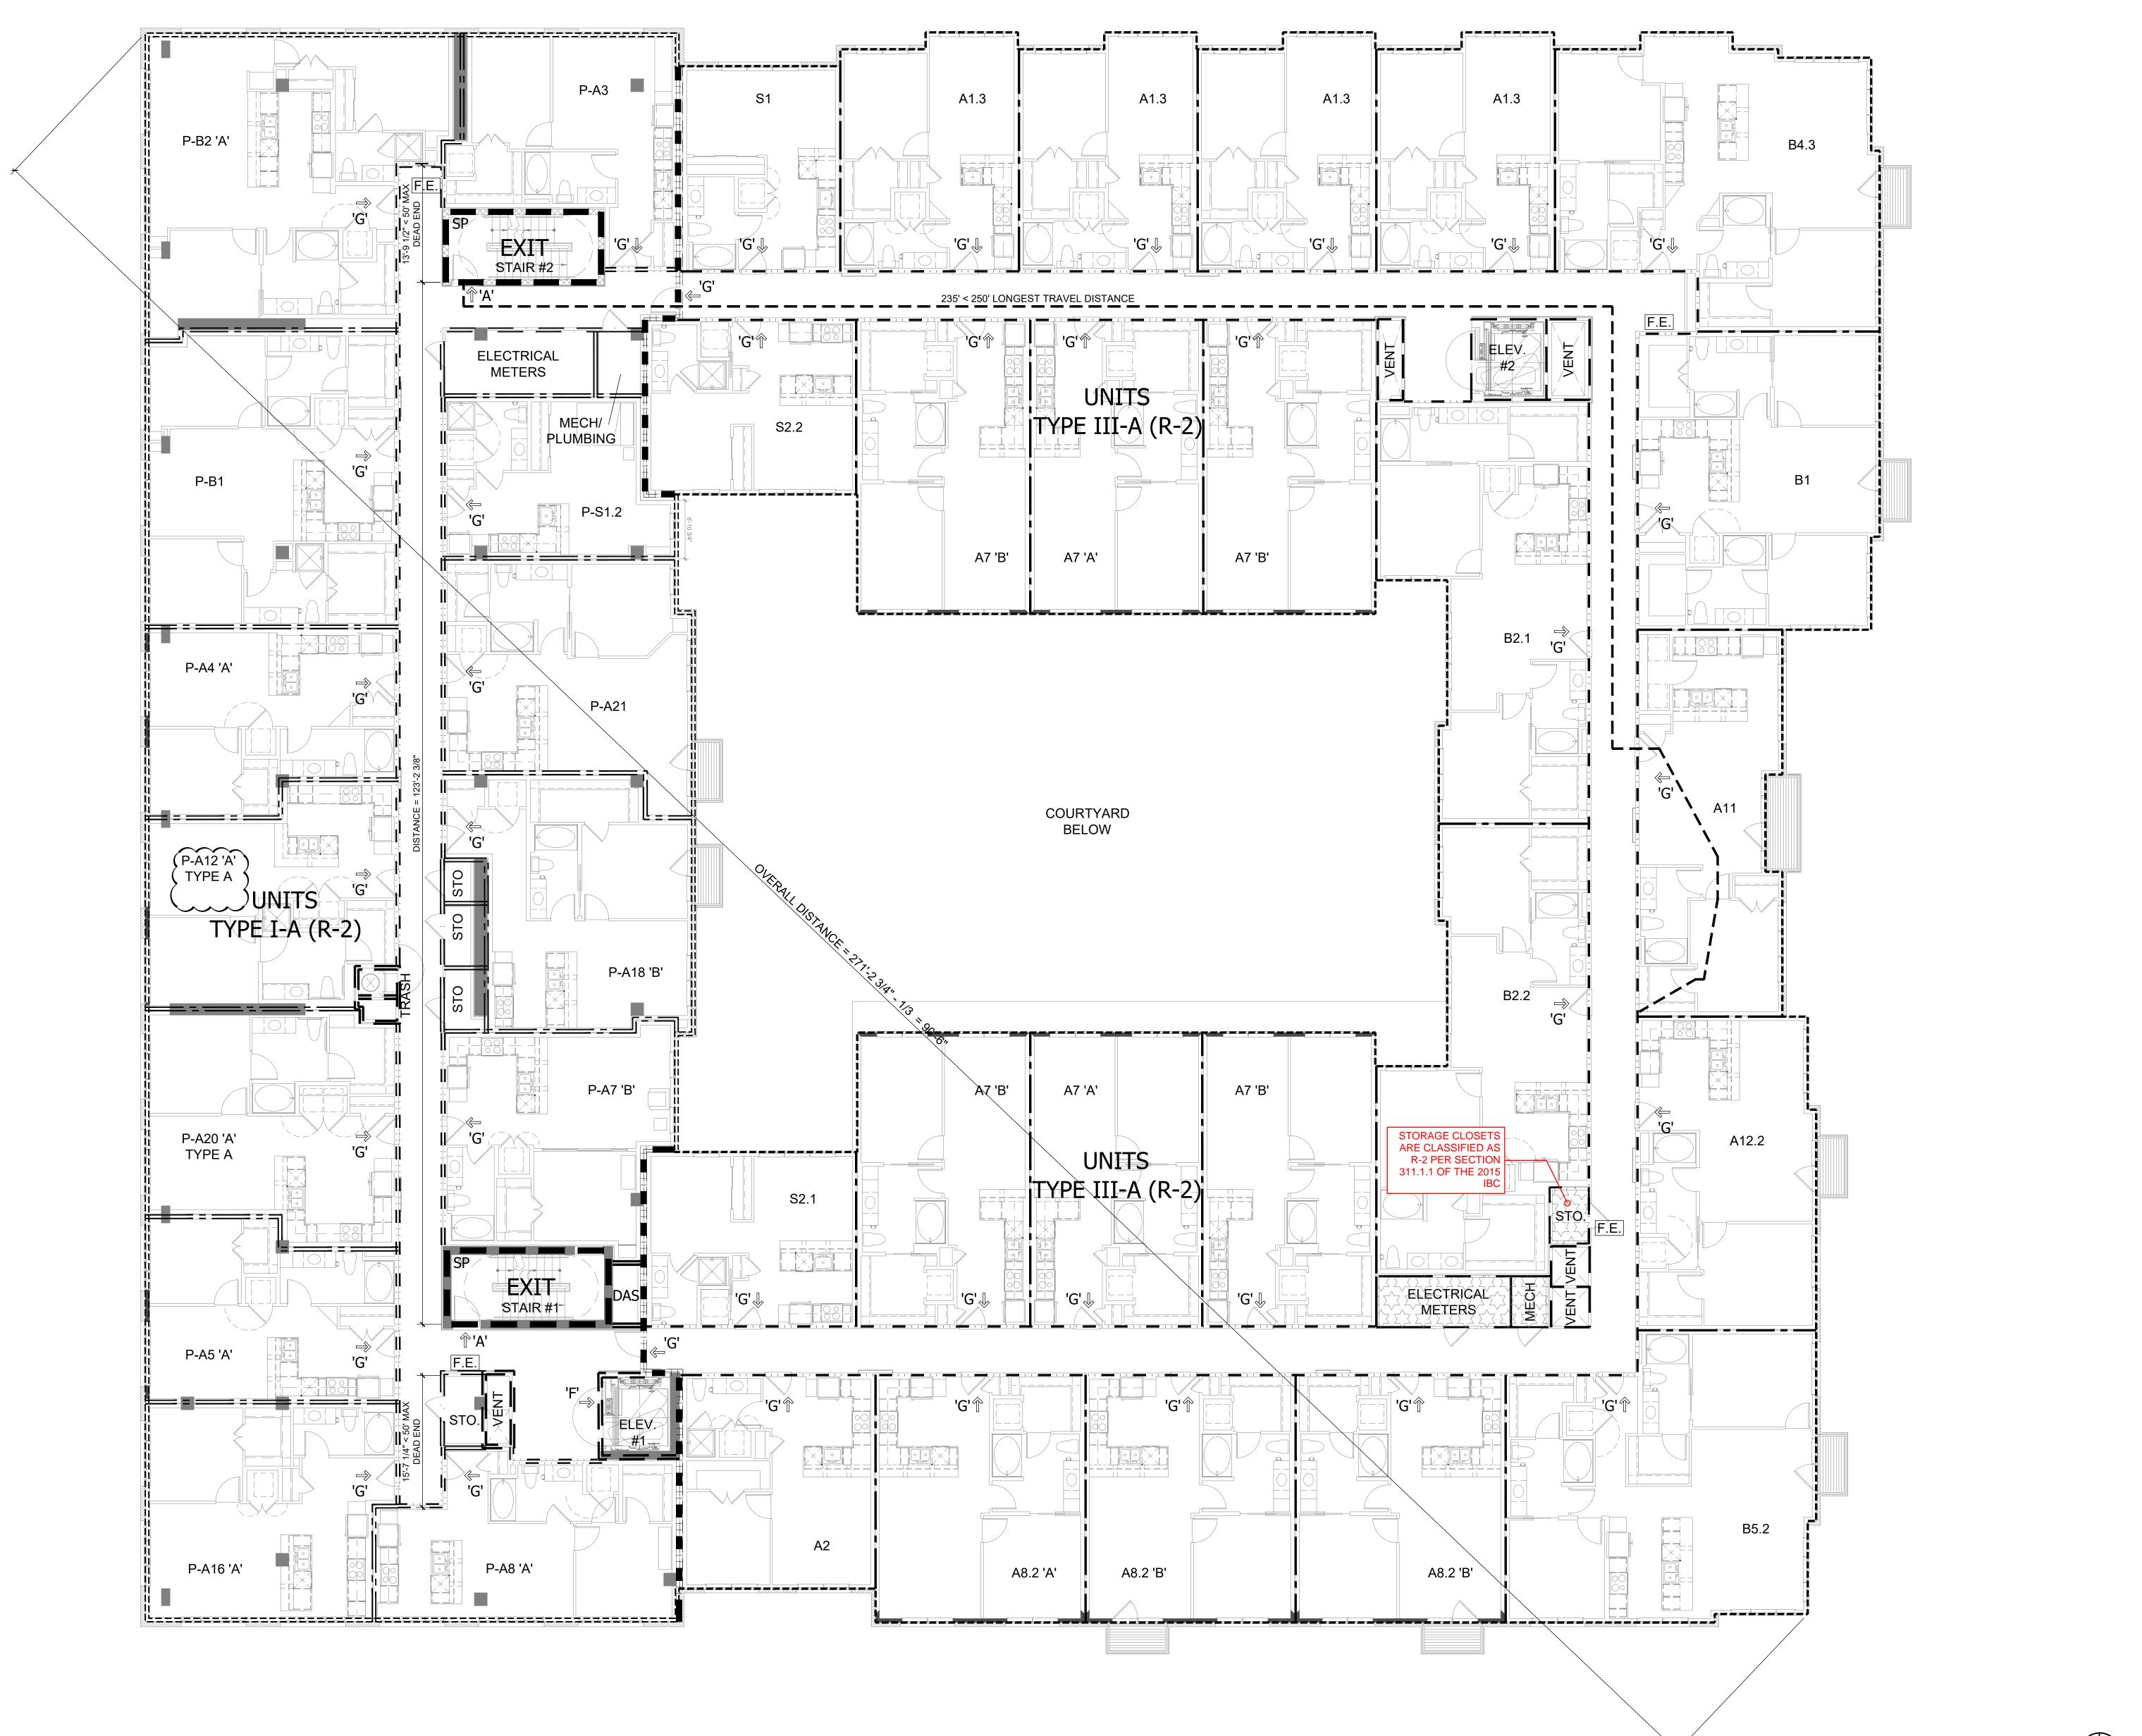


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Drawing No.	С		
EGRESS AND I	FIRE		

PROTECTION DIAGRAM UL1



EXIT PLAN LEGEND

EXIT	BUILDING EXIT
	EXIT ACCESS TRAVEL DISTANCE PER TABLE 1016.2
💪 EXIT	ACCESIBLE BUILDING EXIT

EXIT TYPE	S	V.10.01.14
'A'	VERTICAL EXIT	
'C'	EXIT DISCHARGE	
'D'	COURTYARD EXIT	
Έ'	EXTERIOR EXIT STAIR	
'F'	ACCESSIBLE MEAN OF EGRESS	
'G'	EXIT ACCESS	

NOTE: 1. REFER TO COURTYARD EXIT AREA TABULATIONS FOR EXITING REQUIREMENTS.

FIRE RESITANCE LINETYPE LEGEND

FIRE RESITAN	NCE LINETYPE	LEGEND	
VERTICAL SEPAR	ATIONS (TYPE I-A)		
	3 HR RATED EXTE 722.2.1.1	RIOR WALL - RATIN	G PER TABLE
	• CMU - U.L. #U		
		RATING PER TABLE BARRIER STAIR / E	
	• CMU - U.L. #U		
		RATING PER TABLE GA FILE NO. WP152	
======		RIOR WALL - U.L. #U	
_ = = _	1 HR RATED TENA GA FILE NO. WP50	NT SEPARATION FI	RE PARTITION -
	1 HR RATED EXIT A PARTITION - GA FI	ACCESS CORRIDOR LE NO. WP1522	S FIRE
		ACCESS CORRIDOR ITERIOR WALLS - U.	
	3 HR RATED VERT 2800	ICAL SEPARATION -	GA FILE NO. WP
HORIZONTAL SEF	PARATIONS (TYPE I-	A)	
	3 HR RATED HORI TABLE 722.2.1.1	ZONTAL SEPARATIC	ON - RATING PER
		ZONTAL SEPARATIO	ON - RATING PER
	ATIONS (TYPE III-A)		
	2 HR RATED FIRE	BARRIER STAIR/E	LEVATOR / VENT
	SHAFT / TRASH - L		
	2 HR RATED EXTE BRICK - U.L. # FIBER CEMEN #U301		IHA PANEL - U.L.
<u> </u>	1 HR RATED TENA U.L. #U341	NT SEPARATION FI	RE PARTITION -
			S FIRE
	1 HR RATED EXIT	ACCESS CORRIDOR	
	PARTITION AND IN	ITERIOR WALLS - U.	L. #U305
HORIZONTAL SEF	ARATIONS (TYPE II	I-A) ZONTAL SEPARATIO	N - ESP-1153
		ZONTAL SEPARATIC	
LECEND		\sim	
	DENOTES ACCESS USE	SORY FEC	FIRE EXTINGUISHER CABINET
	DENOTES WALL T	YPE SP	STAND PIPE LOCATION
<u>NOTES:</u> 1. ALL BUILDING	GS TO HAVE A 13 SF		
	R WALLS TO EXTEN	D TO DECK OF FLO	OR ABOVE OR
3. REFER TO BL		ENLARGED PLAN DE ONS.	TAILS FOR
4. FIRE EXTING	UISHER MUST BE LO	OCATED WITHIN 75'- THE BUILDINGS. CO	
	ZONTAL SEPARATIC	IN IS REQUIRED BE	TWEEN THE S-2
6. REF. TO SHE	-	1-2, A-D1.1-6 AND W	
FOR WALL AS	SSEMBLIES USED IN	OR THE ADDITIONAL I THIS PROJECT. RICAL CLOSETS & N	
	LOW THE 3-HR HOR	RIZONTAL SEPARATI	
8. ALL STORAG	E CLOSETS, BOILER	R ROOMS, ELECTRIC	
311.1.1 OF TH	IE 2015 IBC, ACCES	-2 OCCUPANCY. PE SORY STORAGE SP	ACES LESS
	- REFER TO APPEA	SIFIED AS PART OF 1 LS.	THE MAIN
\dots	mm	\dots	\dots
OCCUPANCY	GROUP NOTES		
2. STORAGE CLO		JPANCY, R-2 PER NOT Y USES TO THE R-2 O ATION BELOW.	
• FLOOR AREA =	-		
		ORY USES $(10\%) = 3$,157 S.F.
	SE AREAS = 502 S.F AGE, ELEC. & MECH. C		
STAIDWAVE	EGRESS SIZIN	G	uuu
GROSS FLOOR AREA		EXIT WIDTH	EXIT WIDTH
OCCUPANCY	OCC. LOAD	REQUIRED	PROVIDED
	200 GROSS=	1	1

OCCUPANCY	OCC. LOAD	REQUIRED	PRO	
R-2 = 31,565 SF	200 GROSS= 157/2 = 78 OCC. EACH STAIR	15.6" EACH STAIR	EACH	
EXIT WIDTH OF STAIRWAY IS CALCULATED WITH A FACTOR OF 0.2" PE OCCUPANT PER SECTION 1005.3.1, EXCEPTION #1.				
STAIR #	OCC. LOAD	EXIT ENTRY WIDTH REQUIRED	EXIT ENT PRO	
STAIR #1 STAIR #2	78 OCC.	11.7"	3	

WIDTH OF ENTRY DOOR TO THE STAIRWAY IS CALCULATED WITH A FACTOR OF 0.15" PER OCCUPANT PER SECTION 1005.3.2, EXCEPTION #1.

V.10.01.14

IT WIDTH OVIDED _____ 44" CH STAIR _____ PER


_____ NTRY WIDTH OVIDED _____ 36"





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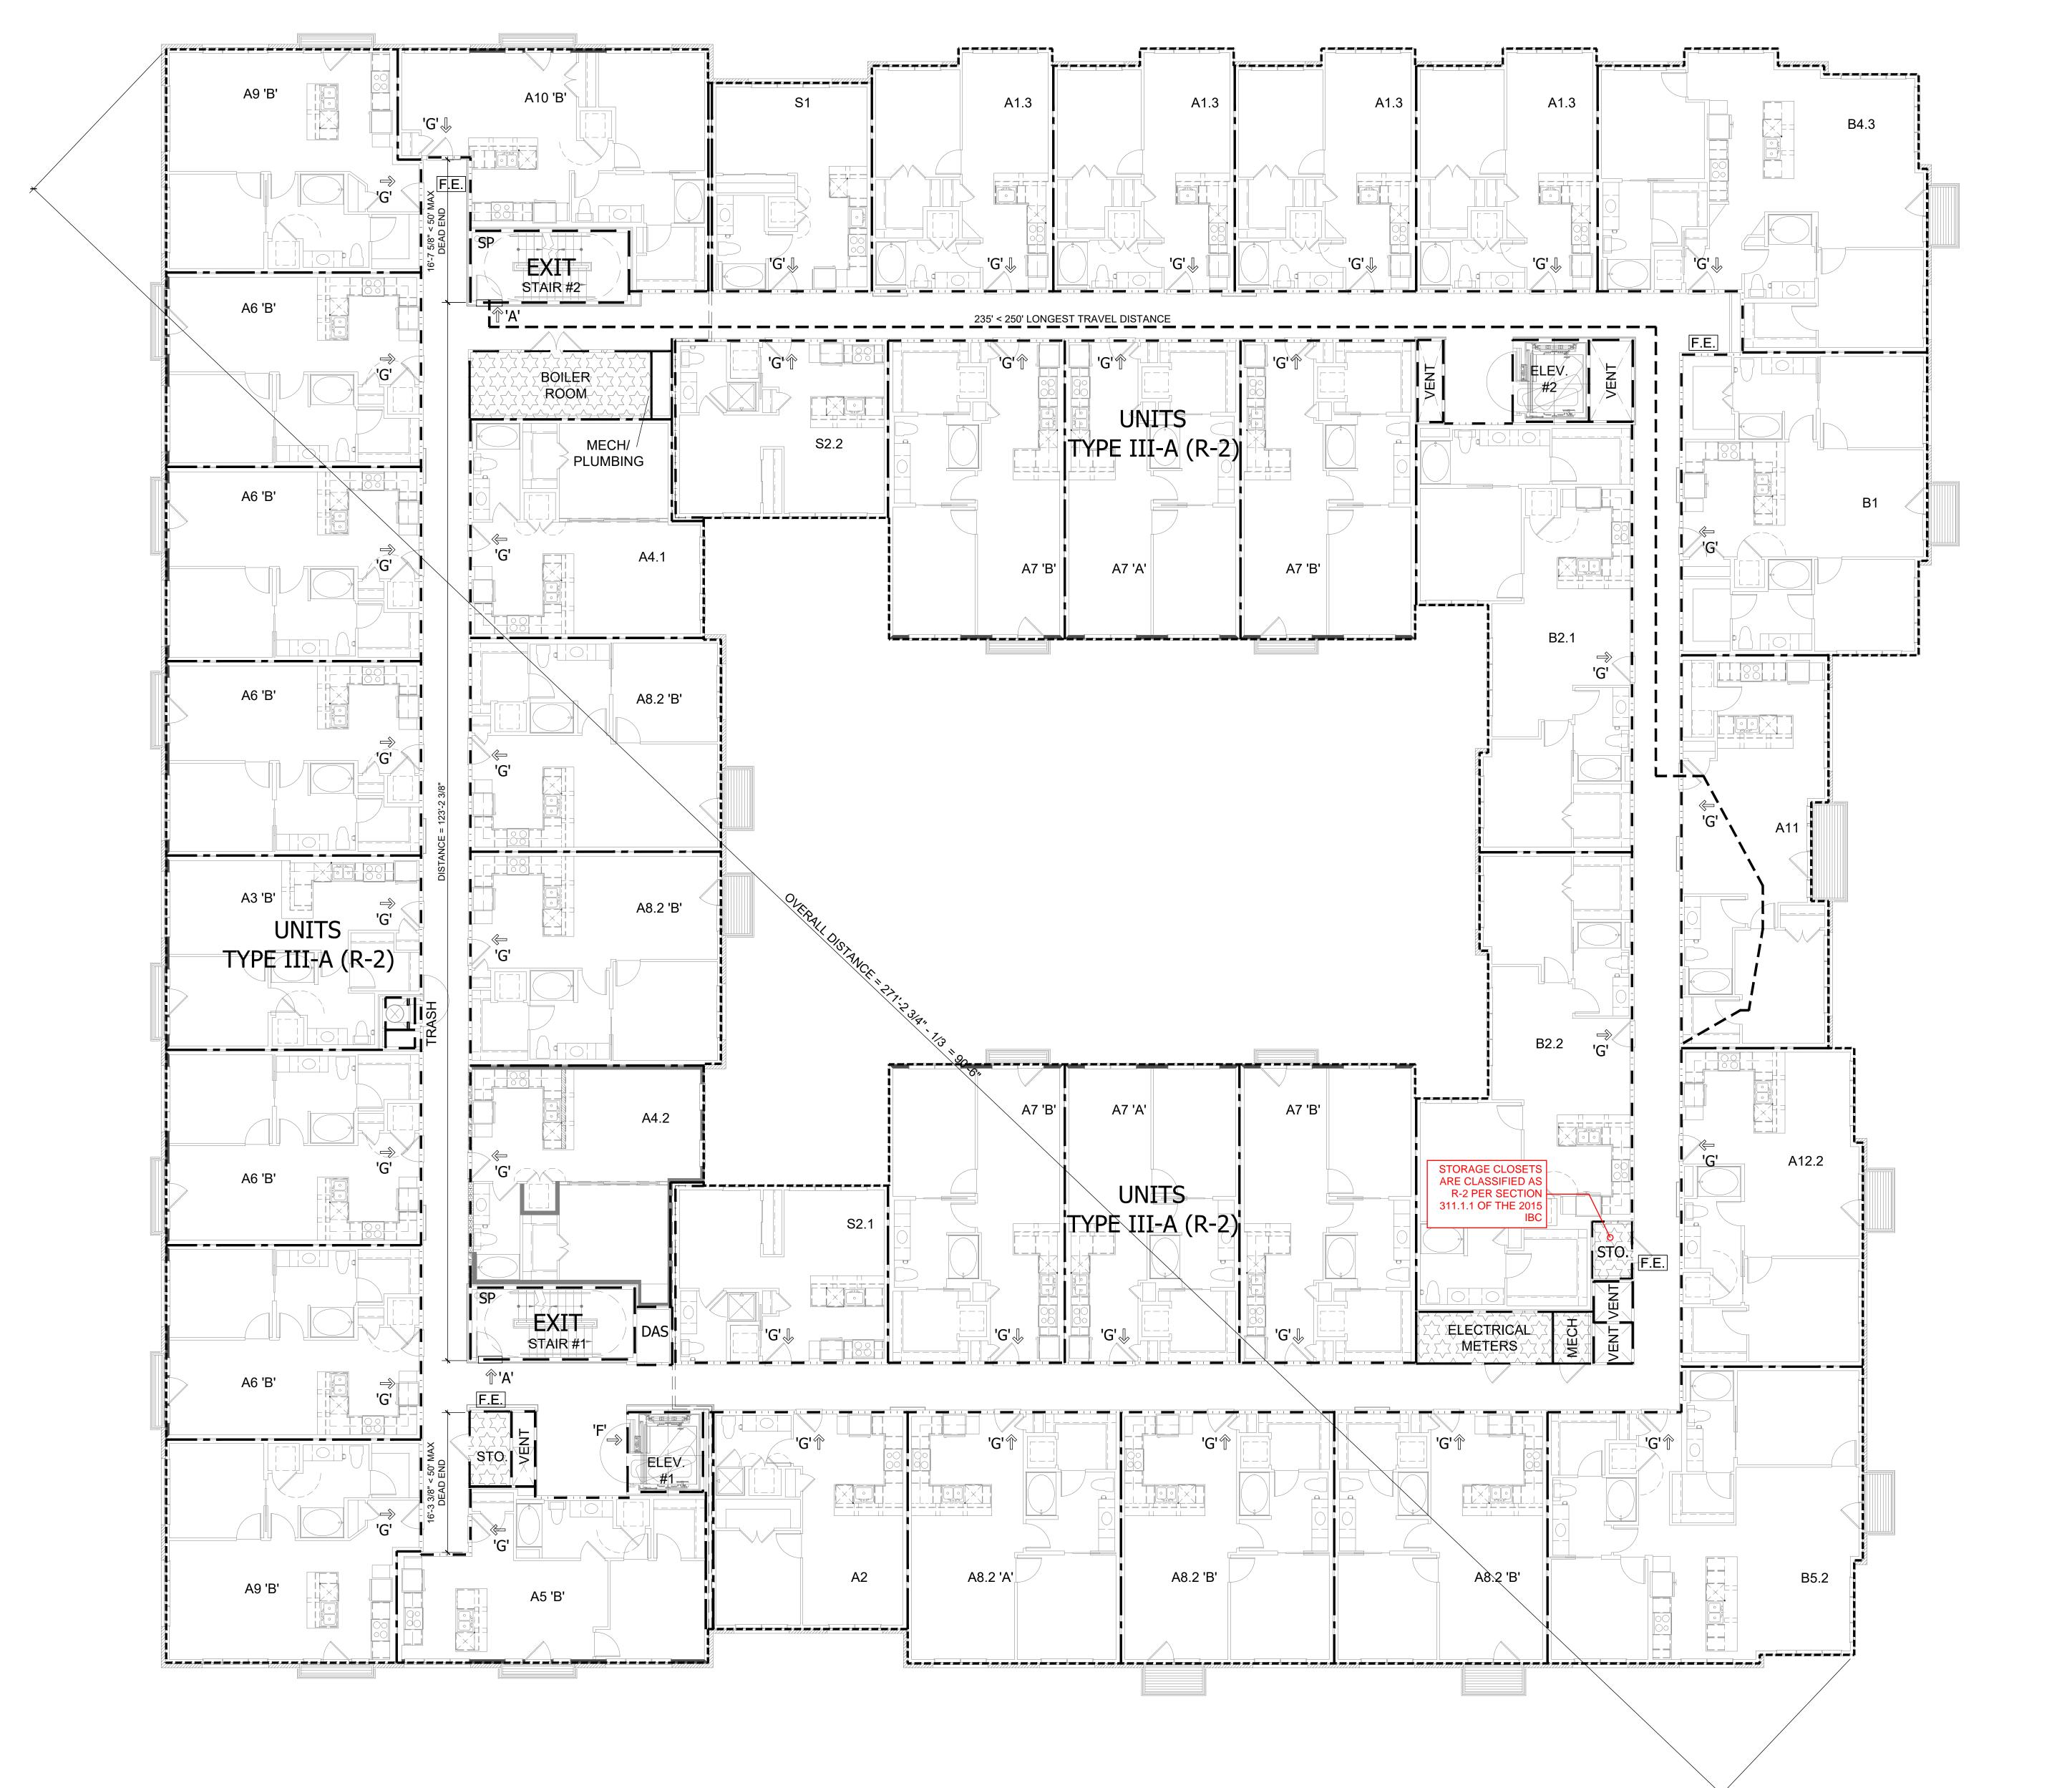


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	EXIT ACCESS TRAVEL DISTANCE PER TABLE 1016.2
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'A'	VERTICAL EXIT	
miĝi		
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'F'	ACCESSIBLE MEAN OF EGRESS	
'G'	EXIT ACCESS	

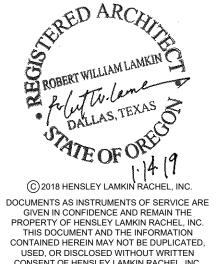NOTE: 1. REFER TO COURTYARD EXIT AREA TABULATIONS FOR EXITING REQUIREMENTS.

FIRE RESITANCE LINETYPE LEGEND

FIRE RESITAN	NCE LINETYPE	LEGEND	
VERTICAL SEPAR	RATIONS (TYPE I-A)		
	3 HR RATED EXTE 722.2.1.1	RIOR WALL - RATIN	G PER TABLE
	• CMU - U.L. #U	BARRIER STAIR SH 904 RATING PER TABLE	
	SHAFT / TRASH / E • CMU - U.L. #U	BARRIER STAIR / E ELECTRICAL ROOM 905 RATING PER TABLE	3
=======		GA FILE NO. WP152	
	1 HR RATED TENA	NT SEPARATION FI	
		ACCESS CORRIDOF	RS FIRE
		ACCESS CORRIDOF	
		ITERIOR WALLS - U	
	2800	• `	
	PARATIONS (TYPE I- 3 HR RATED HORI	A) ZONTAL SEPARATIO	ON - RATING PER
	TABLE 722.2.1.1 2 HR RATED HORI TABLE 722.2.1.1	ZONTAL SEPARATIO	ON - RATING PER
VERTICAL SEPAR	RATIONS (TYPE III-A))	
	2 HR RATED FIRE SHAFT / TRASH - U	BARRIER STAIR / E J.L. #U301	LEVATOR / VENT
	2 HR RATED EXTE BRICK - U.L. # FIBER CEMEN #U301		IIHA PANEL - U.L.
<u> </u>	1 HR RATED TENA U.L. #U341	NT SEPARATION FI	RE PARTITION -
	1 HR RATED EXIT PARTITION - GA F	ACCESS CORRIDOF ILE NO. WP3380	RS FIRE
		ACCESS CORRIDOF	
HORIZONTAL SEF	PARATIONS (TYPE II	I-A)	
	1 HR RATED HORI	ZONTAL SEPARATIO	DN - ESR-1153
	1 HR RATED HORI	ZONTAL SEPARATIO	DN - UL-#P522
	DENOTES ACCES		FIRE EXTINGUISHER
	DENOTES WALL T	YPE SP	CABINET STAND PIPE LOCATION
NOTES:			
	R WALLS TO EXTEN	PRINKLER SYSTEM. ID TO DECK OF FLO	
3. REFER TO BU		ENLARGED PLAN DI ONS.	ETAILS FOR
DISTANCE F	ROM ALL POINTS IN	OCATED WITHIN 75' THE BUILDINGS. C	
		N IS REQUIRED BE	TWEEN THE S-2
6. REF. TO SHE	ETS A-D1.1-1, A-D1.	1-2, A-D1.1-6 AND W OR THE ADDITIONAL	
7. ALL STORAG		RICAL CLOSETS & M	
OCCUPANCY		RIZONTAL SEPARAT	
	CLOSET ABOVE TH	HE 3-HR HORIZONT/ R-2 OCCUPANCY. PI	AL SEPARATION
311.1.1 OF TH THAN 100 S.F	<mark>HE 2015 IBC, ACCES</mark>	SORY STORAGE SP	ACES LESS
	GROUP NOTES		
2. STORAGE CLO		UPANCY, R-2 PER NO Y USES TO THE R-2 C ATION BELOW.	
FLOOR AREA =MAX. ALLOWA		ORY USES (10%) = 3	,182 S.F.
	SE AREAS = 376 S.F AGE, ELEC. & MECH. (
STAIRWAYS	EGRESS SIZIN	G	
GROSS FLOOR AREA PER OCCUPANCY	OCC. LOAD	EXIT WIDTH REQUIRED	EXIT WIDTH PROVIDED
	200 GROSS=		

GROSS FLOOR AREA PER OCCUPANCY	OCC. LOAD	EXIT WIDTH REQUIRED	EXIT PRO
R-2 = 31,848 SF	200 GROSS= 159/2 = 79 OCC. EACH STAIR	15.8" EACH STAIR	EAC
	AIRWAY IS CALCULAT CTION 1005.3.1, EXCE		of 0.2" pe

STAIR #	OCC. LOAD	EXIT ENTRY WIDTH REQUIRED	EXIT ENTRY WIDTH PROVIDED
STAIR #1 STAIR #2	79 OCC.	11.85"	36"
WIDTH OF ENTRY	DOOR TO THE STAIR	NAY IS CALCULATED	WITH A FACTOR OF

0.15" PER OCCUPANT PER SECTION 1005.3.2, EXCEPTION #1.



V.10.01.14

T WIDTH ROVIDED 44" ACH STAIR PER


ENTRY WIDTH ROVIDED _____ 36"





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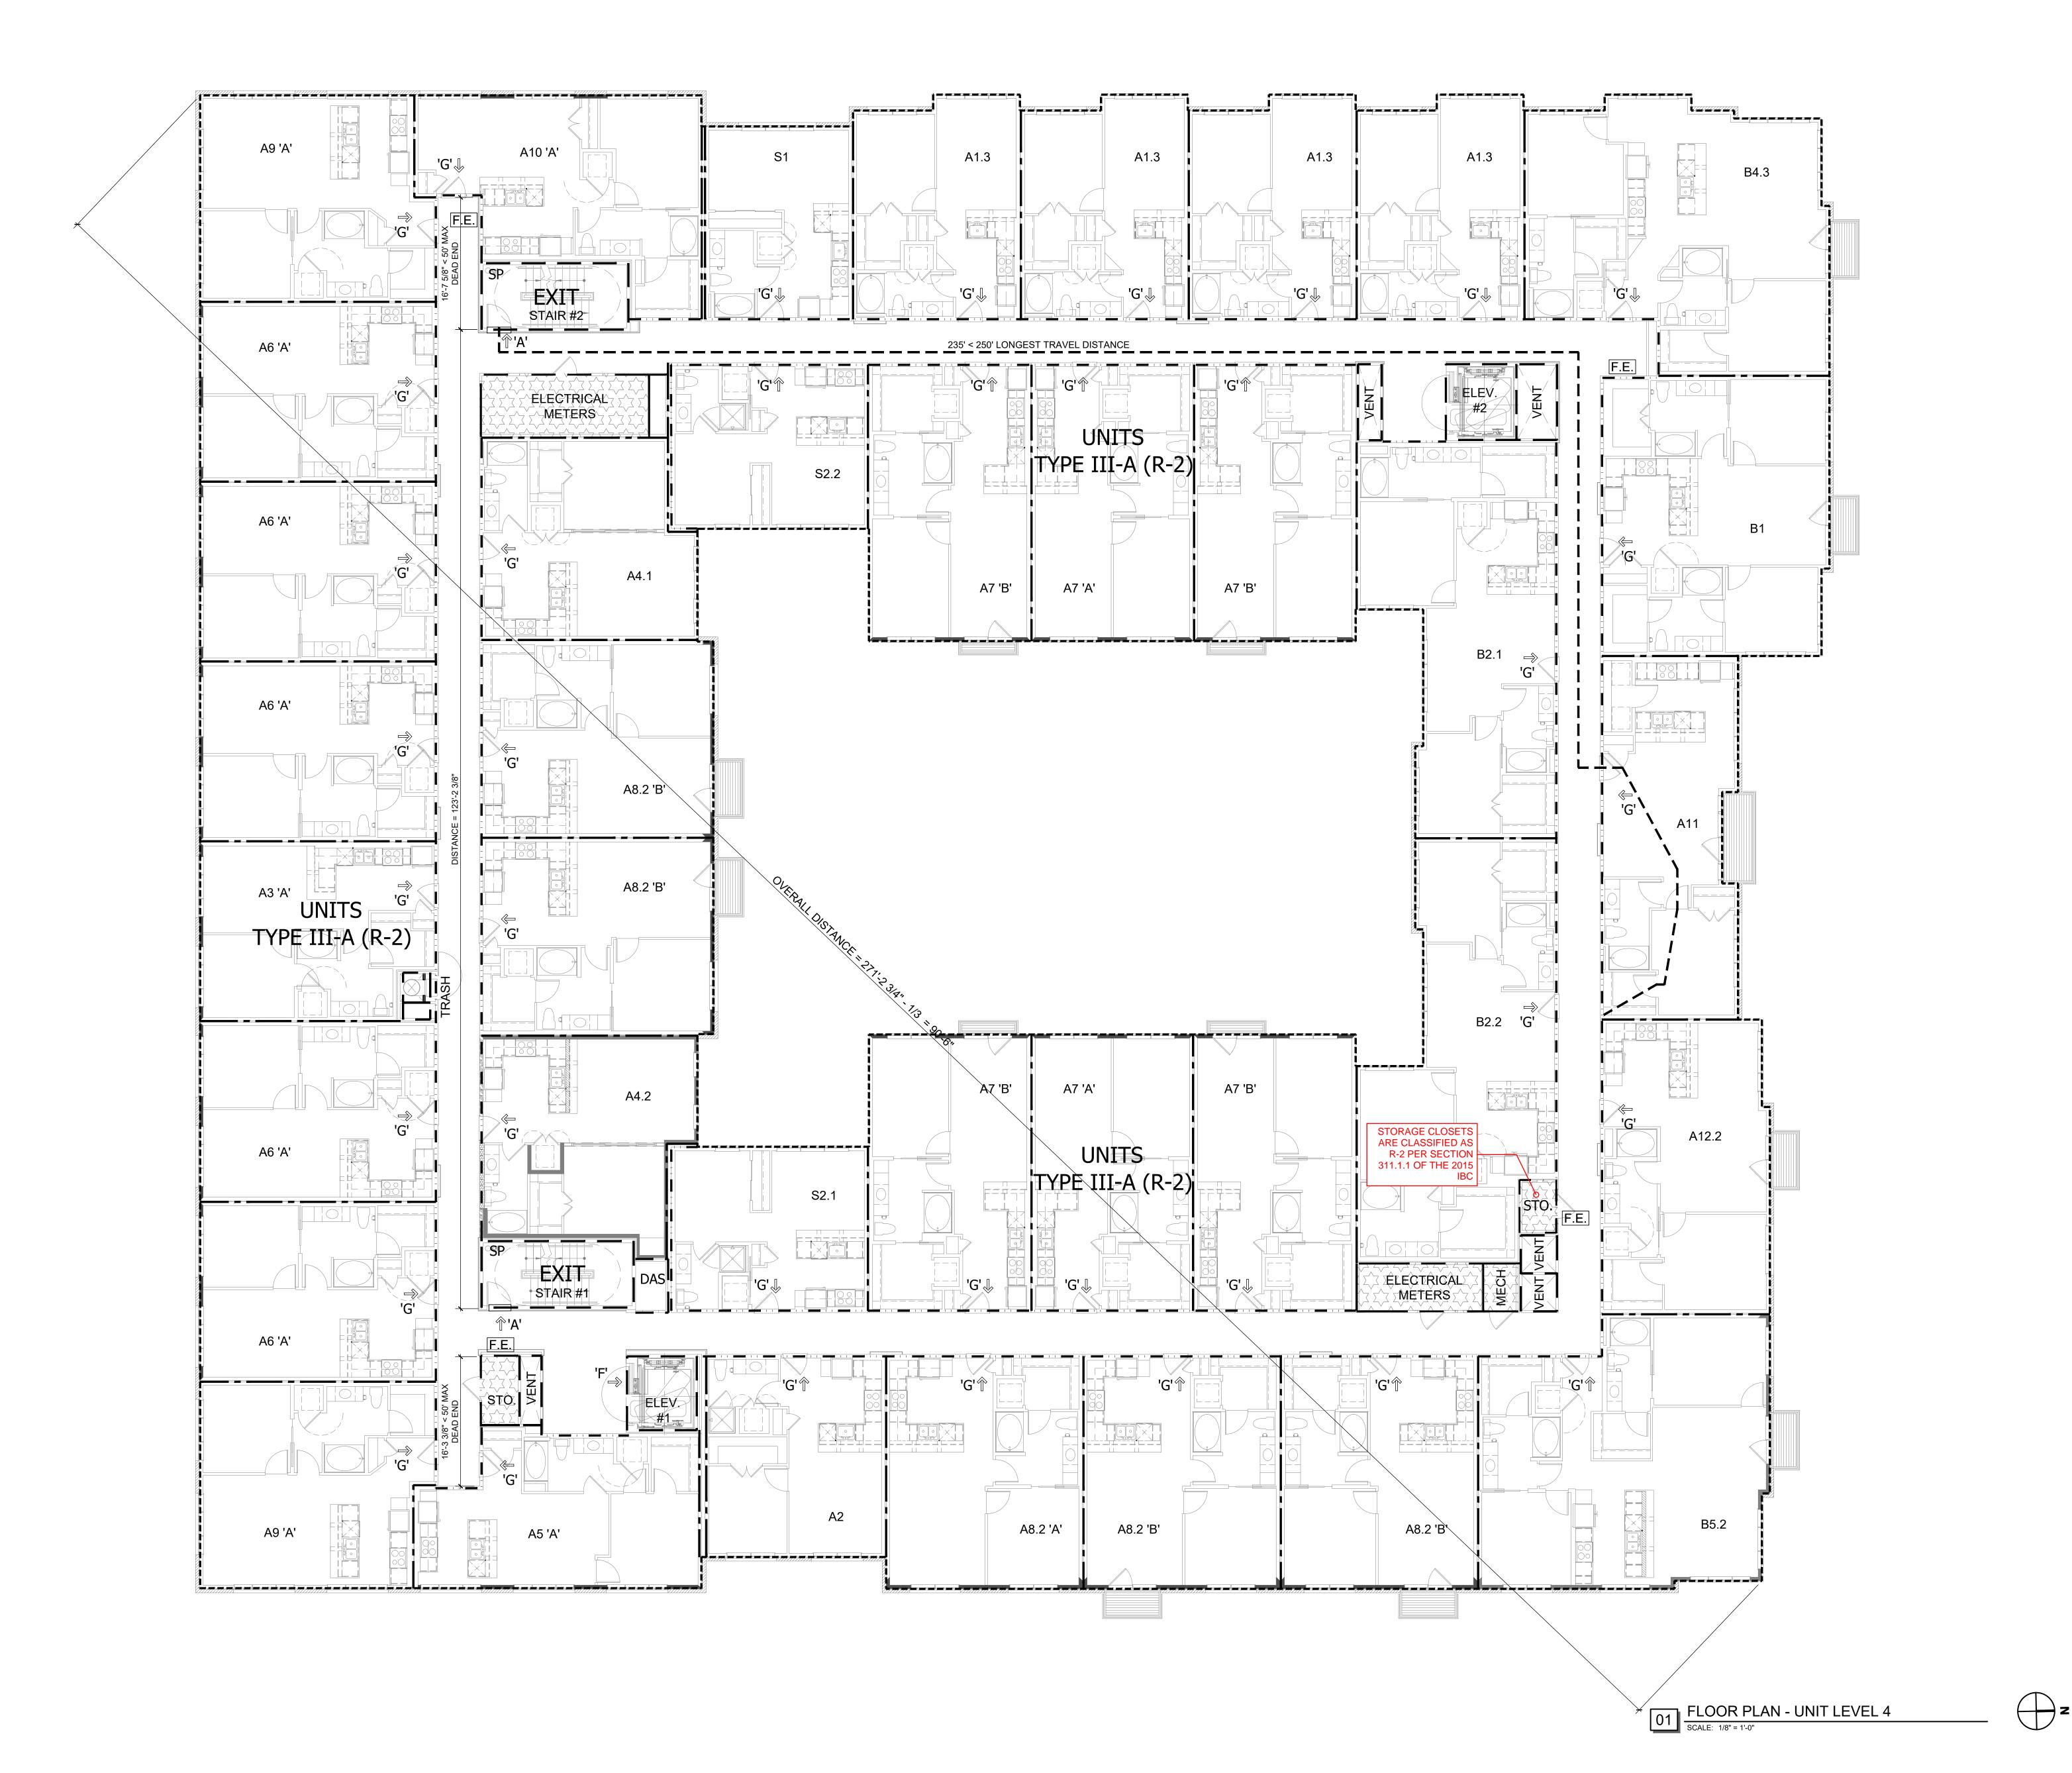


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EGRESS AND F	FIRE					

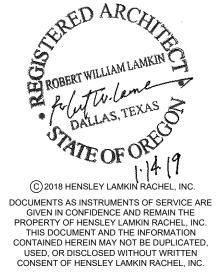PROTECTION DIAGRAM UL3



EXIT PLAN LEGEND

EXIT	BUILDING EXIT
	EXIT ACCESS TRAVEL DISTANCE PER TABLE 1016.2
🖧 EXIT	ACCESIBLE BUILDING EXIT

EXIT TYPE	S	V.10.01.14
'A'	VERTICAL EXIT	
'C'	EXIT DISCHARGE	
'D'	COURTYARD EXIT	
'E'	EXTERIOR EXIT STAIR	
'F'	ACCESSIBLE MEAN OF EGRESS	
'G'	EXIT ACCESS	

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FIR	E RESITAI	NCE LINETYPE	LEGEND							
VEF	TICAL SEPAR	RATIONS (TYPE I-A)								
		3 HR RATED EXTE 722.2.1.1	RIOR WALL - RATIN	G PER TABLE						
		• CMU - U.L. #U								
CONCRETE - RATING PER TABLE 722.2.1.1 2 HR RATED FIRE BARRIER STAIR / ELEVATOR / V SHAFT / TRASH / ELECTRICAL ROOMS										
 SHAFT / TRASH / ELECTRICAL ROOMS CMU - U.L. #U905 CONCRETE - RATING PER TABLE 722.2.1.1 										
==	=====		GA FILE NO. WP152 RIOR WALL - U.L. #U							
		1 HR RATED TENA GA FILE NO. WP50	NT SEPARATION FI	RE PARTITION -						
	_ : :		ACCESS CORRIDOF	RS FIRE						
_		1 HR RATED EXIT	ACCESS CORRIDOF							
		3 HR RATED VERT	ICAL SEPARATION							
HOF	RIZONTAL SEF	2800 PARATIONS (TYPE I-	A)							
			ZONTAL SEPARATIO	ON - RATING PER						
	=::===		ZONTAL SEPARATIO	ON - RATING PER						
VEF	TICAL SEPAR	RATIONS (TYPE III-A))							
1		2 HR RATED FIRE	BARRIER STAIR / E	LEVATOR / VENT						
_		SHAFT / TRASH - U								
		• BRICK - U.L. #		IIHA PANEL - U.L.						
		1 HR RATED TENA U.L. #U341	NT SEPARATION FI	RE PARTITION -						
			ACCESS CORRIDOF	RS FIRE						
		1 HR RATED EXIT	ACCESS CORRIDOF							
				L. #0000						
		PARATIONS (TYPE II 1 HR RATED HORI	ZONTAL SEPARATIO	DN - ESR-1153						
		1 HR RATED HORI	ZONTAL SEPARATIO	ON - UL-#P522						
LEC										
3		DENOTES ACCESS USE	SORY FEC	FIRE EXTINGUISHER CABINET						
		DENOTES WALL T	YPE SP	STAND PIPE LOCATION						
<u>NO</u> 1										
1. 2.	FIRE BARRIE	GS TO HAVE A 13 SF R WALLS TO EXTEN								
3.	-	UK. JILDING PLAN AND I ASSEMBLY LOCATIO	-	ETAILS FOR						
4.	FIRE EXTING	UISHER MUST BE LORING ALL POINTS IN	OCATED WITHIN 75'							
5.		ZONTAL SEPARATIC		TWEEN THE S-2						
6.	REF. TO SHE	2 OCCUPANCIES PER ETS A-D1.1-1, A-D1.2 BUILDING PLANS FO	1-2, A-D1.1-6 AND W							
7.	FOR WALL A	SSEMBLIES USED IN E CLOSETS, ELECT	THIS PROJECT.							
	CLOSETS BE OCCUPANCY	LOW THE 3-HR HOR	RIZONTAL SEPARAT	ION TO BE S-1						
<mark>8.</mark>	MECHANICA	E CLOSETS, BOILER CLOSET ABOVE TH ORY USE TO THE R	HE 3-HR HORIZONT	AL SEPARATION						
	311.1.1 OF TH	HE 2015 IBC, ACCES ARE TO BE CLASS	SORY STORAGE SP	ACES LESS						
\sim	OCCUPANCY	- REFER TO APPEA	LS.							
00		GROUP NOTES								
1. 2.	STORAGE CLC	IAS ONE SINGLE OCCU ISETS ARE ACCESSOR 2. REFER TO CALCUL	Y USES TO THE R-2 C							
•	Floor Area = Max. Allowa	= 31,738 S.F. BLE AREA OF ACCESS	ORY USES (10%) = 3	,174 S.F.						
•		SE AREAS = 376 S.F AGE, ELEC. & MECH. C								
ST4	IRWAYS	EGRESS SIZIN	G	uuu						
	FLOOR AREA	OCC. LOAD	EXIT WIDTH	EXIT WIDTH						
PER	OCCUPANCY	200 GROSS=	REQUIRED	PROVIDED						
R-2	= 31,738 SF	158/2 = 79 OCC. EACH STAIR	15.8" EACH STAIR	44" EACH STAIR						

_	OCCUPANT PER SE	CTION 1005.3.1, EXCE	EPTION #1.	
	STAIR #	OCC. LOAD	EXIT ENTRY WIDTH REQUIRED	EXIT ENT PRO
-	STAIR #1 STAIR #2	79 OCC.	11.85"	3

WIDTH OF ENTRY DOOR TO THE STAIRWAY IS CALCULATED WITH A FACTOR OF 0.15" PER OCCUPANT PER SECTION 1005.3.2, EXCEPTION #1.

V.10.01.14

IT WIDTH ROVIDED 44" ACH STAIR EXIT WIDTH OF STAIRWAY IS CALCULATED WITH A FACTOR OF 0.2" PER


> _____ NTRY WIDTH OVIDED _____ 36"





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A0.3	F					
EGRESS AND F						

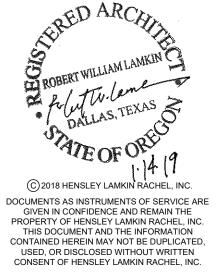

01 FLOOR PLAN - UNIT LEVEL 5 SCALE: 1/8" = 1'-0"



V.10.01.14

EXIT PLAN LEGEND

BUILDING EXIT

EXIT ACCESS TRAVEL DISTANCE PER TABLE 1016.2

C EXIT ACCESIBLE BUILDING EXIT

EXIT

V.10.01.14

FIRE

EXTINGUISHER CABINET STAND PIPE LOCATION

EXIT WIDTH PROVIDED 44" EACH STAIR


PROVIDED 36"





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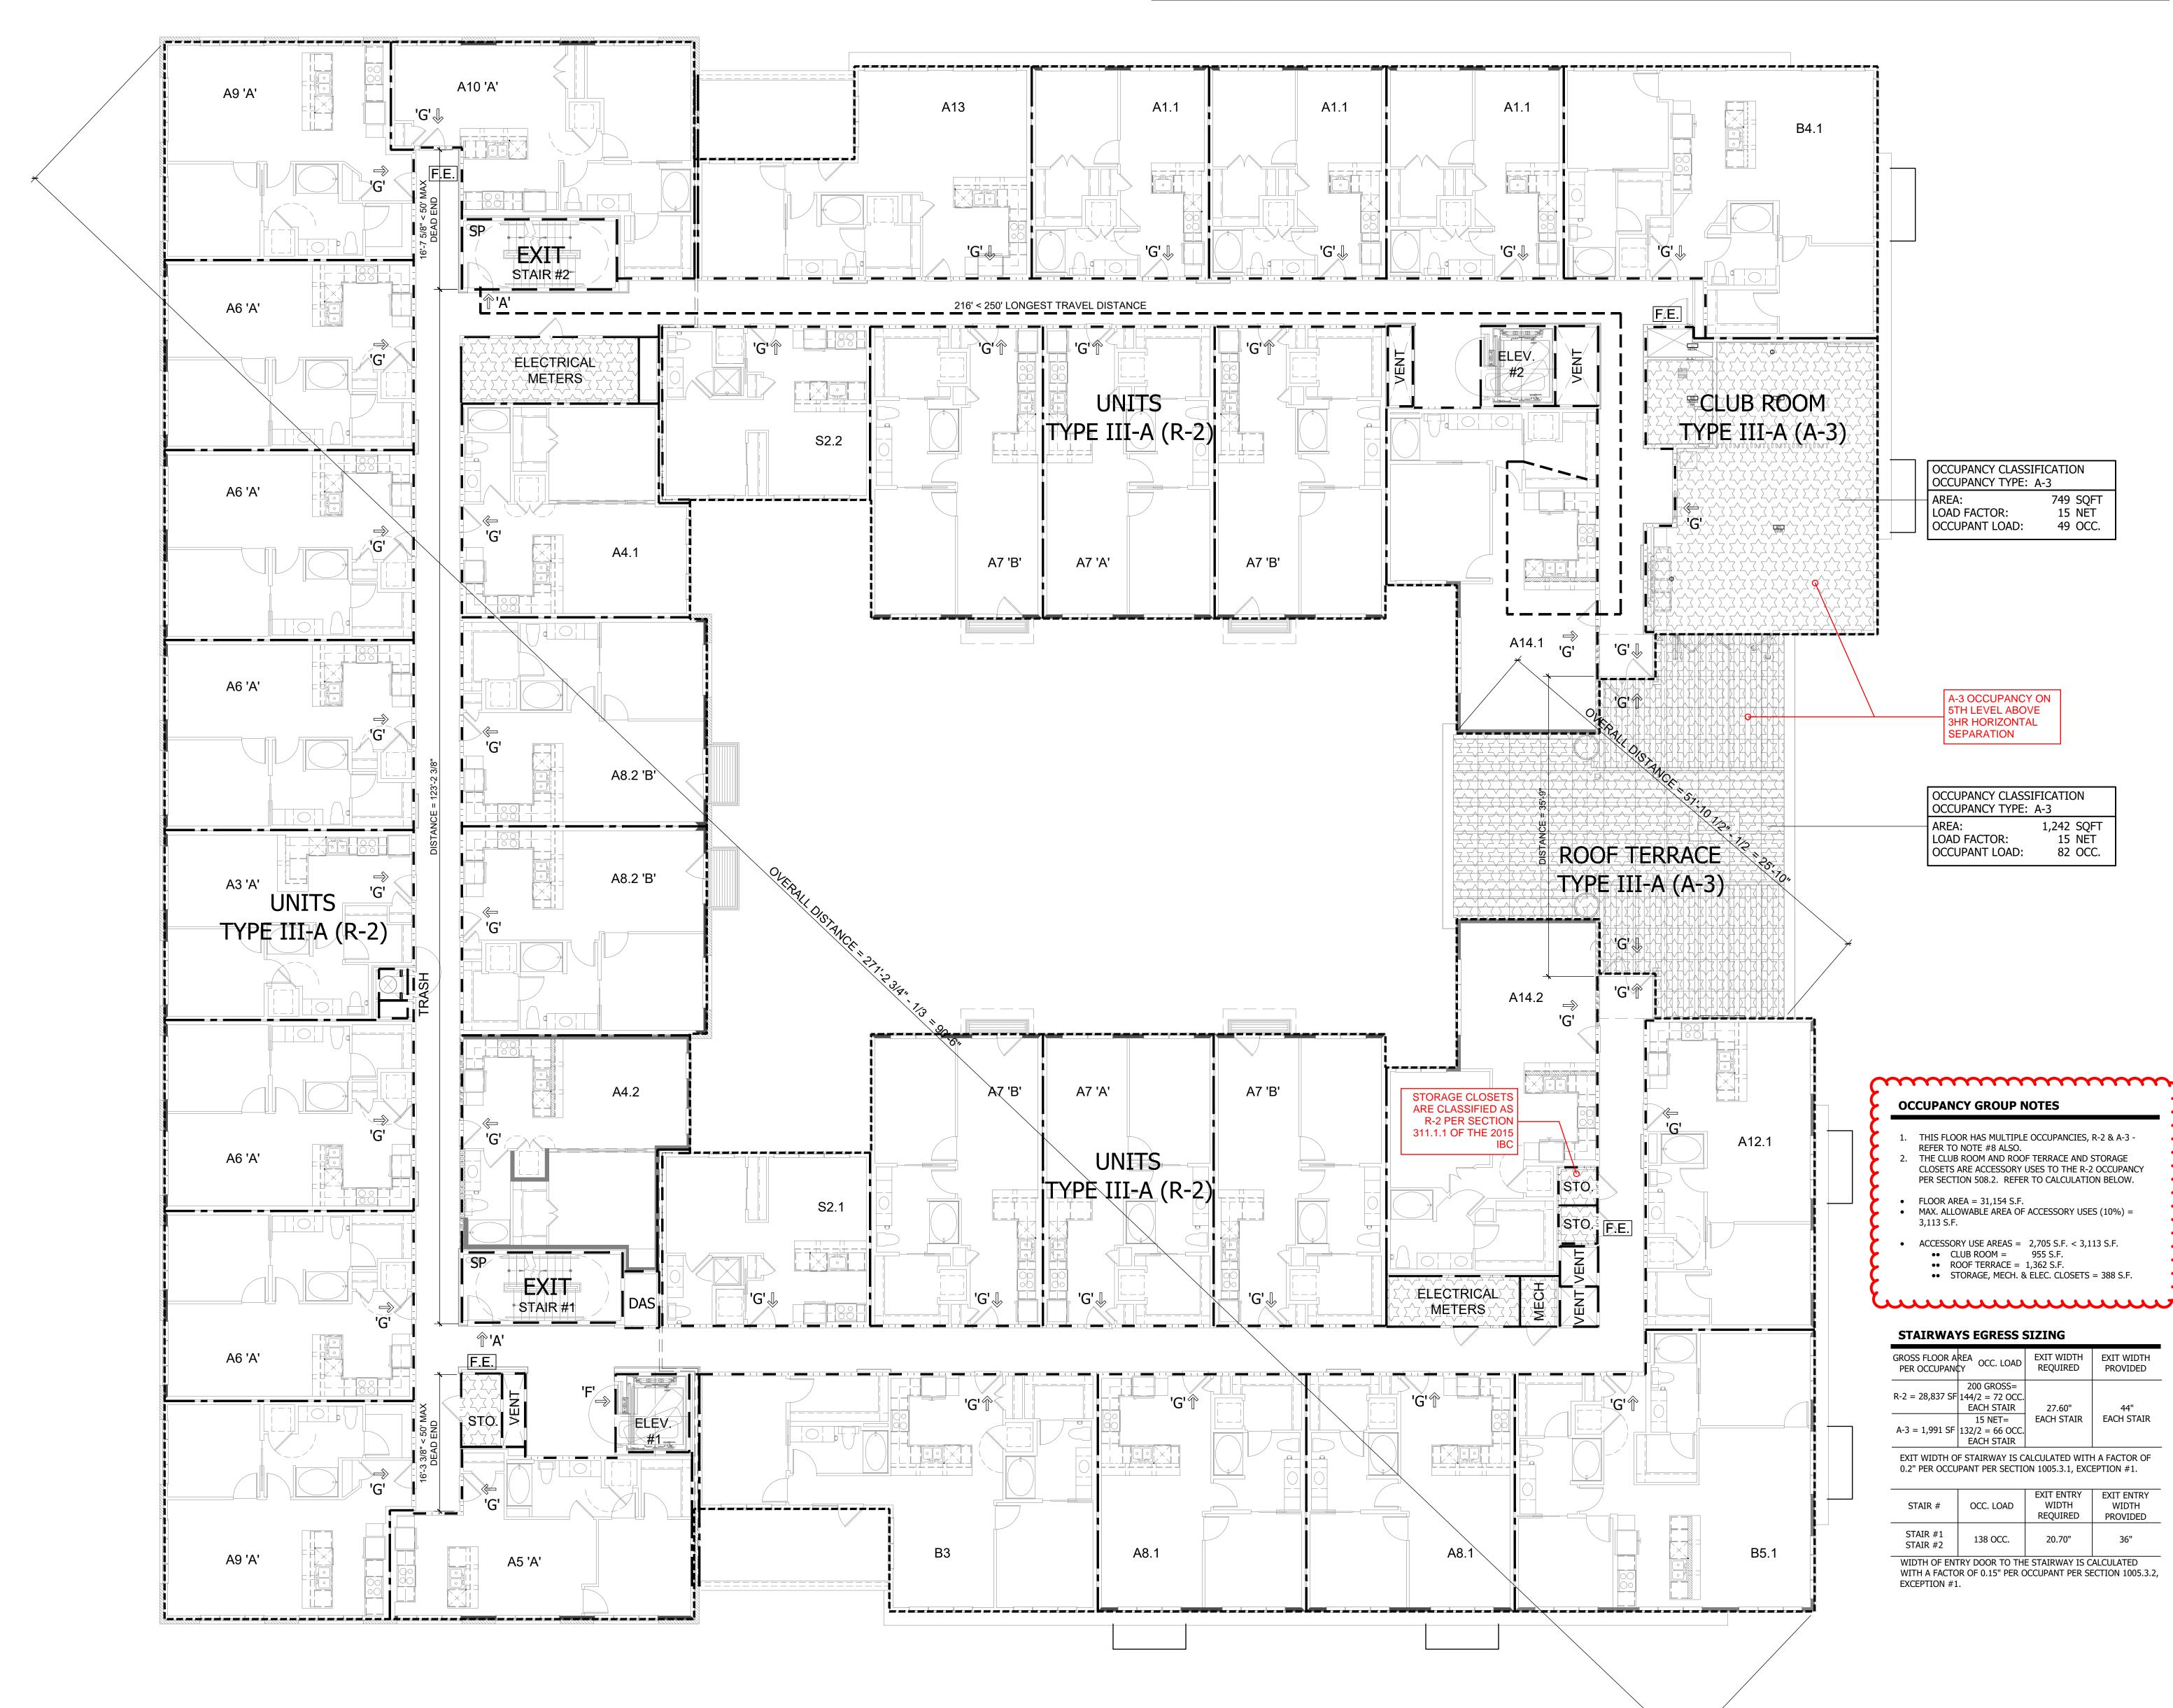


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PLUMBING FIXTURES	OCCUPANCY			WATER C	LOSETS				LAVATORI	S				DRINKING FO	UNTAINS	SERVICE SINK	*	EXIT P
CALCULATIONS -	USE		LOAD	RATIO	MALE	RATIO	FEMALE		RATIO	MALE	RATIO	FEMALE		RATIO		THE CODE REQUIRES ONLY ONE SERVICE SINK PER BLDG. IF ALL	NOTES: 1. REFER TO APPEALS FOR PLUMBING	
UL6	CLUB	A3	49	1x125	0.20	1x65	0.36		1x200	0.12	1x200	0.12		1x500	0.10	OCCUPANCIES HAVE ACCESS TO THE	FIXTURES PROVIDED FOR THE CLUB AND ROOF TERRACE AMENITIES.	EX
PER TABLE 2902.1 OF 2014 OSSC	ROOF TERRACE	A3	82	1x125	0.33	1x65	0.63		1x200	0.20	1x200	0.20		1x500	0.16	SERVICE SINK		
	SUBTOTAL				.53		.96			0.32		0.32			0.26	1		£.
	REQ. TOTALS				1		1	2		1		1	2		1	1		G. E
	PROVIDED *							1					1		-	1		

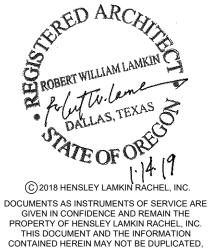

EXIT TYPE	V.10.01.14	
'A'	VERTICAL EXIT	
'C'	EXIT DISCHARGE	
'D'	COURTYARD EXIT	
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'G'	EXIT ACCESS	

NOTE: 1. REFER TO COURTYARD EXIT AREA TABULATIONS FOR EXITING REQUIREMENTS.

FIRE RESITANCE LINETYPE LEGEND

VERTICAL SEPAR	RATIONS (TYPE I-A)	
	3 HR RATED EXTERIOR WALL - RAT 722.2.1.1	ING PER TABLE
	 3 HR RATED FIRE BARRIER STAIR S CMU - U.L. #U904 CONCRETE - RATING PER TABL 	
	2 HR RATED FIRE BARRIER STAIR / SHAFT / TRASH / ELECTRICAL ROOM CMU - U.L. #U905 CONCRETE - RATING PER TABL MTL. STUDS - GA FILE NO. WP1	ELEVATOR / VEN MS .E 722.2.1.1
======	1 HR RATED EXTERIOR WALL - U.L.	#U419
	1 HR RATED TENANT SEPARATION GA FILE NO. WP5006	FIRE PARTITION -
	1 HR RATED EXIT ACCESS CORRIDO PARTITION - GA FILE NO. WP1522	ORS FIRE
	1 HR RATED EXIT ACCESS CORRIDO PARTITION AND INTERIOR WALLS -	
	3 HR RATED VERTICAL SEPARATION 2800	N - GA FILE NO. WI
HORIZONTAL SEI	PARATIONS (TYPE I-A)	
	3 HR RATED HORIZONTAL SEPARAT TABLE 722.2.1.1	TION - RATING PE
	2 HR RATED HORIZONTAL SEPARAT TABLE 722.2.1.1	TION - RATING PE
VERTICAL SEPAR	RATIONS (TYPE III-A)	
	2 HR RATED FIRE BARRIER STAIR / SHAFT / TRASH - U.L. #U301	ELEVATOR / VEN
	 2 HR RATED EXTERIOR WALL BRICK - U.L. #U302 FIBER CEMENT SIDING AND NIC #U301 	CHIHA PANEL - U.L
	1 HR RATED TENANT SEPARATION	FIRE PARTITION -
I I	1 HR RATED EXIT ACCESS CORRIDO PARTITION - GA FILE NO. WP3380	ORS FIRE
	1 HR RATED EXIT ACCESS CORRIDO PARTITION AND INTERIOR WALLS -	
HORIZONTAL SEI	PARATIONS (TYPE III-A)	
	1 HR RATED HORIZONTAL SEPARAT	TION - ESR-1153
	1 HR RATED HORIZONTAL SEPARAT	TION - UL-#P522
	DENOTES ACCESSORY FEC	FIRE EXTINGUISHEF CABINET
	DENOTES WALL TYPE SP	STAND PIPE LOCATION
NOTES:		
	GS TO HAVE A 13 SPRINKLER SYSTEM R WALLS TO EXTEND TO DECK OF FL	
3. REFER TO B	JILDING PLAN AND ENLARGED PLAN	DETAILS FOR
	ASSEMBLY LOCATIONS. UISHER MUST BE LOCATED WITHIN 7	

- WITH FIRE MARSHALL. A 3 HR HORIZONTAL SEPARATION IS REQUIRED BETWEEN THE S-2
- AND THE R-2 OCCUPANCIES PER SECTION 510.2 REF. TO SHEETS A-D1.1-1, A-D1.1-2, A-D1.1-6 AND WALL TYPE
- LEGEND ON BUILDING PLANS FOR THE ADDITIONAL INFORMATION FOR WALL ASSEMBLIES USED IN THIS PROJECT.
- ALL STORAGE CLOSETS, ELECTRICAL CLOSETS & MECHANICAL CLOSETS BELOW THE 3-HR HORIZONTAL SEPARATION TO BE S-1
- OCCUPANCY. ALL STORAGE CLOSETS, BOILER ROOMS, ELECTRICAL CLOSETS & MECHANICAL CLOSET ABOVE THE 3-HR HORIZONTAL SEPARATION ARE ACCESSORY USE TO THE R-2 OCCUPANCY. PER SECTION

311.1.1 OF THE 2015 IBC, ACCESSORY STORAGE SPACES LESS THAN 100 S.F. ARE TO BE CLASSIFIED AS PART OF THE MAIN OCCUPANCY - REFER TO APPEALS.

EXIT AREA TABULATIONS

LEVEL	ROOF TERRACE	CLUB ROOM
GROSS AREA	DECK 1,362 S.F. TOTAL 1,242 S.F. USABLE	DECK 955 S.F. TOTAL 749 S.F. USABLE
OCCUPANT LOAD FACTOR	DECK 15 SF NET	DECK 15 SF NET
TOTAL OCCUPANTS	82 OCC	49 OCC
# OF EXITS REQUIRED	2	1
# OF EXITS PROVIDED	2	1
WIDTH REQUIRED	1'-3" TOTAL	8" TOTAL
WIDTH PROVIDED	EXIT #1 = 6'-0" EXIT #2 = 6'-0"	EXIT #1 = 3'-0"

NOTE:

1. EXIT REQUIREMENT CRITERIA BASED ON OCCUPANT LOAD. 1.1. 1-500 OCC = 2 1.2. 501-1000 = 3

1.3. MORE THAN 1000 OCC = 4

2. WIDTH OF EXITS ARE CALCULATED WITH A FACTOR OF .15" PER OCCUPANT.

3. OCCUPANT LOAD BASED ON A MAX OCCUPANCY OF 49 FOR GROUP 'B' UNDER ASSEMBLY GROUPS.



V.10.01.14



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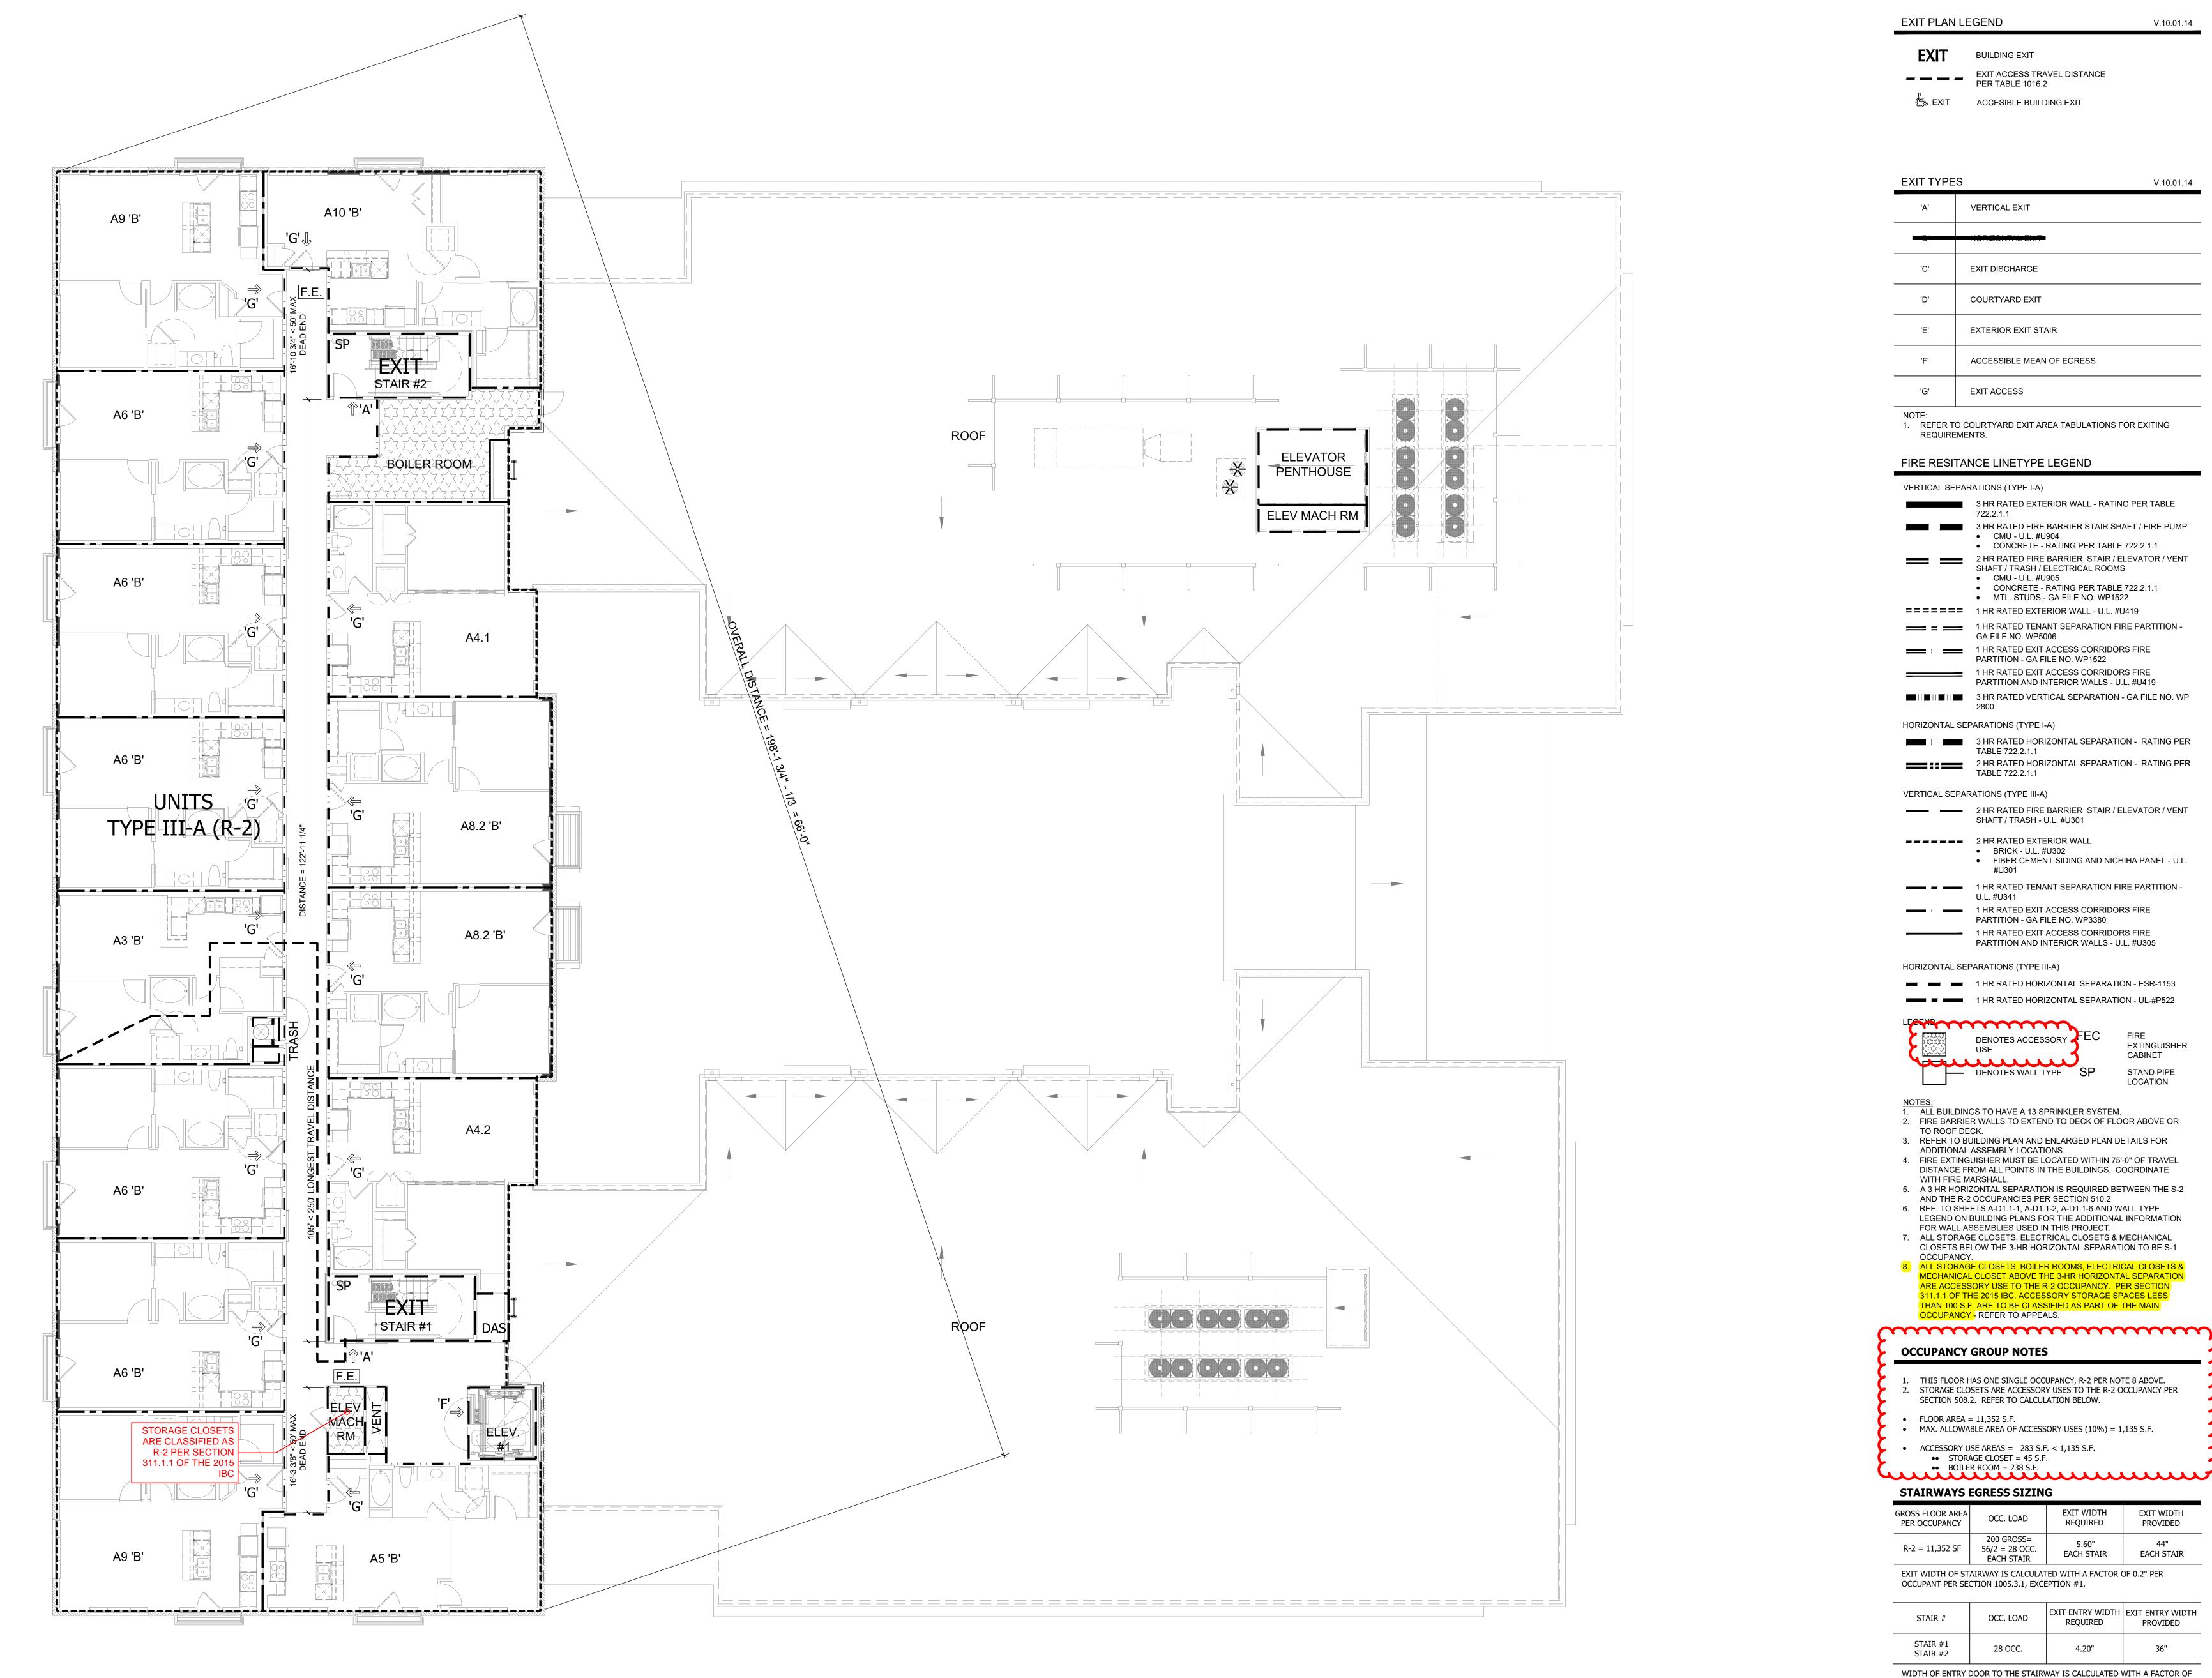
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Project Title:

E2 BLOCK 40 PORTLAND OREGON

ALAMO MANHA	TTAN
Issue Set:	04.09.18
Permit Set Issue:	07.20.18
Bid Set Issue:	01.14.19
Construction Set Issue:	
Project ID 17065	
Drawing No.	┥





0.15" PER OCCUPANT PER SECTION 1005.3.2, EXCEPTION #1.

V.10.01.14

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EXIT WIDTH PROVIDED 44" EACH STAIR

PROVIDED 36"





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