#### **Development Services**

#### From Concept to Construction







APPEAL SUMMARY

Status: Dec	ision F	Rend	lered
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Appeal ID: 18796	Project Address: 901 SW King Ave
Hearing Date: 12/19/18	Appellant Name: Melissa Wortman
Case No.: B-020	Appellant Phone: 5032211121
Appeal Type: Building	Plans Examiner/Inspector: Maureen McCafferty
Project Type: commercial	Stories: 12 Occupancy: A-2, B, R-2, S-1 Construction Type: I-A
Building/Business Name: Celio Apartments	Fire Sprinklers: Yes - At Leasing Office and Vestibule Only
Appeal Involves: Alteration of an existing structure	LUR or Permit Application No.: 18-252048-CO
Plan Submitted Option: pdf [File 1]	Proposed use: Multifamily - Mailroom

#### APPEAL INFORMATION SHEET

#### Appeal item 1

Code Sectio	
	n

1018.1; 708.6; 716.5.3

#### Requires

 $1018.1\ Construction.\ Corridors\ shall\ be\ fire-resistance\ rated\ in\ accordance\ with\ Table\ 1018.1.\ The$ 

corridor walls required

to be fire-resistance rated shall comply with Section 708 for fire partitions.

708.6 Openings. Openings in a fire partition shall be protected in accordance with Section 716.

716.5.3 Door assemblies in corridors and smoke barriers. Fire door assemblies required to have a minimum fire protection rating of 20 minutes where located in corridor walls.

#### **Proposed Design**

In reference to Section 1018.1 Construction, individual corridors in question are not fire-resistance rated in accordance with Table 1018.1 because the entire perimeter of the space within which they reside provides the required rating per Section 508.3 Non-separated Occupancies. This can be seen on Sheet A101. Please note the Fire Rated Assembly Legend showing the region which indicates "non-separated use with non-rated corridor" all within the rated boundary.

In reference to Sections 708.6 Openings and 716.5.3 Door Assemblies in corridors and smoke barriers, all openings and fire door assemblies in question lie within the constraints of the perimeter rated non-separated use space described above. This can be seen on Sheet A101.

Therefore, the proposed design removes an ineffective fire-protected door from an existing corridor to an existing mailroom. As described above, these non-separated occupancy spaces maintain the required fire ratings through the perimeter rated walls as seen with the rated wall designations on Sheet A101. Because these spaces all reside within the larger non-separated rated space, fire-protected doors between them are not required. Furthermore, per Table 503, I-A construction permits unlimited area for all of the occupancies contained within this area. All but two

dwelling units are separated from this area via fire-protected doors. Those remaining two units are separated via existing rated party walls which meet the requirements for separation from other occupancies in section 420.2. Refer to Coversheet CS and Sheet A101 for the enclosed area and the location of existing fire-protected doors.

Reason for alternative The existing door to the mailroom creates an unnecessary barrier between spaces and its removal allows for a more direct flow. Removal of the door also allows for the inclusion of additional parcel lockers within the mailroom space. In summation, the mailroom and corridor are enclosed within a rated non-separated occupancy area per Section 508.3. This provides equivalent fire protection to the requirements of Sections 708.6, 716.5.3 and 1018.1.

#### APPEAL DECISION

#### Removal of fire rated mail room door: Granted as proposed.

The Administrative Appeal Board finds that the information submitted by the appellant demonstrates that the approved modifications or alternate methods are consistent with the intent of the code; do not lessen health, safety, accessibility, life, fire safety or structural requirements; and that special conditions unique to this project make strict application of those code sections impractical.

Pursuant to City Code Chapter 24.10, you may appeal this decision to the Building Code Board of Appeal within 180 calendar days of the date this decision is published. For information on the appeals process and costs, including forms, appeal fee, payment methods and fee waivers, go to www.portlandoregon.gov/bds/appealsinfo, call (503) 823-7300 or come in to the Development Services Center.

# CELIO APARTMENTS MAILROOM RENOVATION

# 901 SW KING AVENUE PORTLAND, OR 97205 **PERMIT SET - 09.17.2018**

#### PROJECT DIRECTORY

#### **BUILDING MANAGER**

KING TOWER HOLDINGS LLC **CONTACT PERSON:** 1000 SW VISTA AVE #114 MALCOLM MCIVER MMCIVER@COMMERCEPROPERTIES.COM PORTLAND, OR 97205

> T: 503.224.3315 F: 503.228.3309

#### <u>ARCHITECT</u>

LRS ARCHITECTS **CONTACT PERSON**: 720 NW DAVIS ST, STE 300 LISA WARNOCK PORTLAND, OR 97209 LWARNOCK@LRSARCHITECTS.COM

WWW.LRSARCHITECTS.COM T: 971.242.8183

F: 503.221.2077

#### **GENERAL CONTRACTOR**

PORTLAND, OR 97202


**CHARTER CONSTRUCTION** 3747 SE 8TH AVE

**CONTACT PERSON**:

CCB# 166313 T: 503.546.2600

# DRAWING INDEX

	SHEET NUMBER	SHEET NAME
	CS	COVER-OHEET CONTRACTOR OF THE
A	A001	SITE PLAN
	A100i	GENERAL NOTES & ACCESSIBILITY REQUIREMENTS
	A101	FIRE RATED ASSEMBLY PLAN
	A201	DEMOLITION PLAN & FLOOR PLAN
	A401	REFLECTED CEILING PLAN
	A870	INTERIOR ELEVATIONS & INTERIOR DETAILS

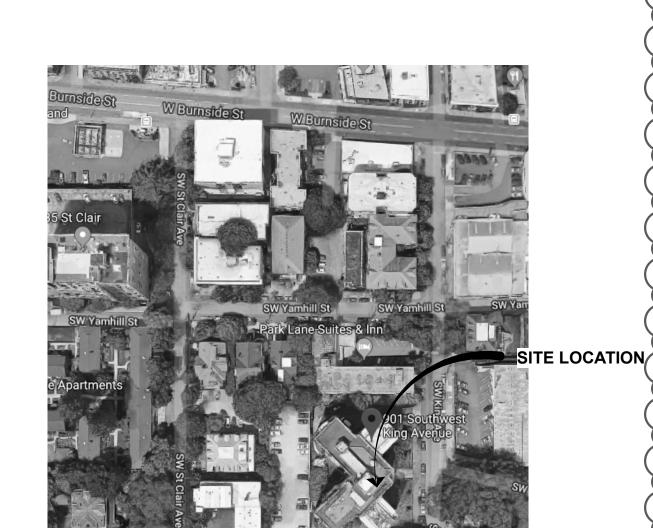


# **VICINITY MAP**

**NOT TO SCALE** 

**PROJECT SUMMARY** 

IV. ADA ACCESSIBILITY UPGRADES:1. AREA OF WORK HAS BEEN UPGRADED ACCORDING TO THE CELIO APARTMENTS MAILROOM RENOVATION PROJECT ADDRESS: 901 SW KING AVENUE ACCESSIBILITY UPGRADES LIST AS OUTLINED IN OSSC 3411. PROJECT DESCRIPTION: RENOVATION OF EXISTING MAIL ROOM. NEW NON-NEW ACCESSIBLE MAILBOXES STRUCTURAL PARTITION, MAILBOXES, PARCEL BOXES, FINISHES, AND BUILDING IS NOT SPRINKLERED, EXCEPT AT THE LEASING OFFICE AND VESTIBULE. MAKE CODE MINIMUM CORRECTIONS AS REQUIRED PER NEW II. GENERAL INFORMATION: 2012 INTERNATIONAL BUILDING CODE (IBC) BUILDING HAS AN EXISTING FIRE ALARM SYSTEM. 2014 OREGON STRUCTURAL SPECIALTY CODE (OSSC) BUILDING CONTAINS EXISTING SMOKE DETECTORS: PROVIDE CODE MINIMUM 2014 OREGON FIRE CODE CORRECTIONS AS REQUIRED. SMOKE DETECTORS TO BE TIED TO THE 2014 OREGON ENERGY EFFICIENCY SPECIALTY CODE (OEESC) BUILDING ALARM SYSTEM. 2014 OREGON ELECTRICAL SPECIALTY CODE (OESC) IN BUILDINGS EQUIPPED WITH AN EXISTING VISUAL STROBE SYSTEM: PROVIDE CODE MINIMUM CORRECTIONS AS REQUIRED. IF A SYSTEM DOES NOT EXIST III. BÜILDINĞ STANDARDS: **BUILDING OCCUPANCY:** A-2, B, R-2, S-1 PUBLIC AND TENANT SPACES. MINIMUM INTENSITY SHALL NOT BE LESS THAN (LEVEL 1 FLOOR AREA) A-2 (1233 SF) FOOTCANDLE AT FLOOR LEVEL ALONG THE ENTIRE LENGTH OF THE PATH B (843 SF) CONNECT TO BUILDING ELECTRICAL SYSTEM. R-2 (3820 SF) PROVIDE EXIT SIGNAGE. EXIT SIGNAGE SHALL BE CONNECTED TO BUILDING R-2 INCIDENTAL USE (529 SF) POWER SUPPLY WITH BATTERY BACK-UP FOR MIN 1-1/2 HOUR DURATION. S-1 (540 SF) **BUILDING AREA:** 131,000 SF **BUILDING HEIGHT:** 136'-0"; 12 STORIES AREA OF WORK: +/- 134 R.S.F. TOTAL OCCUPANT LOAD (LEVEL 1): 123 EXTINGUISHER IN ACCORDANCE WITH CURRENT CODES. PROVIDE NEW FIR UNDER SEPARATE PERMIT ELECTRICAL SYSTEMS OREGON ENERGY EFFICIENT SPECIALTY CODE EXTERIOR ENVELOPE: NO CHANGE TO EXISTING ENVELOPE. IF EXISTING EXTERIOR WALLS, CEILING, OR ROOF CAVITIES BECOME EXPOSED DURING THE GENERAL NOTES ALTERATION, THEN CAVITIES ARE TO BE INSPECED FOR THERMAL INSULATION. INTERIOR LIGHTING: PROPOSED NEW INTERIOR LIGHTING IN COMPLETE COMPLIANCE WITH OECSC. THE SITE PLAN AND SUITE LOCATION PLAN ARE FOR REFERENCE ONLY. SEE

ALL OTHER SHEET PLANS FOR CONTRACT DOCUMENT INFORMATION. THE EXTERIOR LIGHTING: NO CHANGE TO EXISTING EXTERIOR LIGHTING PROJECT SUMMARY IDENTIFIES SOME SPECIFIC OSSC REQUIREMENTS BUT MECHANICAL: NO CHANGE TO EXISTING MECHANICAL SYSTEMS. ACCORDING TO SECTION 101.4. DURING A BUILDING ALTERATION. RENOVATION IS NOT INTENDED TO LIST ALL OSSC REQUIREMENTS. OR REPAIR, ALL EXISTING UNALTERED PORPORTIONS OF THE BUILDING AND BUILDING SYSTEMS SHALL REMAIN UNCHANGED AND IN COMPLIANCE WITH

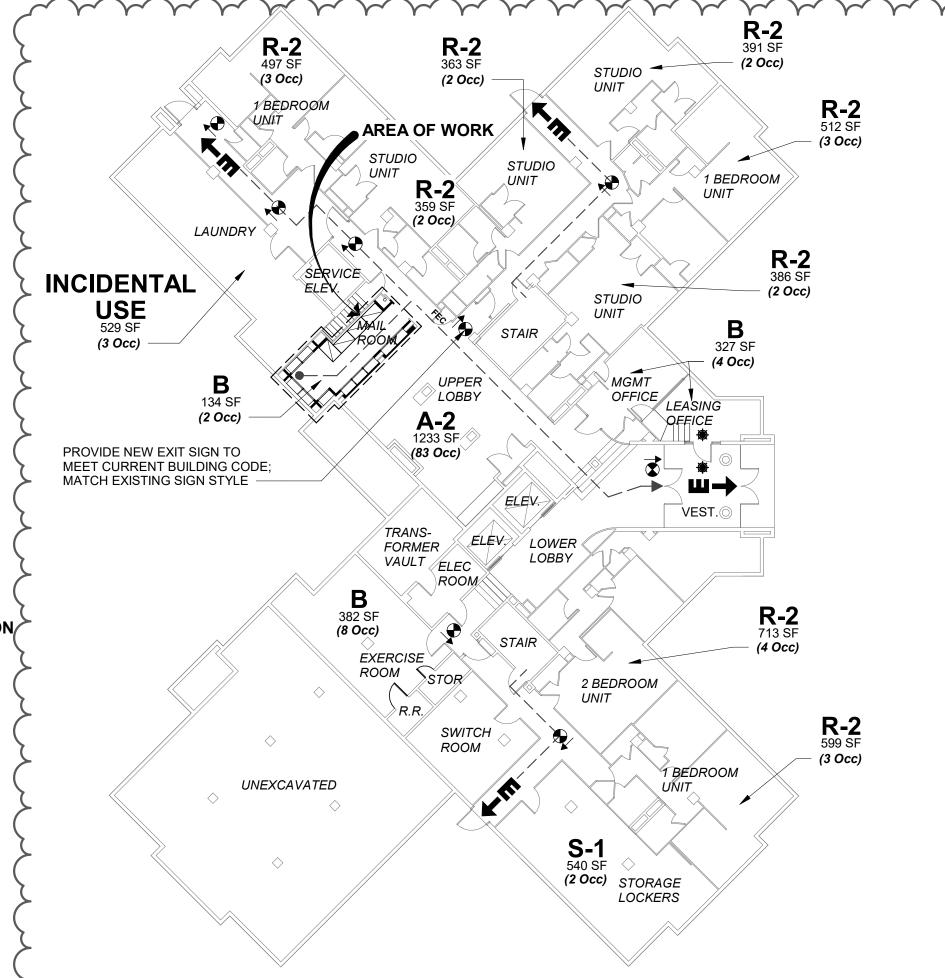

. LEVEL 1 - EGRESS PLAN

SCALE: 1/16" = 1'-0"

SEE EGRESS PLAN	·	TS PER SECTION 1015		
OCCUDANCY			DEOLUBED	DDODOSEI
OCCUPANCY	SPRINKLERED	OCCUPANCY LOAD	REQUIRED	PROPOSEI
LEVEL 1	N N	00 (EVIOTINO)	EVIOTINO	EVICTINO
A-2	N	83 (EXISTING)	EXISTING	EXISTING
В	PARTIAL (LEASING OFFICE AND VESTIBULE ONLY)	14 (EXISTING)	EXISTING	EXISTING
R-2	N	21 (EXISTING)	EXISTING	EXISTING
S-1	N	2 (EXISTING)	EXISTING	EXISTING
INCIDENTAL USE (LAUNDRY - CALCULATED AS	N	3 (EXISTING)	EXISTING	EXISTING
	MINIMUM DISTANCE ALL	OWED PER EXITS PER 1	015.2.1	
OCCUPANCY	SPRINKLERED	REQUIRED	PROPOSED	
A-2	N	EXISTING	EXISTING	
В	PARTIAL (LEASING OFFICE AND VESTIBULE ONLY)	EXISTING	EXISTING	
R-2	N	EXISTING	EXISTING	
S-1	N	EXISTING	EXISTING	
INCIDENTAL USE (LAUNDRY - CALCULATED AS	N	EXISTING	EXISTING	
EXIT ACCE	SS TRAVEL DISTANCE FRO	OM MOST REMOTE POIN	Γ PER TABLE 1	016.2
OCCUPANCY	SPRINKLERED	REQUIRED	PROPOSED	
A-2	N	EXISTING	EXISTING	
В	PARTIAL (LEASING OFFICE AND VESTIBULE ONLY)	EXISTING	EXISTING	
R-2	N	EXISTING	EXISTING	
S-1	N	EXISTING	EXISTING	
INCIDENTAL USE (LAUNDRY - CALCULATED AS	N	EXISTING	EXISTING	
COMMON PATH TR	AVEL DISTANCE FROM MO TAE	ST REMOTE POINT BEFO BLE 1014.3	DRE 2 WAYS PI	ROVIDED PE
OCCUPANCY	SPRINKLERED	REQUIRED	PROPOSED	
_EVEL 1	1		·	
A-2	N	EXISTING	EXISTING	
В	PARTIAL (LEASING OFFICE AND VESTIBULE ONLY)	EXISTING	EXISTING	
R-2	N	EXISTING	EXI	STING
S-1	N	EXISTING	EXISTING	
INCIDENTAL USE (LAUNDRY - CALCULATED AS	N	EXISTING	EXISTING	

# EGRESS PLAN LEGEND

EXISTING FIRE EXTINGUISHER CABINET

ROOM OCCUPANT LOAD (OR TOTAL FLOOR OCCUPANT LOAD) PER SECTION

EXISTING EXIT SIGN, UNO.

EXISTING SPRINKLER LOCATION

DIRECTION. ACCUMULATIVE NUMBER OF OCCUPANTS SERVED WITH EGRESS DIRECTION AT ARROW LOCATION. (DESIGNATED WHERE (2) MEANS OF EGRESS ARE REQUIRED PER TABLE

EGRESS PATH - REFER TO TABLE FOR

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**APARTMENTS MAILROOM** RENOVATION 901 SW KING **AVENUE** PORTLAND, OR

**CELIO** 

97205

DRAWN BY: DATE ISSUED: PERMIT SET 09.17.2018

A Permit Revisions

TO TOILET ROOM ACCESSORIES ARE TO THE CENTER LINE AS NOTED OR TO THE HIGHEST

THIS PROJECT. SEE PROJECT PLANS AND

HORIZONTAL PLAN LAYOUT.

MOUNTING HEIGHTS.

A117.1-2009)

FIXTURES.

AND/OR ADAPTABILITY CONFORMANCE IN THE

HEIGHTS, IF THEY OCCUR ON THIS PROJECT.

ENSURE CONFORMANCE WITH REQUIRED

7. PROVIDE CODE-COMPLIANT BLOCKING WITHIN

ACCESSORIES AND GRAB BARS MOUNTING

AT WALLS DESIGNATED ON FLOOR PLANS AS


SPACE CONTIGUOUS OR OVERLAPPING THE


1/2" DIA. MAXIMUM; FLOOR SLOPE DOES NOT

ACCESSIBLE FIXTURE MOUNTING REQUIREMENTS (PER ICC/ANSI


BE PLACED IN THIS CLEAR FLOOR SPACE.

OPENING-PROTECTED WALLS.

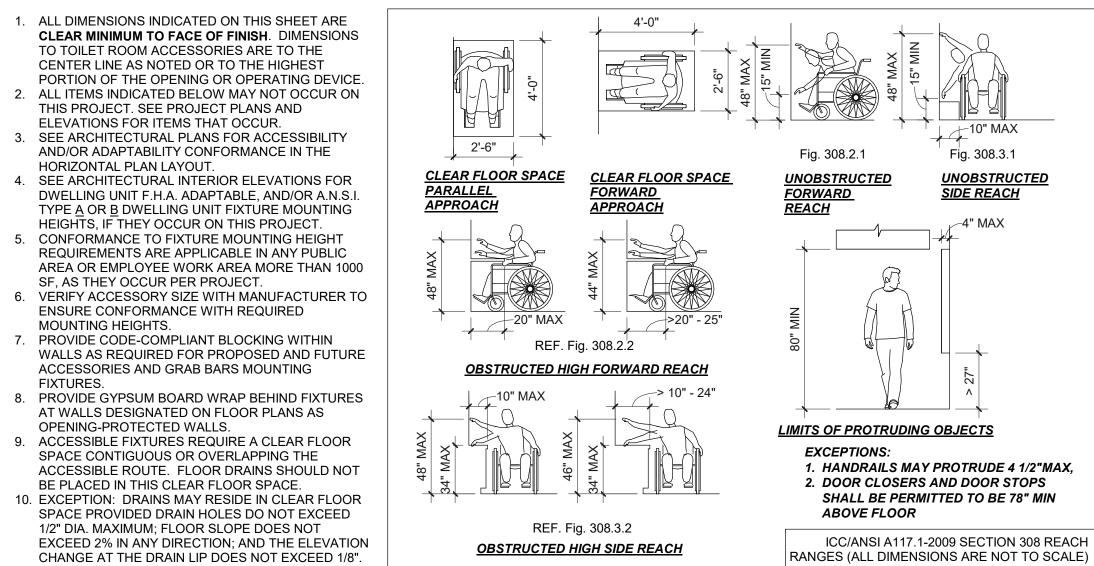

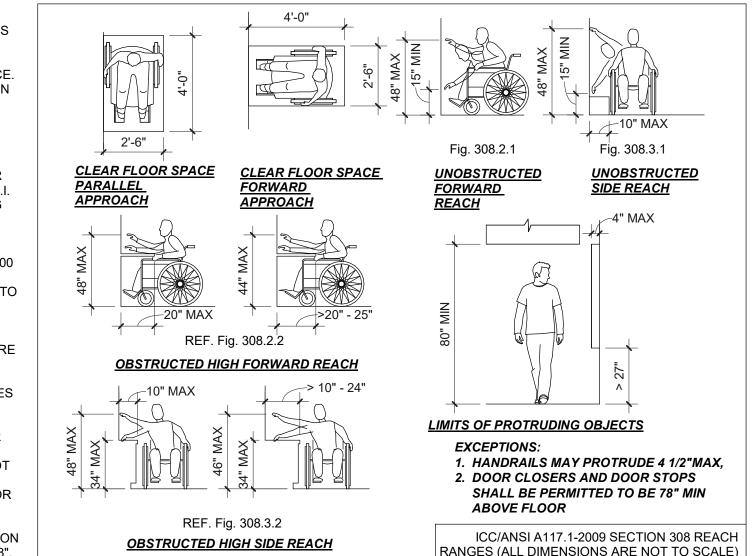

EXIT SIGN TO RAISED CHARACTERS **TYPICAL** DOOR OPENING -READER TYPICAL AT DOOR

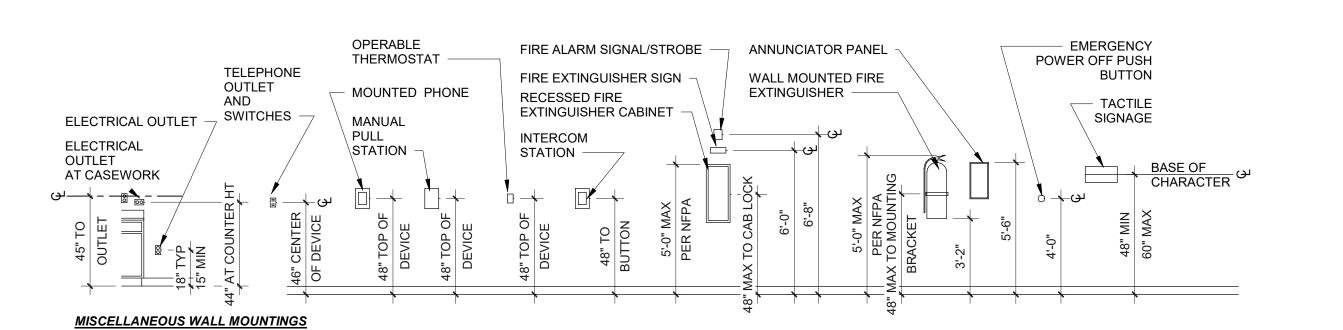

**COMMON FIXTURE MOUNTING HEIGHTS** 

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CONSULTANT:

PROJECT NUMBER: **CELIO APARTMENTS MAILROOM** RENOVATION

901 SW KING *AVENUE* PORTLAND, OR 97205

SHEET TITLE:

**GENERAL** NOTES & **ACCESSIBILITY** REQUIREMENTS

DRAWN BY: DATE ISSUED:

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FIRE RATED ASSEMBLY NOTES

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CONSULTANT:

PROJECT NUMBER: **CELIO APARTMENTS** MAILROOM RENOVATION

901 SW KING AVENUE PORTLAND, OR 97205

SHEET TITLE:

FIRE RATED **ASSEMBLY** PLAN

DRAWN BY: DATE ISSUED: PERMIT SET 09.17.2018


A Permit Revisions

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1. DEMOLITION PLAN

SCALE: 1/2" = 1'-0"

SCALE: 1/2" = 1'-0"

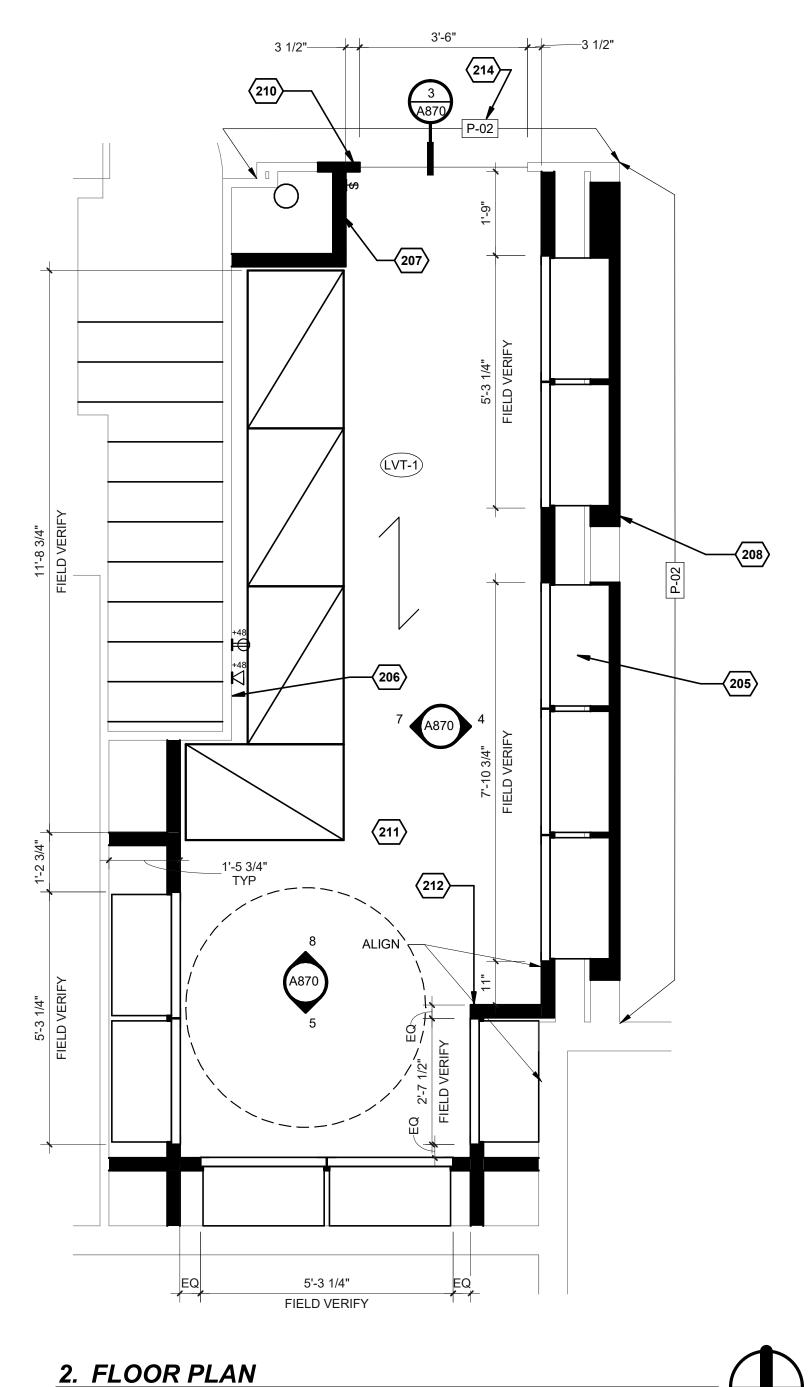

#### FINISH GENERAL NOTES

- A. SEE FINISH MATERIAL LEGEND, INTERIOR FINISH PLANS, INTERIOR ELEVATIONS AND REFLECTED CEILING PLANS FOR MORE INFORMATION. B. INTERIOR PAINTS ARE TO HAVE THE FOLLOWING
- SHEENS UNO: \* WALLS - EGGSHELL \* CEILINGS & SOFFITS - FLAT \* DOORS, DOOR FRAMES, CASINGS AND
- MILLWORK SEMI-GLOSS C. NOT USED D. FLOORING DIRECTION AND SEAMING LOCATIONS ARE
- TO BE APPROVED BY THE ARCHITECT.
- E. PROVIDE NEW FLOORING AND BASE AS INDICATED
- F. REFER TO **A870** FOR TYPICAL FLOORING TRANSITION DETAILS FOR ACCESSIBILITY COMPLIANCE.

#### FINISH LEGEND

P-1 PAINT TAG

INDICATES FINISH DIRECTION

FLOOR FINISH

# FINISH MATERIAL LEGEND

RESILIENT FLOORING (LVT-1) LUXURY VINYL TILE

MFR: ARMSTRONG COMMERCIAL FLOORING PRODUCT: EARTHCUTS SLADE COLOR: NA360 SILVER LINING SIZE: 12" X 24" INSTALLATION: ASHLAR CONTACT: NORA VIVARELLI; norav@pacmat.com

WALL FINISHES (P-1)

PAINT MFR: SHERWIN WILLIAMS

COLOR: SW7007 CEILING BRIGHT WHITE FINISH: FLAT

LOCATION: CEILING

WALL FINISHES (P-2) PAINT

MFR: SHERWIN WILLIAMS COLOR: SW9132 ACACIA HAZE

FINISH: EGGSHELL

LOCATION: LOUNGE WALL

WALL FINISHES (P-3) PAINT

MFR: SHERWIN WILLIAMS COLOR: SW9132 ACACIA HAZE FINISH: SEMI-GLOSS

LOCATION: TRIM

WALL FINISHES WC-1 VINYL WALLCOVERING

> MFR: MAHARAM STYLE: TETHER 399961 COLOR: 009 ROSEMARY WIDTH: 54"

LOCATION: MAIL ROOM

ARCHITECTURAL TRIM (WT-1) WOOD TRIM

TYPE: WALL BASE PROFILE: FLAT STOCK SPECIES: PAINT-GRADE
SIZE: MATCH BUILDING STANDARD

ARCHITECTURAL TRIM

FINISH: P-3

(WT-2) WOOD TRIM TYPE: MAILBOX TRIM, DOOR TRIM PROFILE: FLAT STOCK SPECIES: PAINT-GRADE SIZE: 1X2 FINISH: P-3


## **GENERAL NOTES**

- A. THIS DRAWING REFERENCES EXISTING CONDITIONS FOR REFERENCE ONLY. VERIFY IN FIELD.
- B. REMOVE EXISTING FLOORING, BASE AND LIGHT FIXTURES IN SCOPE OF WORK, UNO.
- C. PROTECT ALL ADJACENT AREAS DURING DEMOLITION AND FROM DUST AND TRASH INTRUSION. D. CEILING CONFIGURATION TO REMAIN UNO.
- E. REMOVE AND SALVAGE FIRE EXTINGUISHERS AND CABINETS FOR REUSE.
- PROVIDE STAGING AREA FOR EXISTING MAILBOXES TO REMAIN IN USE DURING CONSTRUCTION.
- G. DIMENSIONS ARE TO FACE OF FINISH UNLESS OTHERWISE NOTED. ADVISE ARCHITECT OF ANY DISCREPANCIES PRIOR TO CONSTRUCTION.
- H. ALL ELECTRICAL WORK IS DESIGN BUILD ALL ELECTRICAL OUTLETS, DATA & SWITCHES SHOWN FOR REFERENCE ONLY. VERIFY EXISTING CONDITIONS. SUBMIT ELECTRICAL PLANS TO ARCHITECT FOR REVIEW PRIOR TO CONSTRUCTION.
- WHEN NEW LIGHT SWITCHES ARE ADDED, REPLACE ALL EXISTING LIGHT SWITCHES WITH NEW OCCUPANCY SENSOR SWITCHES. J. PATCH AREAS ADJOINING AND/OR ADJACENT TO
- CONSTRUCTION. K. PROVIDE NEW LUTRON WALL PLATES IN SCOPE OF WORK. COLOR: GREENBRIAR (GB).

DEMOLITION WORK TO MATCH EXISTING AND/OR NEW

#### DEMO PHASING LEGEND

EXISTING TO REMAIN

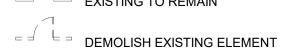



EXISTING TO REMAIN

NEW FULL HEIGHT PARTITION

# ELECTRICAL LEGEND

SHOWN FOR REFERENCE ONLY

PHASE OF FIXTURE -TYPE OF FIXTURE HEIGHT OF FIXTURE R = RELOCATED FIXTURE (IF NOT STANDARD)

SWITCH

\$ os OCCUPANCY SENSOR SWITCH

TELEPHONE / DATA OUTLET

STANDARD DUPLEX OUTLET

**KEYNOTES** 

REMOVE EXISTING MAILBOXES AND MAILBOX TRIM. PROVIDE TEMPORARY STAGING AREA FOR MAILBOXES DURING

CONSTRUCTION. REMOVE EXISTING DOOR, FRAME AND TRIM. 202 REMOVE EXISTING WALLCOVERING ON THIS 203 WALL ONLY.

NEW PARCEL PENDING LOCKERS PROVIDED BY OWNER. PROVIDE STANDARD 110V 204 DUPLEX OUTLET AND DEDICATED SECURE ETHERNET CONNECTION (RJ45).

NEW TENANT MAILBOXES PROVIDED BY OWNER AND CONTRACTOR INSTALLED. COORDINATE PARCEL PENDING LOCKER LOCATION WITH CONDUIT PROJECTING

FROM WALL. ALIGN WALL WITH SOFFIT ABOVE. 208 PATCH AND REPAIR WALL TO LEVEL 4

EXISTING LIGHT FIXTURES TO REMAIN. TRIM AT CASED OPENING TO MATCH 210 EXISTING PROFILE AND FINISH.

FINISH WALLS TO LEVEL 5 FINISH. PROVIDE FULL HEIGHT CLEAR CORNER 212

PROTECT EXISTING WALLCOVERING FROM DAMAGE DURING DEMOLITION. 213 IF WALLCOVERING DAMAGE CANNOT BE AVOIDED, PAINT WALL TO THE EXTENTS

PROJECT NUMBER: **CELIO APARTMENTS MAILROOM RENOVATION** 

ARCHITECTS

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MICHELLE C. START

CONSULTANT:

Suite 300 503 221.2077

720 NW Davis 503.221.1121

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SHEET TITLE:

**DEMOLITION** PLAN & FLOOR PLAN


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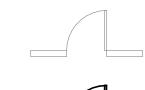
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1. REFLECTED CEILING PLAN SCALE: 1/2" = 1'-0"

WALL TYPE LEGEND



EXISTING TO REMAIN

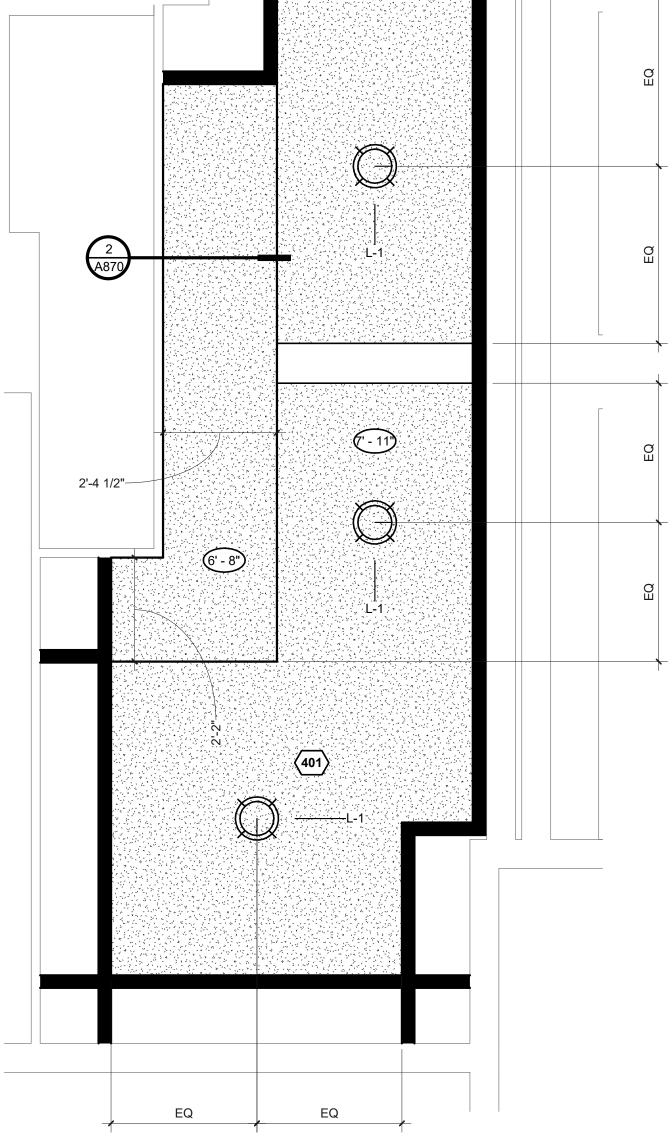

NEW FULL HEIGHT PARTITION SEE 7/A870

## RCP LEGEND

NONRATED GYP. BD. SOFFIT OR NONRATED ONE LAYER GYP. BD. SUSPENDED CEILING SYSTEM. SEE **A870** 

#### ITEMS BELOW ARE SHOWN FOR REFERENCE ONLY



(18' - 0") CEILING ELEVATION TAG

# LIGHT FIXTURE LEGEND

L-1 SURFACE MOUNT

MFR: TANGO LIGHTI
PRODUCT: BOOP FINISH: WHITE/GOLD SIZE: 14.5" DIAMETER, 3.9" H CONTACT: JANET CROSON; janet@cslightingsales.com

L-2 **NOT USED** 

## **GENERAL NOTES**

- A. REFER TO SHEET A100i FOR A COMPLETE LIST OF GENERAL NOTES.
  B. ALL ELECTRICAL WORK IS DESIGN-BUILD. EXISTING AND NEW LIGHT FIXTURES ARE SHOWN FOR A COMPLETE AND ADDITIONAL ADDITIONAL AND ADDITIONAL AND ADDITIONAL ADDITIONA REFERENCE ONLY. VERIFY EXISTING CONDITIONS AND REPORT DISCREPANCIES TO ARCHITECT. SUBMIT ELECTRICAL PLANS TO ARCHITECT FOR REVIEW PRIOR TO CONSTRUCTION. CLEAN AND RESTORE ALL LIGHTS TO WORKING ORDER PRIOR TO JOB
- COMPLETION. C. ALL FIRE/LIFE SAFETY WORK IS DESIGN-BUILD. SUBMIT PROPOSED LOCATIONS FOR EMERGENCY LIGHTING, STROBES, SMOKE DETECTION AND SPRINKLERS TO ARCHITECT FOR REVIEW AND
- COORDINATION PRIOR TO CONSTRUCTION. D. SPRAY PAINT ALL METAL ACCESS PANELS AND DIFFUSERS TO MATCH ADJACENT CEILING FINISHES
- E. WHEN NEW LIGHT SWITCHES ARE ADDED TO ANY PORTION OF THE SUITE, REPLACE ALL EXISTING LIGHT SWITCHES WITH NEW BUILDING STANDARD OCCUPANCY SENSOR SWITCHES.
  F. NOT USED



#### **KEYNOTES**

FURR OUT EXISTING CEILING MINIMUM AMOUNT POSSIBLE TO CONCEAL EXISTING



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CONSULTANT:

PROJECT NUMBER:

**CELIO APARTMENTS** MAILROOM RENOVATION


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REFLECTED **CEILING PLAN** 

DRAWN BY: DATE ISSUED: PERMIT SET 09.17.2018



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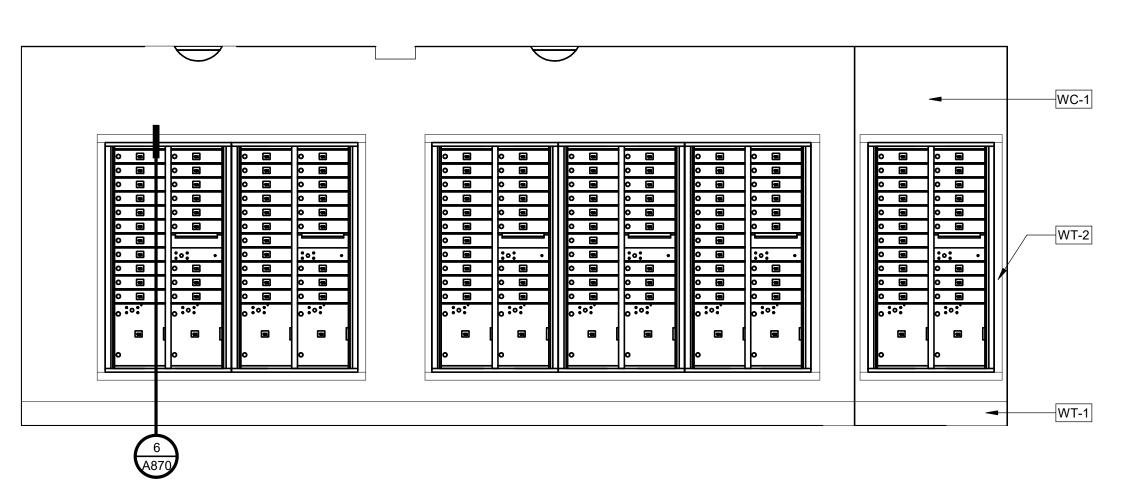


#### 2. SUSPENDED GYP CEILING (SOFFIT OPTION) SCALE: 3" = 1'-0"
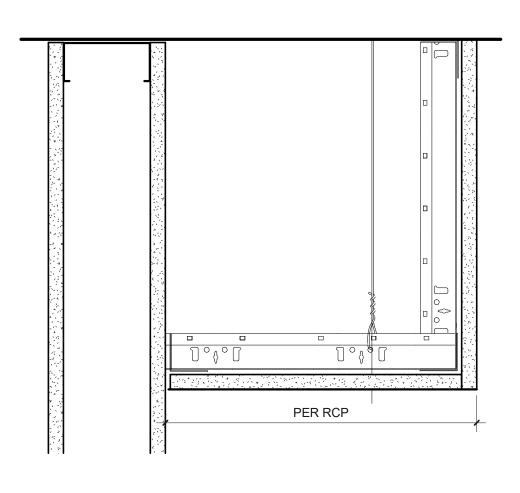
#### SCHLUTER "SCHIENE" TRANSITION STRIP OR SIMILAR RESILIENT FLOORING AS SCHEDULED COLOR: TBD RESILIENT TAPERED CARPET (EXISTING) UNDERLAY, MINIMUM SLOPE TO FLUSH TRANSITION **CARPET TO RESILIENT FLOORING**


# 3. INTERIOR FLOOR TRANSITION DETAILS

SCALE: 12" = 1'-0"




4. MAIL ROOM - EAST

SCALE: 1/2" = 1'-0"

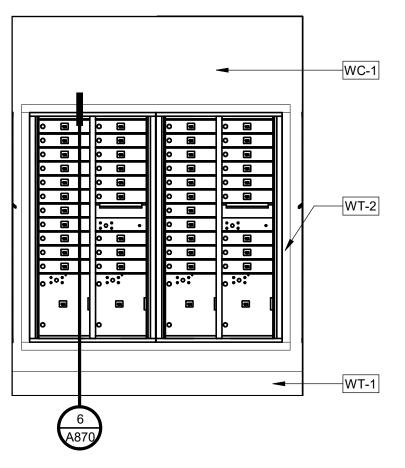


5. MAIL ROOM - SOUTH

SCALE: 1/2" = 1'-0"

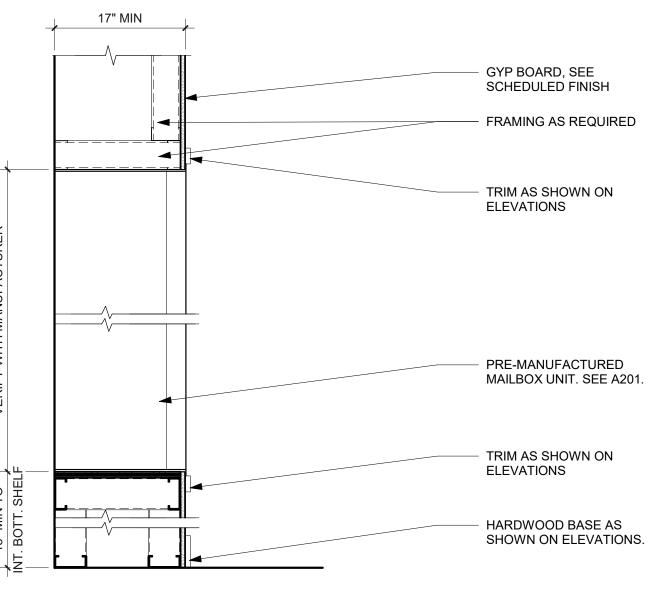


6. RECESSED MAILBOXES

SCALE: 1" = 1'-0"

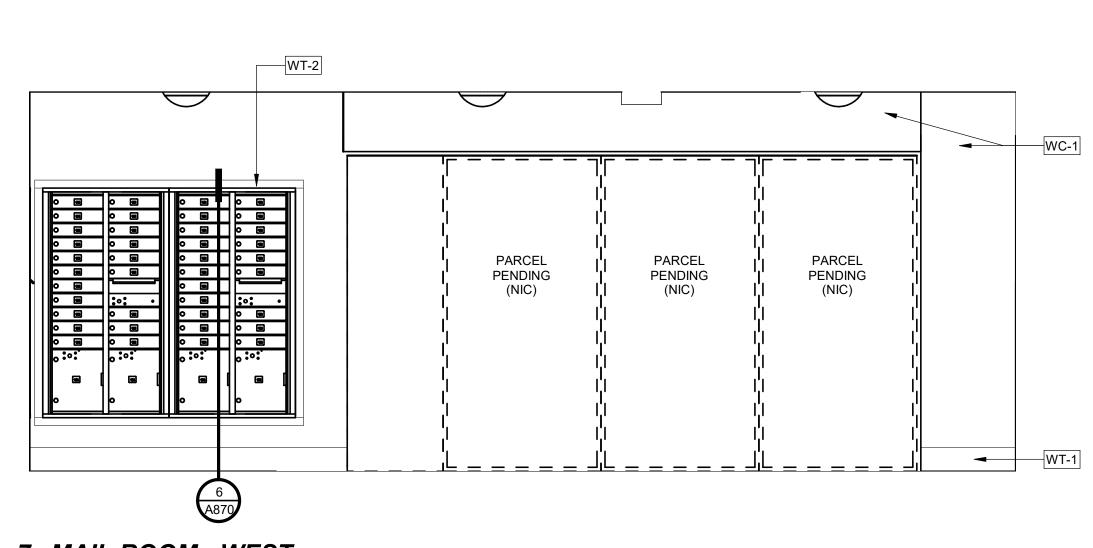


7. MAIL ROOM - WEST

SCALE: 1/2" = 1'-0"

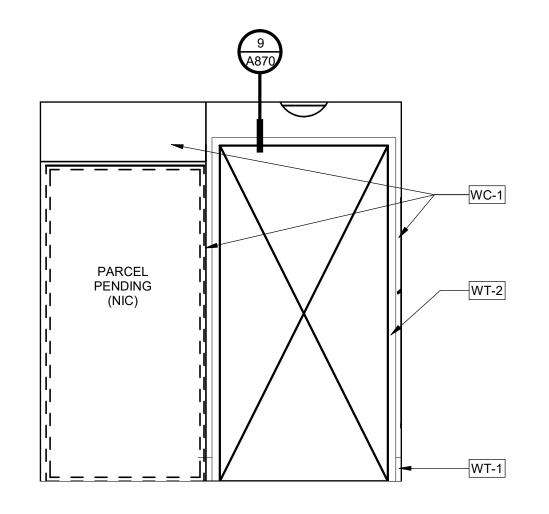

8. MAIL ROOM - NORTH

SCALE: 1/2" = 1'-0"

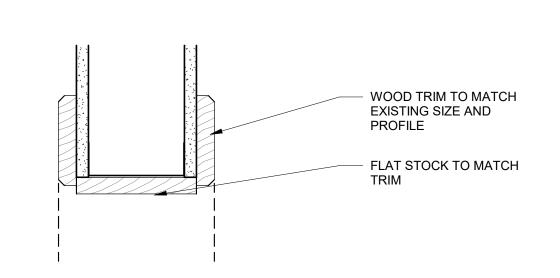

9. CASED OPENING

SCALE: 3" = 1'-0"

#### **GENERAL NOTES**

- A. SEE A100i FOR FULL ACCESSIBILITY REQUIREMENTS.
- B. SEE SPECIFICATIONS, FINISH LEGEND, FINISH SCHEDULE, FINISH PLANS AND FINISH NOTES FOR
- ADDITIONAL INTERIOR FINISH INFORMATION. C. PAINT ALL NON-NOTED MISCELLANEOUS ITEMS TO
- MATCH ADJACENT FINISH COLOR UNO. D. PROVIDE SOLID BLOCKING AT ALL WALL MOUNTED ACCESSORIES WHERE NOTED ON ELEVATIONS.

ARCHITECTS 720 NW Davis 503.221.1121 Suite 300 503 221.2077 🗅

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CONSULTANT:

PROJECT NUMBER: **CELIO APARTMENTS MAILROOM** RENOVATION

901 SW KING **AVENUE** PORTLAND, OR 97205

SHEET TITLE:

INTERIOR **ELEVATIONS &** INTERIOR **DETAILS** 

DRAWN BY: DATE ISSUED: PERMIT SET 09.17.2018

