GENERAL NOTES

- 1. ALL WORK SHALL COMPLY WITH 2014 NATIONAL ELECTRIC CODE (NEC), 2015 INTERNATIONAL RESIDENTIAL CODE (IRC), 2014 NATIONAL BUILDING CODE (NBC), 2015 INTERNATIONAL BUILDING CODE (IBC), 2015 INTERNATIONAL PLUMBING CODE (IBC), AND ALL STATE AND LOCAL BUILDING, ELECTRICAL, AND PLUMBING CODES.
- 2. DRAWINGS HAVE BEEN DETAILED ACCORDING TO UL LISTING REQUIREMENTS.

SITE NOTES

- 1. A LADDER SHALL BE IN PLACE FOR INSPECTION IN COMPLIANCE WITH OSHA REGULATIONS.
- 2. THE PV MODULES ARE CONSIDERED NON-COMBUSTIBLE AND THIS SYSTEM IS AN UTILITY NTERACTIVE SYSTEM WITH NO STORAGE BATTERIES.
- 3. THE SOLAR PV INSTALLATION SHALL NOT OBSTRUCT ANY PLUMBING, MECHANICAL, OR BUILDING ROOF VENTS.
- 4. PROPER ACCESS AND WORKING CLEARANCE AROUND EXISTING AND PROPOSED ELECTRICAL EQUIPMENT WILL BE PROVIDED AS PER SECTION [NEC 110.26]
- 5. THE GROUNDING ELECTRODE CONDUCTOR SHALL BE PROTECTED FROM PHYSICAL DAMAGE 3ETWEEN THE GROUNDING ELECTRODE AND THE PANEL (OR INVERTER) IF SMALLER THAN #6 AWG COPPER WIRE PER NEC 250-64B. THE GROUNDING ELECTRODE CONDUCTOR WILL BE CONTINUOUS, EXCEPT FOR SPLICES OR JOINTS AT BUSBARS WITHIN LISTED EQUIPMENT PER NEC 250.64C.]
- 3. ROOF COVERINGS SHALL BE DESIGNED, INSTALLED, AND MAINTAINED IN ACCORDANCE WITH THIS CODE AND THE APPROVED MANUFACTURER'S INSTRUCTIONS SUCH THAT THE ROOF COVERING SHALL SERVE TO PROTECT THE BUILDING OR STRUCTURE.
- 7. RIGID CONDUIT (AND/OR NIPPLES) MUST HAVE A PULL BUSHING TO PROTECT WIRES.
- 3. BOLTED CONNECTION REQUIRED IN DC DISCONNECTS ON THE WHITE GROUNDED
- CONDUCTOR (USE POLARIS BLOCK OR NEUTRAL BAR)
- 9. ANY CONNECTION ABOVE LIVE PARTS MUST BE WATERTIGHT. REDUCING WASHERS DISALLOWED ABOVE LIVE PARTS. MEYERS HUBS RECOMMENDED

SOLAR CONTRACTOR

- 1. MODULE CERTIFICATIONS WILL INCLUDE UL1703, IEC61646, IEC61730.
- 2. IF APPLICABLE, MODULE GROUNDING LUGS MUST BE INSTALLED AT THE MARKED GROUNDING LUG HOLES PER THE MANUFACTURERS' INSTALLATION REQUIREMENTS.
- AS INDICATED BY DESIGN, OTHER NRTL LISTED MODULE GROUNDING DEVICES MAY BE USED N PLACE OF STANDARD GROUNDING LUGS AS SHOWN IN MANUFACTURER DOCUMENTATION AND APPROVED BY THE AHJ.
- 4. CONDUIT AND WIRE SPECIFICATIONS ARE BASED ON MINIMUM CODE REQUIREMENTS AND ARE
- NOT MEANT TO LIMIT UP-SIZING AS REQUIRED BY FIELD CONDITIONS.
- 5. CONDUIT POINT OF PENETRATION FROM EXTERIOR TO INTERIOR TO BE INSTALLED AND SEALED WITH A SUITABLE SEALING COMPOUND.
- 3. DC WIRING LIMITED TO MODULE FOOTPRINT W/ ENPHASE AC SYSTEM
- 7. ENPHASE WIRING SYSTEMS SHALL BE LOCATED AND SECURED UNDER THE ARRAY W/ SUITABLE WIRING CLIPS.
- MAX DC VOLTAGE CALCULATED USING MANUFACTURER PROVIDED TEMP COEFFICIENT FOR VOC UNLESS NOT AVAILABLE.
- 9. ALL INVERTERS, MOTOR GENERATORS, PHOTOVOLTAIC MODULES, PHOTOVOLTAIC PANELS, AC PHOTOVOLTAIC MODULES, DC COMBINERS, DC-TO-DC CONVERTERS, SOURCE CIRCUIT COMBINERS, AND CHARGE CONTROLLERS INTENDED FOR USE IN A PHOTOVOLTAIC POWER SYSTEM WILL BE IDENTIFIED AND LISTED FOR THE APPLICATION PER 690.4 (B).
- 10. ALL SIGNAGE TO BE PLACED IN ACCORDANCE WITH LOCAL BUILDING CODE

EQUIPMENT LOCATION


- 1. ALL EQUIPMENT SHALL MEET MINIMUM SETBACKS AS REQUIRED BY [NEC 110.26]
- 2. EQUIPMENT INSTALLED IN DIRECT SUNLIGHT MUST BE RATED FOR EXPECTED OPERATING TEMPERATURE AS SPECIFIED BY [NEC 690.31 (A)-(B)] AND [NEC TABLE 310.15 (B)(2)(C)].
- 3. ADDITIONAL AC DISCONNECTS SHALL BE PROVIDED WHERE THE INVERTER IS NOT ADJACENT TO THE UTILITY AC DISCONNECT, OR NOT WITHIN SIGHT OF THE UTILITY AC DISCONNECT.
- 4. ALL EQUIPMENT SHALL BE INSTALLED ACCESSIBLE TO QUALIFIED PERSONNEL ACCORDING TO
- NEC APPLICABLE CODES.
- 5. ALL COMPONENTS ARE LISTED FOR THEIR PURPOSE AND RATED FOR OUTDOOR USAGE WHEN APPROPRIATE.

City of Portland REVIEWED FOR CODI COMPLIANCE

AUG 0 1 2017

Permit Number

AERIAL VIEW

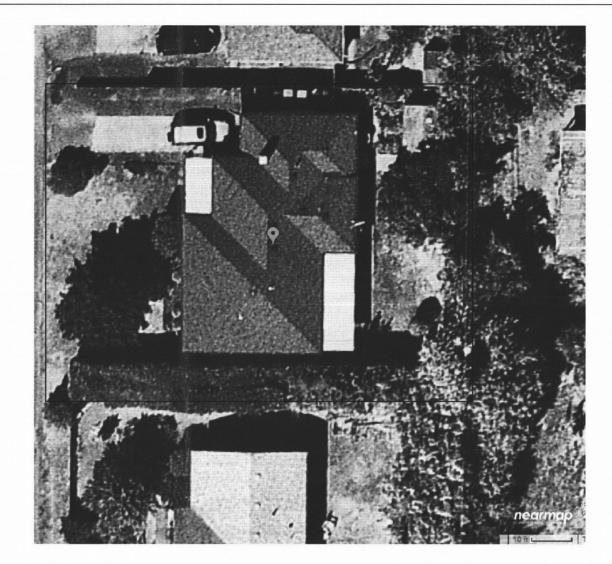

ASCE 7-10 WIND SPEED: 120 MPH GROUND SNOW LOAD: 20 PSF EXPOSURE CATEGORY: C SEISMIC DESIGN CATEGORY: D

OCCUPANCY - R3 CONSTRUCTION - V-B ZONING: RESIDENTIAL

SCOPE OF WORK

DC SYSTEM SIZE: 6.38 kW DC ROOF TYPE: COMP SHINGLE

MODULE: (22) Q.CELL Q.PEAK BLK-G4 1 290 INVERTER(S): SOLARDEDGE SE5000A-US,----

RACKING: IRON RIDGE XR10 PV Mounting & Racking System

ANCHORED ON MAX 48 INCH CENTERS USING UL LISTED RACKING SYSTEM TO SPEC.

UV RESISTANT CABLE TIES(NOT ZIP TIES) USED FOR PERMANENT WIRE MANAGEMENT OFF THE ROOF SURFACE IN ACCORDANCE WITH NEC 110.2,110.3(A-B). 300.4

SOLADECK JUNCTION BOXES MOUNTED FLUSH W/ROOF SURFACE WILL BE USED IF CONDUIT RUN DETERMINED IN THE FIELD TO BE RAN THROUGH ATTIC. DC CONDUCTORS SIZED WITH DERATES TO 1/2" ABOVE ROOF SURFACE PER NEC 310.15(B)(3)(C), IF CONDUIT RAN ON ROOF IT WILL BE INSTALLED AT LEAST 1/2" FROM ROOF SURFACE.

SHEET INDEX

- PV1 COVER SHEET
- PV2 PROPERTY PLAN
- PV3 SITE PLAN
- PV4 EQUIPMENT & ATTACHMENT DETAIL
- PV4.2 EQUIPMENT & ATTACHMENT DETAIL
- PV5 ELECTRICAL SINGLE LINE DIAGRAM
- PV6 ELECTRICAL CALCULATIONS & STRING DIAGRAM
- PV7 MBD CALCS. (IF NEEDED)
- PV8 LABELS & LOCATIONS
- PV9 STRING & SE OPTIMIZER
- PV10 PLACARD (IF NEEDED NEWS 0.56(B))

STRUCTURAL ONLY
July 14, 2017



651 W. GALENA PARK BLVD., SUITE 101 P: (801) 990-1775
DRAPER, UT 84020 F: (801) 990-1776





1220 S. 630 E STE. 430 AMERICAN FORK, UT 84003

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PROJECT MANAGER: SCOTT GURNEY 385-498-4401

CONTRACTC BLUE RAVEN SOL/ 800.377.44

78TH PLACE 7218

PORTLAND, OR 97218

SIZE

SYSTEM

DC

SITE INFORMATION:
BRIAN VAN HORN
4734 NORTHEAST 78TI

DRAWING

MIKE PRATT

DATE

July 11, 2017


PROJECT NUMBER


34002723

COVER SHEET

PAGE NUMBER

REVISION

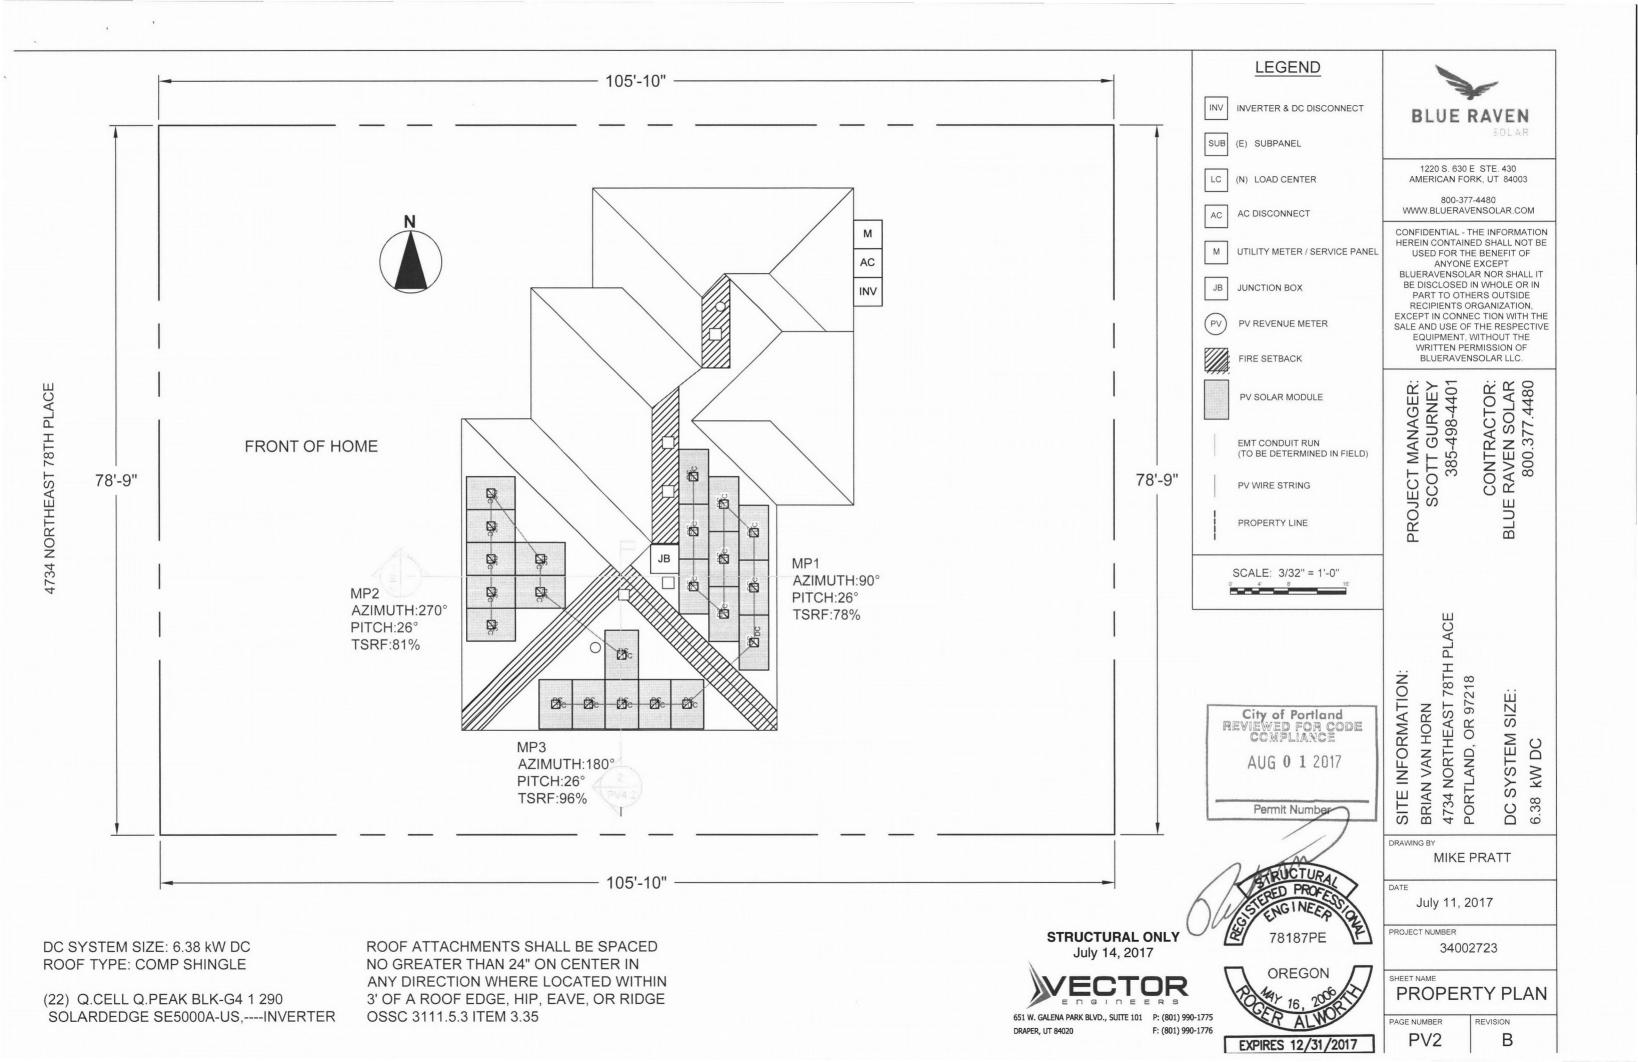

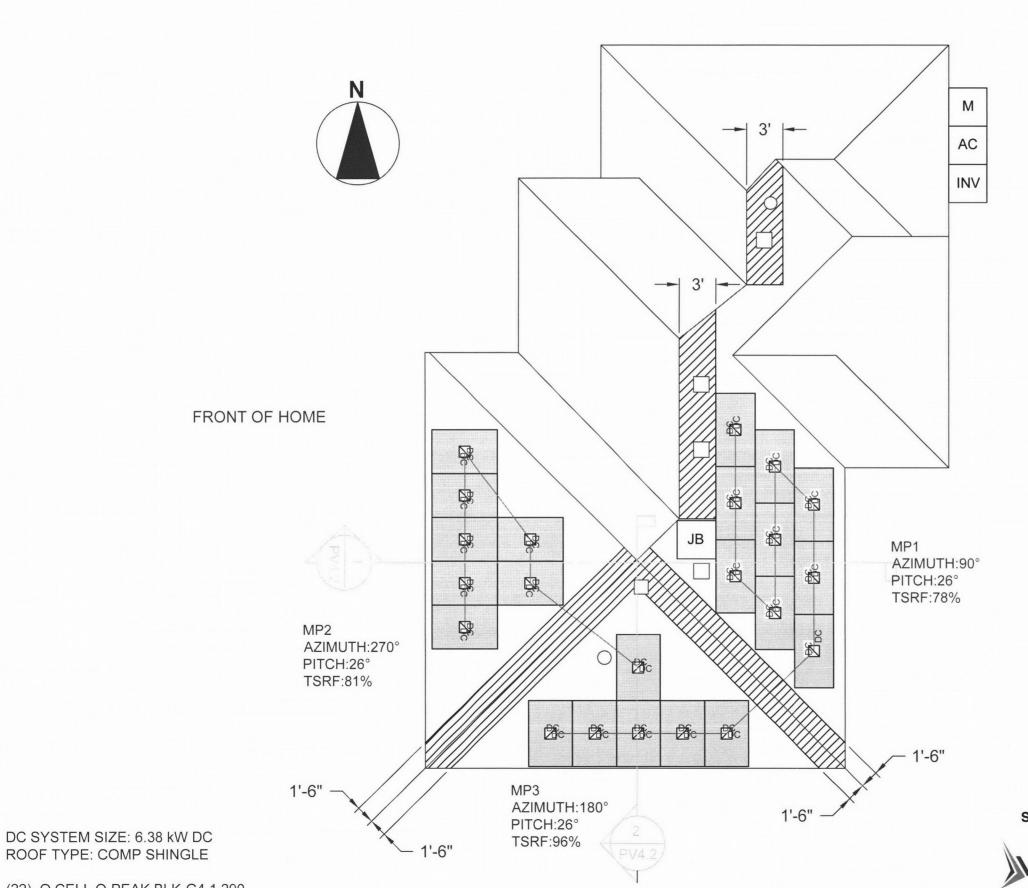



INVERTER & DC DISCONNECT

(E) SUBPANEL

(N) LOAD CENTER

AC DISCONNECT

UTILITY METER / SERVICE PANEL

JUNCTION BOX

PV REVENUE METER

FIRE SETBACK

PV SOLAR MODULE

EMT CONDUIT RUN (TO BE DETERMINED IN FIELD)

PV WIRE STRING

PROPERTY LINE

SCALE: 1/8" = 1'-0"

City of Portland
REVIEWED FOR CODE
COMPLIANCE AUG 0 1 2017 Permit Number

STRUCTURAL ONLY July 14, 2017



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EXPIRES 12/31/2017

78187PE



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PROJECT MANAGER: SCOTT GURNEY 385-498-4401

CONTRACTOR: RAVEN SOLAR 800.377.4480 BLUE

4734 NORTHEAST 78TH PLACE PORTLAND, OR 97218 SITE INFORMATION: BRIAN VAN HORN SYSTEM SIZE: 6.38 kW DC

DRAWING BY

MIKE PRATT

DC

July 11, 2017

PROJECT NUMBER

34002723 SHEET NAME

SITE PLAN

PAGE NUMBER PV3

REVISION В

(22) Q.CELL Q.PEAK BLK-G4 1 290 SOLARDEDGE SE5000A-US,----INVERTER

F: (801) 990-1776

PV ARRAY STRUCTURAL CALCULATIONS

PV MODULE COUNT:

22 MODULES

OF ATTACHMENT POINTS:

73

ARRAY AREA:

Module Count X 17.51ft² = 385.2ft²

ROOF AREA:

2369.8ft²

% OF ARRAY/ROOF:

18.1%

ARRAY WEIGHT:


Module Count x 50lbs = 1100.0lbs


DISTRIBUTED LOAD:


Array Weight ÷ Array Area = 2.86 lbs/ft²


POINT LOAD:

Array Weight + Attachments = 15.2lbs/attachment

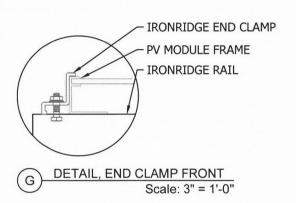


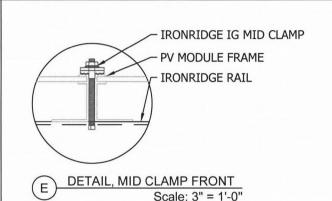

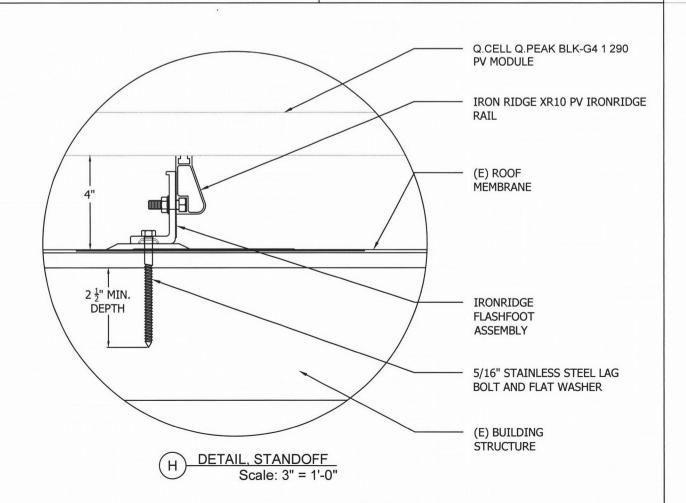


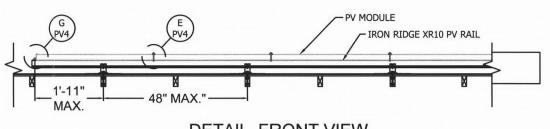

DETAIL, FRONT VIEW Scale: 3/8" = 1'-0"

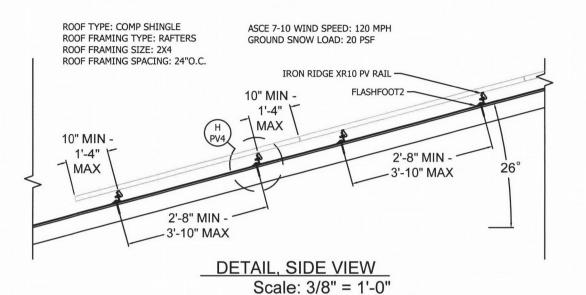

ROOF ATTACHMENTS SHALL BE SPACED NO GREATER THAN 24" ON CENTER IN ANY DIRECTION WHERE LOCATED WITHIN 3' OF A ROOF EDGE, HIP, EAVE, OR RIDGE OSSC 3111.5.3 ITEM 3.35

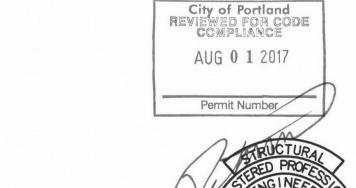

VECTOR ENGINEERING HAS REVIEWED
THE NEW LOADS IMPOSED BY THE
PROPOSED SOLAR ARRAY ON THE
EXISTING STRUCTURE. THE DESIGN OF
SOLAR PANEL RACKING AND ALL OTHER
COMPONENTS SHOWN IS BY OTHERS.

DRAPER, UT 84020



STRUCTURAL ONLY

July 14, 2017

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PROJECT MANAGER: SCOTT GURNEY 385-498-4401

CONTRACTOR: BLUE RAVEN SOLAR 800.377.4480

BRIAN VAN HORN 4734 NORTHEAST 78TH PLACE PORTLAND, OR 97218 DC SYSTEM SIZE:

kW DC

DC S 6.38

DRAWING BY

SITE INFORMATION:

MIKE PRATT

DATE

July 11, 2017

PROJECT NUMBER

34002723

SHEET NAME

EQUIP. DETAIL

PAGE NUMBER

REVISION B

* SCOPE OF REVISION ROOF ATTACHMENTS SHALL BE SPACED NO GREATER THAN 24" ON CENTER IN ANY DIRECTION WHERE LOCATED WITHIN 3' OF A ROOF EDGE, HIP, EAVE, OR RIDGE OSSC 3111.5.3 ITEM 3.35 1'-6" -7'-3" 8'-6" 8'-6" 7'-3" 1'-6" 1220 S. 630 E STE. 430 AMERICAN FORK, UT 84003 800-377-4480 WWW.BLUERAVENSOLAR.COM CONFIDENTIAL - THE INFORMATION HEREIN CONTAINED SHALL NOT BE USED FOR THE BENEFIT OF ANYONE EXCEPT BLUERAVENSOLAR NOR SHALL IT BE DISCLOSED IN WHOLE OR IN PART TO OTHERS OUTSIDE RECIPIENTS ORGANIZATION EXCEPT IN CONNECTION WITH THE SALE AND USE OF THE RESPECTIVE B EQUIPMENT, WITHOUT THE WRITTEN PERMISSION OF BLUERAVENSOLAR LLC. *RAFTER UPGRADE - FULL SISTER (N) CONTRACTOR: BLUE RAVEN SOLAR 800.377.4480 2X4 TO (E) 2X4 RAFTERS WITH 16D PROJECT MANAGER: SCOTT GURNEY 385-498-4401 SINKERS SPACED 12" APART STAGGARD LBW LBW **LBW LBW** STRUCTURAL SIDE VIEW Scale: Not to Scale City of Portland
REVIEWED FOR CODE
COMPLIANCE RAFTERS 2X4 @ 24" OC 6'-3" 1'-6" 7'-5" AUG 0 1 2017 4734 NORTHEAST 78TH PLACE 10'-6" Permit Number SITE INFORMATION: PORTLAND, OR 97218 DC SYSTEM SIZE: BRIAN VAN HORN 6.38 kW DC 10'-5" OREGON *RAFTER UPGRADE - FULL SISTER (N)
2X4 TO (E) 2X4 RAFTERS WITH 16D
SINKERS SPACED 12" APART DRAWING BY MIKE PRATT EXPIRES 12/31/2017 DATE July 11, 2017 STRUCTURAL ONLY July 14, 2017 PROJECT NUMBER 34002723 LBW **LBW** STRUCTURAL SIDE VIEW EQUIP. DETAIL Scale: Not to Scale

PAGE NUMBER

PV4.2

REVISION B

RAFTERS 2X4 @ 24" OC



City of Portland, Oregon - Bureau of Development Services



1900 SW Fourth Avenue Portland, Oregon 97201 | 503-823-7300 | www.portlandoregon.gov/bds

Permit Revision Submittal Requirements and Application

A Permit Revision is required when there are proposed changes to the project after the permit has been issued. This may arise due to discrepancies between the city-approved permit drawings and actual field conditions, or the customer has changed their mind about an aspect of the project. In all cases, a revision to the existing permit must be submitted, reviewed and approved.

Applicants will provide: A copy of this application Three (3) sets of plans that clearly reflect the proposed change(s). Drawings and calculations must be stamped and signed by the Architect and/or the Engineer of Record, if applicable.	One (1) copy of the original city approved permit drawings. (NOTE: If your project has an assigned process manager please contact them regarding submittal of the revision). Two (2) sets of calculations, if applicable Inspector's correction notice, if revision is due to an inspection correction Revision fee (paid at time of submittal)
Contact Information: Contact name Zach Scholad Address (270 S. (30) S. H430)	
Address (200) (0,50 2 14950 City State	Parmyting, Department & Blue raven, Com
Value of proposed revision #0.50 Job site address 4734 NE 78th PL	Issued permit # 17-164640
Description of revision fastened tech Char	ngel for Structural upgale
Fees:	

The Permit Revisions are subject to fees associated with plan review, processing and any increase in project value. Additional fees may apply if adding plumbing fixtures.

The Bureau of Development Services fee schedule is available under the fees tab on the BDS web site at: www.portlandoregon.gov/bds. Fees are updated annually on July 1st.

Helpful Information:

Bureau of Development Services

City of Portland, Oregon 1900 SW 4th Avenue, Portland, OR 97201 www.portlandoregon.gov/bds

Submit your plans in person to:

Development Services Center (DSC), First Floor, For Hours Call 503-823-7310

Important Telephone Numbers:

503-823-7300
503-823-7310
503-823-1456
503-823-7000
503-823-7388
503-823-7357
503-823-6868