

## City of Portland, Oregon - Bureau of Development Services



1900 SW Fourth Avenue Portland, Oregon 97201 | 503-823-7300 | www.portlandoregon.gov/bds

### Permit Revision Submittal Requirements and Application

A Permit Revision is required when there are proposed changes to the project after the permit has been issued. This may arise due to discrepancies between the city-approved permit drawings and actual field conditions, or the customer has changed their mind about an aspect of the project. In all cases, a revision to the existing permit must be submitted, reviewed and approved.

Applicants will provide:	One (1) copy of the original city approved permit
A copy of this application  Three (3) sets of plans that clearly reflect the proposed change(s).  Drawings and calculations must be stamped and signed by the Architect and/or the Engineer of Record, if applicable.	drawings. (NOTE: If your project has an assigned process manager please contact them regarding submittal of the revision).  Two (2) sets of calculations, if applicable  Inspector's correction notice, if revision is due to an inspection correction  Revision fee (paid at time of submittal)
Contact Information:	
Contact name Elizabeth Steszy	$\sim$
Address 404 SE 45th Ohr	
City Por Hand State_	02 Zip Code 97 215
Phone 503-341-9226 Email_	Steszyn @ comcast 1
Value of proposed revision	_ Issued permit # 16 - 244444 RS
Job site address 49 1727 SE Mad	ison Portland OR 97214
Description of revision extending widt	th of upper level by
One foot.	, , , , , , , , , , , , , , , , , , , ,
Fees:	

The Permit Revisions are subject to fees associated with plan review, processing and any increase in project value. Additional fees may apply if adding plumbing fixtures.

The Bureau of Development Services fee schedule is available under the fees tab on the BDS web site at: www.portlandoregon.gov/bds. Fees are updated annually on July 1st.

#### **Helpful Information:**

**Bureau of Development Services** 


City of Portland, Oregon 1900 SW 4th Avenue, Portland, OR 97201 www.portlandoregon.gov/bds


#### Submit your plans in person to:


Development Services Center (DSC), First Floor, For Hours Call 503-823-7310 | Select option 1

#### **Important Telephone Numbers:**

BDS main number	503-823-7300
DSC automated information line	503-823-7310
Building code information	503-823-1456
BDS 24 hour inspection request line	503-823-7000
Residential information for	
one and two family dwelling	503-823-7388
General Permit Processing and	
Fee Estimate info	503-823-7357
City of Portland TTY	503-823-6868

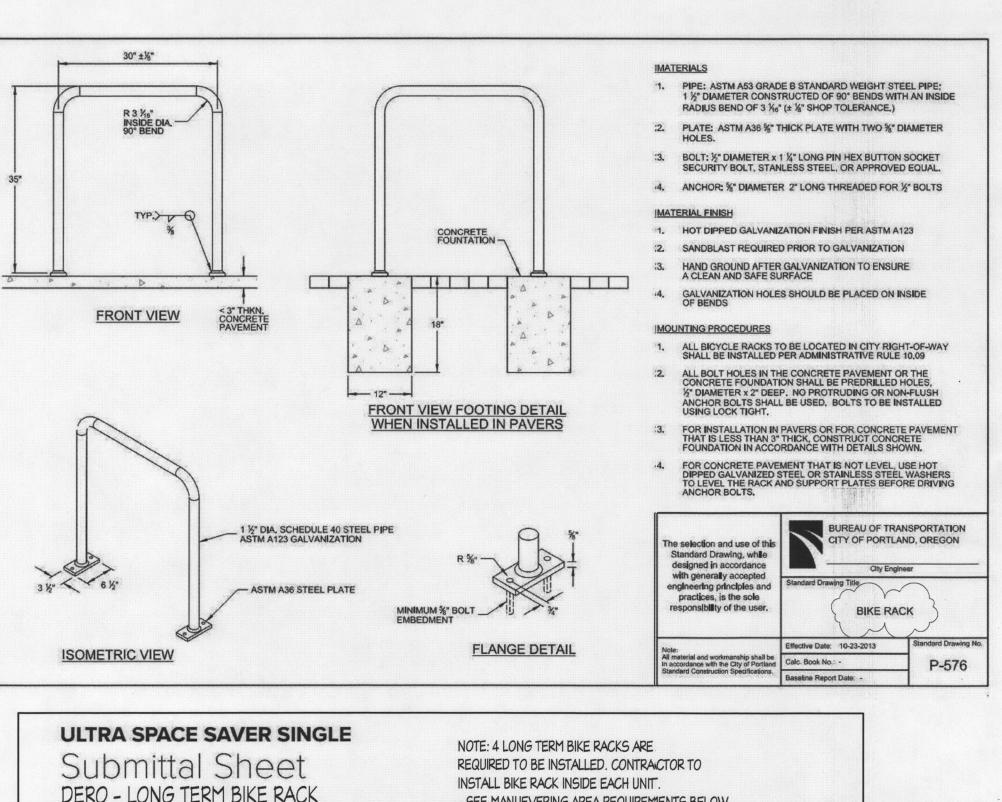


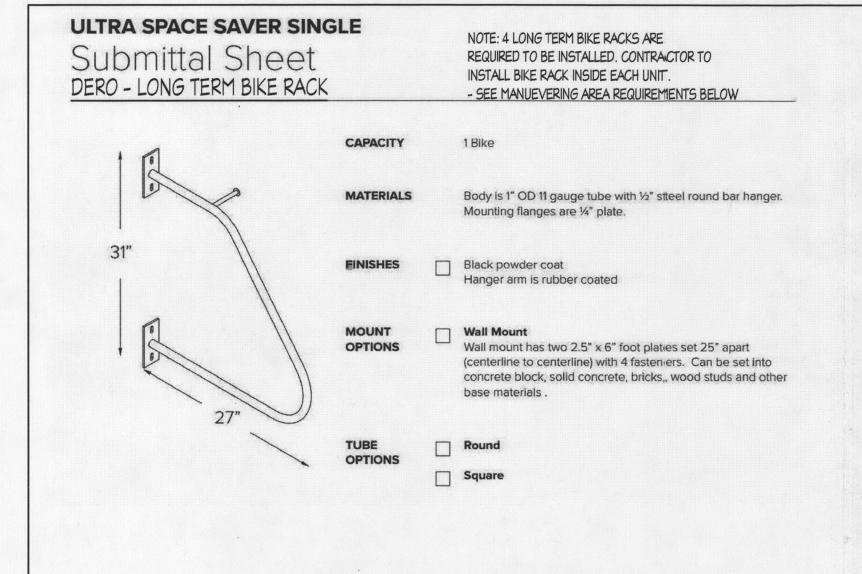

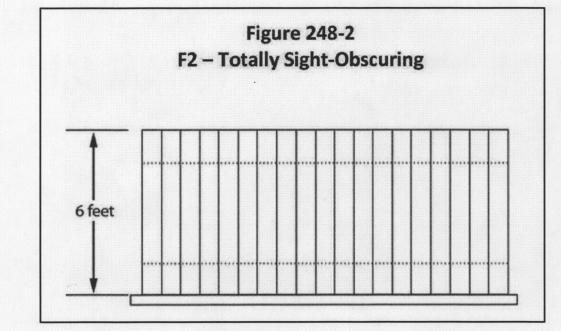

## BIKE PARKING REQUIREMENTS

Standards for all biicycle parking found in Title 33, Planning and Zoning, 33.26i6.220.C.3 are as follows: The bicycle frame and one wheel can be locked to the rack with a high security, U-shaped shackle lock even if both wheels are left on the bicycle; An area of 2 feet by 6 feet must be provided for each bicycle parking space in order that a bicycle six feet long can be securely helld in place with its frame supported by the rack. The bicycle should not be able to be pushed over or fall in a manner that will damage its wheels or The rack must be securely anchored.

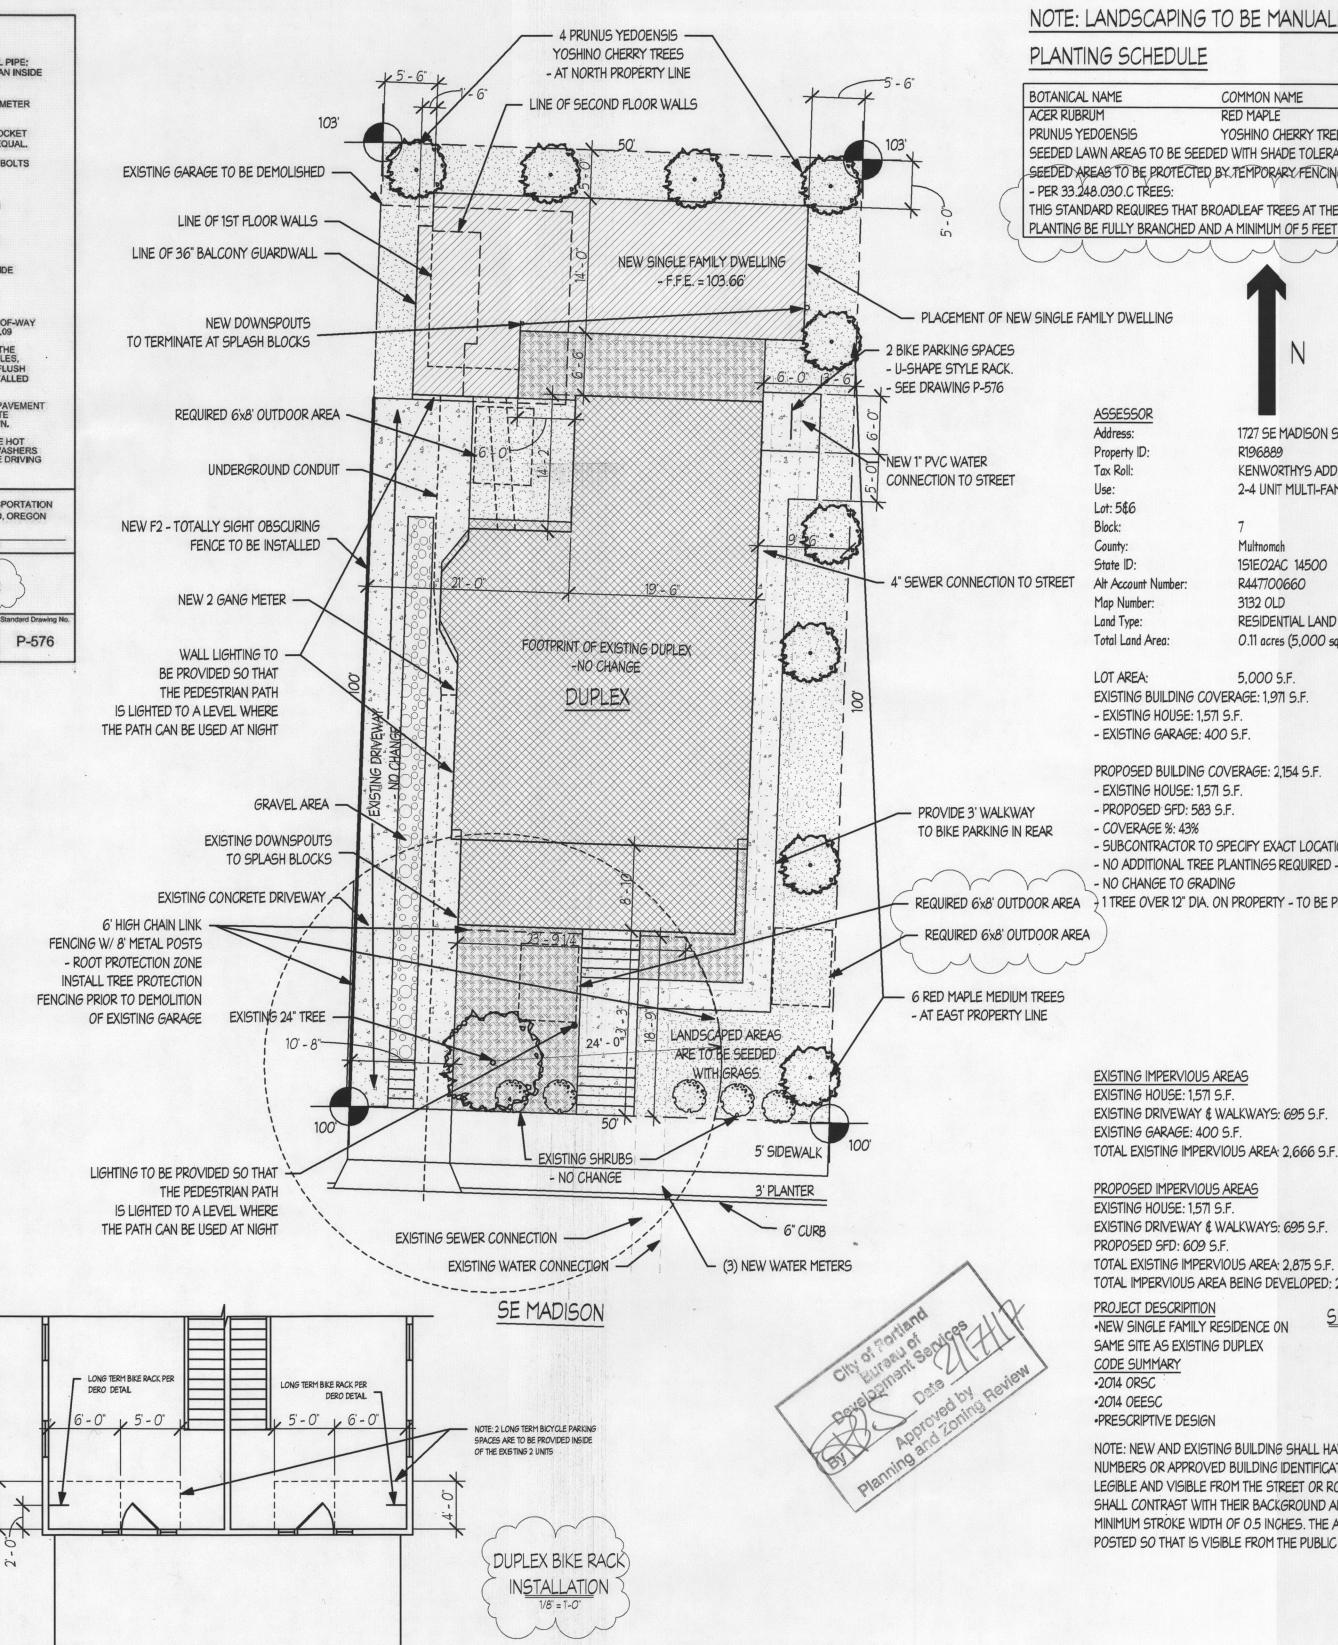

# NOTE: LANDSCAPING TO BE MANUALLY IRRIGATED

# PLANTING SCHEDULE

BOTANICAL NAME COMMON NAME QTY. SIZE ACER RUBRUM RED MAPLE PRUNUS YEDOENSIS YOSHINO CHERRY TREES 1.5" CAL. SEEDED LAWN AREAS TO BE SEEDED WITH SHADE TOLERANT LAWN MIXTURE. SEEDED AREAS TO BE PROTECTED BY TEMPORARY FENCING UNTIL ESTABLISHED. - PER 33.248.030.C TREES: THIS STANDARD REQUIRES THAT BROADLEAF TREES AT THE TIME OF PLANTING BE FULLY BRANCHED AND A MINIMUM OF 5 FEET IN HEIGHT.

1727 SE MADISON ST, PORTLAND, OR 97214 Property ID: R196889 KENWORTHYS ADD, BLOCK 7, W 1/2 OF LOT 5&6 2-4 UNIT MULTI-FAMILY

County: Multnomah 151E02AC 14500 R447700660 Alt Account Number:

3132 OLD Map Number: Land Type: RESIDENTIAL LAND Total Land Area: 0.11 acres (5,000 sq ff)

LOT AREA: 5,000 S.F. EXISTING BUILDING COVERAGE: 1,971 S.F. - EXISTING HOUSE: 1,571 S.F. - EXISTING GARAGE: 400 S.F.

PROPOSED BUILDING COVERAGE: 2,154 S.F.

- EXISTING HOUSE: 1,571 S.F. - PROPOSED SFD: 583 S.F.

- COVERAGE %: 43% - SUBCONTRACTOR TO SPECIFY EXACT LOCATIONS OF UTILITY STUBS - NO ADDITIONAL TREE PLANTINGS REQUIRED - <\$153,000 VALUATION

- NO CHANGE TO GRADING

) 1 TREE OVER 12" DIA. ON PROPERTY - TO BE PROTECTED

# EXISTING IMPERVIOUS AREAS

EXISTING HOUSE: 1,571 S.F. EXISTING DRIVEWAY & WALKWAYS: 695 S.F. EXISTING GARAGE: 400 S.F.

PROPOSED IMPERVIOUS AREAS

EXISTING HOUSE: 1,571 S.F. EXISTING DRIVEWAY & WALKWAYS: 695 S.F. PROPOSED SFD: 609 S.F. TOTAL EXISTING IMPERVIOUS AREA: 2,875 S.F.

TOTAL IMPERVIOUS AREA BEING DEVELOPED: 209 S.F. PROJECT DESCRIPITION

•NEW SINGLE FAMILY RESIDENCE ON SAME SITE AS EXISTING DUPLEX CODE SUMMARY •2014 ORSC •2014 OEESC •PRESCRIPTIVE DESIGN


NOTE: NEW AND EXISTING BUILDING SHALL HAVE APPROVED ADDRESS NUMBERS, BUILDING Project number: NUMBERS OR APPROVED BUILDING IDENTIFICATION PLACED IN A POSITION THAT IS PLAINLY LEGIBLE AND VISIBLE FROM THE STREET OR ROAD FRONTING THE PROPERTY. THESE NUMBERS Date: 2/13/2017 2:14:14 PM SHALL CONTRAST WITH THEIR BACKGROUND AND BE A MINIMUM OF 4 INCHES HIGH WITH A MINIMUM STROKE WIDTH OF 0.5 INCHES. THE ADDRESS FOR THE ADU SHALL BE CLEARLY POSTED SO THAT IS VISIBLE FROM THE PUBLIC STREET.


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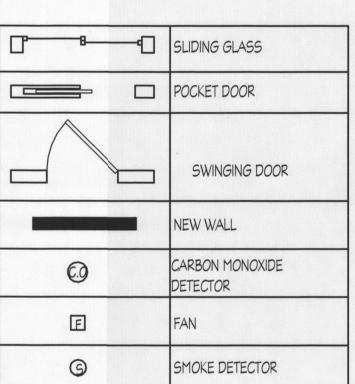
Permit Number

**MADIS** PI SITE SE 2

As indicated CS



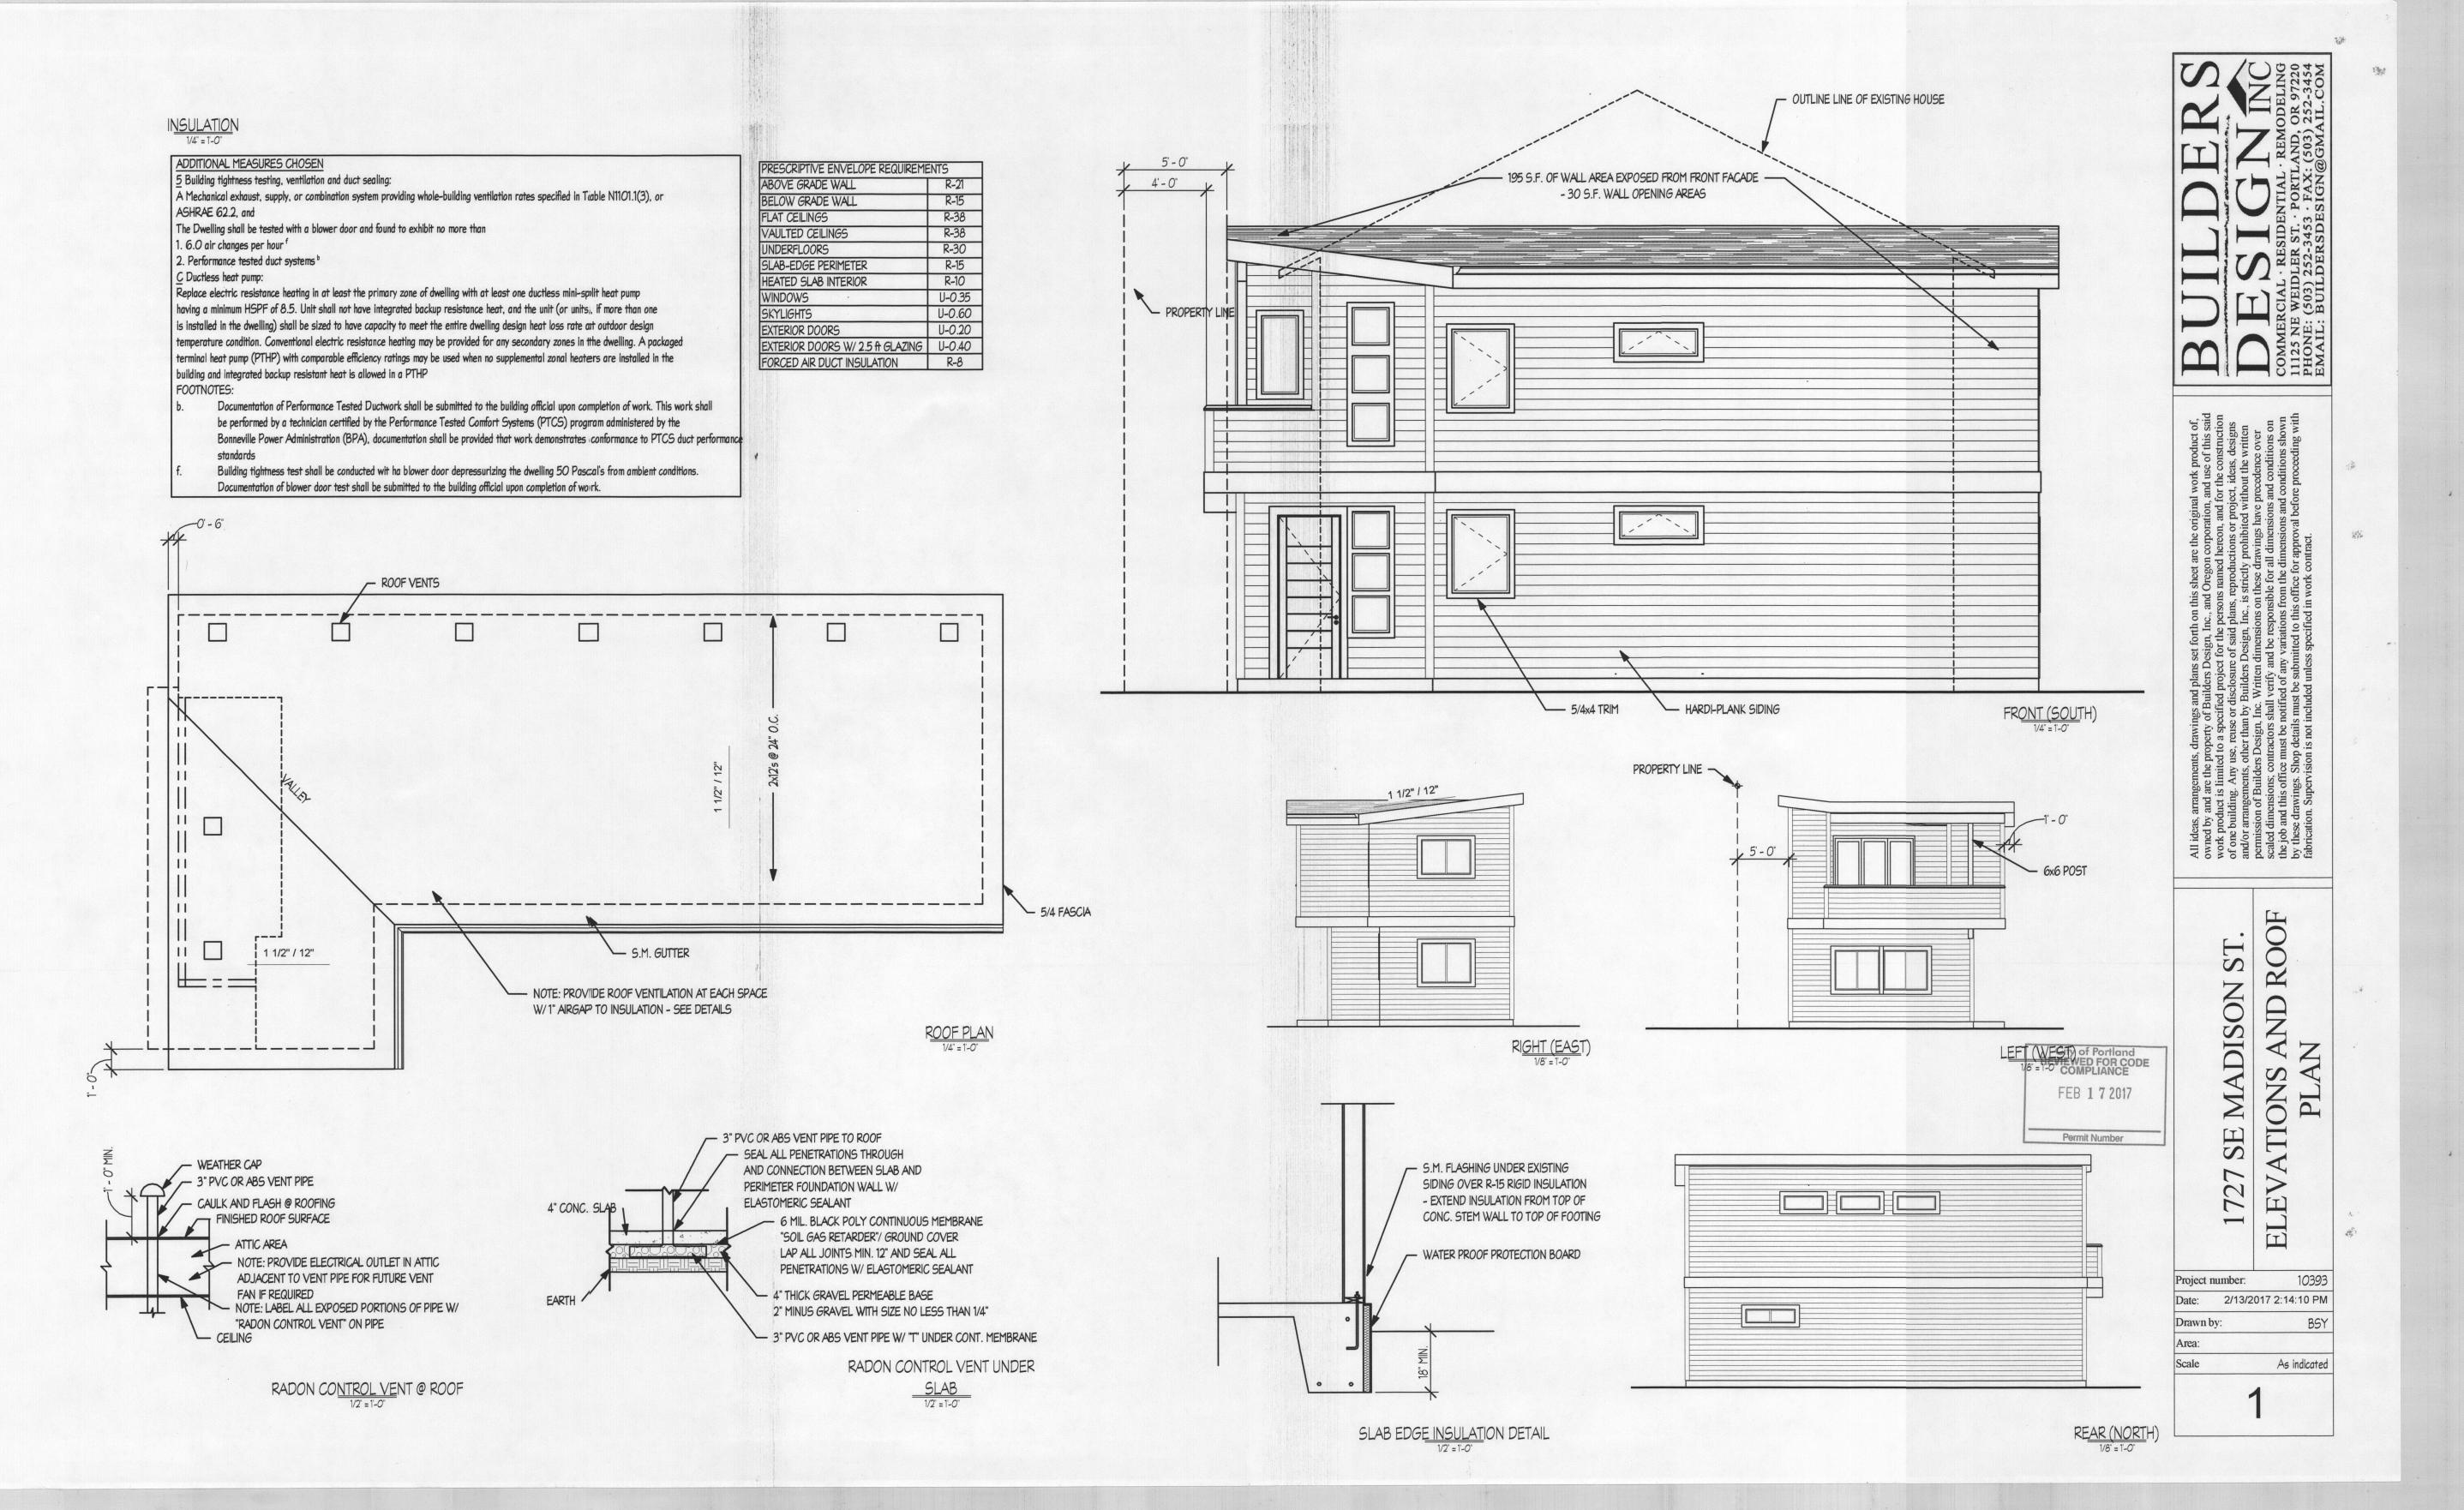

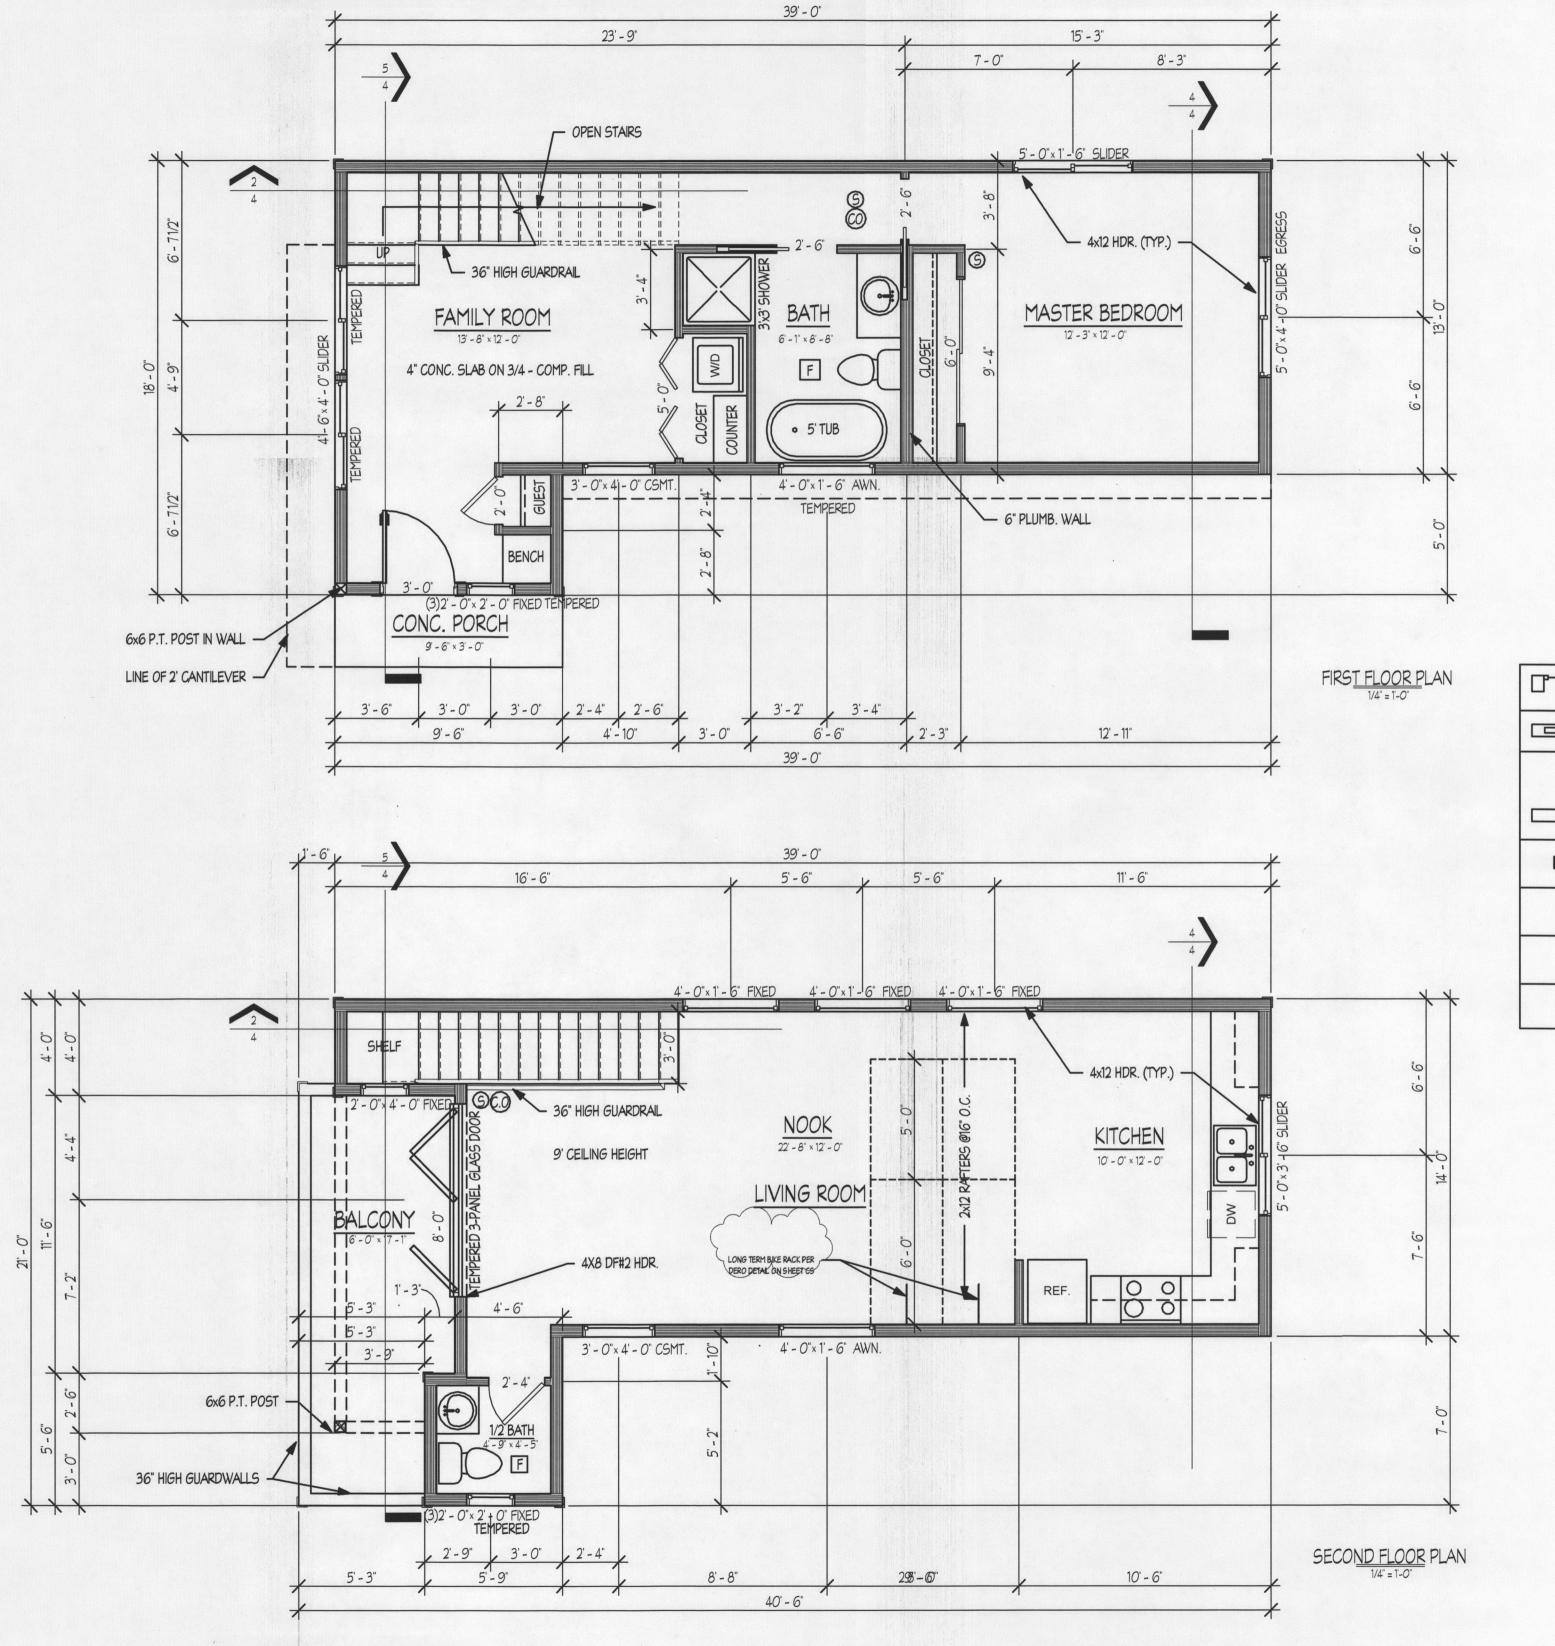




City of Portland
REVIEWED FOR CODE
COMPLIANCE
FEB 1 7 2017

Permit Number

1727 SE MADISON ST. 1st FLOOR PLAN

BUILDERSDEIGN@GMAIL.COM

Project nu	mber:	103
Date:	2/13/2	017 2:14:11 [
Drawn by:		В
Area:		1,059.
Scale		1/4" = 1'-

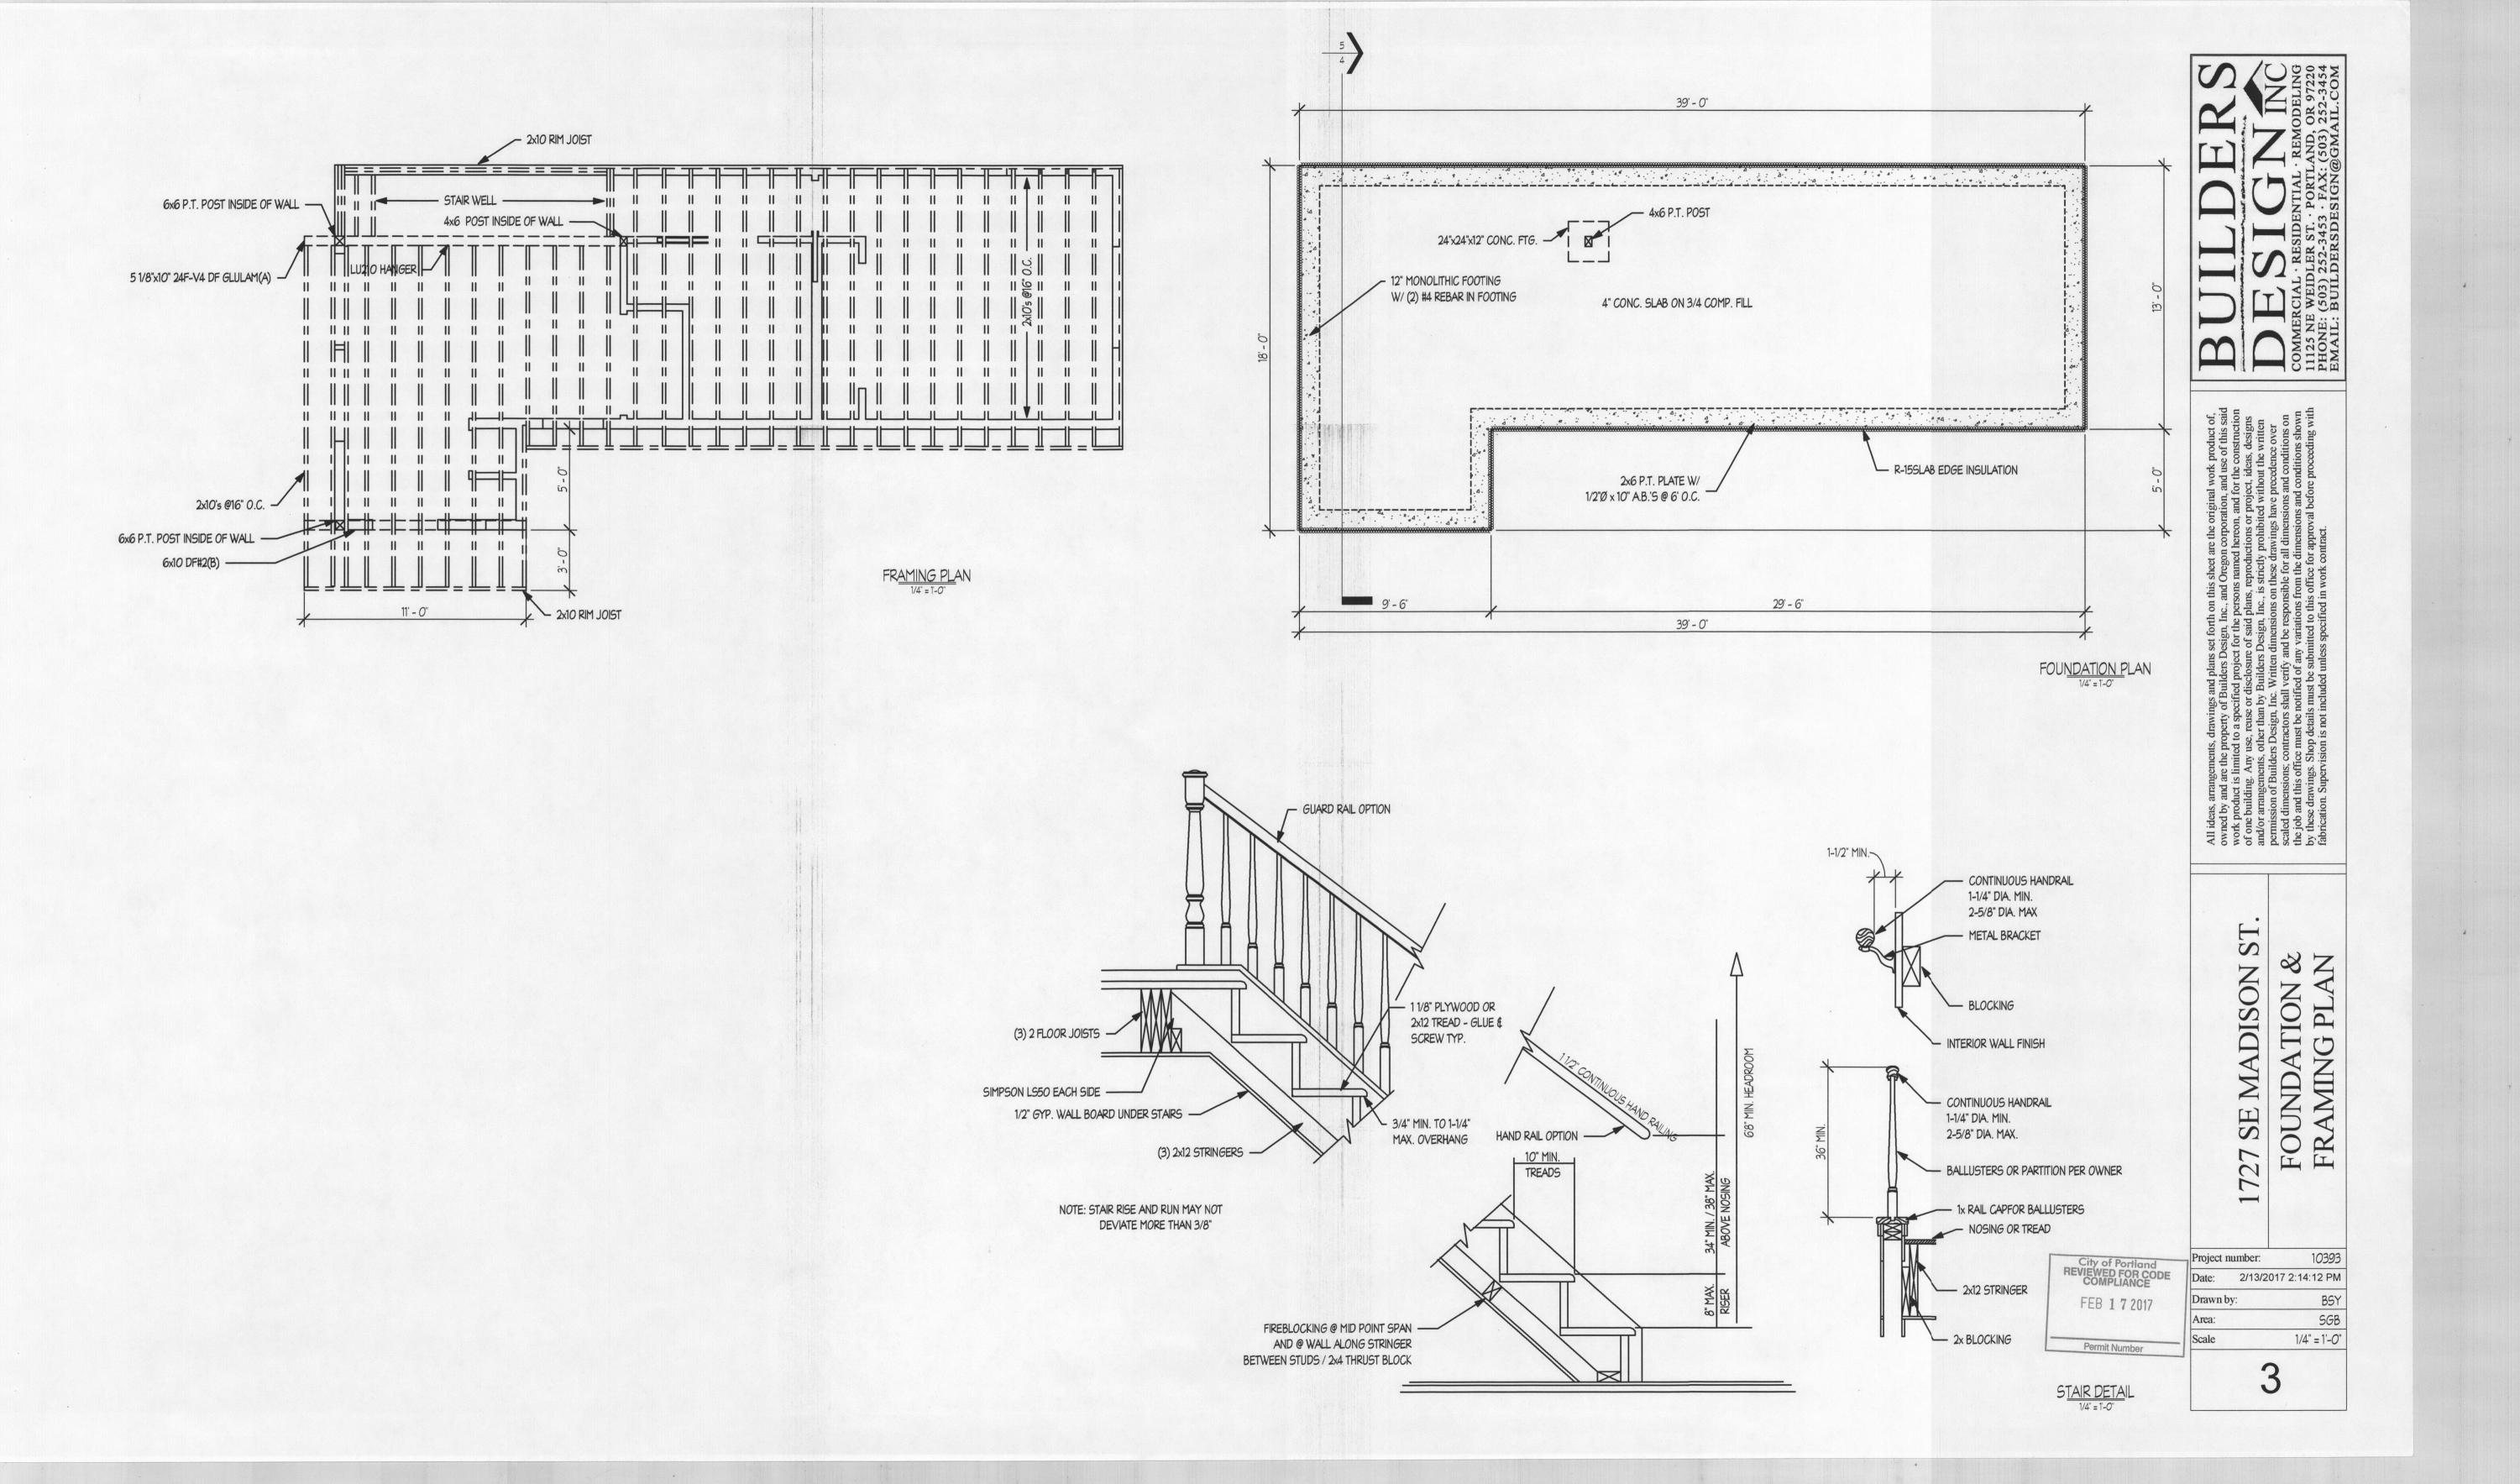

GENERAL CONDITIONS 1. ALL WORK SHALL CONFORM WITH THE LATEST ADOPTED ISSUE OF THE OREGON 2014 RESIDENTIAL SPECIALTY CODE. 2. THE CONTRACTOR IS RESPONSIBLE FOR CHECKING THE PLANS AND SITE CONDITIONS AND TO NOTIFY THE ARCHITECT OF ANY ERRORS OR OMISSIONS PRIOR TO THE START OF CONSTRUCTION. 3. WRITTEN DIMENSIONS HAVE PRECEDENCE OVER SCALED DIMENSIONS SITE WORK 1. REMOVE TOP SOIL AND ORGANIC MATERIAL FROM THE BUILDING SITE, STOCKPILING ON SITE FOR FINAL GRADING IF POSSIBLE. 2. FOOTINGS ARE TO BEAR ON UNDISTURBED LEVEL SOIL, STEPPED AS REQUIRED TO MAINTAIN THE REQUIRED DEPTH BELOW FINISH GRADE. 3. ANY FILL UNDER GRADE SUPPORTED CONCRETE SLABS TO BE 4" THICK (MIN.) SAND COMPACTED TO 95%. 4. CONCRETE SLABS TO BE 4" THICK, 3000 P.S.I AT 28 DAYS WITH CONTROL JOINTS AT 25' O/C (MAX.) EACH WAY 5. FINISH GRADES ARE TO REMAIN AT LEAST 6" BELOW FINISH SIDING. **FOUNDATIONS** 1. CONCRETE - MIX AND 28 DAY STRENGTH OF CONCRETE - BASEMENT WALLS & FOUNDATION NOT EXPOSED TO WEATHER 2500 PSI - BASEMENT & INTERIOR 2500 PSI SLABS ON GRADE: - BASEMENT WALLS & FOUNDATIONS EXPOSED TO WEATHER AND GARAGE SLABS: 3000 PSI -PORCHES. STEPS & CARPORT SLABS EXPOSED TO WEATHER: 3000 PSI 2. ALL REINFORCING STEEL TO BE A-615 GRADE 60. WELDED WIRE MESH TO BE 3. LAP ALL CONTINUOUS BARS 30 x DIA. (MIN.) PLACE ALL REINFORCING AS PER A.C.I. CODES & STANDARDS. 4. PROVIDE A MINIMUM CLEARANCE OF 18" UNDER GIRDERS, BEAMS, OR JOISTS. 5. COVER ENTIRE CRAWL SPACE WITH 6 MIL. BLACK "VISQUEEN" AND EXTEND UP FOUNDATION WALLS AND FASTEN TO MUD SILL 6. PROVIDE A MINIMUM OF 1 S.F. OF NET VENTILATION AREA FOR EACH 1500 S.F. OF CRAWL SPACE AREA. VENTS ARE TO BE CLOSABLE AND HAVE 1/4" OPENINGS IN CORROSIVE RESISTANT SCREEN. POST NOTICE ABOUT OPENING VENTS NEAR ELECTRICAL PANEL. GAS PERMEABLE MATERIAL SHALL BE PILACED UNDER ALL CONCRETE SLABS INCLUDING: 7. ALL WOOD IN CONTACT WITH CONCRETE TO BE PRESSURE TREATED. 1. A UNIFORM OF CLEAN AGGRIEGATE, A MINIMUM OF 4" THICK. 8. BEAM POCKETS IN CONCRETE WALLS TO HAVE 1/2" AIR SPACE AT SIDES AND 2. A UNIFORM LAYER OF SAND) A MINIMUM OF 4" THICK. ENDS AND 3" OF BEARING (MIN.) 3. OTHER MATERIALS, SYSTEMIS, OR FLOOR DESIGNS WITH DEMONSTRATED 9. MUD SILLS TO BE 2x6 PRESSURE TREATED WOOD WITH 1/2" DIA. x 10" ANCHOR CAPABILITY TO PERMIT DEPIRESSURIZATION ACROSS THE ENTIRE SUB-FLOOR AREA BOLTS SPACED 6'-0" O/C, OR PER SHEAR WALL SCHEDULE AND WITHIN 12" OF SOIL GAS RETARDER: CORNERS. LAYOUT FOR 14' LONG 2x6 P.T. SILL PLATE, PROVIDE AB. EACH SIDE OF A MINIMUM 6 MIL. POLY OR EQUIV. FLEXIBLE SHEETING MATERIAL SHALL BE SILL SPLICES. 10. PROVIDE 4" DIA. PERFORATED DRAIN TILE BELOW THE TOP OF FOOTINGS.

- 4x4 POSTS (PICKETS AND RAILS

NOT SHOWN FOR CLARITY)

SIMPSON HD3B HOLDOWN

DECKING -

2x12 BLOCKING

W/ SIMPSON A34 FRAMING

(4 TOTAL CONNECTORS)

ANGLE EACH SIDE AT EACH END

2x12 JOIST —

MANU. I-JOISTS

WITH (2) 5/8" dia. GALVANIZED THROUGH

(2) 5/8" dia. GALVANIZED THROUGH

BOLTS WITH WASHERS AT FAR SIDE

**BOLTS WITH WASHERS** 

2x12 RIM JOIST WITH

(3) 16d NAILS @ EACH JOIST

GUARD POST CONNECTION TO PARRALEL JOISTS

NAILING SCHEDULE: JOIST TO SILL OF GIRDER: TOE NAIL (3) 8d BRIDGE TO JOIST (2) 8d TOE NAIL **BOTTOM PLATE TO JOIST** 16d@16" O.C. FACE NAIL PLYWOOD SUBFLOOR 8d@6" EDGE NAIL INTERIOR 8d @ 12" TOP PLATE TO JOIST (2)16dEND NAIL STUD TO BOTTOM PLATE (4)8dTOE OR END NAIL DOUBLE STUDS 16d@ 16" O.C FACE NAIL DOUBLE TOP PLATE 16d@ 16" O.C. FACE NAIL CONTINUOUS HEADER (2 PC) 16d@ 16" O.C. EDGE NAIL CEILING JOIST TO PLATE (3) 8d FACE NAIL (3) 16d CEILING JOIST LAP OVER PLATE FACE NAIL CEILING JOIST TO RAFTER (3) 16dFACE NAIL RAFTER TO TOP PLATE (3) 8d TOE NAIL COLLAR TIES (EACH END) (6) 10d (U.N.O.) FACE NAIL BUILD UP CORNER STUDS 16d @ 24" O.C. FACE NAIL FACE NAIL TOP PLATE AT INTERSECTIONS (2) 16d 2 ROWS - 16d @ 12" O.C. STAGGERED MULTIPLE LVL'S (2 PLIES) MULTIPLE LVL'S (3 PLIES) 2 ROWS - 16d @ 12" O.C. STAGGERED MULTIPLE JOISTS (UP TO 3) 2 ROWS - 16d @ 12" O.C. STAGGERED 1x6 SPACED SHEATHING FACE NAIL RAFTERS TO HIPS, VALLEY OR RIDGE (4) 16d HEALTH AND SAFETY: All new smoke and CO alarms shall be hardwired with battery backup and interconnected within the dwelling unit Smoke alarms shall be located within each sleeping room, immediately outside of each sleeping room, and on each level of the dwelling. CO alarms shall be located within 15' outside off each bedroom door. All alarms shall be cross listed for interconnecttion. All Smoke Alarms shall be listed in accordance: with UL 217. Combination Smoke / Carbon monoxide alarms shall be listed as complying with UL 2034 and UL 217. Combination Smoke / Carbon monoxide alarms shall be listed as complying with ANSI/UL 2075 and ANSI/UL FANS AND SMOKE DETECTORS FANS IN BATHING AREAS SHALL BE CONTROLLED BY TIMER. SMOKE DETECTORS SHALL BE 110V BATTERY BACKUP. RADON CONTROL NOTES: CONCRETE JOINTS:

A. POSTS, BEAMS, HEADERS, JOISTS AND RAFTERS - NO. 1 DOUG FIR OR LVL'S - 2650 FB & 1.8E B. PLATES, BLOCKING AND BRIDGING -NO. 3 DOUG FIR C. STUDS -STUD GRADE DOUG FIR D. T&G DECKING -STUD & BETTER GRADE DOUG FIR E. PLY. SHEATHING -CD DOUG FIR PLY. (32/16) F. GLU-LAM -24-F V-4 2. UNLESS OTHERWISE NOTED ON DRAWINGS, ALL EXTERIOR WINDOW AND DOOR HEADERS ARE TO BE 4x12 DOUG FIR No. 1 3. PROVIDE DOUBLE JOISTS UNDER ALL BEARING PARTITIONS. 4. DESIGN LOADS :ROOF -25 P.S.F. (LL) FLOOR -40 P.S.F. (LL) 100 P.S.F. (LL) STAIRS -GARAGE FLOOR - 50 P.S.F. (LL) 40 P.S.F. (LL) 5. SOIL BEARING PRESSURE IS ASSUMED TO BE 1500 P.S.F. 6. NAILING SCHEDULE AS PER TABLE 25-Q, U.B.C., TYPICAL PLYWOOD NAILING WITH 8d NAILS @ 6" O/C AT EDGES AND 12" O.C. FIELD. 7. DECK AND BALCONY GUARDRAILS TO BE 36" HIGH WITH MAXIMUM OPENING SPACES SO THAT A 4" SPHERE CAN NOT PASS THROUGH. 8. PROVIDE METAL TRUSS AND RAFTER TIE DOWNS SUCH AS A, "SIMPSON" H2.5 TO EACH RAFTER AT TOP 9. ALL EXTERIOR FASTENERS, EXPOSED TO THE ELEMENTS TO BE STAINLESS STEEL OR GALVANIZED. INCLUDING NAIL, STAPLES, CLIPS, ETC. GYPSUM BOARD FINISH 1. ERECT SINGLE LAYER 1/2" STANDARD, 5/8" F.R. AND 1/2" MOISTURE RESISTANT GYPSUM BOARD IN MOST ECONOMICAL DIRECTIONS, WITH ENDS OCCURRING OVER FIRM BACKING. ROOF COVERINGS ROOF COVERINGS ASPHALT SHINGLES SHALL BE USED ONLY ON ROOF SLOPES OR 2/12 OR GREATER. FOR ROOF SLOPES FROM 2/12 TO 4/12, DOUBLE UNDERLAYMENT APPLICATION IS REQUIRED. **ENTRY ROUTES:** FLOOR OPENINGS: POTENTIAL RADON ENTRY ROUTES (BATHTUBS, SHOWERS, PIPES, WIRES, OR OTHER OBJECTS THAT PENETRATE CONC. SLABS) SHALL BE SEALED WITH POLYURETHANE CAULK APPLIED ACCORDING TO MANU. SPEC'S.

ALL JOINTS IN CONCRETE OR BETWEEN SLAB AND FOUNDATION WALL

CONDENSATE DRAINS:

2x4 WALL

SHALL BE SEALED WITH CAULK OR SEALANT. GAPS AND JOINTS SHALL

BE CLEARED OF LOOSE MATERIAL AND FILLED ACCORDING TO MANU. SPEC'S.

CONDENSATE DRAINS SHALL BE TRAPPED OR ROUTED THROUGH NON-PERFORATED PIPE TO DAYLIGHT

TILE LOOPS SHALL BE COVERED WITH GASKETED OR OTHERWISE SEALED LID. SUMPS USED AS THE

THE VENT PIPE. SUMPS USED AS A FLOOR DRAIN SHALL HAVE A LID EQUIPPED WITH TRAPPED INLET

SUCTION POINT IN A SUB-SLAB DEPRESSURIZATION SYSTEM SHALL HAVE A LID DESIGNED TO ACCOMMODATE

SUMP PITS OPEN TO SOIL OR SERVING AS TERMINATION POINT FOR SUB-SLAB OR EXTERIOR DRAIN

1. WOOD FRAMING MEMBER GRADES ARE AS FOLLOWS UNLESS, OTHERWISE NOTED ON THE DRAWINGS:

FEB 1 7 2017 PLACED ON TOP OF THE GAS-PERMEABILE LAYER PRIOR TO CASTING THE SLAB. THE SHEETING SHALL COVER THE ENTIRE FLOOR AREA WITH SEPARATE SHEETING LAPPED AT LEAST 12". THE SHEETING SIHALL FIT CLOSELY AROUND ANY PENETRATION OF THE MAT. Permit Number ALL PUNCTURES AND TEARS SHALL BE SEALED OR COVERED WITH ADDITIONAL SHEETING. 2x12 RAFTER @ 16" O.C - 2x12@ 24' O.C. ----28 CEILING JOIST @ 16" O \_\_\_\_\_\_ HARDI-PLANK SIDING ON 6x6 P.T POST W/ - R-38 INSUL. - S.M. GUTTER PC66@ TOP OF POST 1/2" PLY. WD. OR 7/16" OSB - HGUS-5.50/14 W/TYVEK HYDROGAP (OR EQUAL) ON 2x6 STUDS @ 16" O.C. DOUBLE TOP PLATE W/R-21 INSULATION - 36" HIGH GUARDWALL 5 1/8"x10 1/2" 24F-V4 DF GLULAM HARDI-PLANK SIDING ON 4x4 POSTS (PICKETS AND RAILS -1/2" PLY. WD. OR 7/16" OSB NOT SHOWN FOR CILARITY) SIMPSON HD3B HOLDOWN W/ TYVEK HYDROGAP (OR EQUAL) -- 60 MIL. TPO DECK SURFACE WITH (2) 5/8" dia. GALVANIZED THROUGH ON 2x6 STUDS @ 16" O.C. BOLTS WITH WASHERS AT FAR SIDE W/ R-21 INSULATION 3/4 EDGE-GOLD DECKING -3/4" EDGE-GOLD SUBFLOOR 2x10's @ 16" O.C. -1/2" GYP. BD. -(2) 5/8" dia. GALVANIZED THROUGH - DOUBLE TOP PLATE SOLID BLOCKING - 6"x10" DF#2 - 1/2" GYP. BOARD -**BOLTS WITH WASHERS** DOUBLE RIM JOIST . 2x6 JOISTS @ 16" O.C. - 2x10's @ 16" O.C. AT STAIR LANDINGS 2x12 JOISTS 2x12 RIM JOIST WITH (3) 16d NAILS @ EACH JOIST GUARD POIST CONNECTION TO PERPENDICULAR JOISTS 1/2"Ø x 10" A.B.'S @ 6' O.C. - 3/4 EDGE-GOLD TREADS 1/2"Ø x 10" A.B.'S @ 6' O.C. — - 2x12 STRINGERS #4 REBAR AT TOP - R-15 INSULATION .006 POLY V.B. GRADE GUARDRAIL ATTACHMENT TO 4" CONC. SLAB ON 3/4 - COMP. FILL WALL 1/2" = 1'-0" 4" CONC. SLAB ON 3/4 - COMP. FIL R-15 INSULATION -12" MONOLITHIC FOOTING Section 3

1/4" = 1'-0"

12" MONOLITHIC FOOTING

W/ (2) #4 REBAR IN FOOTING

2x12 RAFTERS@24" O.C. ---

5 1/8"x10 1/2" 24F-V4 DF GLULAM

4" CONC. SLAB ON 3/4- COMP. FILL

1/2"Ø x 10" A.B.'S @ 6' O.C. —

2x6 JOISTS @ 16" O.C.

12" MONOLITHIC FOOTING

W/(2) #4 REBAR IN FOOTING

AT STAIR LANDINGS

R-15 INSULATION -

- 2x8 CEILING JOISTS @24" O.C. —

- 3/4" EDGE-GOLD TREADS

- MAX 8" RISE/ MIN. 9" RUN

W/ (2) #4 REBAR IN FOOTING

7.25" RISE / 9.5" RUN SHOWN

- 3' GUARD RAIL

3/4" EDGE-GOLD

2x12's @ 16" O.C

(3) 2x12 STRINGERS

Section 1

City of Portland
REVIEWED FOR CODE
COMPLIANCE

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GENERAL NOT SECTIONS AND D

10393

As indicated

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**MADISON** 

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Date: 2/13/2017 2:14:12 PM


Project number:

Drawn by

Area:

Section 2

1/4" = 1'-0"

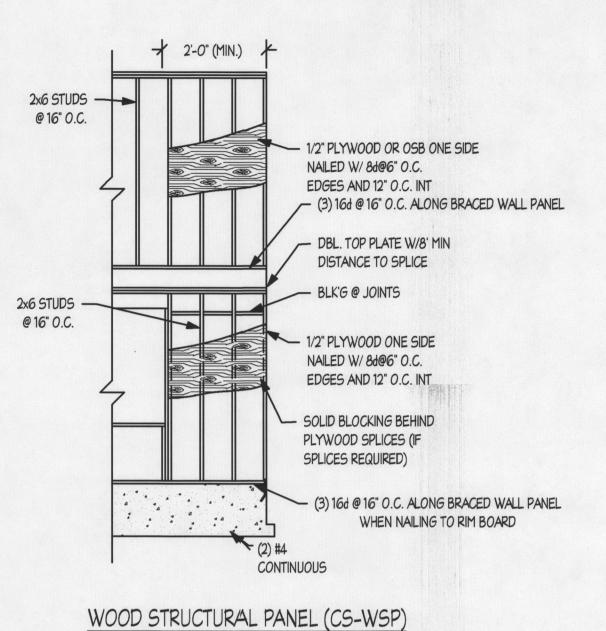


# Method CS-PF: Continuous Portal Frame


SECTION R602.10.4.1.1

Refer to Table 3 (page 2) in conjunction with Talble B (page 5) for straps required due to pony walls constructed on headers.


1/4" = 1'-0"

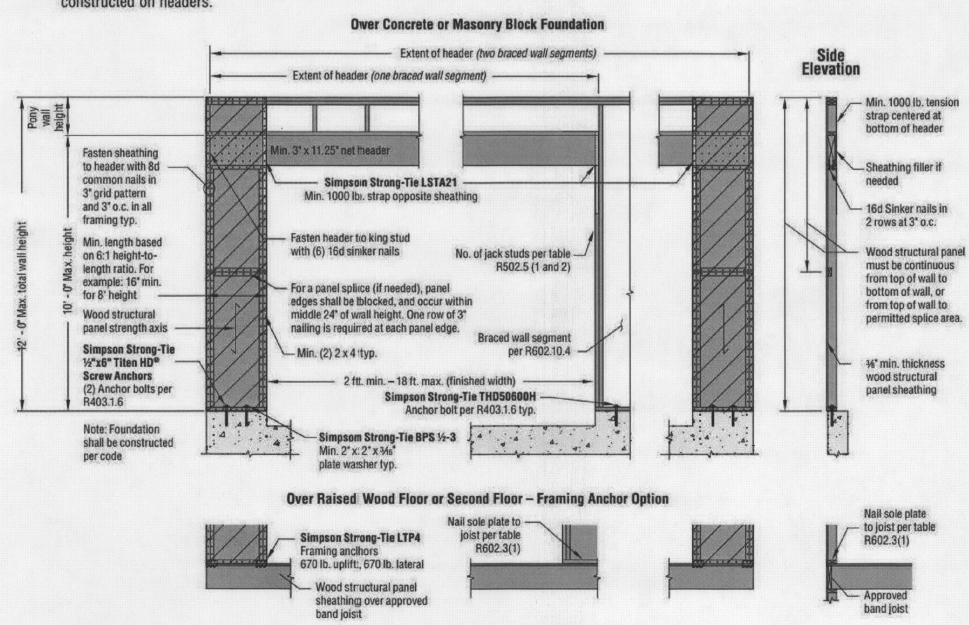

Method CS-PF: Continuous Portal Frame Panel Construction

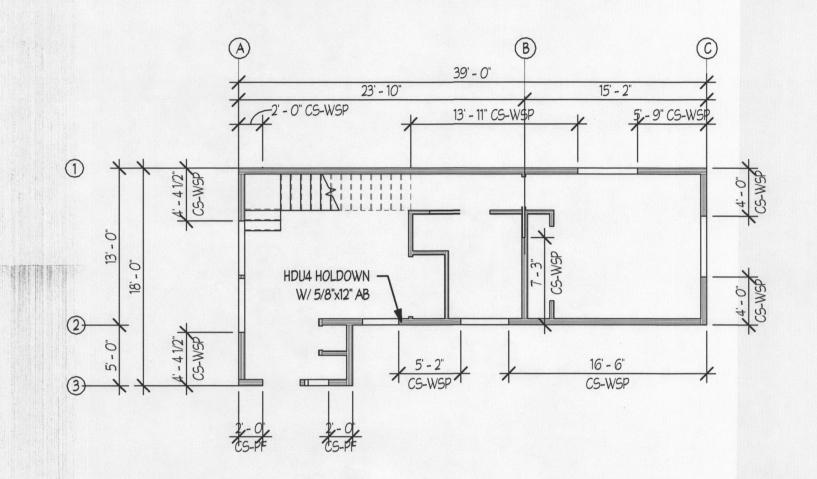

FIRST FLOOR SHEAR PLAN
1/8" = 1-0"

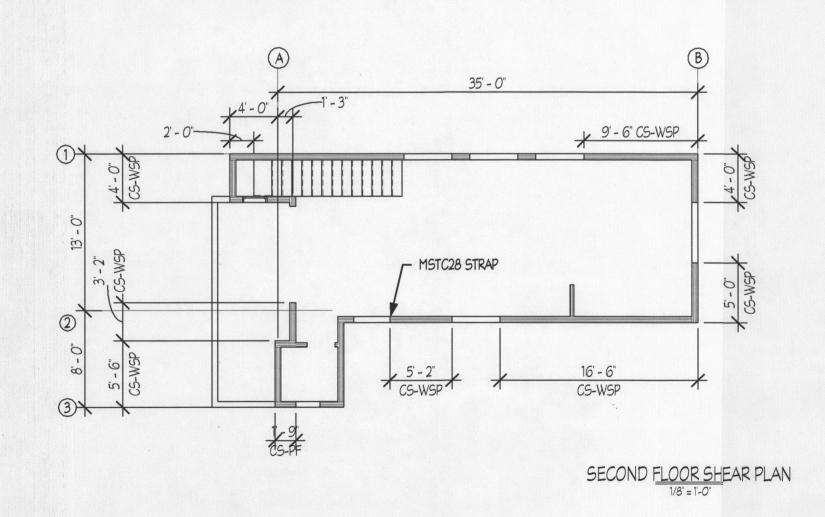

1727 SE MADISON ST.
SHEAR BRACING
DETAILS

Project number: 10393

Date: 2/13/2017 2:14:12 PM

Drawn by: Author

Area: Checker

Scale As indicated

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Permit Number