

Development Site Address 1131 WI/SE Oak St

R R150543

Tax account number(s)

R R150544

City of Portland, Oregon - Bureau of Development Services



1900 SW Fourth Avenue • Portland, Oregon 97201 • 503-823-7526 • www.portlandoregon.gov/bds

| Early Assistance Application | File Number: 14-227891 |
|--|---|
| FOR INTAKE, STAFF USE ONLY | Appt Date/Time |
| Date Rec 10.20.14 by Esandy | 2001 |
| LU Reviews Expected DZ | Qtr Sec Map(s) 303/ Zoning EXA |
| Required Optional | Plan District CCPD; Central Eastside |
| [Y] [N] Unincorporated MC | Neighborhood <u>Buckman</u> |
| [Y] [N] Flood Hazard Area (LD & PD only) | District Coalition |
| [Y] [N] Potential Landslide Hazard Area (LD & PD only) | Business Assoc CEIC |
| | Neighborhood within 400/1000 ft Buckman |
| | |
| APPLICANT: Complete all sections below that a | pply to the proposal. Please print legibly. |

Cross Street SE 11th Ave/SE Stark St Site Size/Area 46,000 sf

Adjacent property in same ownership

R R150545

| R R | _ К | | |
|--|---|----------------------------------|--|
| Project Description - include proposed stormwater | disposal methods | | |
| Affordable multi-family residential, 102 apartments of pri | marily studio and one bedroom | size. Anticipate one l | evel of |
| concrete structure at SE Stark for resident services and co | mmunity space along with belo | ow grade parking. Ho | using will |
| occur above within 3 story and 4 story wood framed cons | struction. Storm water is anticip | oated through on-site | treatment and |
| infiltration however geotechnical report indicates poor in | filtration so auxiliary connectio | n to the combo sewer | anticipated. |
| Design Review (New development: give project valuation. Re | enovation: give exterior alteration v | value) \$\frac{11,700,000.00}{2} |) |
| Early Assistance Type | City Reviewers | Meeting & written notes provided | No meeting, written notes provided |
| ☑ Pre-application Conference required for Type III and IV land use reviews | BDS Land Use Services, Transportation, Environmental Services, Water, others as needed | \$4,289 | |
| ☑ Design Commission Advice Request presentation at Design Commission | BDS Land Use Services, Design Commission | \$2,520 | |
| ☐ Early Assistance - Zoning and Infrastructure Bureaus | BDS Land Use Services, Transportation, Environmental Services, Water | \$1,502 | □ \$1,074 |
| ☐ Early Assistance - Zoning Only | BDS Land Use Services | □ \$500 | □ \$400 |
| ☐ Pre-Permit Zoning Plan Check | BDS Land Use Services | | \$200 |

Note: Public notice (email and internet posting) provided for Pre-application conferences and Design Commission Advice Requests.

Transportation, Environmental

Services, Water

\$450

\$150

☐ 1-2 housing units

☐ All other development

☐ Public Works Inquiry for 1-2 housing units

No land use review or property line adjustment expected

| | apply 🗹 Ap | | |
|--|--|--|---|
| Name_Bill Lanning | | Company_M\ | /A Architects |
| Mailing Address 70 NW Couch St, Suite | 401 | | |
| City Portland | | State OR | Zip Code_97209 |
| Day Phone_(503) 973-5151 | FAX (503) | 973-5060 | email blanning@mwaarchitects.com |
| Check all that apply Applicant | Owner | ☑ Other | |
| Name April Berg | | Company <u>Hon</u> | ne Forward |
| Mailing Address 135 SW Ash St, Suite 5 | 500 | | |
| | | State_OR | Zip Code_ ⁹⁷²⁰⁴ |
| • | | | |
| Check all that apply Applicant | ☑ Owner | Other | |
| Name_Trell Anderson | | Company_St. F | rancis Park L.P. |
| Mailing Address 2740 SE Powell Blvd | | | <u> </u> |
| | | | |
| | | State OR | Zip Code_97202 |
| City_Portland Day Phone_(503) 231-4866 Submit the following: ✓ Fee | FAX <u>N/A</u> | | Zip Code 97202email tanderson@catholiccharitiesoregon.org |
| City Portland Day Phone (503) 231-4866 Submit the following: Fee Two site plans, to scale, (8.5x11 in water, sewer and stormwater conn Building elevations Additional two site plans, to scale, | FAX N/A ches) showing | : 1) existing and pro cilities; 3) lot dimens | |
| City Portland Day Phone (503) 231-4866 Submit the following: ✓ Fee ✓ Two site plans, to scale, (8.5x11 inwater, sewer and stormwater conn ✓ Building elevations ✓ Additional two site plans, to scale, NOTE: 1. Estimates for System Development Chargwebsite. 2. Plans examiners do not participate in Earl | FAX N/A ches) showing ections and factors and factors and factors are not specifically assistance meeting. | p: 1) existing and pro cilities; 3) lot dimens or larger in size It be provided at Early As | email tanderson@catholiccharitiesoregon.org |
| City Portland Day Phone (503) 231-4866 Submit the following: Fee Two site plans, to scale, (8.5x11 inwater, sewer and stormwater conn Building elevations Additional two site plans, to scale, NOTE: 1. Estimates for System Development Chargwebsite. 2. Plans examiners do not participate in Earl questions, consult with a plans examiner in article/94545). | FAX N/A ches) showing ections and factors and factors and factors and factors are not specifically as a second of the Permit Center of | : 1) existing and pro cilities; 3) lot dimens or larger in size It be provided at Early As tings and they do not pro er or schedule a Life Saf | email tanderson@catholiccharitiesoregon.org |
| City Portland Day Phone (503) 231-4866 Submit the following: Fee Two site plans, to scale, (8.5x11 in water, sewer and stormwater conn Building elevations Additional two site plans, to scale, NOTE: 1. Estimates for System Development Charg website. 2. Plans examiners do not participate in Earl questions, consult with a plans examiner i article/94545). Questions to be discussed: 1) Consideration for loading zones with earling the state of the state o | FAX N/A ches) showing ections and factors and factors and factors and factors are not specifically assistance meeting the Permit Central chin access drives existing overhead | eways and they do not proceed at Early As tings and they do not proceed at Early As tings and they do not proceed at Early As eways | email tanderson@catholiccharitiesoregon.org |
| City Portland Day Phone (503) 231-4866 Submit the following: ☐ Fee ☐ Two site plans, to scale, (8.5x11 inwater, sewer and stormwater connowater, sewer and stormwater connowater connowater and stormwater connowater connowater connowater connowater, sewer and stormwater connowater connowater connowater, sewer and stormwater connowater c | FAX N/A ches) showing ections and factors and factors and factors and factors are not specifically assistance meeting the Permit Center and the Permit Center access drive existing overheader below grade or below grade | eways construction activities construction activities | email tanderson@catholiccharitiesoregon.org |
| City Portland Day Phone (503) 231-4866 Submit the following: Fee Two site plans, to scale, (8.5x11 in water, sewer and stormwater conn Building elevations Additional two site plans, to scale, NOTE: 1. Estimates for System Development Chargwebsite. 2. Plans examiners do not participate in Earl questions, consult with a plans examiner i article/94545). Questions to be discussed: 1) Consideration for loading zones with ed. 3) Ability to lay back in ROW to curb for 4) Will a Traffic Impact Analysis be req. | FAX N/A ches) showing ections and factors and factors and factors and factors are not specifically assistance meeting the Permit Center of below grade or below grade ouired? Can a 15 | eways ad utility lines construction activities minute field observa | email tanderson@catholiccharitiesoregon.org |
| City Portland Day Phone (503) 231-4866 Submit the following: ✓ Fee ✓ Two site plans, to scale, (8.5x11 inwater, sewer and stormwater connowater, sewer and stormwater connowater connowater connowater was a sewer and stormwater connowater connowater, sewer and stormwater connowater connowater connowater, sewer and stormwater connowater connowater, sewer and stormwater connowater connowater connowater connowater, sewer and stormwater connowater | FAX N/A ches) showing ections and factors and factors and factors and factors are not specifically assistance meets in the Permit Center with the property of the content of the property of the pr | exactions: 1) existing and procilities; 3) lot dimens or larger in size It be provided at Early As tings and they do not procer or schedule a Life Safet ad utility lines Construction activities In minute field observations: | email tanderson@catholiccharitiesoregon.org |



Civil Schematic Design Narrative 1131 & 1136 SE Oak Street St. Francis Park Development June 2, 2014 (revised Oct. 20, 2014)

Site Description

The project site consists of an existing park on 1.1-acres of land in the city of Portland, Oregon. The site is zoned Central Employment (EX) with a design (d) overlay. The project will construct a new 4story building that will provide 100-140 units of affordable housing as part of a partnership between Home Forward and Catholic Charities with involvement from St. Francis Parish. The development will include ground floor retail, below ground parking, a central internal plaza, bike parking, a soup kitchen garden, and stormwater planters.

On-Site Improvements

Water

An 8-inch public water main exists in SE Stark Street and a 12-inch main exists in SE 12th Avenue. The site is currently served off the 4-inch water main in vacated SE Oak Street, but this main will be required to be abandoned by Portland Water Bureau as part of this project. A new connection off of SE Stark Street or SE 12th Avenue will be required. We anticipate that the development will require at least a 3-inch domestic water service connection and a 6-inch fire lateral.

There are four public fire hydrants near the site. One is located across the street on the southeast corner of SE Oak Street and SE 12th Avenue. Another is located across vacated SE Oak Street on the northeast corner of SE Oak and SE 11th Avenue. A third is located across the street on the southeast corner of SE Stark Street and SE 11th Avenue. And the fourth is located across the intersection on the southeast corner of SE Stark Street and SE 12th Avenue. The existing fire hydrants are adequate to serve the building.

Sanitary Sewer

Sanitary mains exist in both SE Oak and SE Stark Streets. SE Oak Street contains a 30-inch sanitary sewer and an abandoned sanitary sewer line. SE Stark Street contains an 8-inch and 72-inch sanitary line. The site is currently served from a lateral that connects to the SE Stark Street line near SE 11th Avenue. The project will attempt to reuse the existing lateral on SE Stark Street.

Storm Drain

The site is located in a combined sewer area, so stormwater is required to be disposed of on-site if at all possible. Plaza runoff will be treated in flow-through stormwater planters, likely built into the steps between the plaza and garden. Roof runoff and treated stormwater from the planters will drain to a sedimentation manhole which drains to a drywell for disposal. Depending on the infiltration rate of the drywell, a second drywell may be required for disposal. Due to the relatively

> 111 SW 5th Avenue, Suite 2500, Portland, OR 97204 503-227-3251 FAX 503-274-4681 Eugene, OR



CIVIL SCHEMATIC DESIGN NARRATIVE RE: St. Francis Park Development June 2, 2014 Page 2

poor infiltration rates of the soil there will need to be an overflow connection to the combination sewer in Oak.

Gas

4-inch gas mains exist in SE 11th Avenue and SE Oak Street, while SE Stark Street and the northern half of SE 12th Avenue contain 2-inch gas mains. A new gas lateral will be required.

Power

Overhead power is located along the furnishing zone of the site on SE 12th Avenue and SE Stark Street. Overhead lines are located across the street from the site on SE 11th Avenue and SE Oak Street.

Street Improvements


Curb and Sidewalks

The site currently has 12-foot sidewalk corridors as required by the City, however, the frontages on SE 11th Avenue, SE 12th Avenue, and SE Stark Street must be reconstructed to meet current requirements of a 4-foot wide furnishing zone width. The vacated SE Oak Street frontage will be required to provide a 15-foot wide pedestrian corridor.

Street Trees


At this time it is assumed that all existing street trees will be removed and replaced with new trees approximately 30-feet apart as part of the frontage improvements.

New street trees will be planted in accordance with the City of Portland street tree requirements. The City of Portland Urban Forester will determine the number of street trees that are required along the frontages during the Frontage Improvement permit process. In our experience, trees (existing or new) must be 25-feet away from any existing or future street lights and they must be 5-feet away from any new water services.

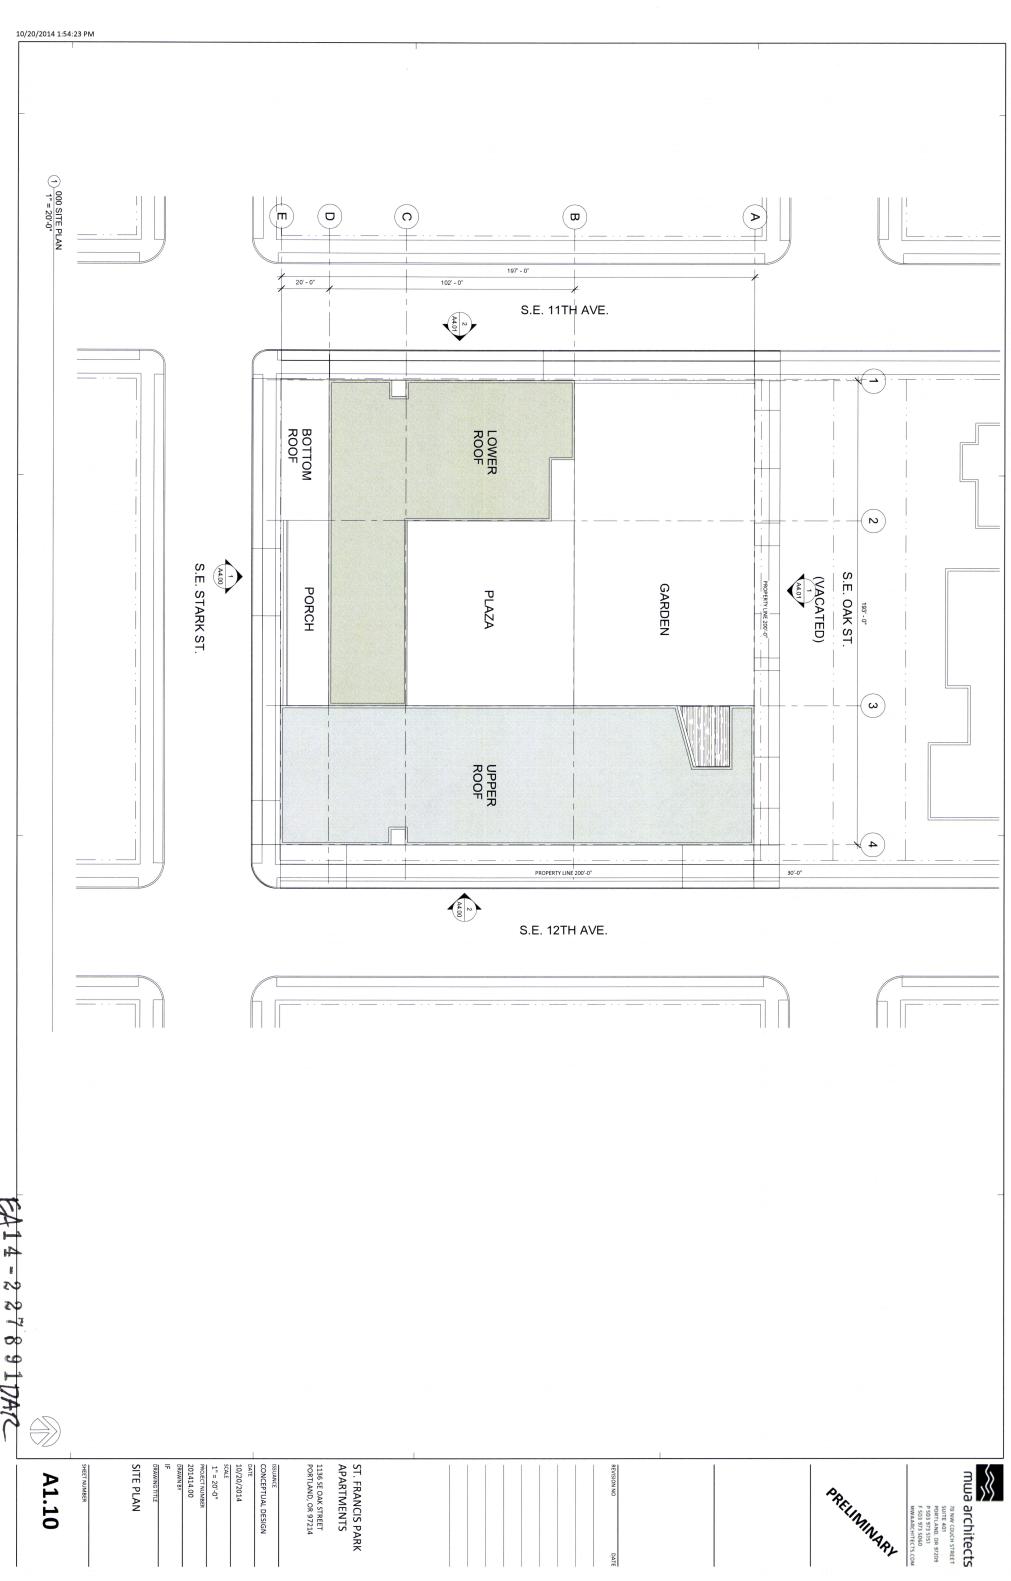

PACININA AN

10/20/2014 1:54:24 PM

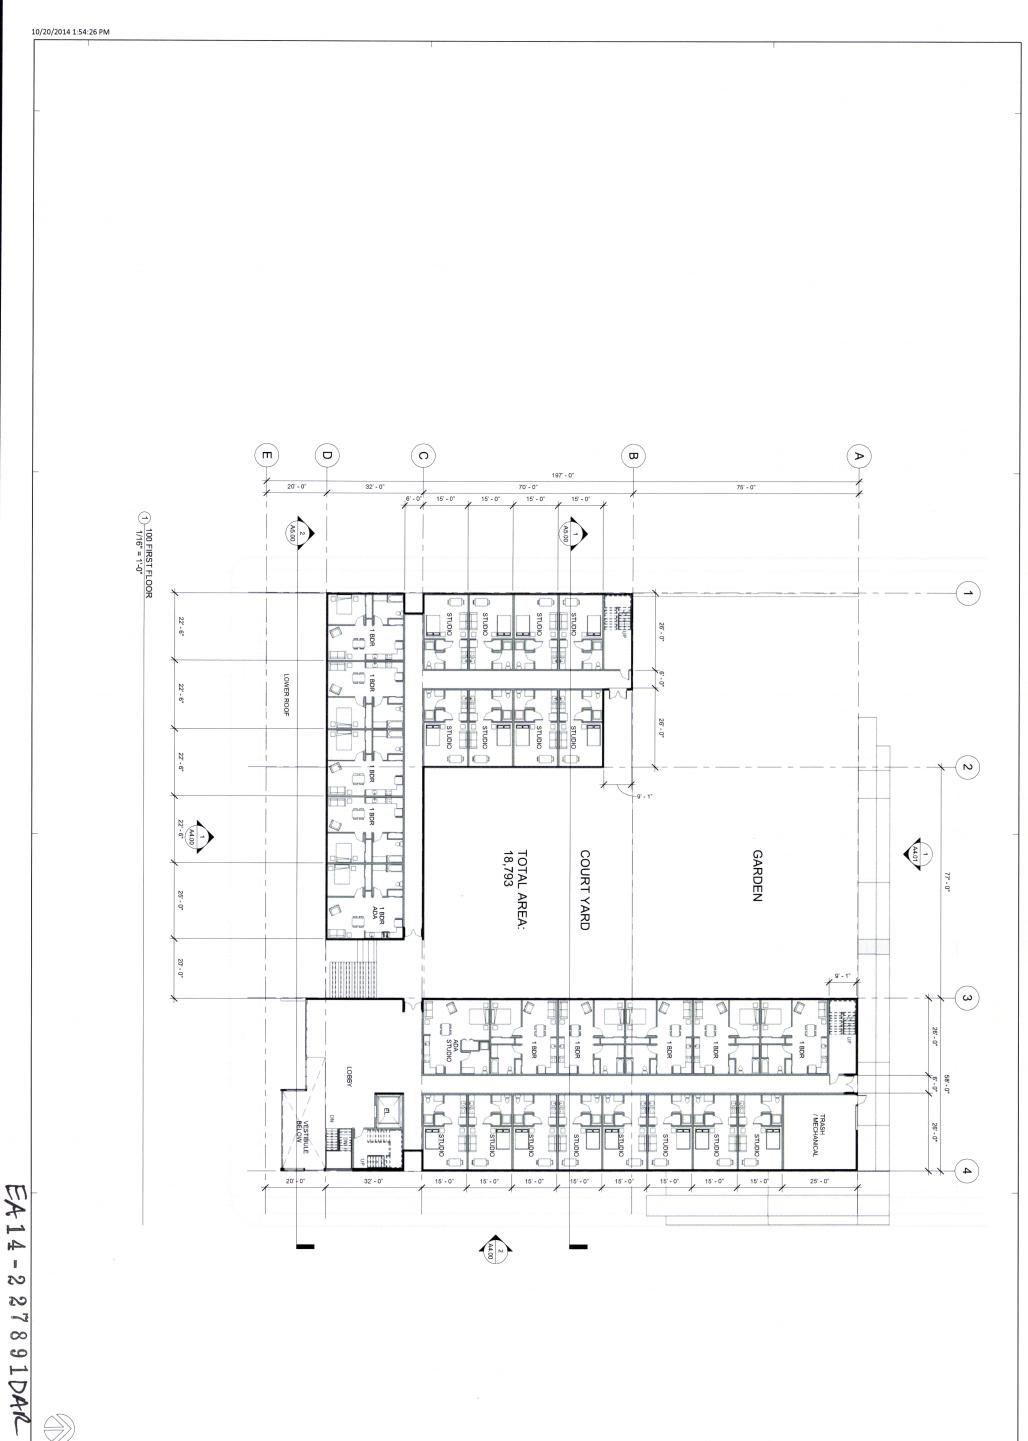

A2.01

1/16" = 1'-0"

PROJECT NUMBER

201414.00

FIRST FLOOR PLAN

DATE 10/20/2014


CONCEPTUAL DESIGN

ST. FRANCIS PARK APARTMENTS

1136 SE OAK STREET PORTLAND, OR 97214


PREIMINARY

mwa architects 70 NW COUCH STREET SUITE 401 PORTLAND, OR 97209 P 503 973 5151 F 503 973 5060 MWAARCHITECTS.COM

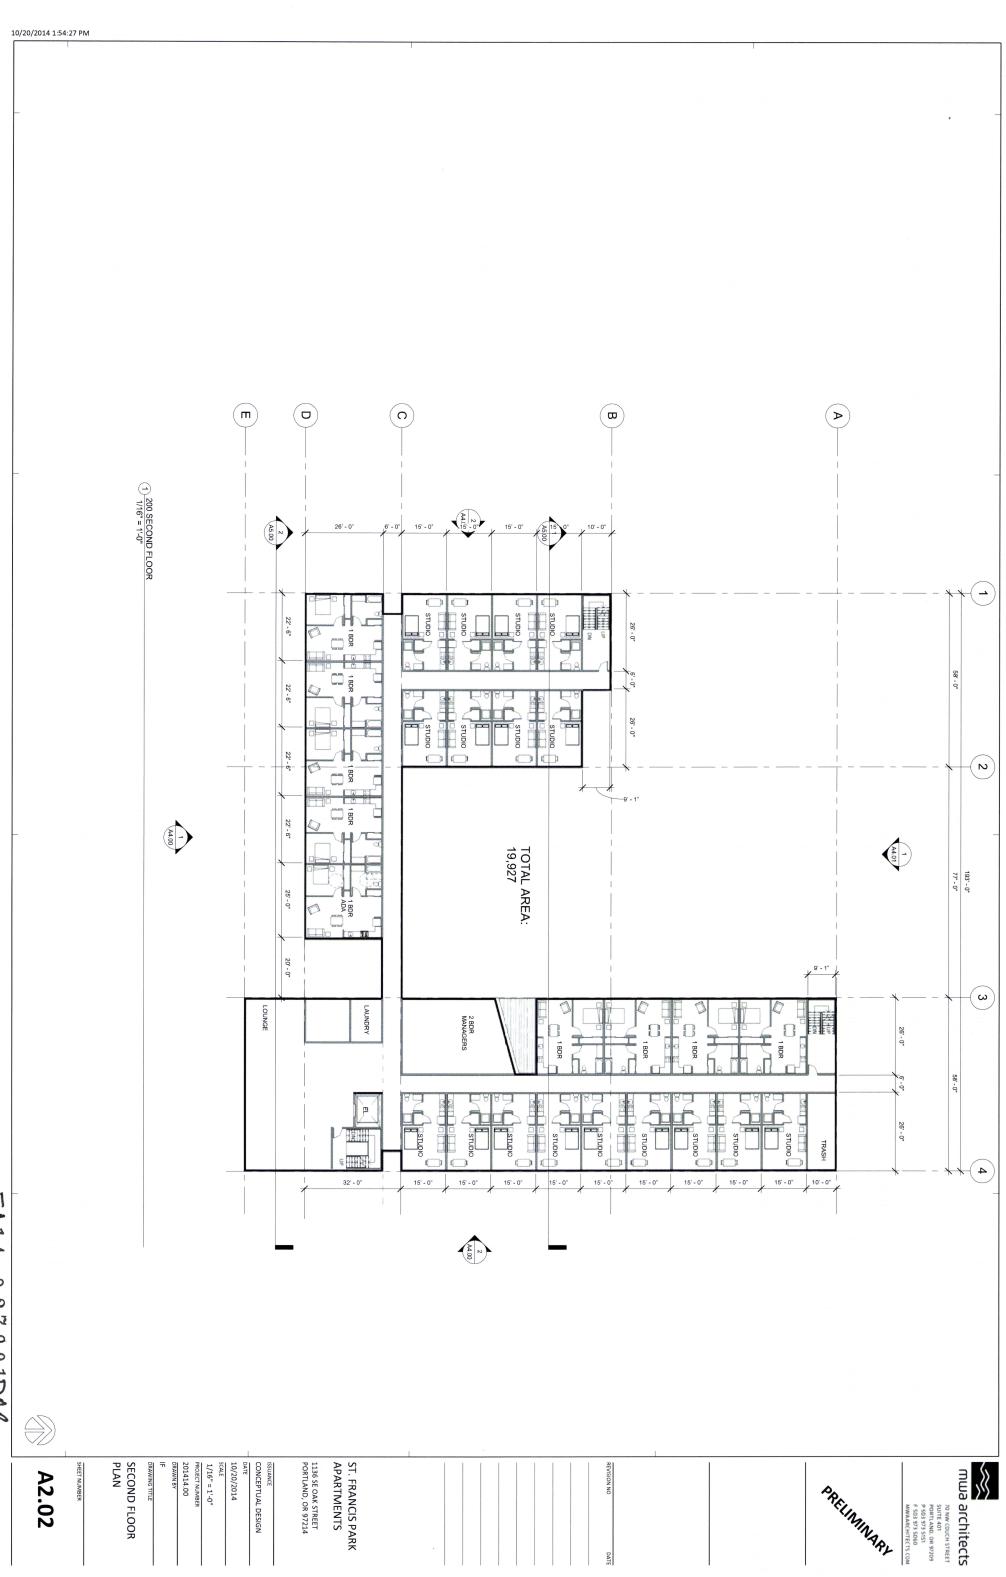


A2.02

PREIMINARY 70 NW COUCH STREET
SUITE 401
PORTLAND, OR 97209
P 503 973 5151
F 503 973 5060
NWAARCHITECTS.COM

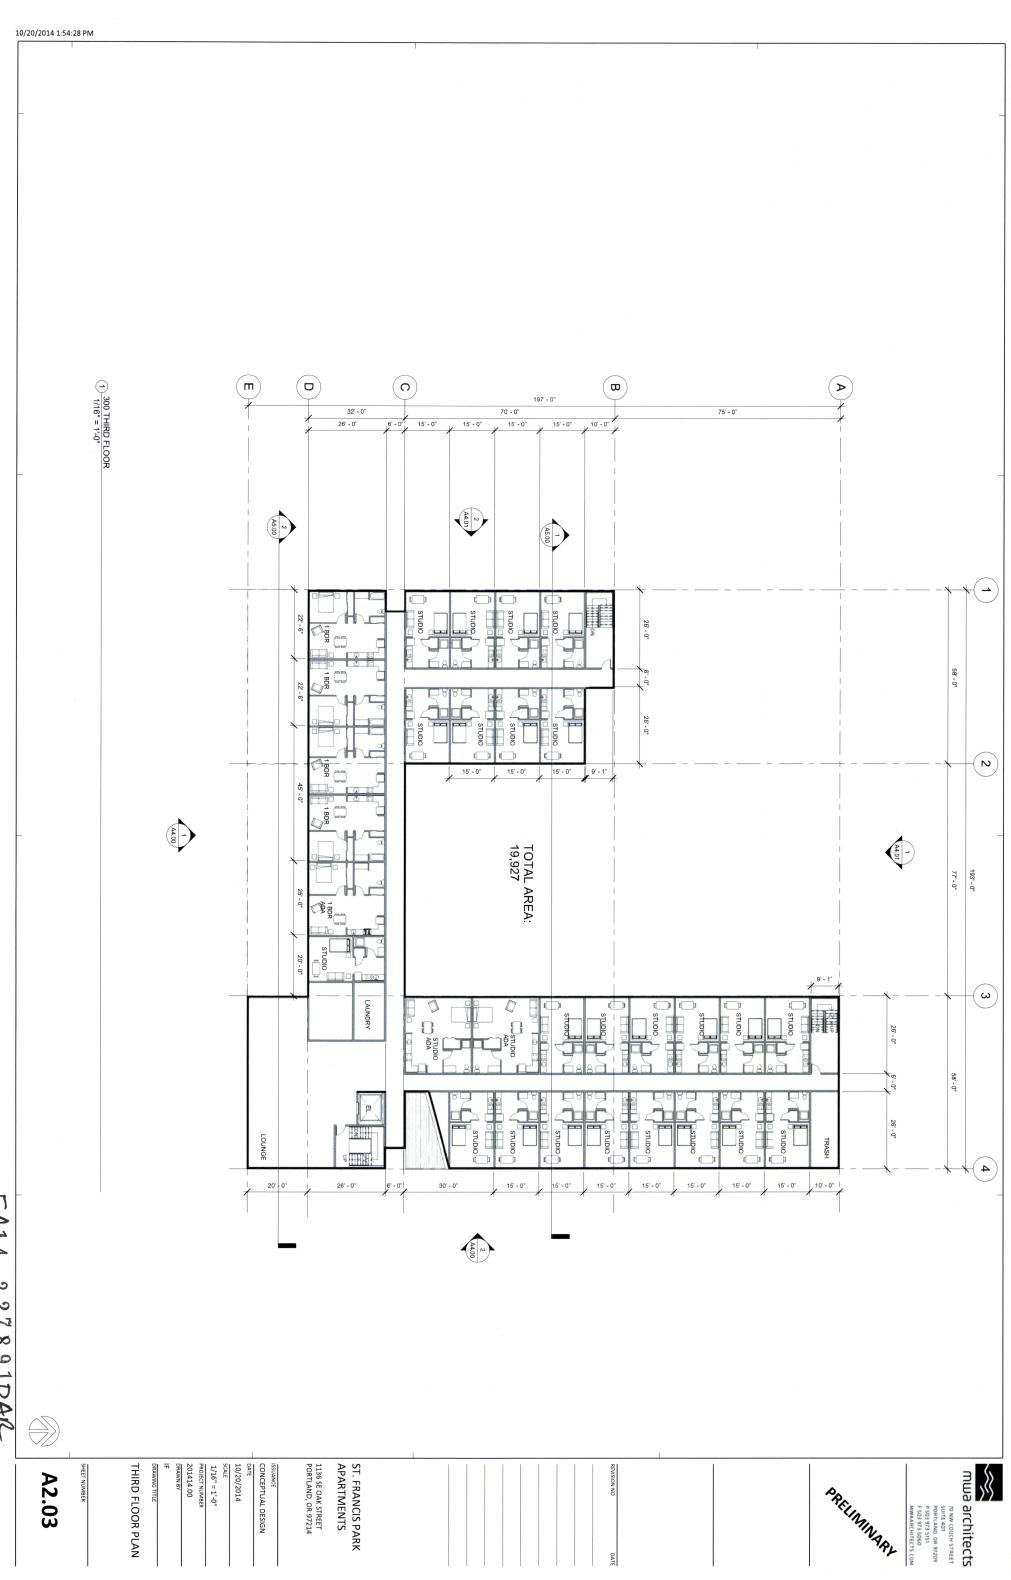


PREIMINARY. 70 NW COUCH STREET SUITE 401 PORTLAND, OR 97209 P 503 973 5151 F 503 973 5060 NWAARCHITECTS.COM

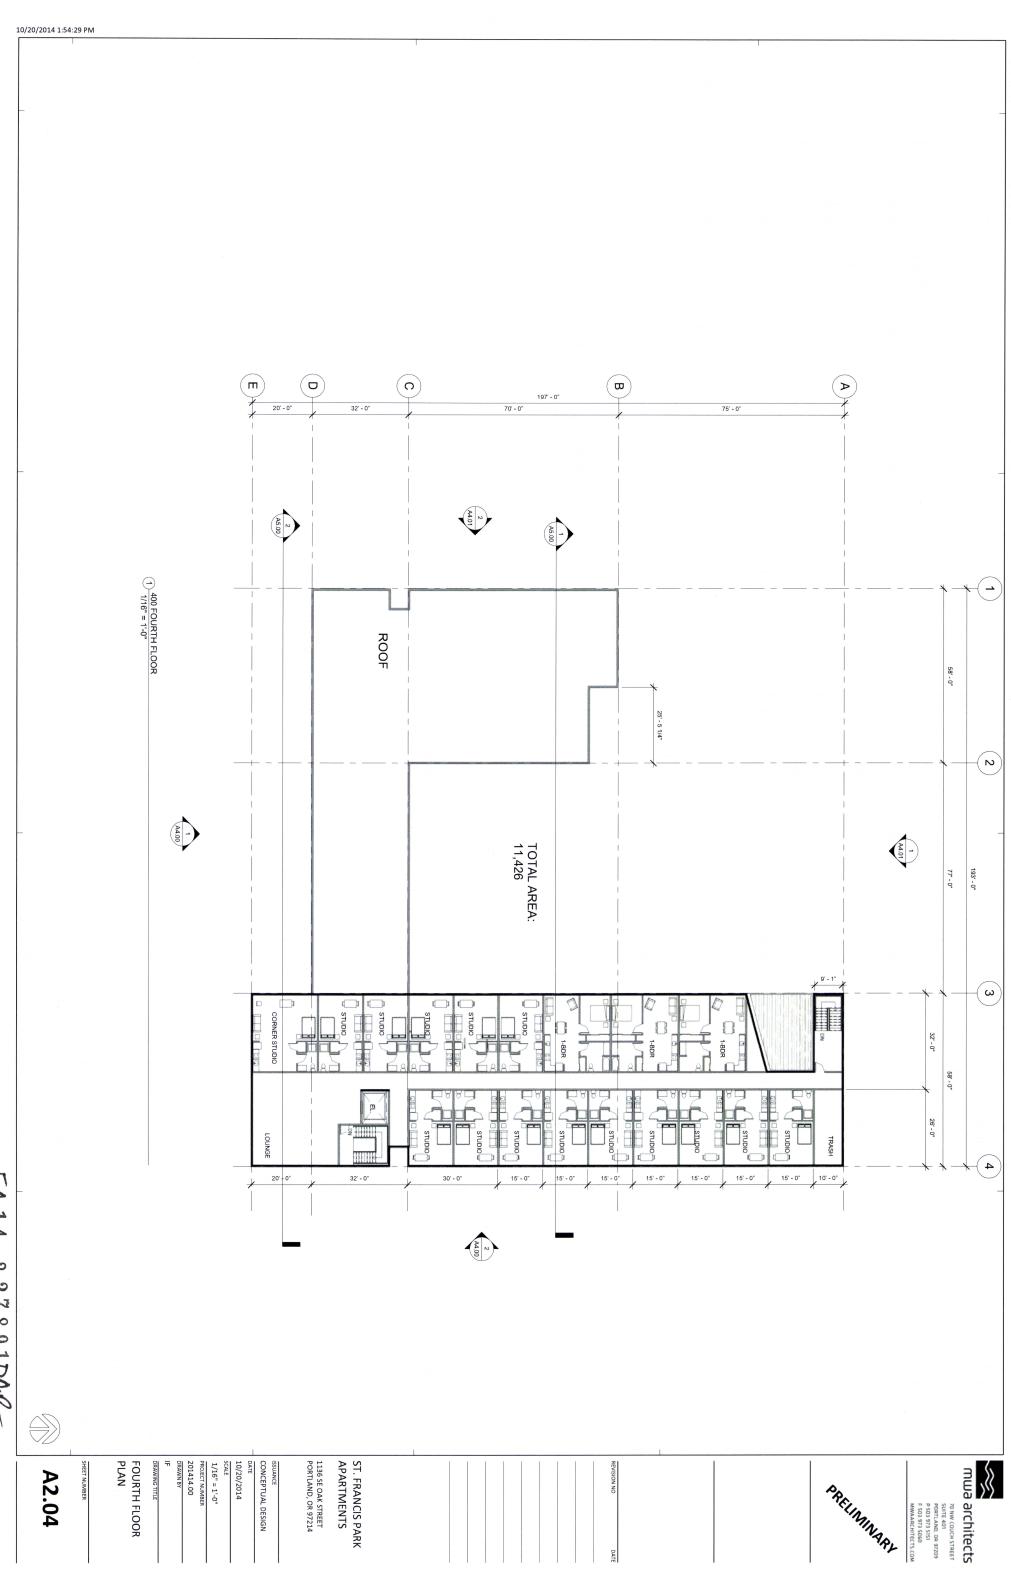


FF 14 -2 27891DAR


A2.04

70 NW COUCH STREET SUITE 401 PORTLAND, OR 97209 P 503 973 5151 F 503 973 5060 NWAARCHITECTS.COM

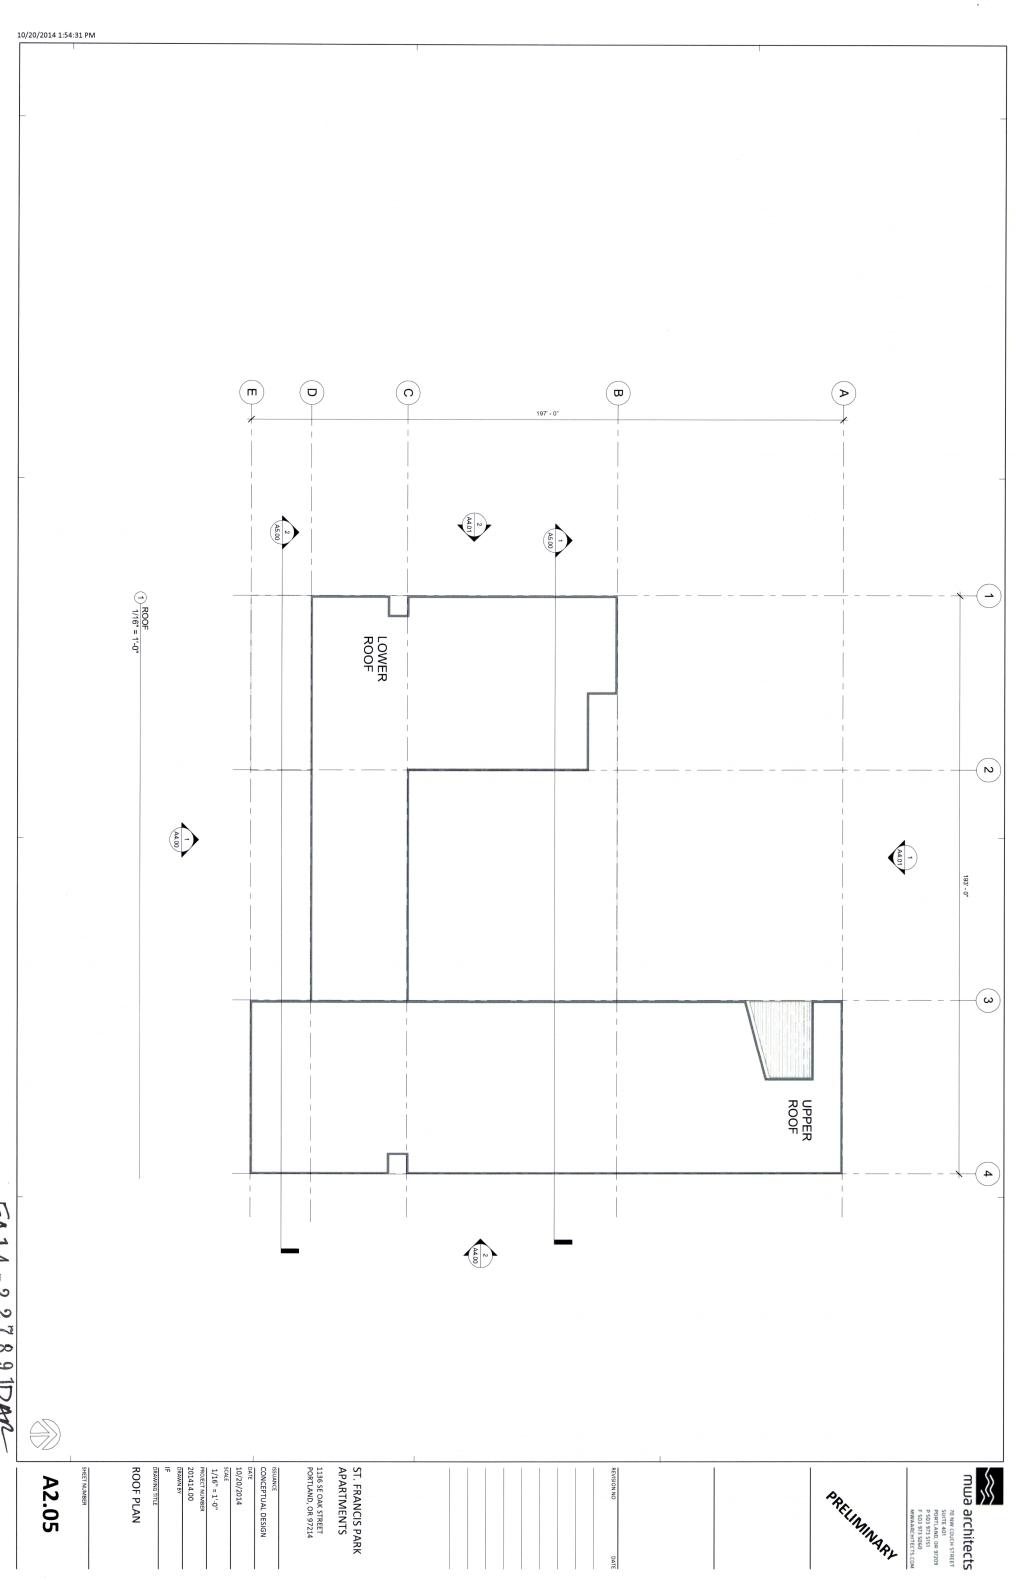

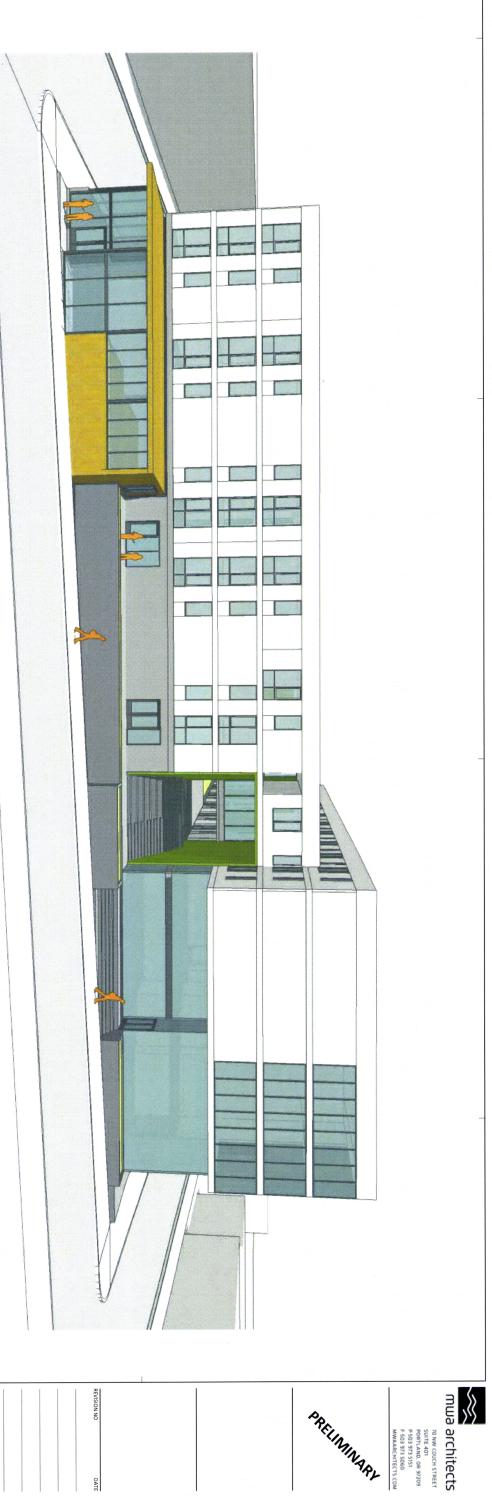

STARK STREET ELEVATION: NTS

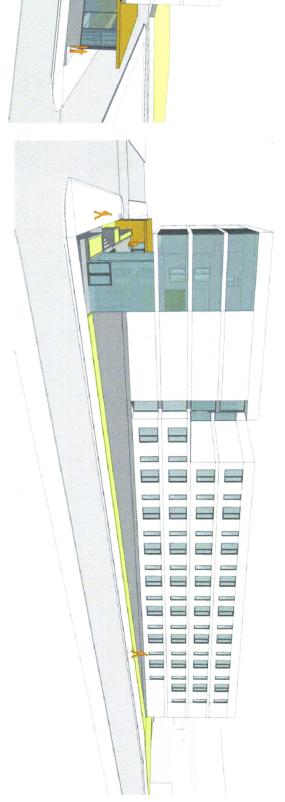

SE 11TH STREET ELEVATION: NTS

SE 12TH STREET ELEVATION: STN

ST. FRANCIS PARK APARTMENTS

1136 SE OAK STREET PORTLAND, OR 97214

CONCEPTUAL DESIGN

DATE 10/20/2014 PROJECT NUMBER
201414.00
DRAWN BY 1 1/2" = 1'-0"

ELEVATIONS

A4.00B

EA 14 -

8 N


7891DAR

PREIMINARY


70 NW COUCH STREET SUITE 401 PORTLAND, OR 97209 P 503 973 5151 F 503 973 5060 NWAARCHITECTS.COM




CORNER OF S.E. 11TH AND STARK ST.

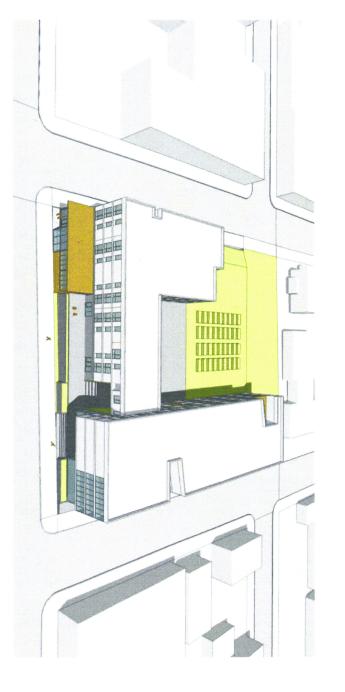

BIRDSEYE FROM S.E. STARK ST.

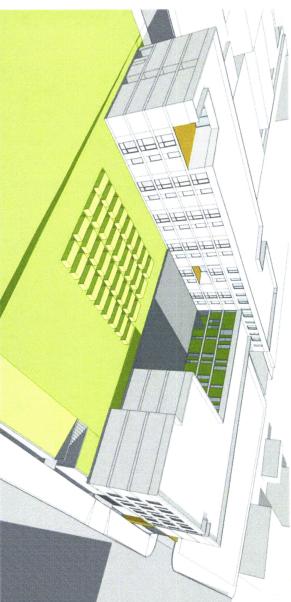

BIRDSEYE FROM S.E. 11TH AND OAK ST.

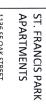

1136 SE OAK STREET PORTLAND, OR 97214

CONCEPTUAL DESIGN 1 1/2" = 1'-0"

PROJECT NUMBER

201414.00

DRAWN BY 10/20/2014

PERSPECTIVES

mwa architects PREI ININARY 70 NW COUCH STREET SUITE 401 PORTLAND, OR 97209 P 503 973 5151 F 503 973 5060 MWAARCHITECTS.COM

A4.00C

EA14-227891DAR

10/20/2014 1:54:34 PM 1) EW COURTYARD SECTION 3/32" = 1'-0" 2) EW PORCH SECTION 3/32" = 1'-0" SIDEWALK (-) (8) (N) ω 4 4 SIDEWALK 050 ENTRY FLOOR 9' - 0" 050 ENTRY FLOOR 9' - 0" 025 PARKING
6' - 0"
001 COMMUNITY
ROOM
0' - 0" 300 THIRD FLOOR 39' - 4" 025 PARKING
6" - 0"
001 COMMUNITY
ROOM
0" - 0" 300 THIRD FLOOR 39' - 4" 100 FIRST FLOOR 19' - 4" 100 FIRST FLOOR 19' - 4" 200 SECOND FLOOR 29' - 4" 400 FOURTH FLOOR 49' - 4" 200 SECOND FLOOR 29' - 4" 400 FOURTH FLOOR 49' - 4" ROOF 59' - 4" ROOF 59' - 4" 9 IDAR mwa architects ST. FRANCIS PARK APARTMENTS PROJECT NUMBER 201414.00 10/20/2014 SCALE 1136 SE OAK STREET PORTLAND, OR 97214 SECTIONS CONCEPTUAL DESIGN DRAWING TITLE 3/32" = 1'-0" PREIMINARY A5.00

70 NW COUCH STREET SUITE 401
SOUTE 401
PORTLAND, OR 97209
P 503 973 5151
F 503 973 5060
MWAARCHITECTS.COM

EX14-

2

N ~1 00




L1.00

PREIMINARY


mwa architects

70 ww.couchstreet
Suite 401
Portiano, 09 97209
P 503 973 5060
MWAARCHITECTS.COM

ST. FRANCIS PARK APARTMENTS CONCEPTUAL DESIGN 1136 SE OAK STREET PORTLAND, OR 97214

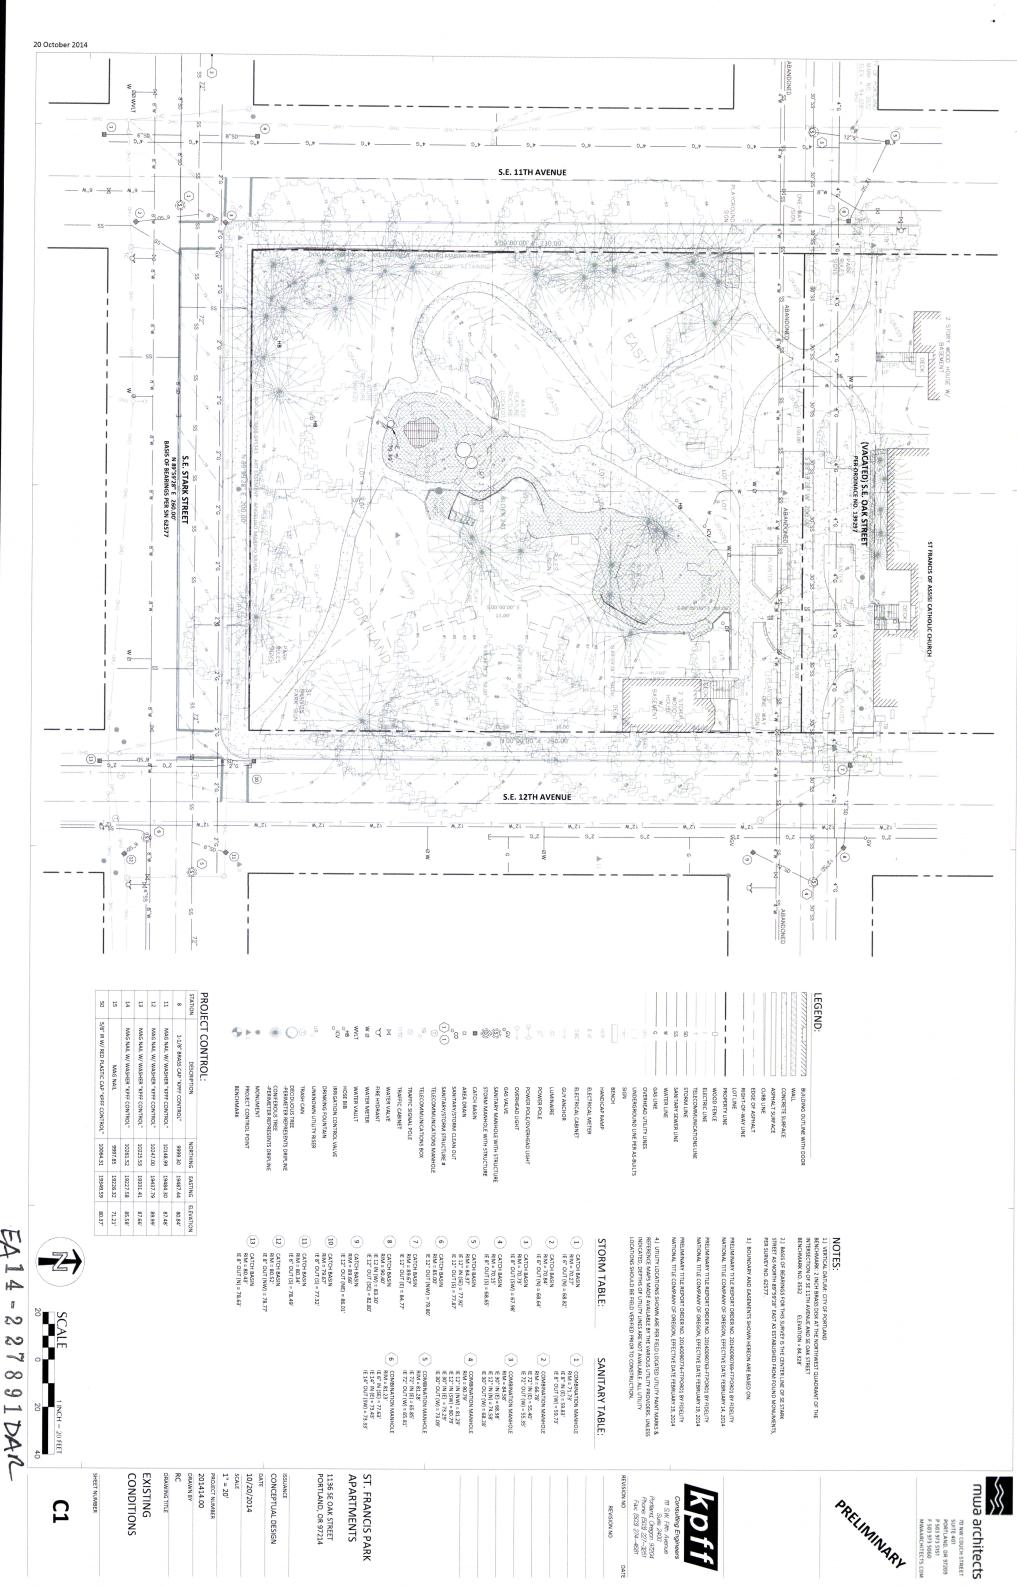

70 NW COUCH STREET SUITE 401 PORTLAND, OR 97209 P 503 973 5151 F 503 973 5050 MWAARCHITECTS.COM

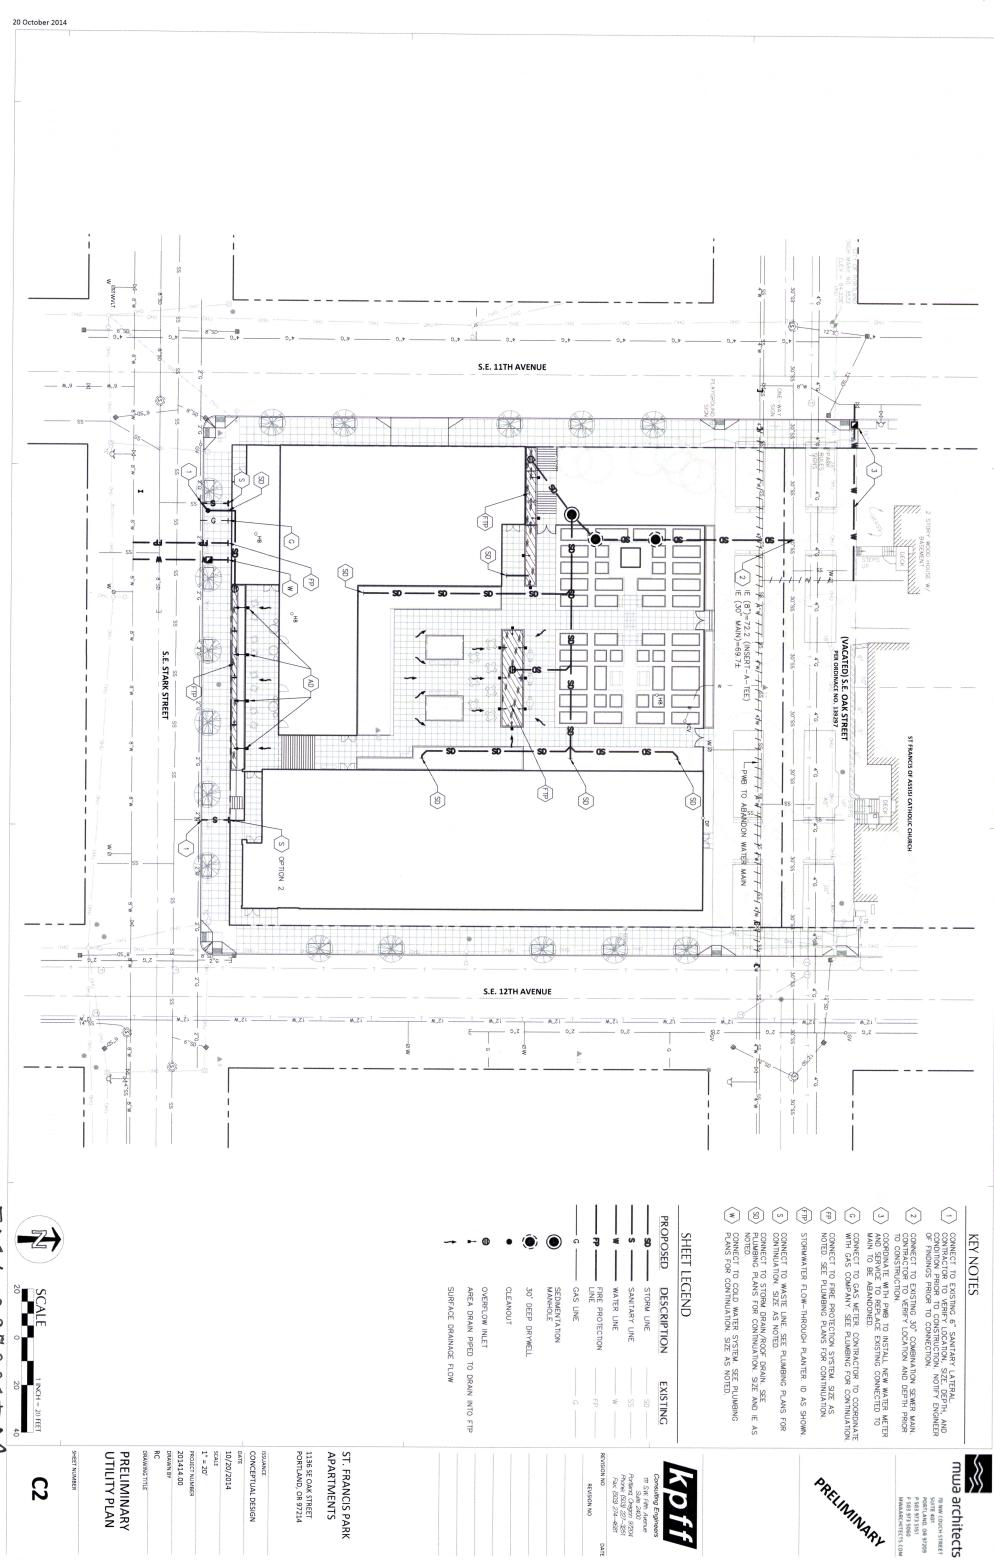

2

PRELIMINARY UTILITY PLAN

70 NW COUCH STREET SUITE 401 PORTLAND, OR 97209 P 503 973 5151 F 503 973 5060 MWAARCHITECTS.COM