Development Services

From Concept to Construction

Phone: 503-823-7300 Email: bds@portlandoregon.gov 1900 SW 4th Ave, Portland, OR 97201

More Contact Info (http://www.portlandoregon.gov//bds/article/519984)



APPEAL SUMMARY

Status: Decision Rendered - Held over from ID 28929 (6/22/22) for additional information

| Appeal ID: 27920 | Project Address: 3943 N Mississippi Ave |
|---|--|
| Hearing Date: 8/3/22 | Appellant Name: Nick Turrell |
| Case No. : B-004 | Appellant Phone: 971-267-0872 |
| Appeal Type: Building | Plans Examiner/Inspector: Robert Keal |
| Project Type: commercial | Stories: 2 Occupancy: A-2, S-2, R-3 Construction Type: V-B |
| Building/Business Name: | Fire Sprinklers: No |
| Appeal Involves: Addition to an existing structure, Reconsideration of appeal | LUR or Permit Application No.: |
| Plan Submitted Option: pdf [File 1] | Proposed use: Convenience Stair (Non egress) |

APPEAL INFORMATION SHEET

Appeal item 1

Code Section OSSC 705.2.2

Requires

Cornices, eave overhangs, exterior balconies and similar projections extending beyond the exterior wall shall conform to the requirements of this section and Section 1405. Exterior egress balconies and exterior exit stairways and ramps shall comply with Sections 1021 and 1027, respectively. Projections shall not extend any closer to the line used to determine the fire separation distance than shown in Table 705.2.

Table 705.2

Fire Separation Distance: 0'-2' - Projections not permitted.

Code Modification or Alternate Requested

This appeal is seeking to remove fire separation distance requirements to allow the construction of a convenience stair near a property line. Each of the properties separated by the property line are owned by the same owner and are operated jointly as a bar and a music venue with existing access between the 2 properties. The wall along the adjoining property is a 2-HR CMU wall with no penetrations.

Reconsideration Text: This appeal is seeking to reduce the fire separation distance requirements of 2' to the provided 1' to allow the construction of a convenience only (non egress) stair near a property line.

Proposed Design

The proposed exterior convenience stair is designed using heavy timber stringers and noncombustible steel grate treads and would attach to the existing Type VB building. The Owner will provide multiple sprinkler heads that provide coverage along the proposed stair. The sprinkler system for Mississippi Studios (property directly south) has a dry system that will extend from the 2-HR CMU wall. Both Mississippi Studio and Bar Bar are connected to the same fire

alarm system and triggering the alarm will audibly and visually alarm occupants in both venues should a fire be detected.

Reconsideration Text: The proposed exterior convenience stair will be built with a heavy timber structure, noncombustible steel grate treads, and noncombustible steel guardrails/handrails.

Reason for alternative Due to existing configuration of stairs, exits and structures, the only feasible location for this convenience stair is along the property line. Our understanding of the purpose of code section 705.2.2 is to minimize combustible fuel loading near property lines and to protect neighboring buildings from damage and increase life safety. The wall that the proposed stair is adjacent to is a 2-HR CMU bearing wall with no openings. In the event of a fire on either property, the lack of combustible material included in the proposed stair construction will limit the potential damage to both the stair itself and the neighboring property.

> Existing egress from the second level is provided by an internal stair that exits directly to the right of way (Mississippi Ave) and this stair will not be labeled as an exit. This stair is being proposed as a convenience stair so that loading and unloading can occur from the alley in the rear of the property.

> Reconsideration Text: Due to existing configuration of stairs, exits and structures, the only feasible location for this convenience stair is along the property line. Our understanding of the purpose of code section 705.2.2 is to minimize combustible fuel loading near property lines and to protect neighboring buildings from damage and increase fire safety. There are 3 mitigating factors that provide equivalent fire safety: First, the stair is not part of the egress path and is not required nor will be used for egress in the event of a fire. Second, the stair is built from heavy timber and non combustible materials. This will allow the stair to be resilient in the event of a fire as well as limit it's additional fuel loading to the surrounding structures. Third, the neighboring building is separated from the stair by it's 8" thick CMU wall with no openings.

APPEAL DECISION

Reduction in minimum required fire separation distance for projection of convenience stair from two feet to one foot: Granted as proposed.

Note: Sprinklers offered at stairs on original appeal are not required by this decision.


Appellant may contact John Butler (503 865-6427) or e-mail at John.Butler@portlandoregon.gov with questions.

The Administrative Appeal Board finds that the information submitted by the appellant demonstrates that the approved modifications or alternate methods are consistent with the intent of the code; do not lessen health, safety, accessibility, life, fire safety or structural requirements; and that special conditions unique to this project make strict application of those code sections impractical.

Pursuant to City Code Chapter 24.10, you may appeal this decision to the Building Code Board of Appeal within 90 calendar days of the date this decision is published. For information on the appeals process, go to www.portlandoregon.gov/bds/appealsinfo, call (503) 823-7300 or come in to the Development Services Center.

BAR BAR

CONVENIENCE STAIR RENOVATION

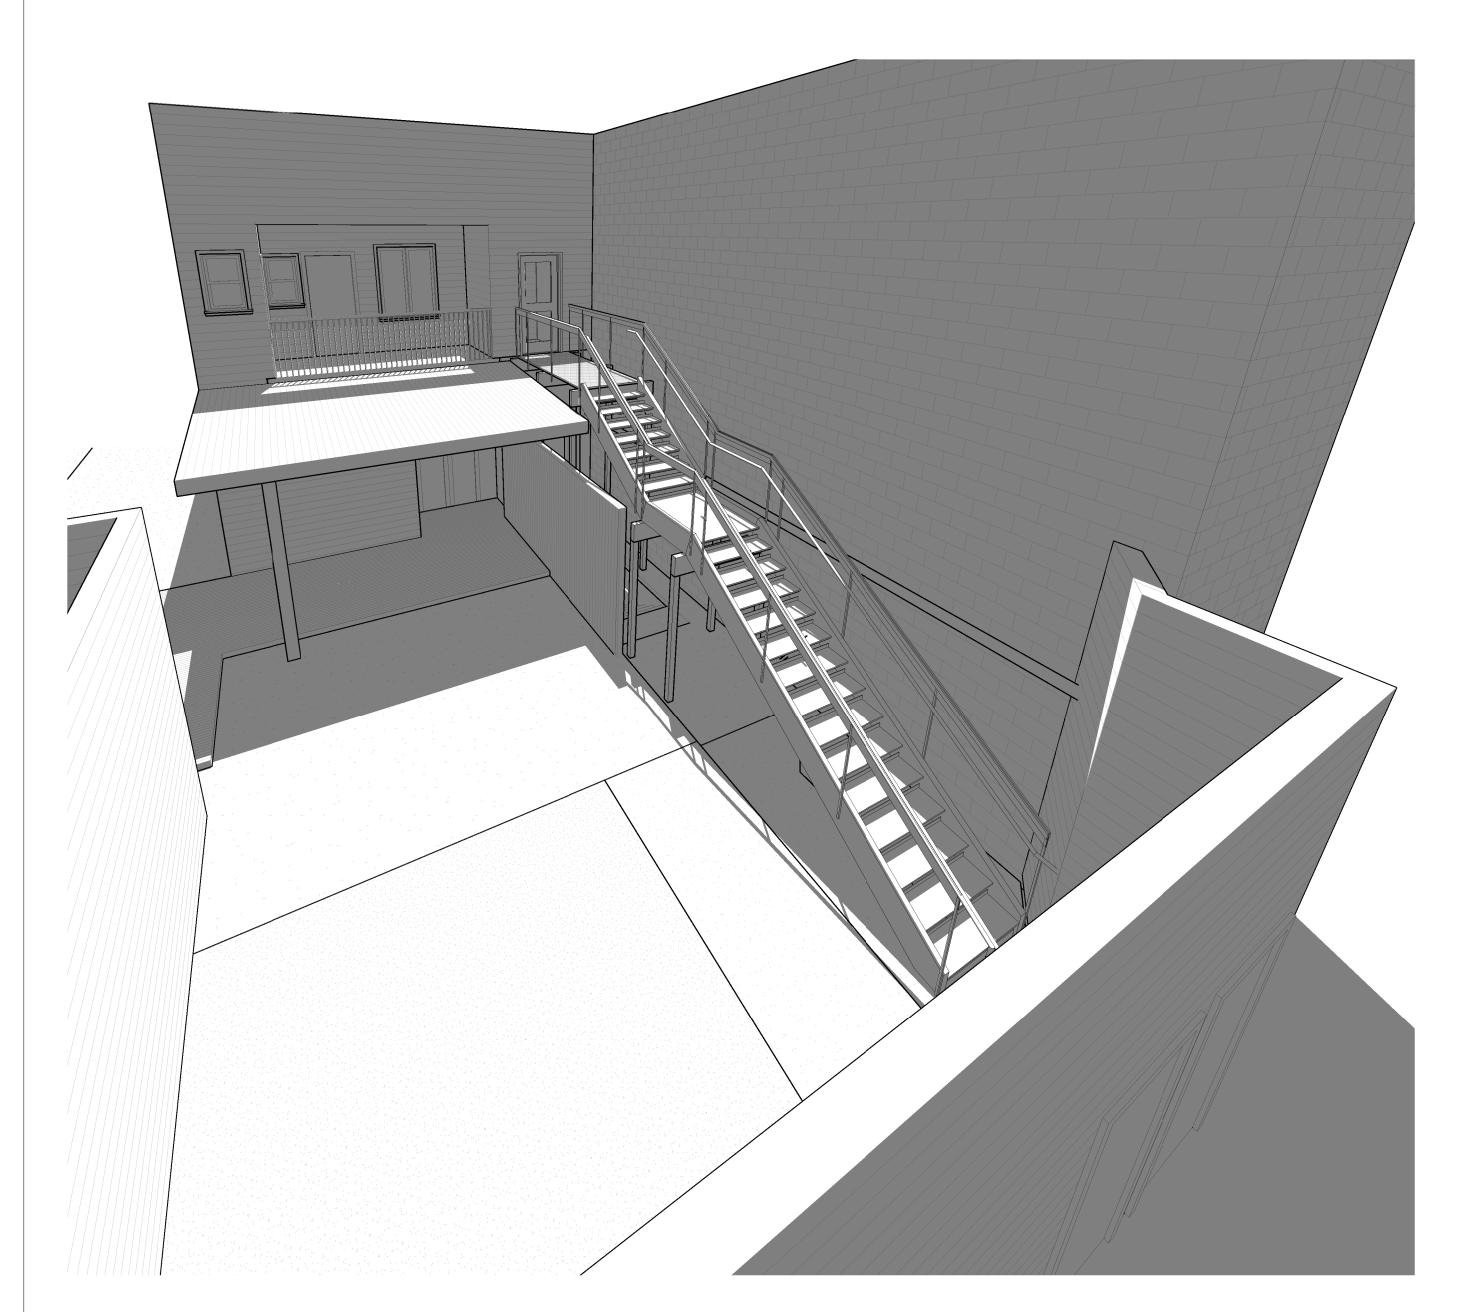

UNDER SEPARATE PERMIT

1. FIRE ALARM

CODE INFORMATION

- APPLICABLE CODE: OSSC 2019
- EXISTING BUILDING CONSTRUCTION TYPE: VB - EXISTING OCCUPANCY CLASSIFICATION: A2, S2, AND R3. PROJECT IMPACTS LEVEL 2 (R3
- OCCUPANCY) ONLY.
 BUILDING IS NON SPRINKLED. (N) CONVENIENCE STAIR TO BE PROTECTED BY SPRINKLERS FROM
- ADJACENT BUILDING SYSTEM (NFPA 13).

VICINITY MAP

LOCATION MAP



The Fresh Pot Bridgetown Beerhouse Beer state Mississippi Delta N Shaver St N

PROJECT TEAM

OWNER
URSA MINOR LLO

URSA MINOR, LLC

PORTLAND, OR 97227
CONTACT: KEVIN CRADOCK

CT: KEVIN CRADOCK 503.309.5313

STRUCTURAL ENGINEER
PCS STRUCTURAL SOLUTIONS

PCS STRUCTURAL SOLUTIONS

ADDRESS: 111 SW 5TH AVE #3210
PORTLAND, OR 97204

CONTACT: LUKE HEATH
PHONE: 503.416.2400

ARCHITECT

PROCESS DESIGN, LLC

PRESS: 240 N BROADWAY SUITE 201 PORTLAND OR, 97227 NTACT: JASON KARAM DNE: 775.846.4793

ABBREVIATIONS


| ACT | ACOUSTICAL CEILING TILE | IRGWB | IMPACT RESISTANT |
|-------|--|--------|-----------------------------|
| AD | AREA DRAIN | | GYPSUM WALL BOARD |
| AFF | ABOVE FINISHED FLOOR | IPNT | INTUMESCENT PAINT |
| ALT | ALTERNATE | INSUL | INSULATED |
| ALUM | ALUMINUM | INT | INTERIOR |
| ANOD | ANODIZED | MAX | MAXIMUM |
| BIM | BUILDING INFORMATION MODELING | MDF | MICRO DENSITY FIBERBOARD |
| BOT | BOTTOM | MO | MASONRY OPENING |
| CG | CORNER GUARD | MECH | |
| CIP | | | MECHANICAL |
| | CAST IN PLACE | MIN | MINIMUM |
| CJ | CONTROL JOINT | MISC | MISCELLANEOUS |
| CL | CENTER LINE | MRGWB | MOISTURE RESISTANT |
| CLG | CEILING | | GYPSUM WALL BOARD |
| CLR | CLEAR | MTL | METAL |
| CMU | CONCRETE MASONRY UNIT | NIC | NOT IN CONTRACT |
| COL | COLUMN | NIS | NOT IN SCOPE |
| CONC | CONCRETE | NOM | NOMINAL |
| CONT | CONTINUOUS | NTS | NOT TO SCALE |
| CPT | CARPET | OC | ON CENTER |
| CT | CERAMIC TILE | OFCI | OWNER FURNISHED, CONTRACTOR |
| CW | COLD WATER | | INSTALLED |
| DEMO | DEMOLITION OR DEMOLISH | OFOI | OWNER FURNISHED, OWNER |
| DF | DRINKING FOUNTAIN | | INSTALLED |
| DIA | DIAMETER | ОН | OVERHEAD |
| DIM | DIMENSION | OSB | ORIENTED STRAND BOARD |
| DN | DOWN | OPP | OPPOSITE |
| DR | DOOR | PL | PROPERTY LINE |
| DS | DOWNSPOUT | PLAM | PLASTIC LAMINATE |
| DWG | DRAWING | PLUMB | PLUMBING |
| EA | EACH | PT | PRESSURE TREATED |
| EIFS | EXTERIOR INSULATED FINISH SYSTEM | PNT | PAINT |
| EJ | EXPANSION JOINT | PVC | POLYVINYL CHLORIDE |
| EL | ELEVATION | R | RISER |
| ELEC | ELECTRICAL OR ELECTRIC | RB | RUBBER BASE |
| ELEV | | RBR | |
| | | | RUBBER |
| EPDM | ETHYLENE PROPYLENE DIENE M-CLASS (ROOFING) | RCP | REFLECTED CEILING PLAN |
| EQ | EQUAL | RD | ROOF DRAIN |
| EXIST | EXISTING | REQD | REQUIRED |
| EXT | EXTERIOR | RO | ROUGH OPENING |
| FD | FLOOR DRAIN | SIM | SIMILAR |
| FEC | FIRE EXTINGUISHER CABINET | SD | SMOKE DETECTOR |
| FF | FINISHED FLOOR OR FINISHED FACE | SPEC | SPECIFICATION OR SPECIFIED |
| FFL | FINISHED FLOOR LEVEL | SSTL | STAINLESS STEEL |
| FLR | FLOOR | STC | SOUND TRANSMISSION CLASS |
| FO | FACE OF | STL | STEEL |
| FRT | FIRE RESISTANT TREATED | STRUCT | STRUCTURAL OR STRUCTURE |
| GA | GAUGE | T | TREAD |
| GALV | GALVANIZED | T&G | TOUNGE AND GROOVE |
| GL | GLAZING | TO | TOP OF |
| GWB | GYPSUM WALL BOARD | TOC | TOP OF CONCRETE |
| HC | HOLLOW CORE | TOS | TOP OF STEEL |
| HM | HOLLOW METAL | TYP | TYPICAL |
| HR | HOUR | UNO | UNLESS NOTED OTHERWISE |
| HW | HOT WATER | VCT | VINYL COMPOSITION TILE |
| HVAC | HEATING, VENTILATION AND AIR CONDITIONING | VIF | VERIFY IN FIELD |
| IIVAC | HEATING, VENTICATION AND AIR CONDITIONING | W/ | WITH |
| | | WD | WOOD |
| | | | |
| | | WR | WATER RESISTANT |
| | | WSP | WOOD STRUCTURAL PANEL |
| | | WWM | WOVEN WIRE MESH |


WOVEN WIRE MESH


SCOPE OF WORK


SCOPE OF WORK INCLUDES ADDITION OF WOOD CONVENIENCE STAIR (NON-EGRESS STAIR) AND ENTRANCE TO UPPER LEVEL OF 2 STORY EXISTING BUILDING.

DRAWING SYMBOL LEGEND

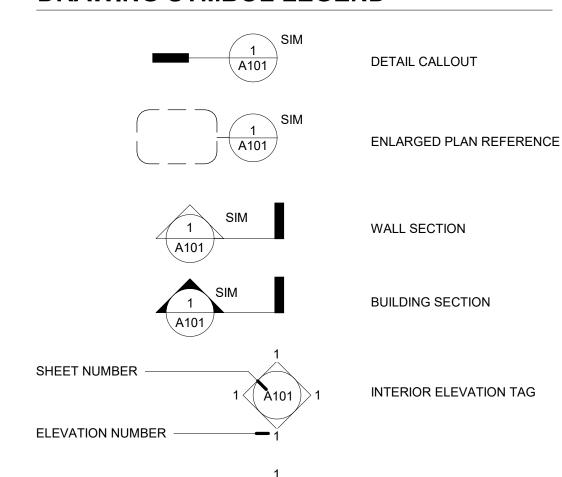

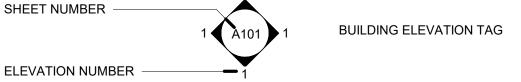

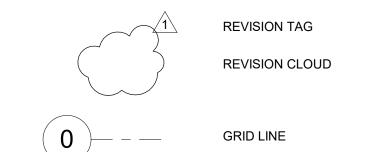

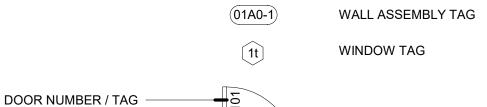



INDICATES TRUE NORTH NORTH ARROW

Name Elevation LEVEL

WALL

WALL OR ELEMENT TO REMAIN

| PROJECT SHEET INDEX | | |
|---------------------|-----------------------------------|--|
| SHEET NUMBER | SHEET NAME | |
| A0.00 | COVER SHEET | |
| A0.10 | ACCESSIBILITY DETAILS | |
| A2.00 | EXISTING & DEMOLITION PLANS | |
| A2.01 | FLOOR PLANS | |
| A3.00 | STAIR SECTIONS | |
| A8.01 | DETAILS | |
| A8.02 | PREVIOUS APPEALS - REFERENCE ONLY | |

S1.01 GENERAL NOTES

S2.01 FLOOR PLAN

DOCUMENTS

PERMIT

DIOCESS ARCHITECTURE DESIGN

504 NE BRAZEE PORTLAND, OR 97212 WWW.PROCESS-PDX.COM 775.846.4793

DESCRIPTION

DATE

6/9/22

7/26/22

REVISIONS

REV 01

2 APPEAL #27829

AR BAR CONVENIENCE

3943 N Mississippi Ave Portland, OR 97227

PORTLANT, OR ARI-13:45


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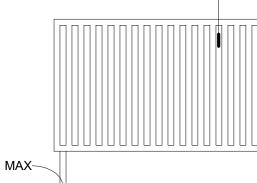
ISSUE DATE: 1/20/2022
PROJECT NO: 21024
DRAWN BY: NT

COVER SHEET

A0.00

303 CHANGES IN LEVEL LONG DIRECTION PERPEDICULAR TO TRAVEL 1 2




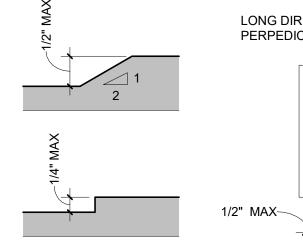

SURFACE

OPENINGS IN WALKING


304 TURNING SPACE

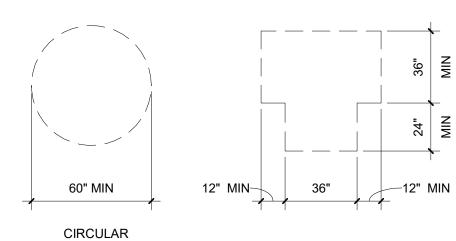

NOTE

CHANGES IN LEVEL ARE NOT PERMITTED WITHIN TURNING SPACE WITH THE EXCEPTION OF SLOPES NOT STEEPER THAN 1:48 (2%) TURNING SPACES SHALL BE PERMITTED TO INCLUDE KNEE AND TOE CLEARANCES COMPLYING WITH SECTION 306. UNLESS SPECIFIED, DOORS SHALL BE PERMITTED TO SWING INTO TURNING SPACES.


305 CLEAR FLOOR SPACE

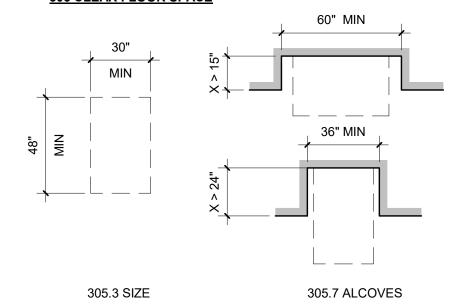

<u>NOTE</u> •

CLEAR FLOOR SPACES SHALL BE PERMITTED TO INCLUDE KNEE AND TOE CLEARANCES COMPLYING WITH SECTION 306.
UNLESS SPECIFIED, DOORS SHALL BE PERMITTED TO SWING INTO TURNING SPACES.

307 PROTRUDING OBJECTS

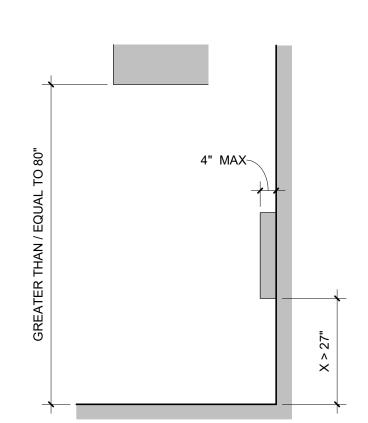


NOTE


SLOPING PORTIONS OF HANDRAILS BETWEEN TOP AND BOTTOM RISERS OF STAIRS AND RAMPS SHALL ARE EXEMPT FROM 307.3


A 27" TALL RAIL OR BARRIER SHALL BE PROVIDED AT THE LOCATION WHERE VERTICAL CLEARANCE IS LESS THAN 80"

309 MOUNTING HEIGHTS

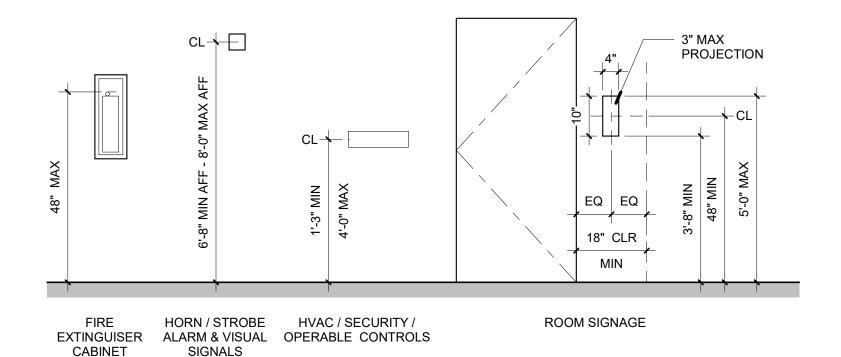



404 DOORS AND DOORWAYS

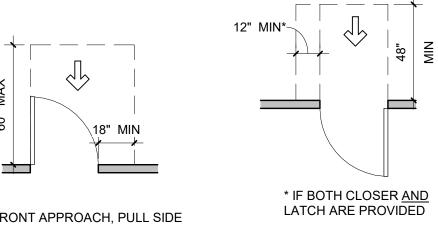


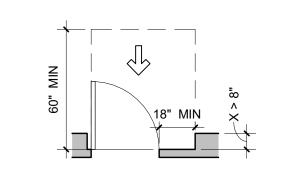



RECESSED DOOR, PULL SIDE

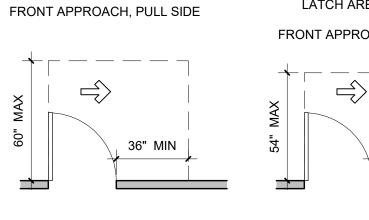

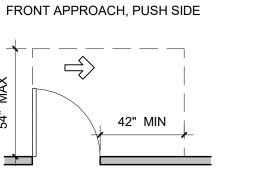

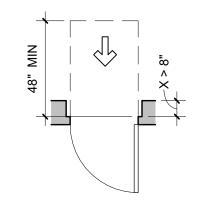

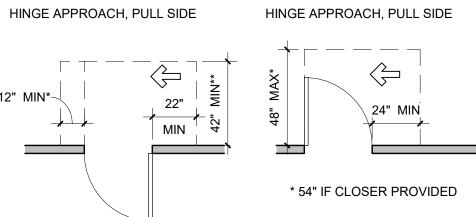

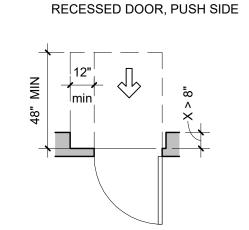


* IF BOTH CLOSER <u>AND</u> LATCH ARE PROVIDED ** 48" MIN IF BOTH CLOSER AND LATCH PROVIDED

HINGE APPROACH, PUSH SIDE

LATCH APPROACH, PULL SIDE

RECESSED DOOR, PUSH SIDE

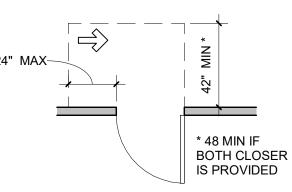

LATCH APPROACH, PUSH SIDE

DI'OCESS ARCHITECTURE DESIGN

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DESCRIPTION

DATE

BAR CONVENIENCE

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1/20/2022

21024

ISSUE DATE:
PROJECT NO:
DRAWN BY:

ACCESSIBILITY

A0_10

DETAILS

GENERAL NOTES - DEMOLITION PLAN

NO CORES, HOLES, OR CUTS IN ANY STRUCTURAL ELEMENTS TO REMAIN ARE ALLOWED.

PREPARE SURFACES EXPOSED DURING DEMOLITION FOR

FINISHES, CONSISTENT WITH ADJACENT SURFACES.

PROTECT ALL EXISTING WINDOWS, UON.

PROTECT EXISTING WORK TO REMAIN. COORDINATE OPENINGS SHOWN WITH FLOOR PLANS, SECTIONS AND ELEVATIONS FOR SIZE AND LOCATION.

REFER TO DETAILS OF NEW WORK WHERE EDGES OF DEMOLITION ARE FINISHED OR CONNECT TO NEW WORK.

PROVIDE ALL MEASURES NECESSARY TO PROTECT ADJACENT SPACES FROM DUST AND/OR NOISE. REFER TO SPECIFICATIONS FOR CONSTRUCTION OF TEMPORARY BARRIERS. WHERE WALLS ARE SHOWN DEMOLISHED, TRIM, ELECTRICAL AND OTHER UTILITIES SHALL BE INCLUDED IN DEMOLITION. TERMINATE

RECONNECTION. MAINTAIN EXIT PATHS, LIGHTS, HVAC, ETC. DURING DEMOLITION FOR ALL OCCUPIED PORTIONS OF THE BUILDING.

UTILITIES AT AN ACCESSIBLE LOCATION TO ENABLE FUTURE

DOOR TO BE DEMOLISHED

WALL / ELEMENT TO BE DEMOLISHED, UNO

WALL / ELEMENT TO REMAIN

EXISTING AREA TO REMAIN

REVISIONS

DATE DESCRIPTION

1 REV 01 6/9/22 2 APPEAL #27829 7/26/22

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775.846.4793

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NC CONVENIE

BAR BAR STAIR
3943 N Mississippi Ave Portland, OR 97227




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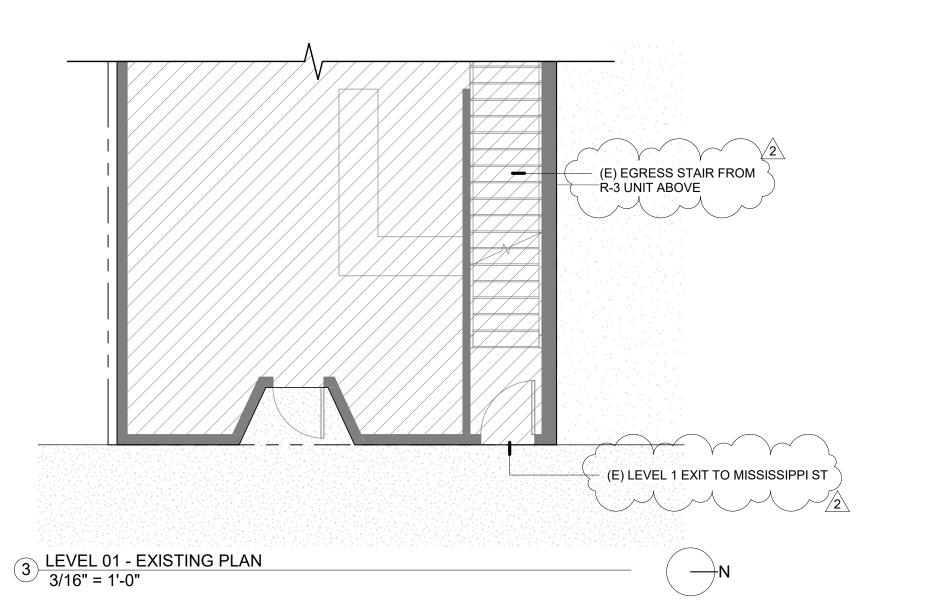
EXISTING & DEMOLITION PLANS


PERMIT DOCUMENTS

A2.00



2 DEMO ELEVATION 1/4" = 1'-0"

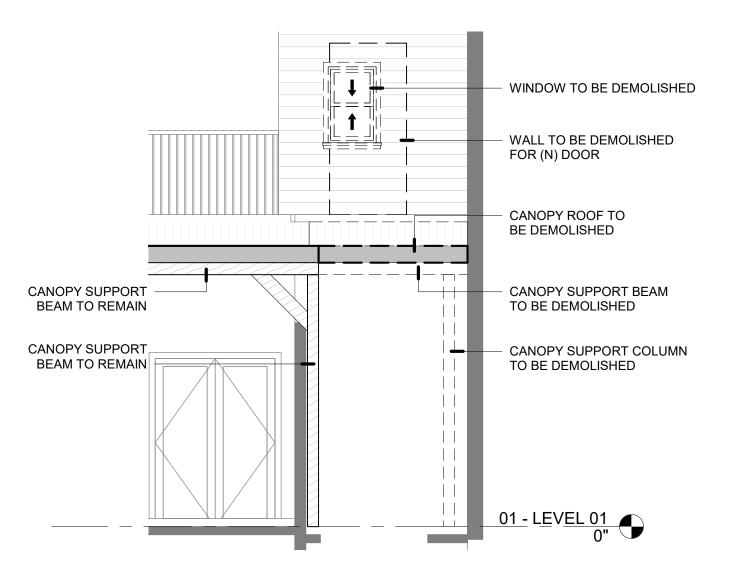

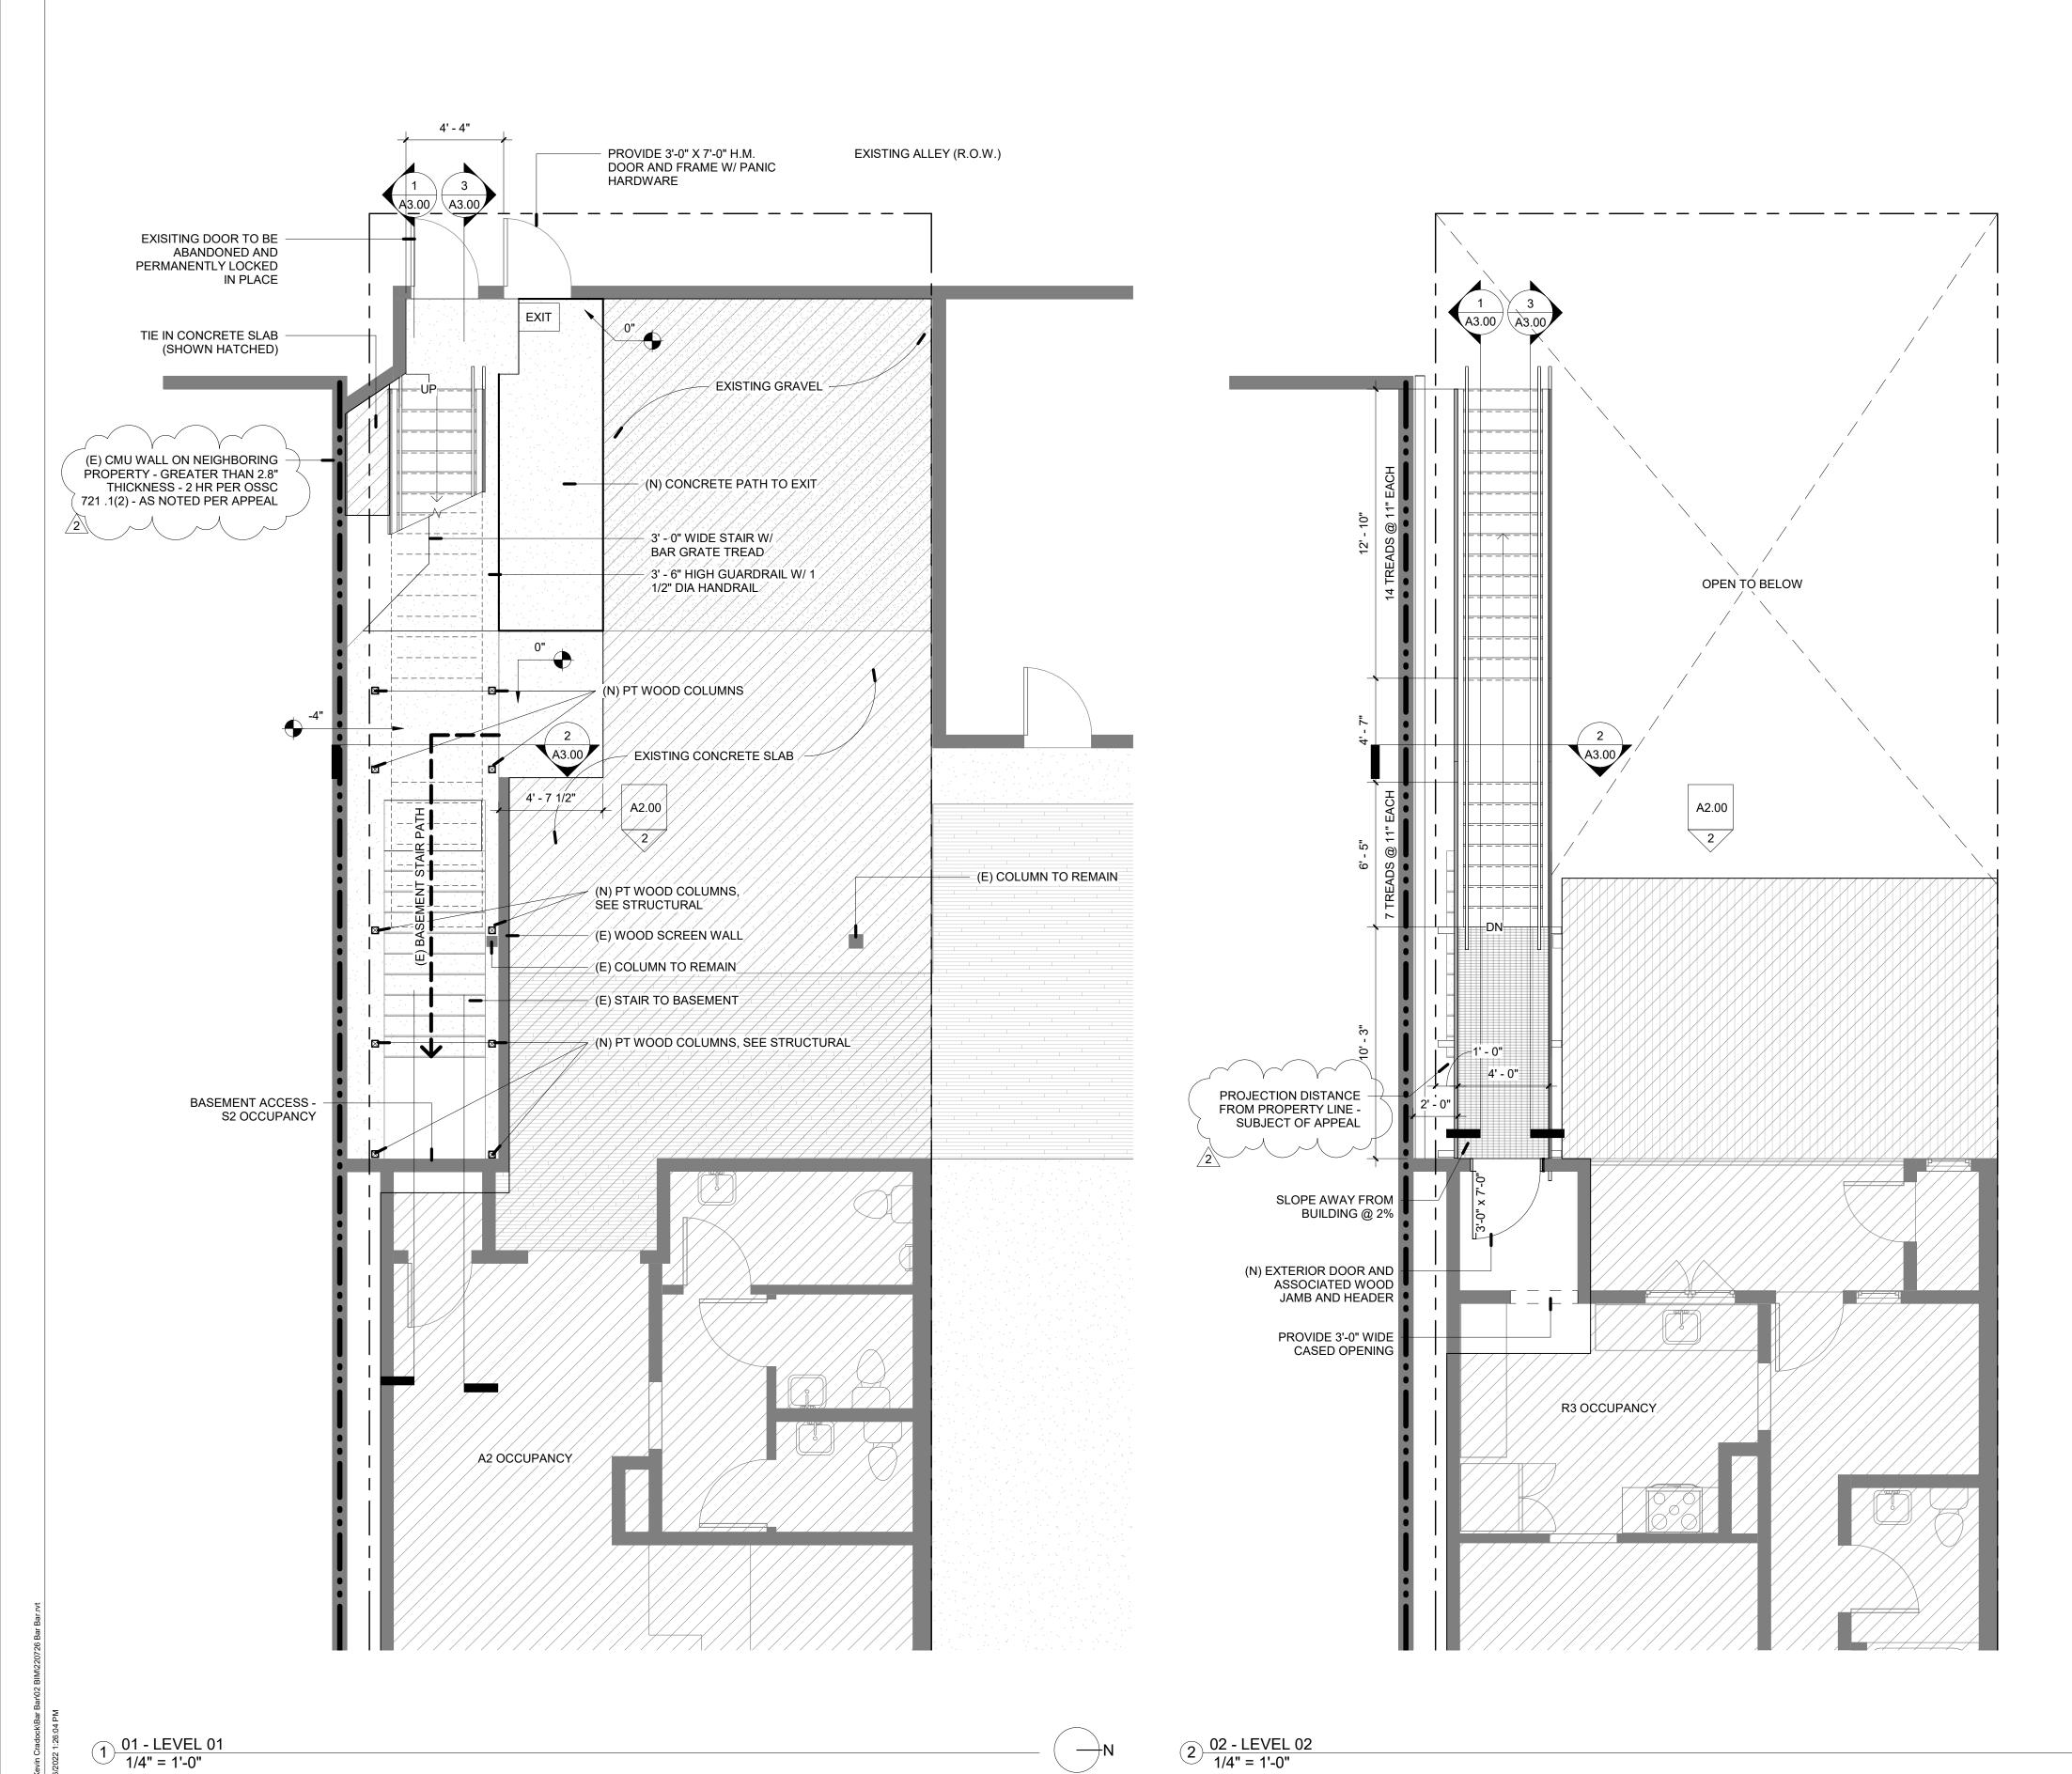

GENERAL NOTES - FLOOR PLANS

1. ALL DIMENSIONS AND GRIDS ARE TO FACE OF STUD OR FACE, FACE OF CMU, FACE OF CONCRETE, OR CENTERLINE OF WINDOW/DOOR, UNO.

2. DOOR ARE TO BE OFFSET 3" FROM PERPENDICULAR WALLS, UNO. 3. EXISTING CONDITIONS TO BE VERIFIED BY CONTRACTOR IN FIELD.

4. IF HARZARDOUS MATERIALS SUCH AS LEAD OR ASBESTOS ARE UNCOVERED, CONTRACTOR TO IMMEDIATLY HALT ALL WORK AND NOTIFY OWNER'S REPRESENATIVE.

5. ALL WORK SHALL CONFORM TO 2019 OREGON STRUCTURAL SPECIALTY CODE (OSSC) AND ALL APPLICABLE LOCAL JURISDICTION RULES AND REGULATIONS.

6. EXISTING EGRESS COMPONENTS WILL REMAIN UNCHANGED. STAIR IS NOT PART OF THE MEANS OF EGRESS PER OSSC CHAPTER 10 AND THUS SHALL

BE SUBJECT TO CHAPTER 10. 7. STAIR SHALL MEET THE FOLLOWING:

A. SHALL BE 4 INCHES (100 MM) MINIMUM AND 7 INCHES (180 MM) MAXIMUM IN HEIGHT. TREADS SHALL BE 11 INCHES (280 MM) MINIMUM

B. STAIR TREADS SHALL COMPLY WITH SECTION 302 AND SHALL HAVE A SLOPE NOT STEEPER THAN 1:48.

C. THE RADIUS OF CURVATURE AT THE LEADING EDGE OF THE TREAD SHALL BE 1/2 INCH (13 MM) MAXIMUM. NOSINGS THAT PROJECT BEYOND RISERS SHALL HAVE THE UNDERSIDE OF THE LEADING EDGE CURVED OR BEVELED. RISERS SHALL BE PERMITTED TO SLOPE UNDER THE TREAD AT AN ANGLE OF 30 DEGREES MAXIMUM FROM VERTICAL. THE PERMITTED PROJECTION OF THE NOSING SHALL BE 11/2 INCHES (38 MM) MAXIMUM OVER THE TREAD OR FLOOR BELOW.

D. THE LEADING 2 INCHES (51 MM) OF THE TREAD SHALL HAVE VISUAL CONTRAST OF DARKON-LIGHT OR LIGHT-ON-DARK FROM THE REMAINDER OF THE TREAD.

E. LIGHTING PROVIDED SHALL BE CAPABLE OF PROVIDING 10 FOOT-CANDLES (108 LUX) OF ILLUMINANCE MEASURED AT THE CENTER OF TREAD SURFACES AND ON LANDING SURFACES WITHIN 24 INCHES (610 MM) OF STEP NOSINGS.

8. HANDRÁILS SHALL MEET THE FOLLOWING:

A. HANDRAILS WITH A CIRCULAR CROSS SECTION SHALL HAVE AN OUTSIDE DIAMETER OF 11/4 INCHES (32 MM) MINIMUM AND 2 INCHES (51 MM) MAXIMUM.

B. HANDRAILS, AND ANY WALL OR OTHER SURFACES ADJACENT TO THEM, SHALL BE FREE OF ANY SHARP OR ABRASIVE ELEMENTS. EDGES SHALL BE ROUNDED.

C. AT THE TOP OF A STAIR FLIGHT, HANDRAILS SHALL EXTEND HORIZONTALLY ABOVE THE LANDING FOR 12 INCHES (305 MM) MINIMUM BEGINNING DIRECTLY ABOVE THE LANDING NOSING. EXTENSIONS SHALL RETURN TO A WALL, GUARD, OR THE LANDING SURFACE, OR SHALL BE CONTINUOUS TO THE HANDRAIL OF AN ADJACENT STAIR

D. AT THE BOTTOM OF A STAIR FLIGHT, HANDRAILS SHALL EXTEND AT THE SLOPE OF THE STAIR FLIGHT FOR A HORIZONTAL DISTANCE EQUAL TO ONE TREAD DEPTH BEYOND THE BOTTOM TREAD NOSING. EXTENSIONS SHALL RETURN TO A WALL, GUARD, OR THE LANDING SURFACE, OR SHALL BE CONTINUOUS TO THE HANDRAIL OF AN ADJACENT STAIR FLIGHT.



EXISTING BUILDING NOT IN SCOPE

─ • • **─** 2 HR WALL

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REVISIONS

REV 01

2 APPEAL #27829

DESCRIPTION

DATE

6/9/22


7/26/22


ISSUE DATE: 1/20/2022 PROJECT NO: DRAWN BY:


21024

FLOOR PLANS

DOCUMENTS PERMIT

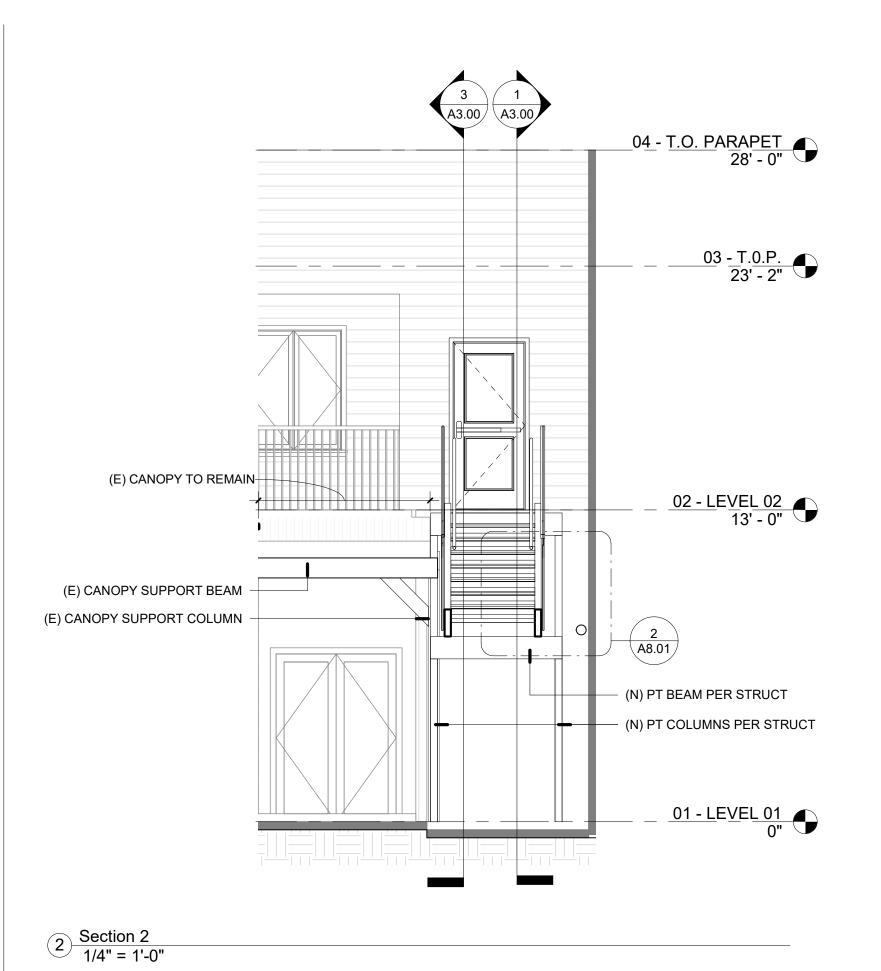

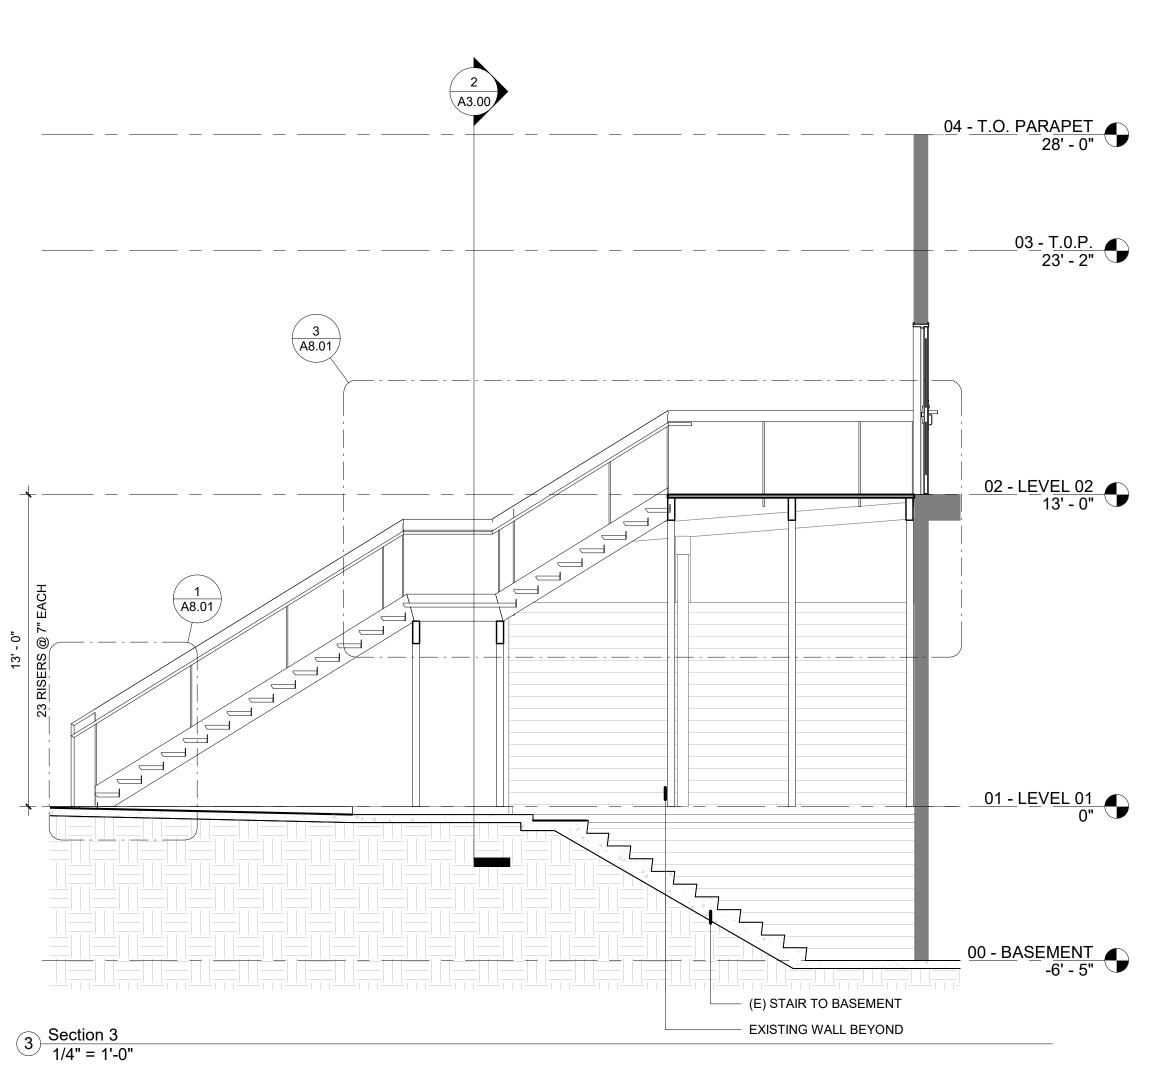

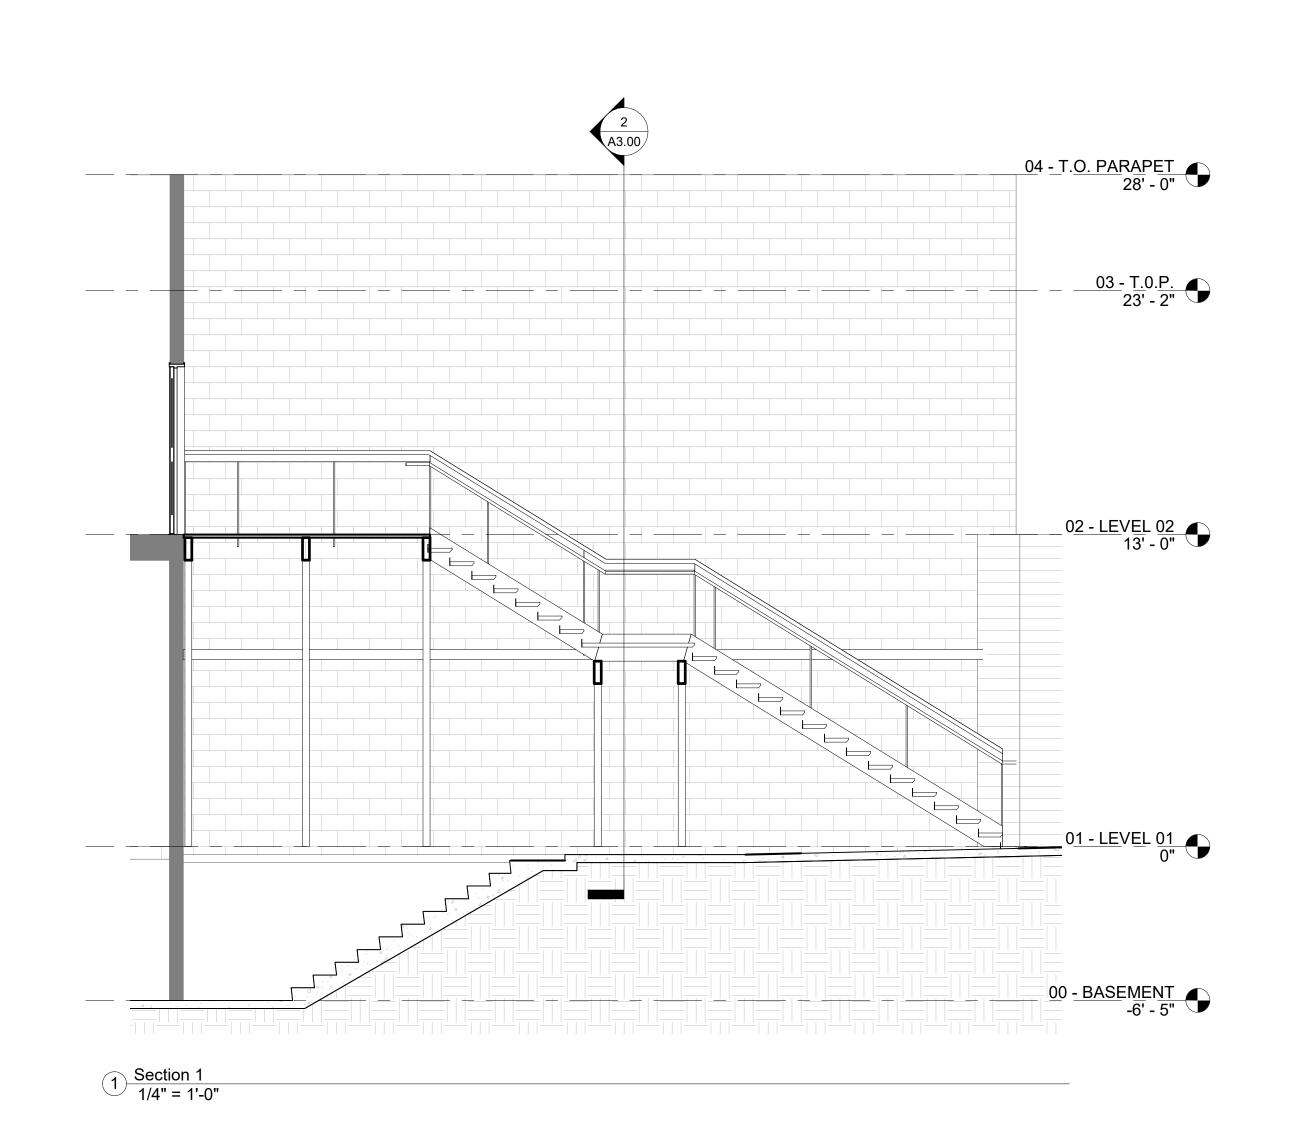

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REVISIONS

DESCRIPTION DATE 1 REV 01

6/9/22


BAR BAR CONVENIENCE
STAIR
3943 N Mississippi Ave
Portland, OR 97227

1/20/2022

STAIR SECTIONS

A3.00

PERMIT DOCUMENTS

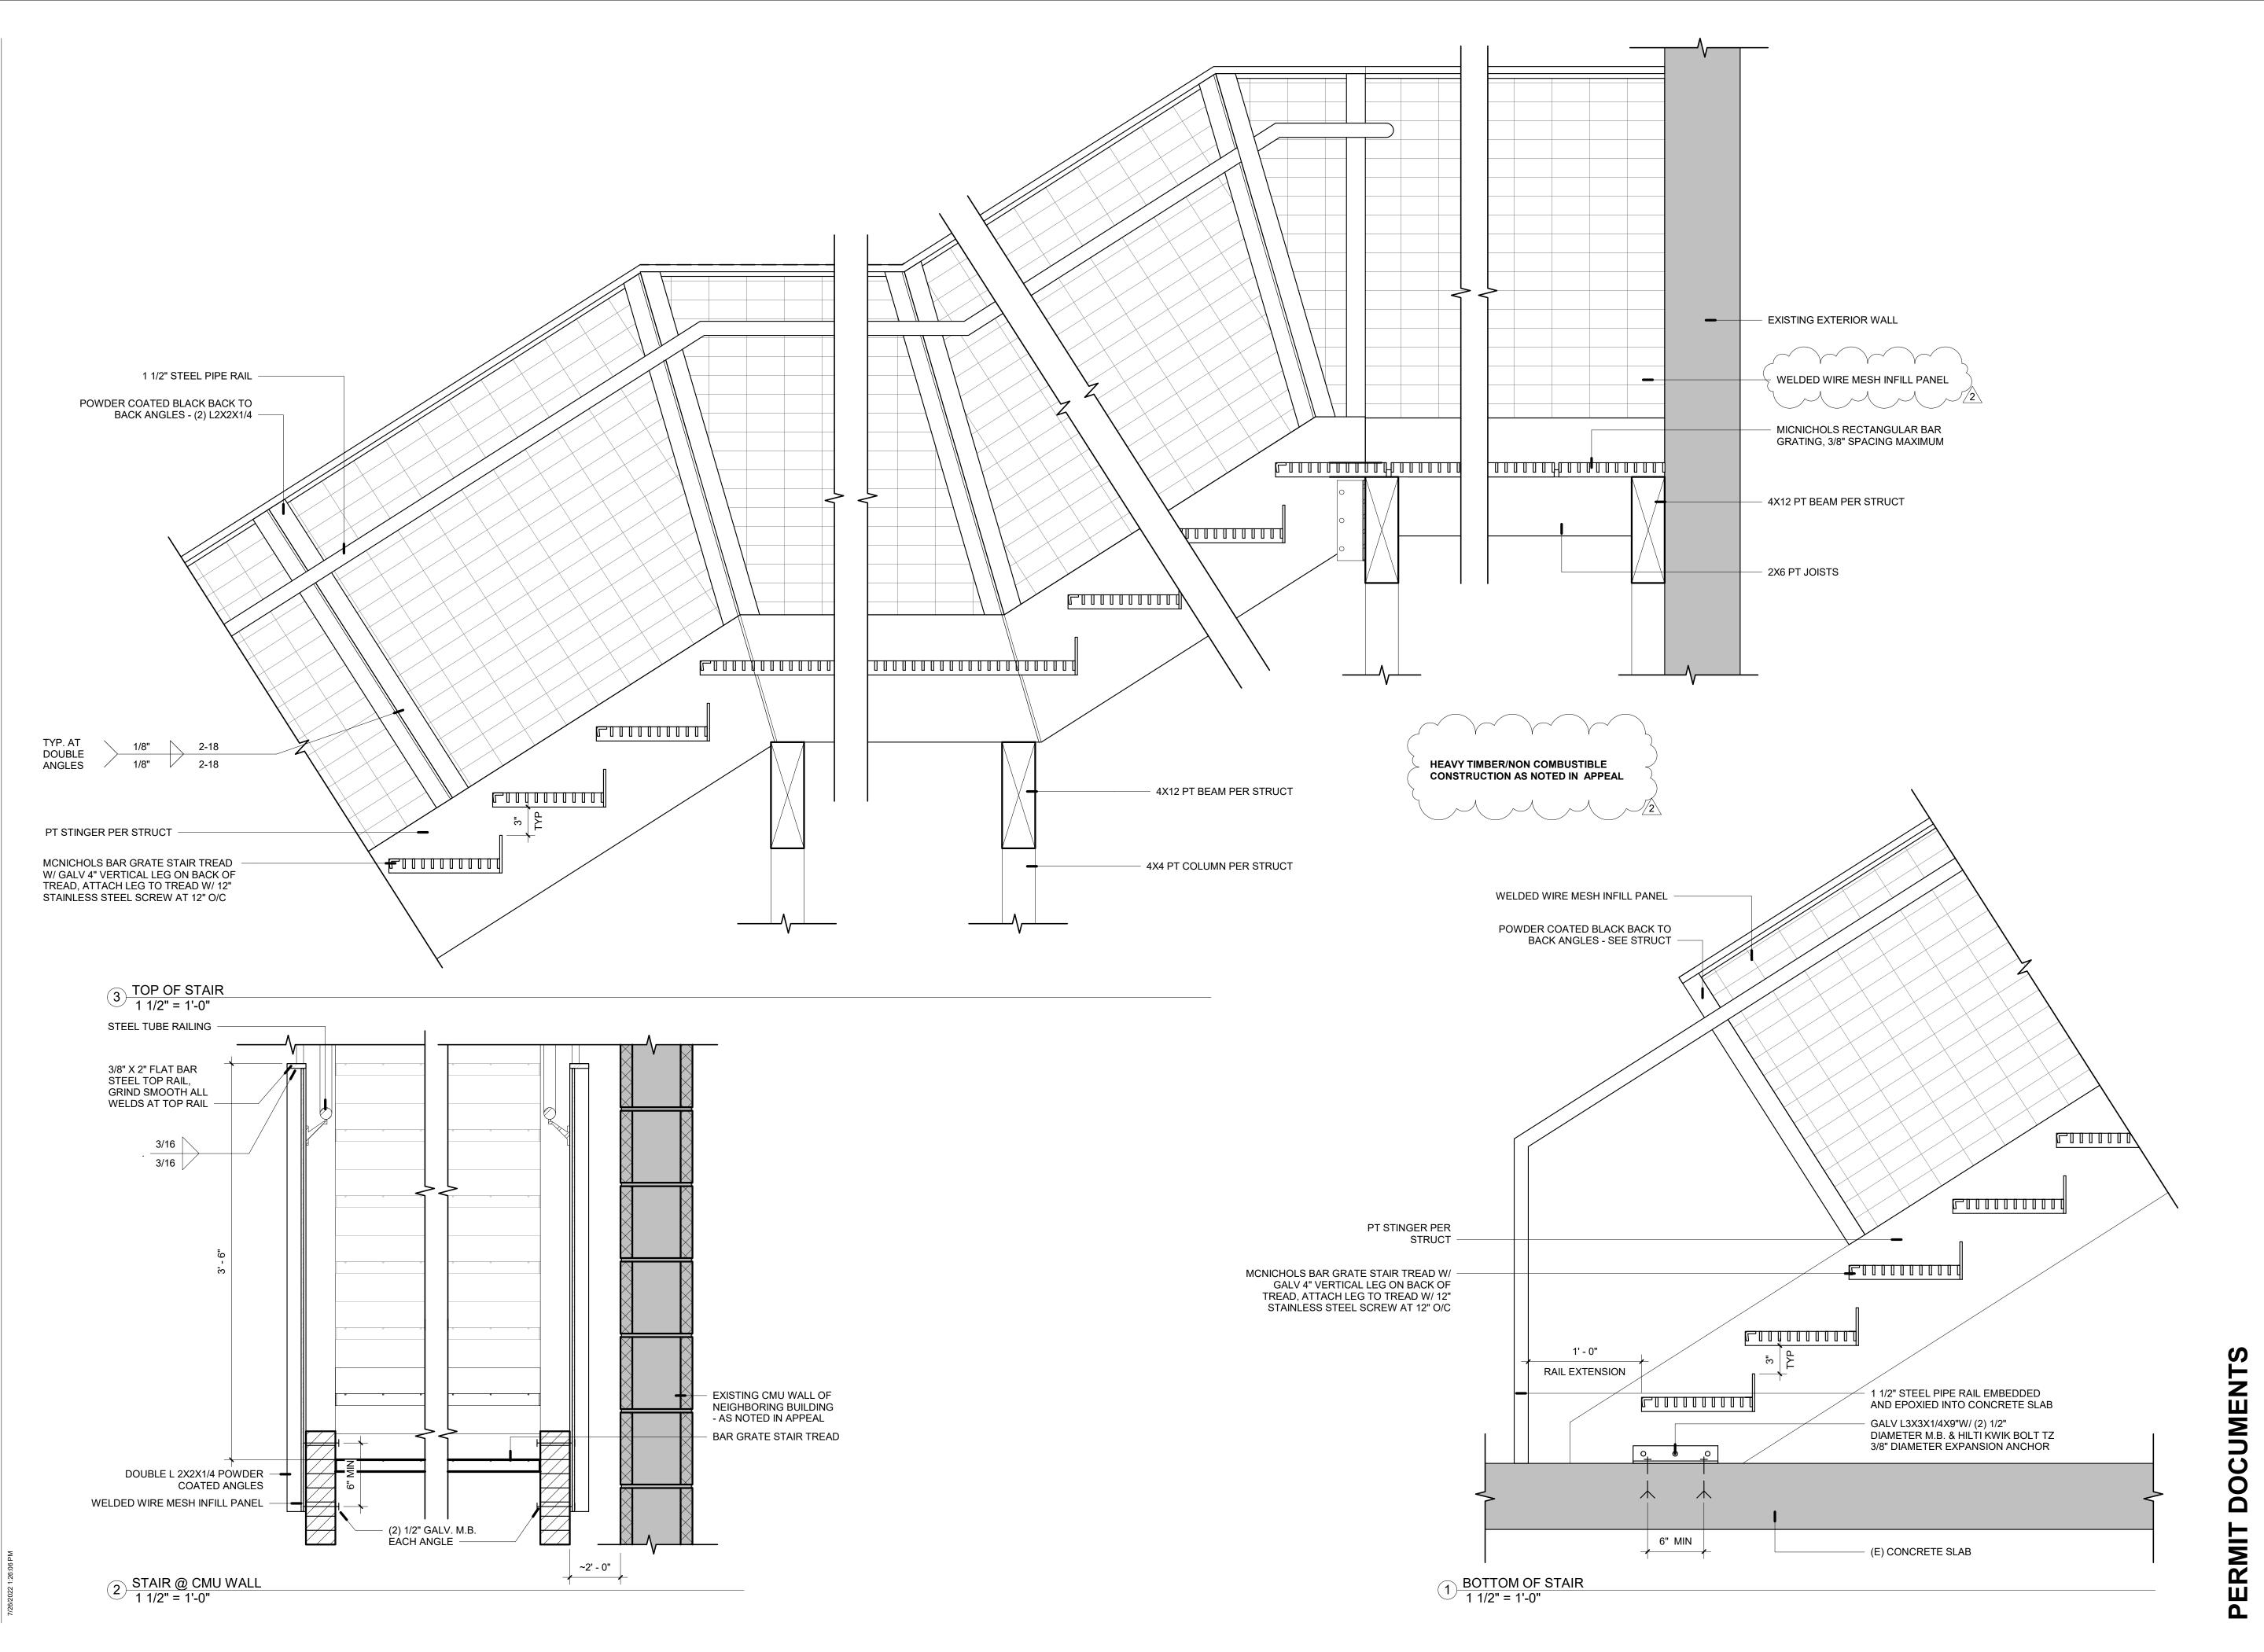

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REVISIONS # DESCRIPTION

1 REV 01 6/9/22 2 APPEAL #27829 7/26/22


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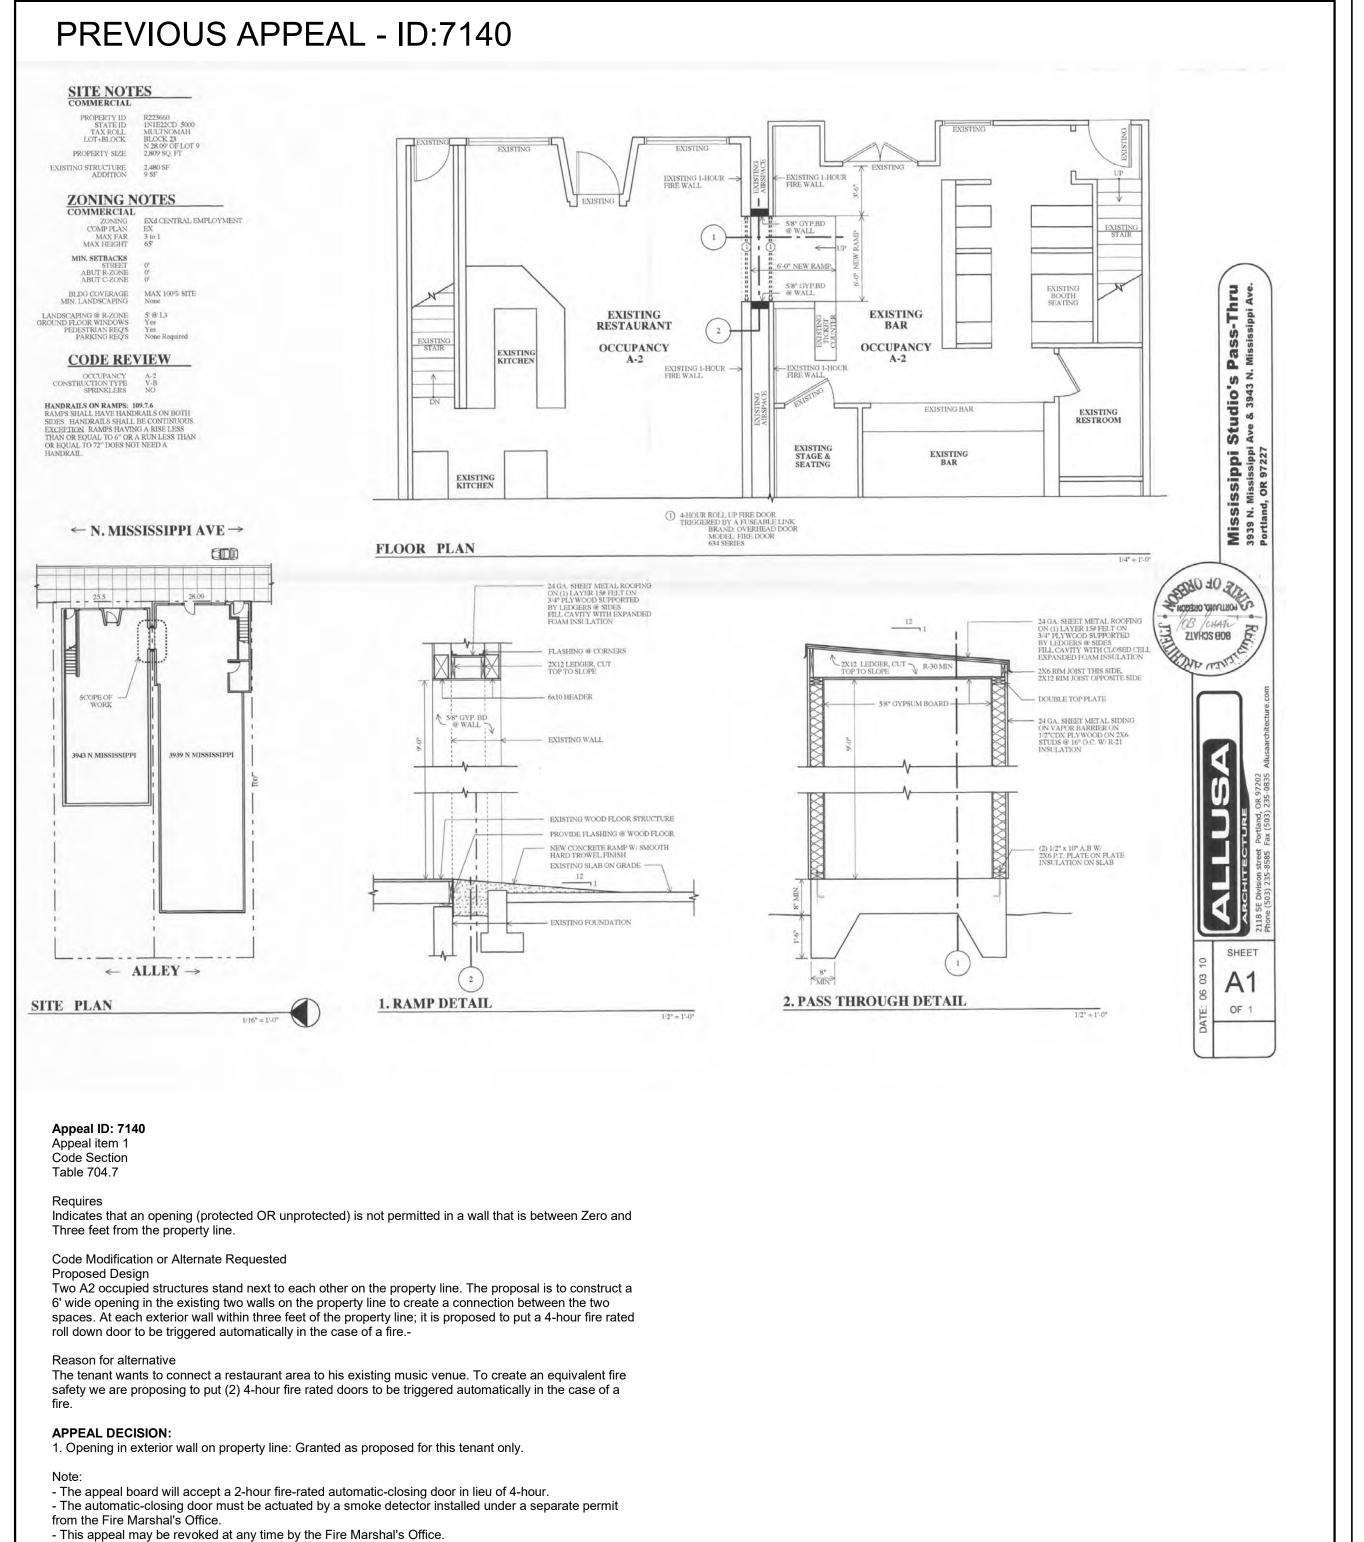
CONVENIENCE BAR BAR STAIR
3943 N MISSISSIPPI Ave

ISSUE DATE: 1/20/2022 PROJECT NO: DRAWN BY:

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DETAILS



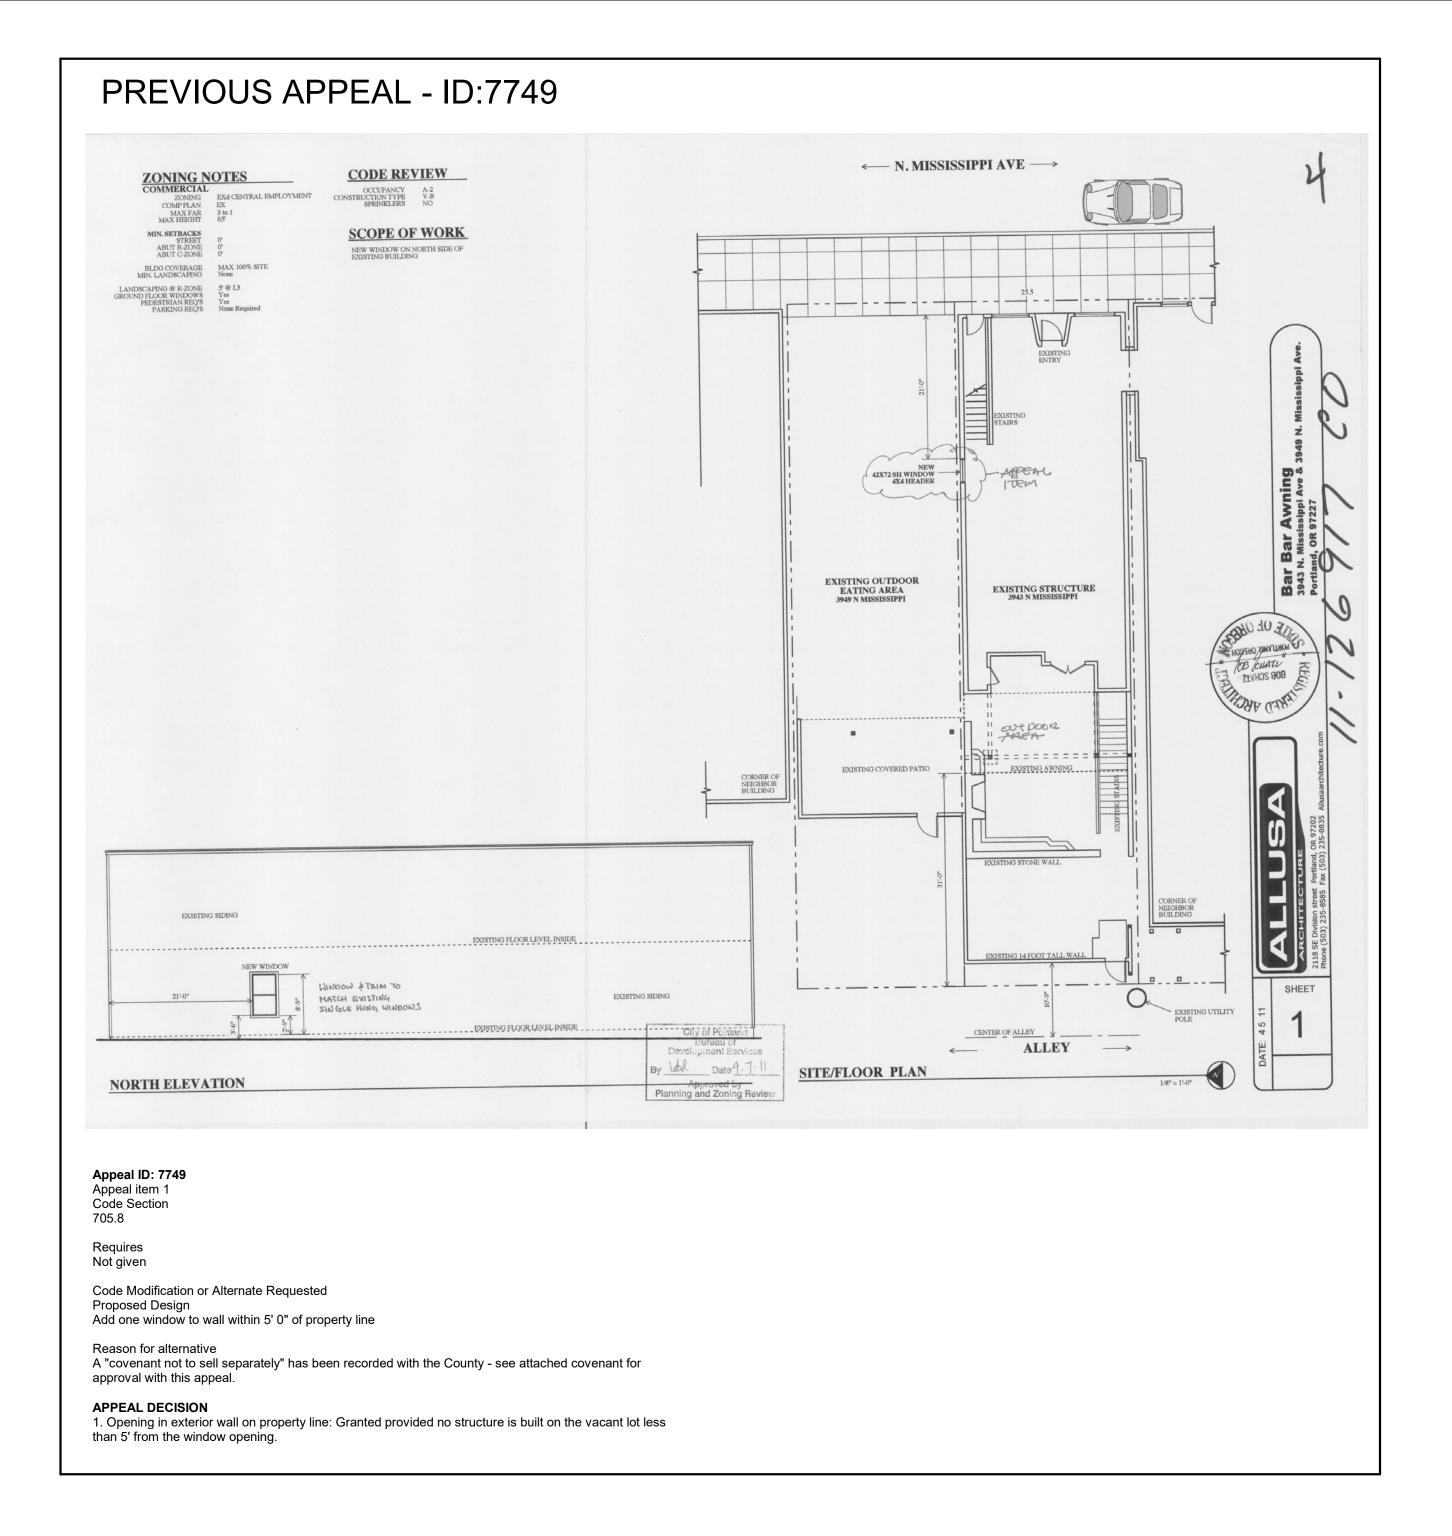

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ISSUE DATE: PROJECT NO: DRAWN BY:

1/20/2022

21024

Author

PREVIOUS APPEALS -REFERENCE

DOCUMENTS