Development Services

From Concept to Construction

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More Contact Info (http://www.portlandoregon.gov//bds/article/519984)



APPEAL SUMMARY

Status:		eci)	S	ion	F	Reno	lered	
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Appeal ID: 27623	Project Address: 4047 N Williams Ave		
Hearing Date: 3/30/22	Appellant Name: Mike Perso		
Case No.: B-010	Appellant Phone: 503-841-5239		
Appeal Type: Building	Plans Examiner/Inspector: David Bartley		
Project Type: commercial	Stories: 4 Occupancy: R-2, S-1, M Construction Type: V-A		
Building/Business Name:	Fire Sprinklers: Yes - throughout		
Appeal Involves: Erection of a new structure	LUR or Permit Application No.: 21-060947-CO		
Plan Submitted Option: pdf [File 1] [File 2] [File 3]	Proposed use: multifamily residential, retail		

APPEAL INFORMATION SHEET

Appeal item 1

Code Section	1028.1
Ocac occion	1020.1

Requires Exits shall discharge directly to the exterior of the building. The exit discharge shall be at grade or

shall provide a direct path of egress travel to grade. The exit discharge shall not reenter a building.

Code Modification or Alternate Requested

This appeal requests that the path of egress travel be permitted to pass underneath the cantilievered building overhang after initially exiting the building and before discharging to a public way.

Proposed Design

The proposed project consists of two, four story mixed-use buildings located on a site along N Williams Avenue. The two structures are separated by an internal courtyard and each building consists of three stories of residential apartments over ground floor lobby and residential units. Ground floor retail is located along the Williams Ave facade.

Each building has two internal exit stairs, one that discharges directly to the building exterior at a public way (Stair 2 and Stair 4), and another that exits through the shared courtyard (Stair 1 and Stair 3). An egress court along the south lot line serves as the exit discharge component of the means of egress for both Stair 1 & Stair 3. It extends between the courtyard and the termination of the exit at the public way.

The egress court is open to the sky with the exception of a portion adjacent to ground floor retail where the exit discharge passes under building overhang and, while enclosed by building on only two sides, is considered to be reentering the building. The egress path continues under building overhang for 22 feet until it terminates at the sidewalk on N Williams Ave. The area under the overhang is proposed to be a paved walkway with a small planting strip. The bottom of the soffit at the overhang is approximately 11'-10" above the walking surface.

The fire resistance rated construction of the exterior wall along the egress court, including the portion of wall supporting the projection above is proposed to be increased to a 2-hour rating. Similarly a 2-hour rated horizontal assembly is proposed at the floor that overhangs the egress path. The entire building, including the path of exit discharge beneath building overhang in the courtyard, is fully sprinklered per NFPA 13. As an additional measure of protection, a moderate fire sprinkler hazard classification is proposed throughout the entire ground floor level and overhang. Openings at the Stair 1 landing and Retail space will be 45-minute rated openings.

The exit access and discharge to the right-of-way is readily visible and clearly identifiable from the lobby at both Stair 1 and Stair 3. Design elements such as glazing and paving, combined with the use of signage and lighting create a direct, clear, and unobstructed path from the termination of each exit stair to the discharge at the public way.

Reason for alternative The design provides equivalent protection in the following ways:

Provides an enhanced level of protection via 2-hour resistance rated fire barriers and horizontal assemblies separating the egress path from areas adjacent and above.

Provides an enhanced level of protection by providing moderate fire sprinkler hazard classification at the entire ground floor level and overhang.

Establishes a clear exiting sequence by providing a readily visible and identifiable view from the point of termination of the stair enclosure to the lobby exit and courtyard beyond. And then providing a readily visible and identifiable view of the exit to the public way from the lobby exit The courtyard adjacent to the discharge access is open to the sky, which will help dissipate smoke in the event of fire.

Additional considerations:

Per table 506.2 the total allowable building area for each building, given type, group, and sprinkler bonus, is 108,000 SF. The proposed actual building areas for the East and West buildings are 8,952 SF and 9,524 SF respectively, resulting in buildings that are approximately 8% of their allowable size. Consequently the occupancy load of the proposed design is significantly less than what is allowed per code and the risk associated with exiting a large volume of occupants is significantly reduced.

Per table 1004.5 the total R-2 occupant load, based on allowable area for floors 2-4 is 540 occupants, or 270 per stair enclosure. The actual proposed total occupant load for floors 2-4 is 40 occupants per building, or 20 per stair. In the event that Stair 1 and Stair 3 were required to accommodate the total occupant loads of floors 2-4 for both buildings it would only account for 14.8% of the allowable load. More importantly, when considering the combined occupant load of Levels 1 and 2 for both buildings, as well as the courtyard occupancy, the cumulative occupant load at the exit discharge shared by stairs 1 and 3 is less than 50 occupants.

The buildings will be used primarily by residents. The residents will be familiar with the spaces and will know where the exits are and how to get to them. The path to the exit from the stair enclosure, through lobby and egress court will be illuminated by a minimum of 1 foot-candle at the floor and lit exit signs will direct occupants, creating a discernible exit path.

This appeal is identical to the condition that was approved in appeal #24963 for permit 21-007867-CO. We respectfully request the approval of this proposed design.

APPEAL DECISION


Exit discharge beneath building overhang: Granted provided Tyco sprinklers are installed in accordance with the manufacturer's specifications.

Appellant may contact John Butler (503 865-6427) or e-mail at John.Butler@portlandoregon.gov with questions.

The Administrative Appeal Board finds with the conditions noted, that the information submitted by the appellant demonstrates that the approved modifications or alternate methods are consistent with the intent of the code; do not lessen health, safety, accessibility, life, fire safety or structural requirements; and that special conditions unique to this project make strict application of those code sections impractical.

Pursuant to City Code Chapter 24.10, you may appeal this decision to the Building Code Board of Appeal within 90 calendar days of the date this decision is published. For information on the appeals process, go to www.portlandoregon.gov/bds/appealsinfo, call (503) 823-7300 or come in to the Development Services Center.

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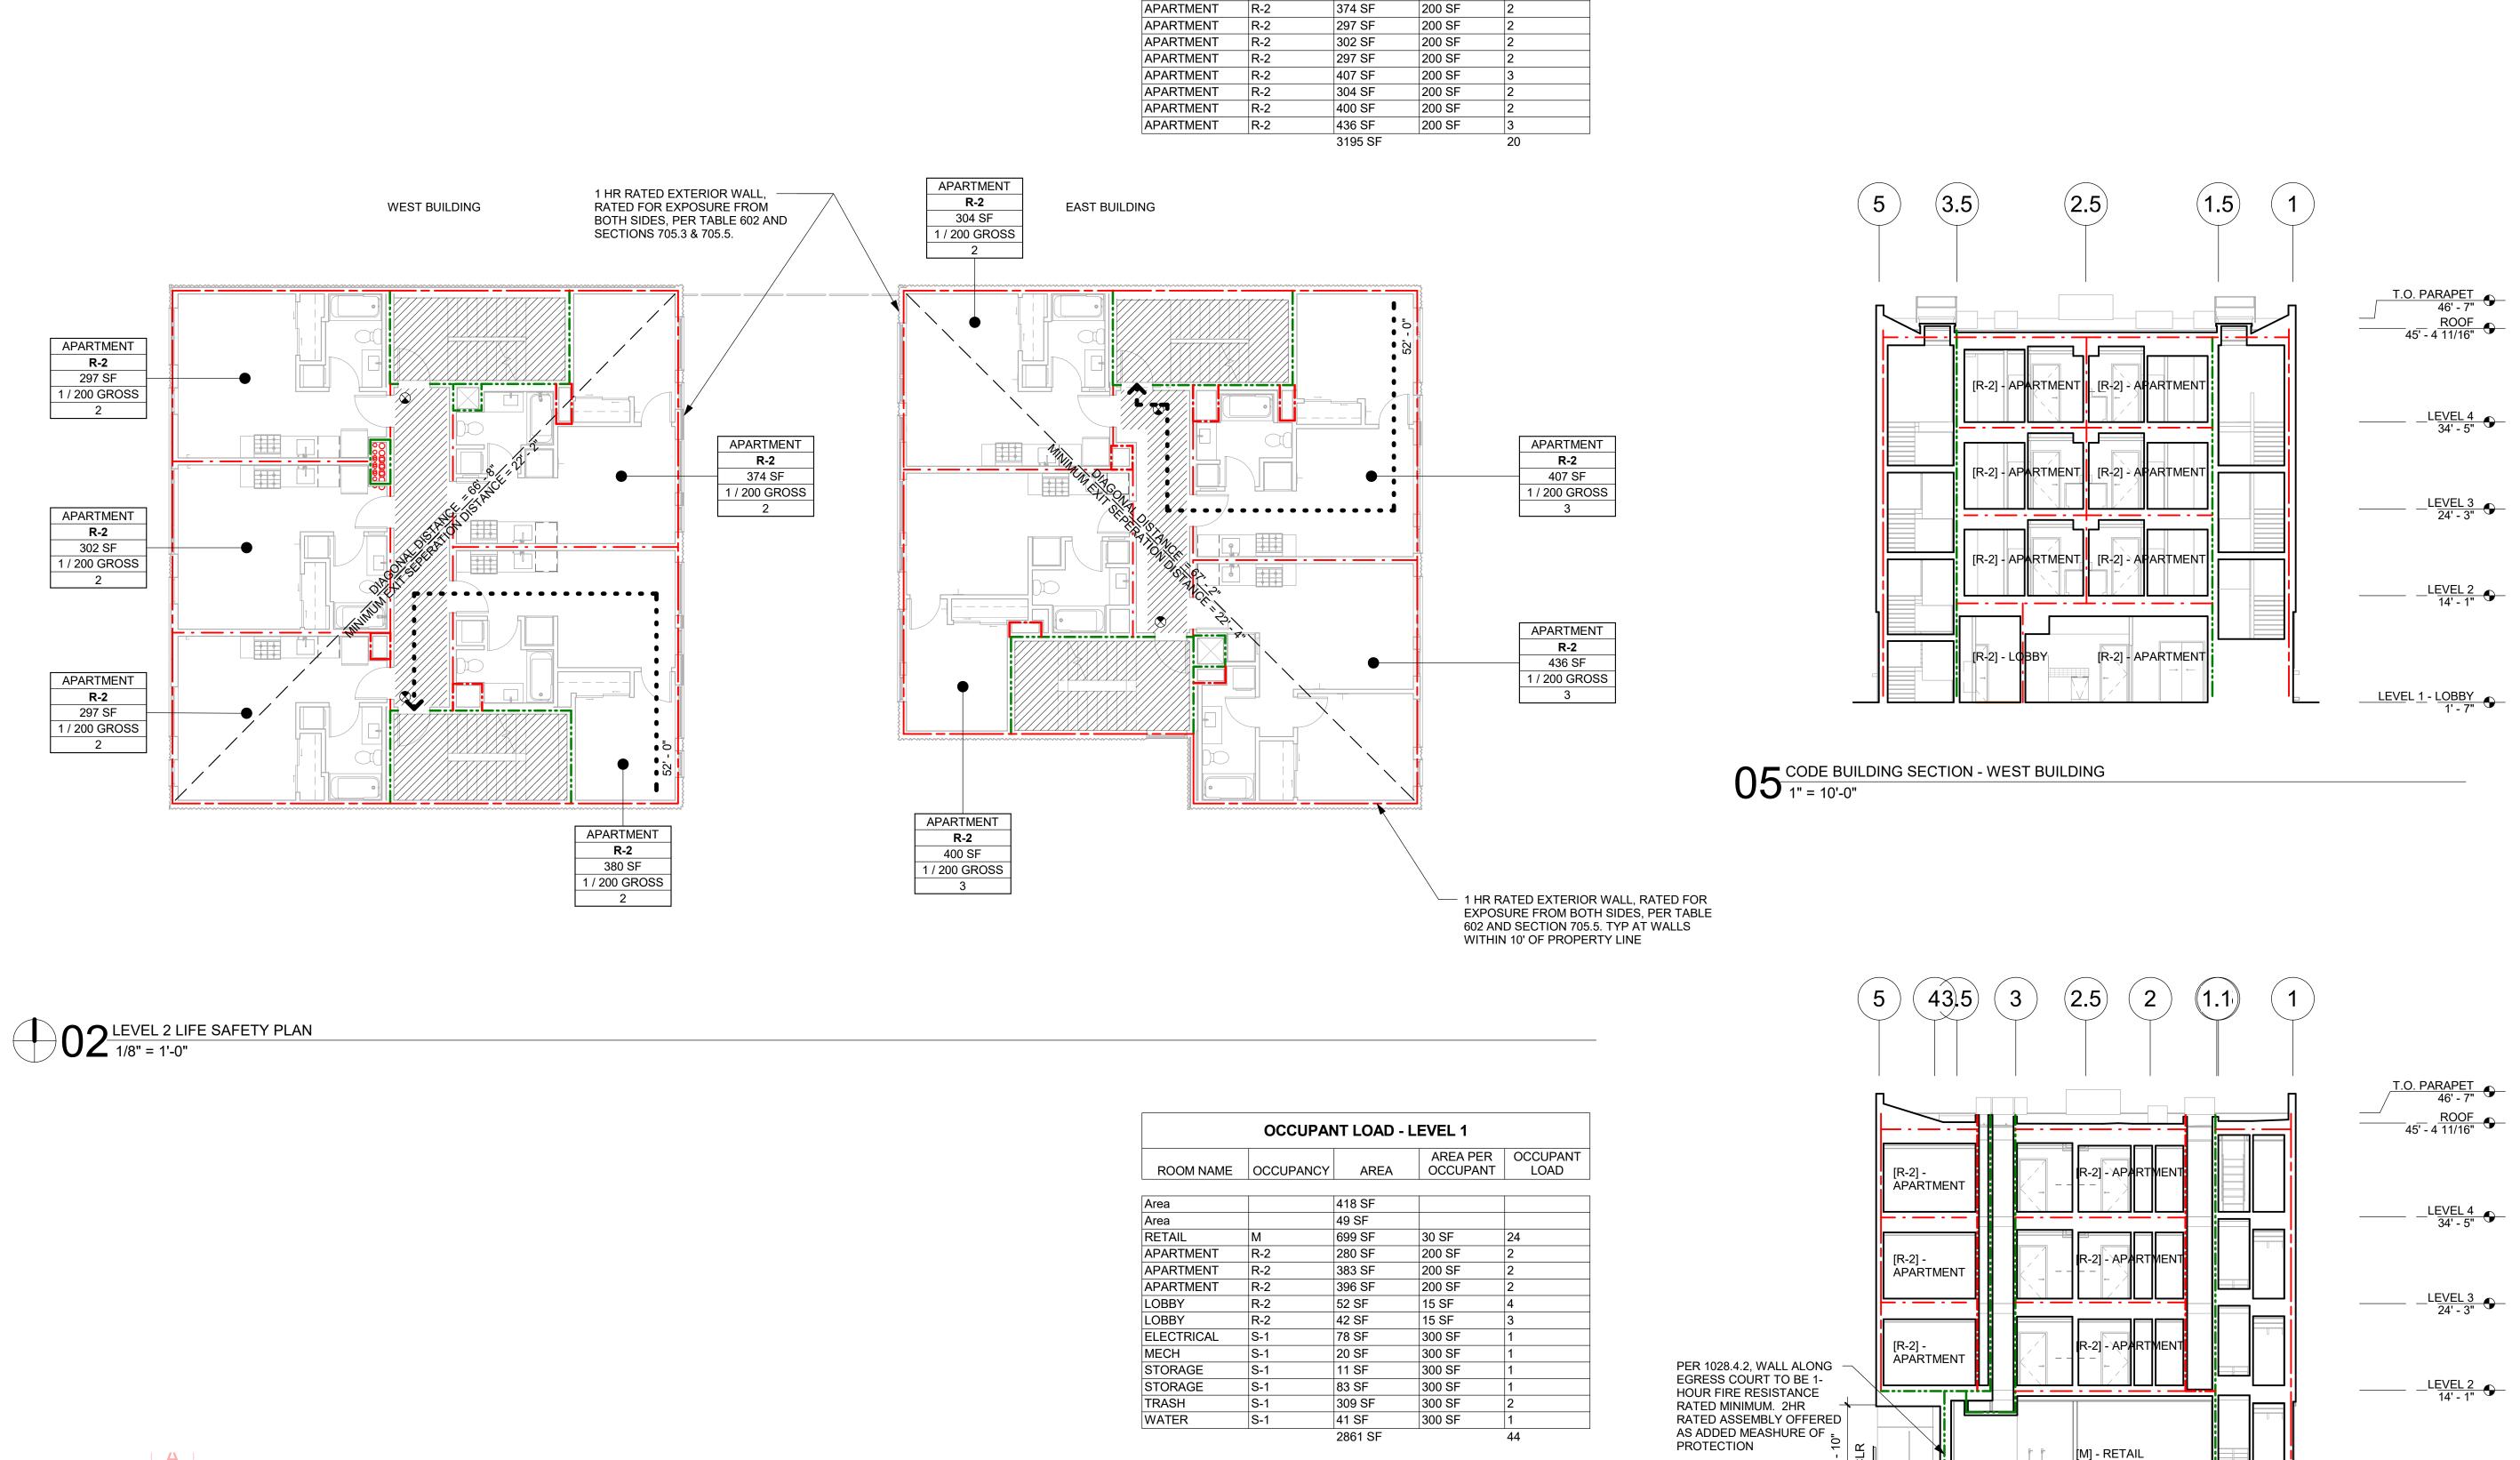

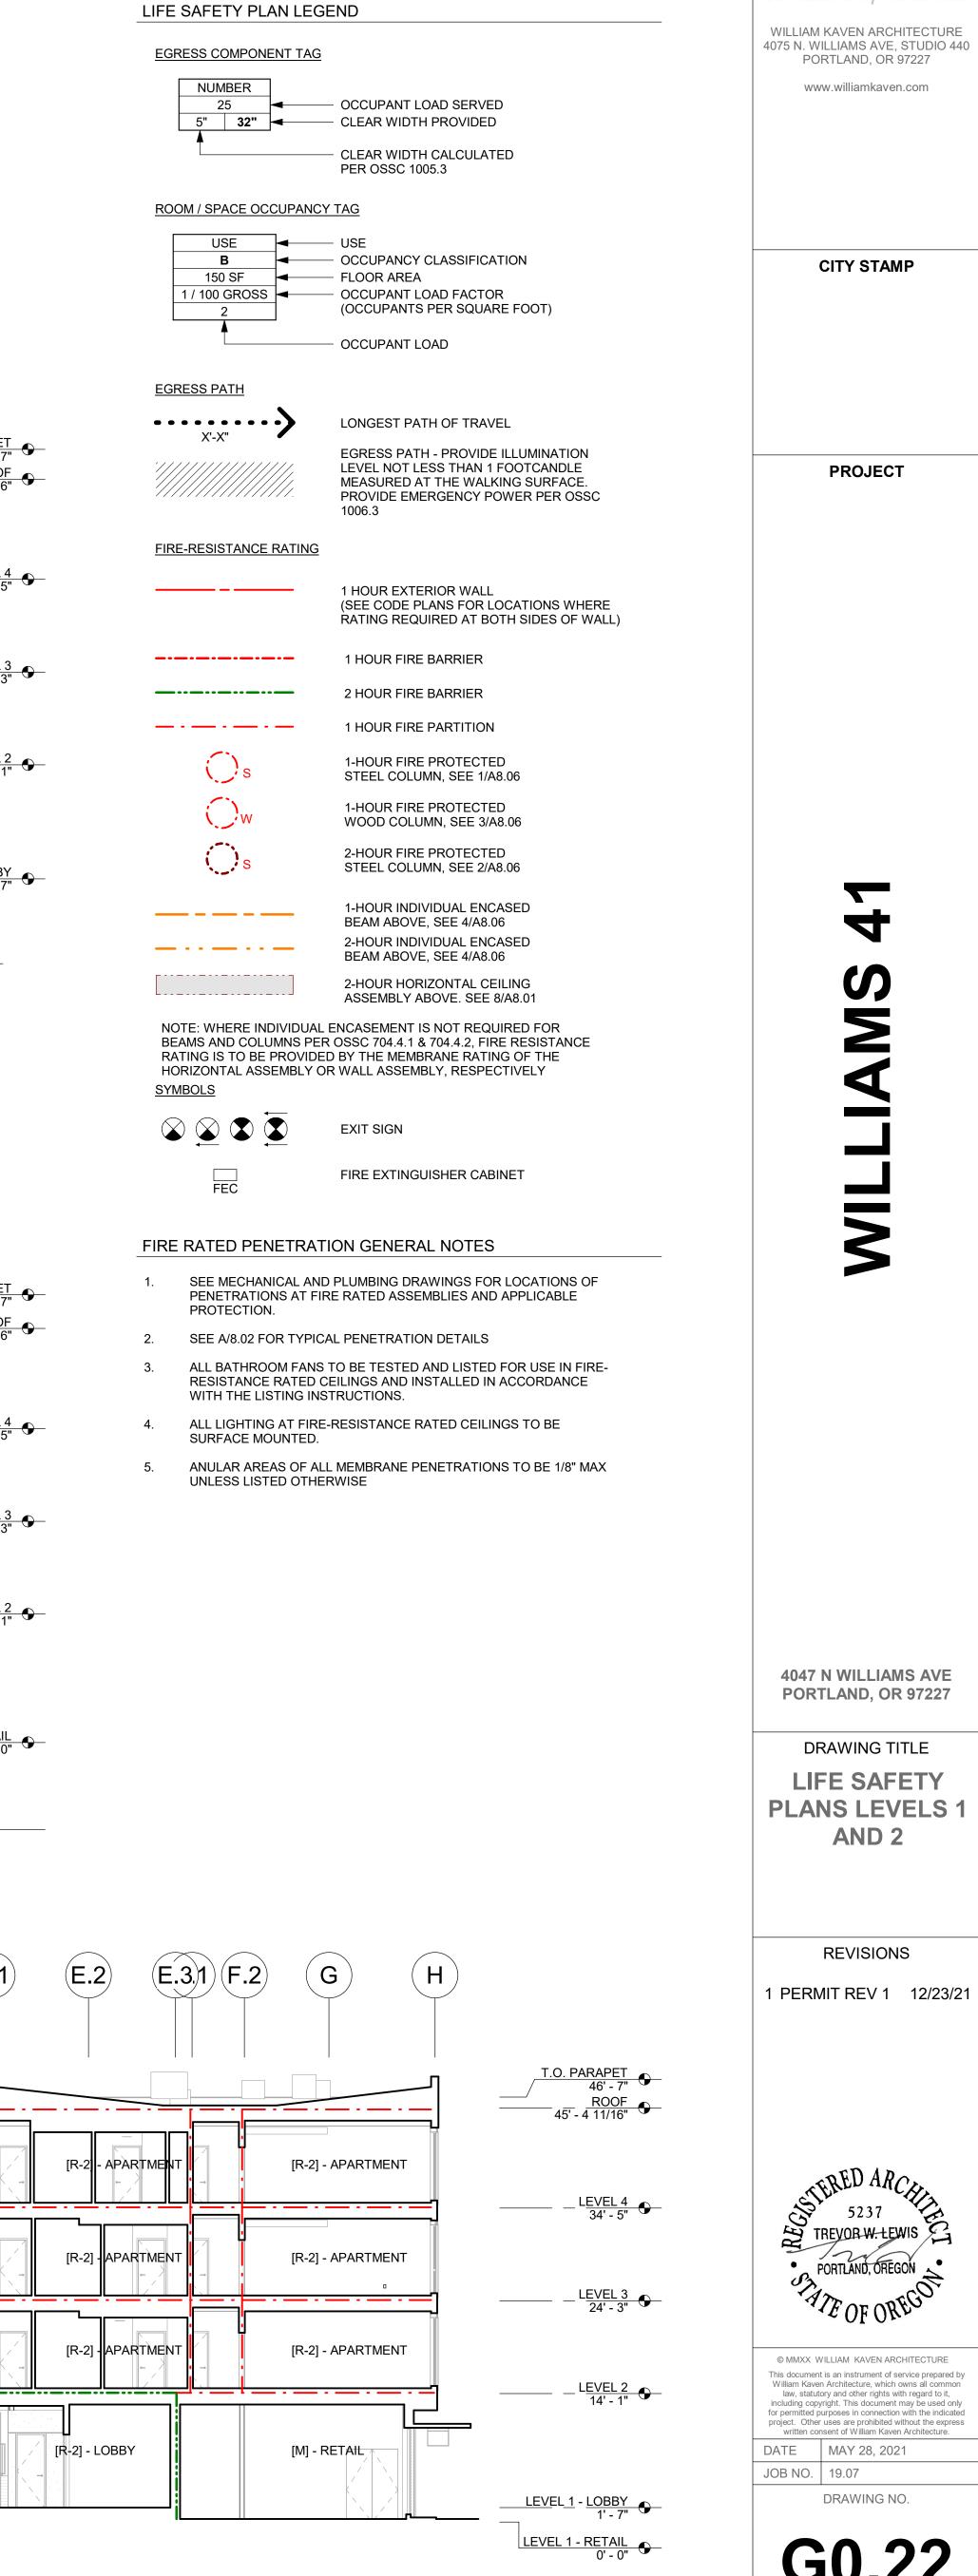
<u>LEVE</u>L <u>1 - RETAIL</u> <u>0' - 0"</u>

[R-2] - APARTMENT

[R-2] - APARTMENT

[R-2] - APARTMENT



EAST BUILDING

396 SF

I / 200 GROSS

S-1

41 SF

1 / 300 GROSS

INDIVIDUALLY ———

M OCCUPANCY FILED

UNDER SEPARATE PERMIT

BUILDING OVERHANG ABOVE

2HR RATED BARRIRE ALONG

DISCHARGE, OFFERED AS ADDED

EGRESS COURT AND EXIT

MEASURE OF PROTECTION

- 45 MINUTE RATED OPENING

PROTECTIVE

ENCASED GLULAM

BEAM ABOVE WALL

1 HR RATED EXTERIOR WALL, RATED

O4 CODE BUILDING SECTION - EAST BUILDING 1" = 10'-0"

[R-2] - APARTMEN

[R-2] - APARTM

[R-2] - APARTMENT

03 CODE BUILDING SECTION

1" = 10'-0"

FOR EXPOSURE FROM BOTH SIDES,

PER TABLE 602 AND SECTION 705.5.

TYP AT WALLS WITHIN 10' OF

NO FURNITURE OR STORAGE

OF MATERIALS AT ALCOVE

PROPERTY LINE

699 SF

1 / 30 GROSS

STEEL ACCESS GATE

PUBLIC WAY

WITH PANIC HARDWARE

- 2 HR RATED HORIZONTAL

- TYCO MODEL WS SPECIFIC

TERMINATION OF EXIT AT THE

ASSEMBLY ABOVE OFFERED AS

ADDED MEASURE OF PROTECTION

APPLICATION PENDENT VERTICAL

SIDEWALL WINDOW SPRINKLER AT

2-HR FIRE BARRIER ASSEMBLY

STORAGE

11 SF

ELECTRICAL S-1

78 SF

1 / 300 GROSS

APARTMENT

280 SF 1 / 200 GROSS

TRASH

S-1

309 SF

1 / 300 GROSS

LEVEL 1 LIFE SAFETY PLAN

7 **1** 1/8" = 1'-0"

1 / 300 GROSS

\ WEST BUILDING

INDIVIDUALLY

ENCASED GLULAM

BEAM ABOVE WALL

/**/**

TYCO MODEL WS SPECIFIC

WINDOW SPRINKLER 2-HR

TERMINATION OF EXIT ACCESS — FOR GROUND LEVEL UNITS. EXIT

APPLICATION PENDENT

FIRE BARRIER ASSEMBLY

NO FURNITURE ALLOWED

VERTICAL SIDEWALL

DISCHARGE BEGINS

1 / 300 GROSS

APARTMENT

R-2

383 SF

1 / 200 GROSS

EMERGENCY ESCAPE /

RESCUE OPENING TO

G0.21

EGRESS COURT

IN ACCORDANCE WITH OSSC 1028.4

STORAGE

S-1

83 SF

1 / 300 NET

EXIT DISCHARGE

R-2

42 SF

1 / 15 NET

\G0.21

COMPLY WITH OSSC

SECTION 1030

1

3' -8" CLR

TYP

LOBBY

R-2

52 SF

1 / 15 NET

OCCUPANT LOAD - LEVEL 2

ROOM NAME OCCUPANCY AREA OCCUPANT

APARTMENT

AREA PER OCCUPANT

200 SF

LOAD

WILLIAM / KAVEN WILLIAM KAVEN ARCHITECTURE 4075 N. WILLIAMS AVE, STUDIO 440 PORTLAND, OR 97227 www.williamkaven.com

PROJECT

CITY STAMP

PERMIT


WILLIAM / KAVEN

DO NOT SCALE. FOLLOW DIMENSIONS SHOWN ON

STERED ARCHIE TREVOR W. LEWIS PORTLAND, OREGON

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DATE MAY 28, 2021 JOB NO. 19.07 DRAWING NO.

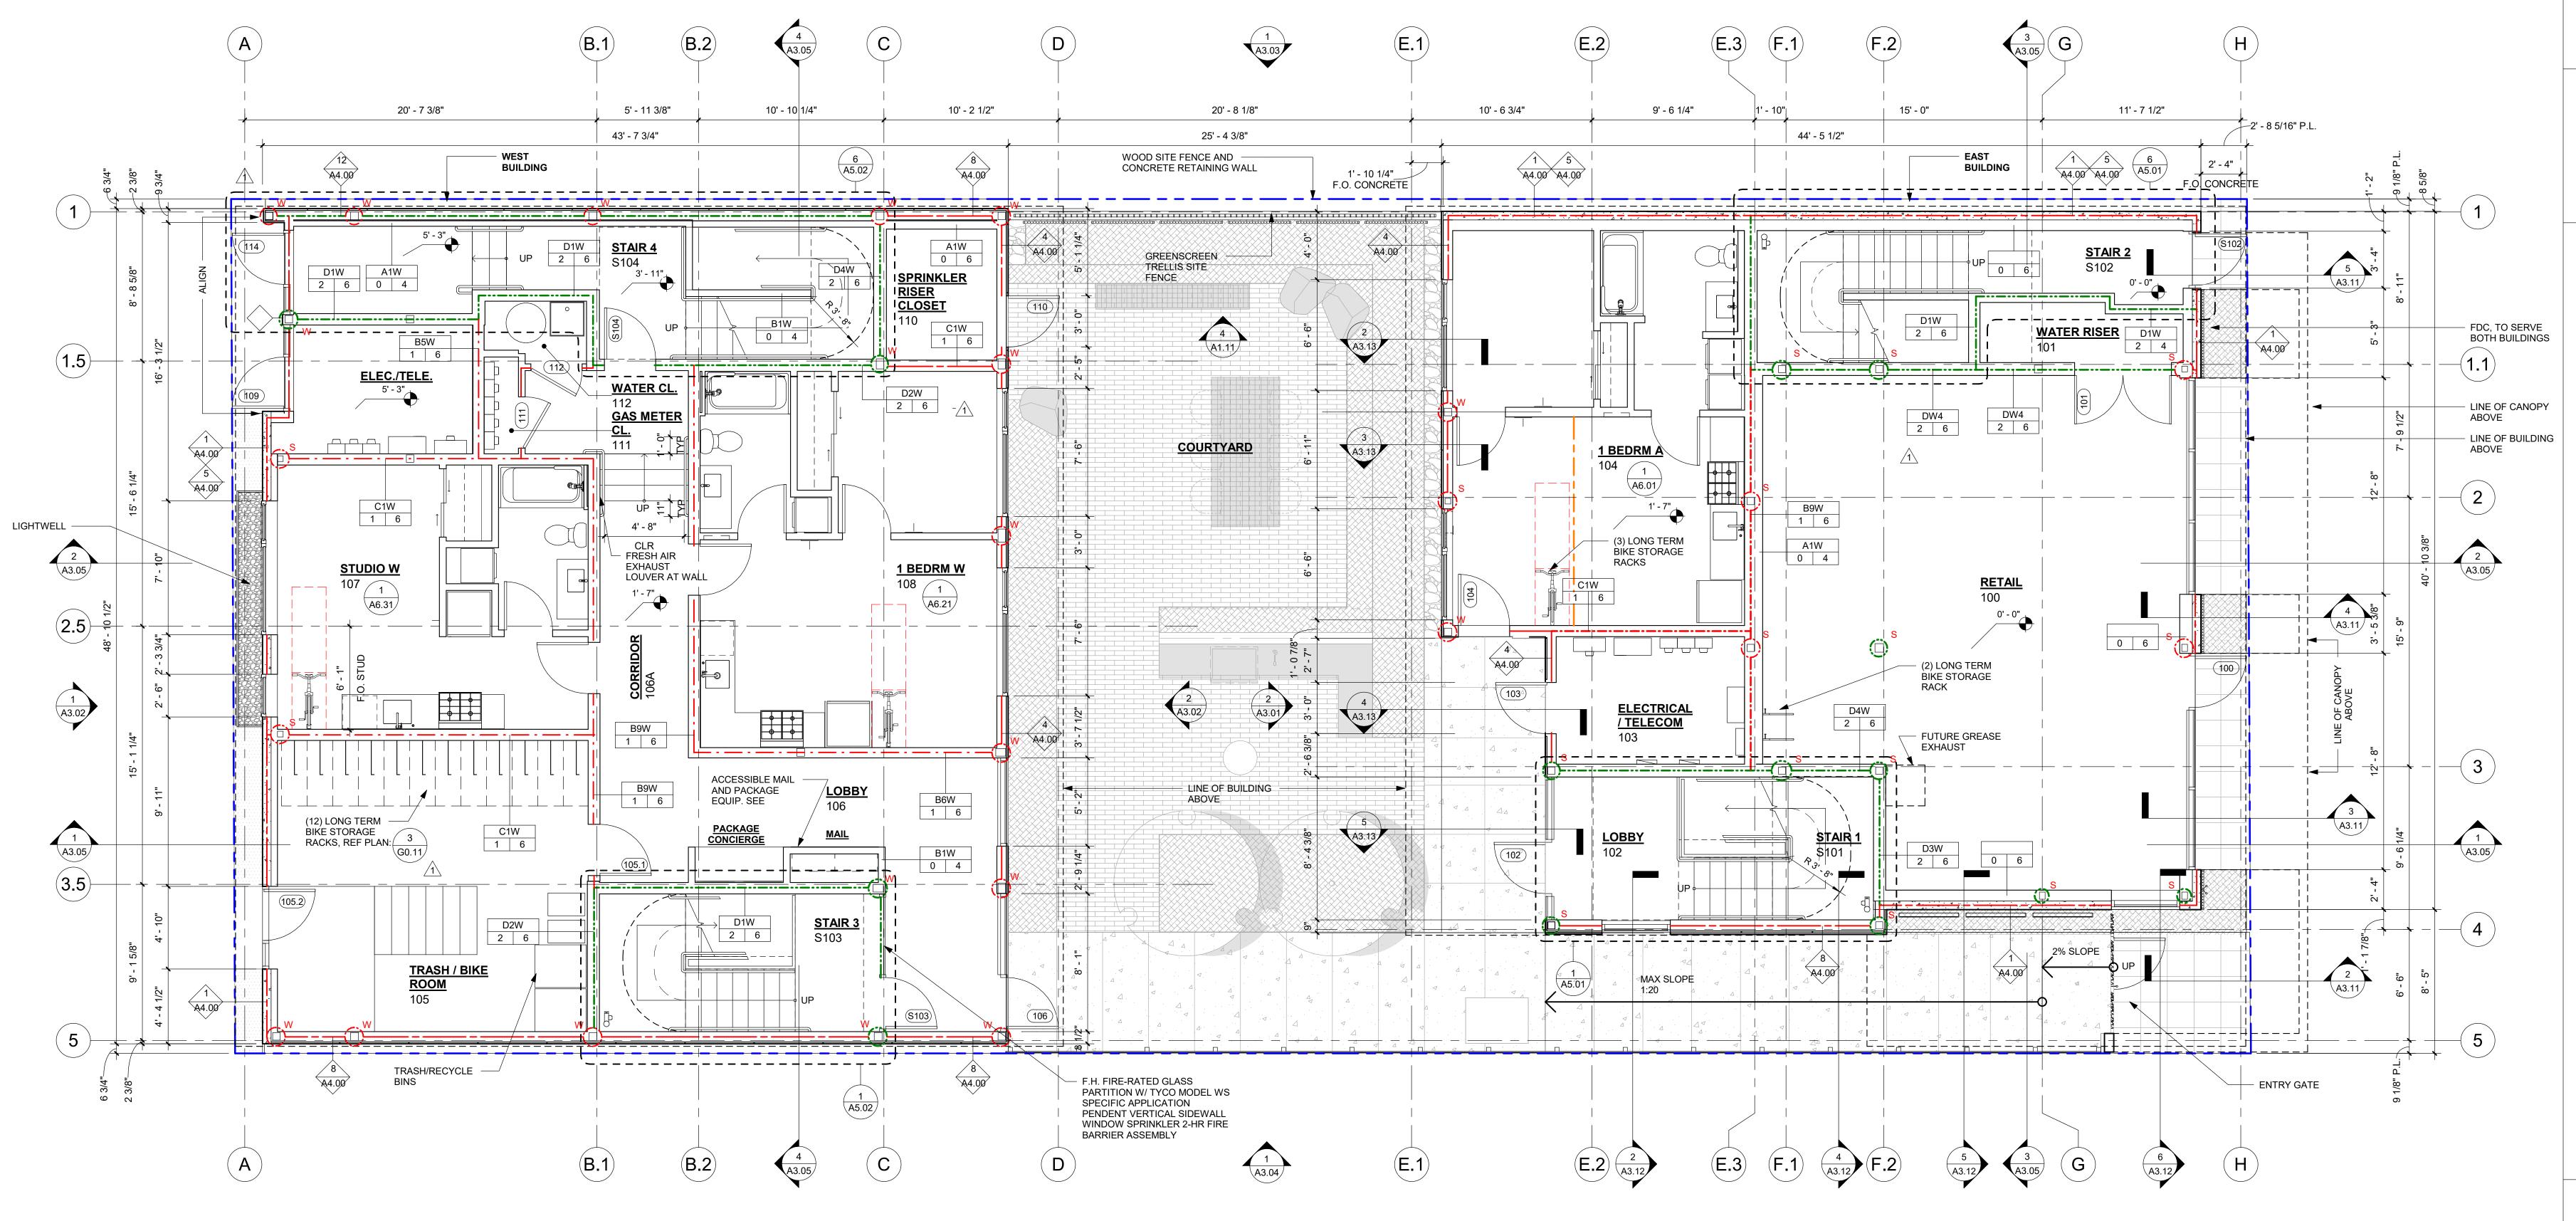

1/4" = 1'-0"

(SEE CODE PLANS FOR LOCATIONS WHERE RATING REQUIRED AT BOTH SIDES OF WALL) 1 HOUR FIRE BARRIER _-----2 HOUR FIRE BARRIER 1 HOUR FIRE PARTITION 1-HOUR FIRE PROTECTED STEEL COLUMN, SEE 1/A8.06 1-HOUR FIRE PROTECTED WOOD COLUMN, SEE 3/A8.06 2-HOUR FIRE PROTECTED STEEL COLUMN, SEE 2/A8.06 1-HOUR INDIVIDUAL ENCASED ____ BEAM ABOVE, SEE 4/A8.06 2-HOUR INDIVIDUAL ENCASED _ . . _ . . _ BEAM ABOVE, SEE 4/A8.06 2-HOUR HORIZONTAL CEILING

1 HOUR EXTERIOR WALL

FIRE RESISTANCE RATING LEGEND

NOTE: WHERE INDIVIDUAL ENCASEMENT IS NOT REQUIRED FOR BEAMS AND COLUMNS PER OSSC 704.4.1 & 704.4.2, FIRE RESISTANCE RATING IS TO BE PROVIDED BY THE MEMBRANE RATING OF THE HORIZONTAL ASSEMBLY OR WALL ASSEMBLY, RESPECTIVELY

ASSEMBLY ABOVE. SEE 8/A8.01

3. SEE SITE PLAN FOR SITE WALLS, GATES, FENCES 4. SEE INTERIOR ELEVATIONS FOR DEVICE, FIXTURE,

5. REFER TO UNIT PLANS FOR UNIT INTERIOR WALL TYPES AND DIMENSIONS. 6. ALL GATES AND RAILINGS TO BE DESIGN BUILD.

AND OTHER EXTERIOR INFORMATION.

GENERAL NOTES

INFORMATION INCLUDED FOR DESIGN INTENT ONLY. ENGINEERING TO BE PROVIDED ON ALL REQUIRED ASSEMBLIES. 7. FOR PARTITION TYPES AND TYPICAL DETAILS SEE

1. THESE DRAWINGS ARE DIAGRAMMATIC IN NATURE:

2. DIMENSIONS ON PLAN SHEETS ARE TO FINISH FACE

AND EQUIPMENT MOUNTING LOCATIONS AND

HEIGHTS WHERE NOT NOTED ON PLANS.

DRAWINGS AND FIELD VERIFY EXISTING

SHEETS <u>A8.01-A8.02.</u> 8. FOR TYPICAL EXTERIOR ASSEMBLY TYPES SEE SHEET <u>A4.00</u>

9. FOR DOOR AND FRAME SCHEDULE SEE SHEET A9.02. 10. FOR FINISH SCHEDULE SEE SHEET A9.03.

11. REFER TO MECHANICAL PLANS FOR MECHANICAL EQUIPMENT LOCATIONS, WEIGHTS, AND ADDITIONAL INFORMATION.

12. FOR ENLARGED STAIR PLANS AND SECTIONS SEE SHEETS <u>A5.01-A5.02.</u> **PERMIT**

WILLIAM / KAVEN

WILLIAM KAVEN ARCHITECTURE

4075 N. WILLIAMS AVE, STUDIO 440

PORTLAND, OR 97227

www.williamkaven.com

CITY STAMP

PROJECT



PORTLAND, OR 97227 DRAWING TITLE LIFE SAFETY SITE PLAN & **CODE SUMMARY**

4047 N WILLIAMS AVE


REVISIONS 1 PERMIT REV 1 12/23/21

5237 TREYOR W. LEWIS

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DRAWING NO.

PERMIT

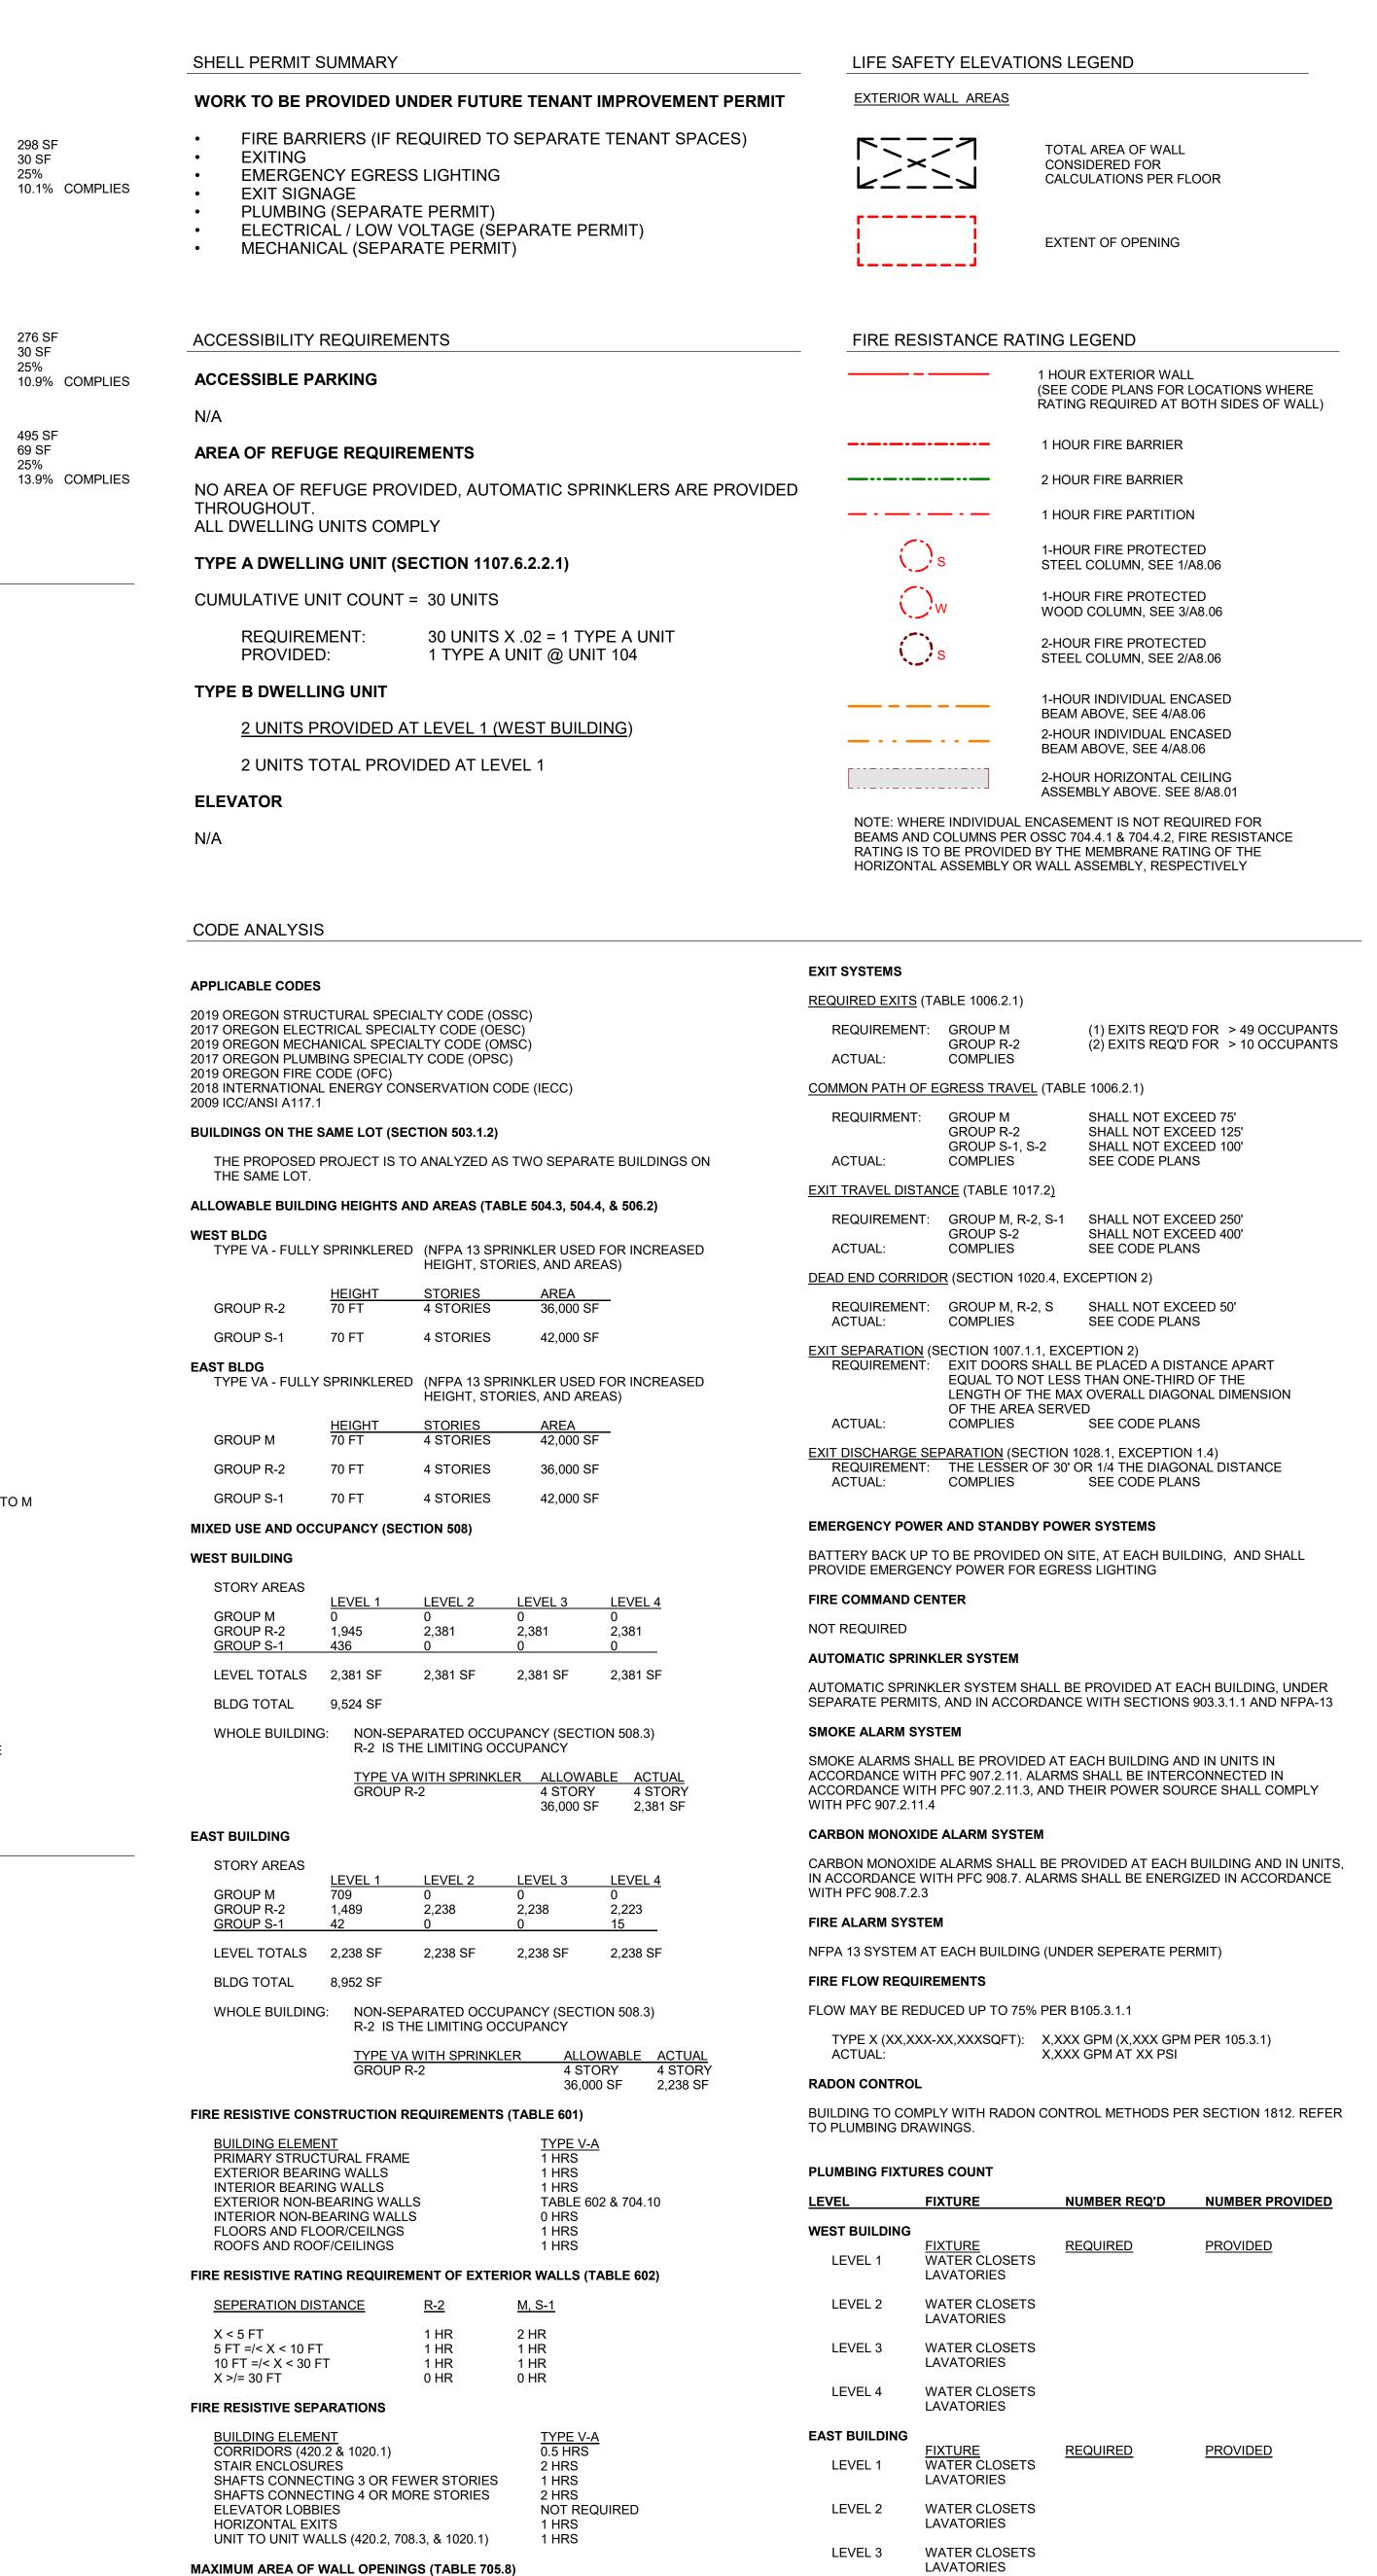

LEVEL 4

SEPARATE PERMIT

MAX OPENING

NO LIMIT

0 TO < 3 FT NOT PERMITTED

10 TO < 15 FT 45%

10 TO < 15 FT 45%

10 TO < 15 FT 45%

NOT PERMITTED

<u>DISTANCE</u>

0 TO < 3 FT

WATER CLOSETS

*** ADDITIONAL FIXTURES REQUIRED BY M OCCUPANCY WILL BE PROVIDED UNDER

LAVATORIES

UNPROTECTED, SPRINKLERED

<u>ELEVATION</u>

NORTH WALL

SOUTH WALL

WEST WALL **COURTYARD EAST**

COURTYARD WEST

EAST WALL

45' - 4 ROOF 11/16" ______ <u> EVEL 4: 5' - 10' SEPARATION</u> TOTAL AREA SAME AS LEVEL 2 OPENING AREA ALLOWABLE OPENING AREA ACTUAL OPENING AREA LEVEL 2: 10' - 15' SEPARATION TOTAL AREA 139 SF OPENING AREA LEVEL 3: SAME AS LEVEL 2 ALLOWABLE OPENING AREA 45% 32% COMPLIES ACTUAL OPENING AREA LEVEL 2: 10' - 15' SEPARATION LEVEL 2: 5' - 10' SEPARATION TOTAL AREA TOTAL AREA **OPENING AREA** 140 SF OPENING AREA ALLOWABLE OPENING AREA 45% ALLOWABLE OPENING AREA 32% COMPLIES ACTUAL OPENING AREA ACTUAL OPENING AREA <u>LEVEL 1: 5' - 10' SEPARATION</u> TOTAL AREA LEVEL 1: 10' - 15' SEPARATION TOTAL AREA OPENING AREA 185 SF OPENING AREA ALLOWABLE OPENING AREA ALLOWABLE OPENING AREA 45% ACTUAL OPENING AREA 36.9% COMPLIES ACTUAL OPENING AREA LEVEL 1 - LOBBY LEVEL 1 - LOBBY OC UNPROTECTED OPENING DIAGRAM - EAST BUILDING - SOUTH ■ UNPROTECTED OPENING DIAGRAM - EAST BUILDING - COURTYARD $04^{\frac{\text{UNPROTEG}}{1" = 10'-0"}}$ 1" = 10'-0"

SAME AS LEVEL 2

OPENING AREA

OTAL AREA

OPENING AREA

OPENING AREA

SAME AS LEVEL 2

OPENING AREA

OTAL AREA

OTAL AREA OPENING AREA

OPENING AREA

LEVEL 3: 10' - 15' SEPARATION TOTAL AREA

LEVEL 2: 10' - 15' SEPARATION

ACTUAL OPENING AREA

ACTUAL OPENING AREA

ALLOWABLE OPENING AREA

ACTUAL OPENING AREA

ALLOWABLE OPENING AREA 45%

ALLOWABLE OPENING AREA 45%

BEECH ST AND N WILLIAMS AVE

FIRE FLOW TEST PENDING

EXISTING GARAGE

LEVEL 1 - LOBBY

ROOF 45' - 4 11/16"

03 UNPROTECTED OPENING DIAGRAM - WEST BUILDING - COURTYARD 1" = 10'-0"

02 UNPROTECTED OPENING DIAGRAM - WEST BUILDING - ALLEY 1" = 10'-0"

01 LIFE SAFETY SITE PLAN
1" = 10'-0"

LEVEL 3: 10' - 15' SEPARATION

EVEL 2: 10' - 15' SEPARATION

LEVEL 1: 10' - 15' SEPARATION

ACTUAL OPENING AREA

ACTUAL OPENING AREA

ACTUAL OPENING AREA

ALLOWABLE OPENING AREA 45%

ALLOWABLE OPENING AREA 45%

ALLOWABLE OPENING AREA 45%

165 SF

164 SF

249 SF

149 SF

146 SF


166 SF

29.8% COMPLIES

29.2% COMPLIES

28.7% COMPLIES

WEST BUILDING **EAST BUILDING** 2,381 SF 2,238 SF 33% COMPLIES [R-2] **FOURTH** 32.8% COMPLIES 40.4% COMPLIES WEST BUILDING 2,381 SF 2,238 SF

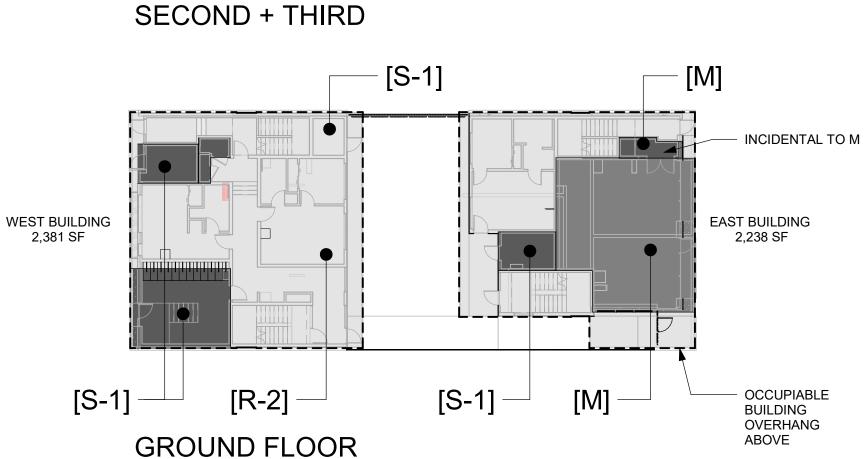

[R-2]

05 GROSS AREA & OCCUPANCY DIAGRAMS

1" = 20'-0"

EXISTING TWO

STORY HOME

