Development Services

From Concept to Construction

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More Contact Info (http://www.portlandoregon.gov//bds/article/519984)





APPEAL SUMMARY

Status: Decision Rendered - Reconsideration of ID 26419

Appeal ID: 26449	Project Address: 1784 NW Northrup St
Hearing Date: 1/26/22	Appellant Name: Tiffonie Carroll
Case No.: B-008	Appellant Phone: 5034847745
Appeal Type: Building	Plans Examiner/Inspector: John Cooley
Project Type: commercial	Stories: 7 Occupancy: B, M, R-2, S-2 Construction Type: Type I-A and Type III-A
Building/Business Name: North 18	Fire Sprinklers: Yes - throughout
Appeal Involves: Erection of a new structure	LUR or Permit Application No.: 20-161043-CO
Plan Submitted Option: pdf [File 1] [File 2] [File 3]	Proposed use: multifamily

APPEAL INFORMATION SHEET

Appeal item 1

Code Section 2019 OSSC Table 601

Requires Table 601: Primary structural frame for Type III-A is required to be 1hr construction.

Code Modification or Alternate Requested

We ask that the primary structural frame for the amenity deck trellis not be required to be 1hr construction, and instead to be non-combustible.

Proposed Design

Building Construction at levels 1 & 2 are construction Type I-A. Levels 3 thru 7 are Type III-A. Occupancy at the amenity deck on level 3 is A-3. The building is fully sprinklered. The level 3 deck is 2hr rated concrete with sand and pavers.

The trellis canopy structure at level 3 is open on 3 sides, and has a glass canopy for about 165 sf (the entire amenity deck is about 2267 sf). The glass canopy is 10' above finish floor, and is open on 3 sides: total open area is over 400 sf of open area, more than 2.5x the area of the glass canopy. Sprinklers for the trellis are not required nor proposed.

The small glass canopy is provided as a rain cover for the bbq's and a few tables so the deck can be useable during inclement weather.

The trellis is made of steel and glass (noncombustible), and is supported by HSS 6x6x5/16 columns. There is a 2hr rated wall at the south end of the trellis that extends 2'-6" above the highest point of the glass canopy (only 1hr is required per table 602).

The trellis structure is isolated from the building structure and only supports trellis components.

Reason for alternative Our trellis is not constructed over exterior walls, has no roof deck, nor thermal barriers. It has low risk of heat and smoke containment due to the fact that it is open on 3 sides.

The trellis columns should not be required to be rated because in the event of a fire people will not congregate below the 165sf canopy – they will walk towards the exits and evacuate the deck.

There are no walls restricting egress nor smoke at the trellis. We propose protection to the south with a 2hr wall (1hr required) and to construct the trellis and canopy with non-combustible materials. In the event of a fire at the neighboring property the area beneath the trellis will be protected and people can evacuate the amenity deck via the 2 egress paths provided.


Reference appeal # 26124 and 1244 (appeal 1)

APPEAL DECISION

Omission of fire rated construction of Level 3, Type IIIA roofed trellis: Granted as proposed.

The Administrative Appeal Board finds that the information submitted by the appellant demonstrates that the approved modifications or alternate methods are consistent with the intent of the code; do not lessen health, safety, accessibility, life, fire safety or structural requirements; and that special conditions unique to this project make strict application of those code sections impractical.

Pursuant to City Code Chapter 24.10, you may appeal this decision to the Building Code Board of Appeal within 90 calendar days of the date this decision is published. For information on the appeals process, go to www.portlandoregon.gov/bds/appealsinfo, call (503) 823-7300 or come in to the Development Services Center.

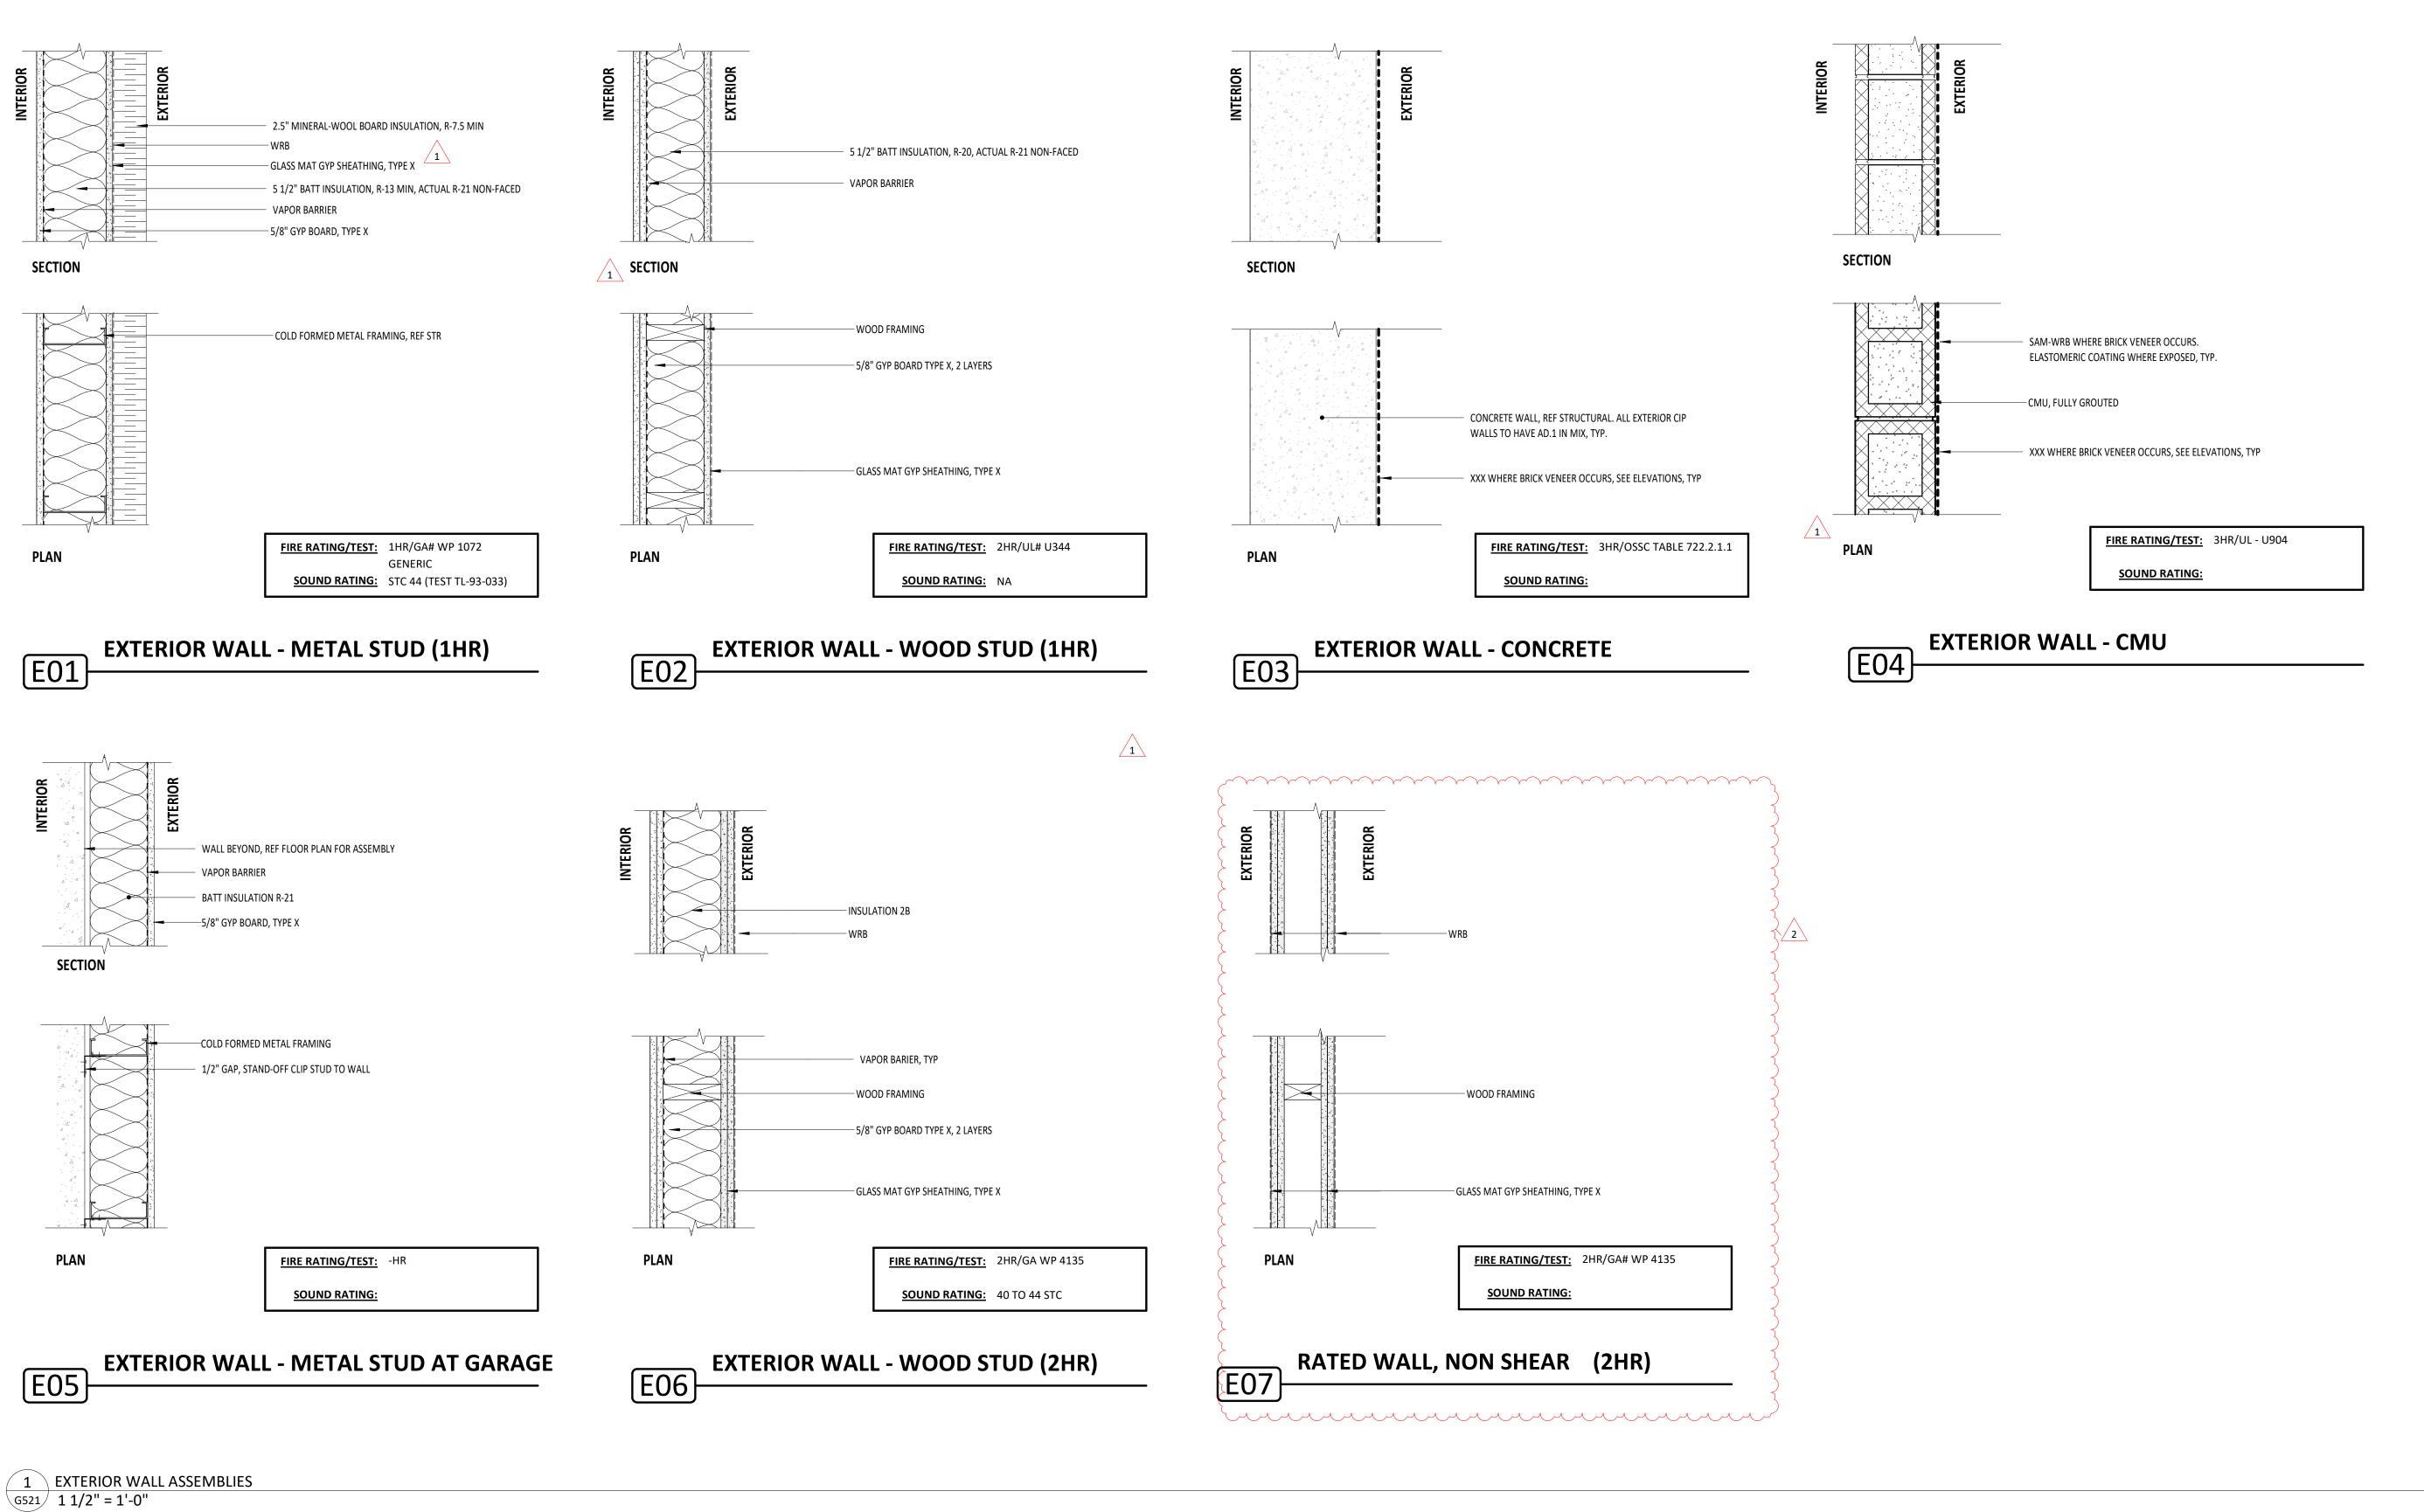

GENERAL NOTES

1 HORIZONTAL AND VE

- HORIZONTAL AND VERITCAL ASSEMBLIES SHALL REFERENCE THE FOLLOWING DOCUMENTS:
 1.OREGON STRUCTURAL SPECIALTY CODE (OSSC)
 2.FIRE RESISTENCE DESIGN MANUAL (GA)
- 3.UNDERWRITER LABORATORIES (UL)
 4. OTHER APPROVED TESTING AS PERMITTED BY THE OSSC
 2. CONTRACTOR & SUBCONTRACTOR ARE RESPONSIBLE FOR OBTAINING AND CONSTRUCTING THE ASSEMBLIES AS PRESCRIBED IN THE SPECIFIED SOURCE DOCUMENTATION REPORT.
- SEE FLOOR PLAN DRAWINGS FOR WALL TYPE LOCATIONS.
 PROVIDE ACOUSTICAL SEAL AT FLOOR/CEILING TRANSITIONS, RECESSED BOXES, AND PENETRATIONS OF SOUND RATED PARTITIONS AND OTHER CONSTRUCTION AS REQUIRED TO
- PENETRATIONS OF SOUND RATED PARTITIONS AND OTHER CONSTRUCTION AS REQUIRED TO ACHIEVE WALL TYPE STC.

 5. MAINTAIN FIRE RATING OF WALLS AROUND FIRE EXTINGUISHER CABINETS, AND OTHER
- MAINTAIN FIRE RATING OF WALLS AROUND FIRE EXTINGUISHER CABINETS, AND OTHER RECESSED ITEMS. FRAME AROUND BEAMS AND OTHER STRUCTURAL ELEMENTS WHEN THEY OCCUR WITHIN THE SPACE OF A FIRE RATED OR ACOUSTICAL PARTITION.
- PLAN DIMENSIONS ARE TO FACE OF STUD, CENTERLINE OF COLUMN, OR FACE OF CONCRETE UNLESS NOTED OTHERWISE.
 SEE FINISH SCHEDULE, INTERIOR ELEVATIONS, AND DETAILS FOR FINISHES AND SPECIAL
- CONDITIONS.
- 8. AT FIRE RATED WALLS PROVIDE UL SYSTEM# HW-D-0491 FOR JOINT @ HEAD OF WALL, (1,2,3 HR) UNLESS NOTED OTHERWISE.
- 9. AT FIRE RATED WALLS PROVIDE UL SYSTEM# W-L-1252 FOR PENETRATIONS , (1,2,3 HR) UNLESS NOTED OTHERWISE.

STAMP

STAMP

ALEXANDER J. YALE

PORTLAND, OREGON

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BDS MBP Checksheet 10.28.2021
BDS MBP Checksheet 01.02.2022

TRUE PLAN NORTH

NORTH 18

HMS NORTH18, LLC

NW NORTHRUP STREET & NW 18TH AVE

ISSUANCE
90% v2.0 HUD / Permit Set
PROJECT NUMBER

DATE
April 19, 2021
FULL SHEET SIZE


30 X 42

DRAWING TITLE


EXTERIOR WALL ASSEMBLIES

SHEET NUMBER

G521

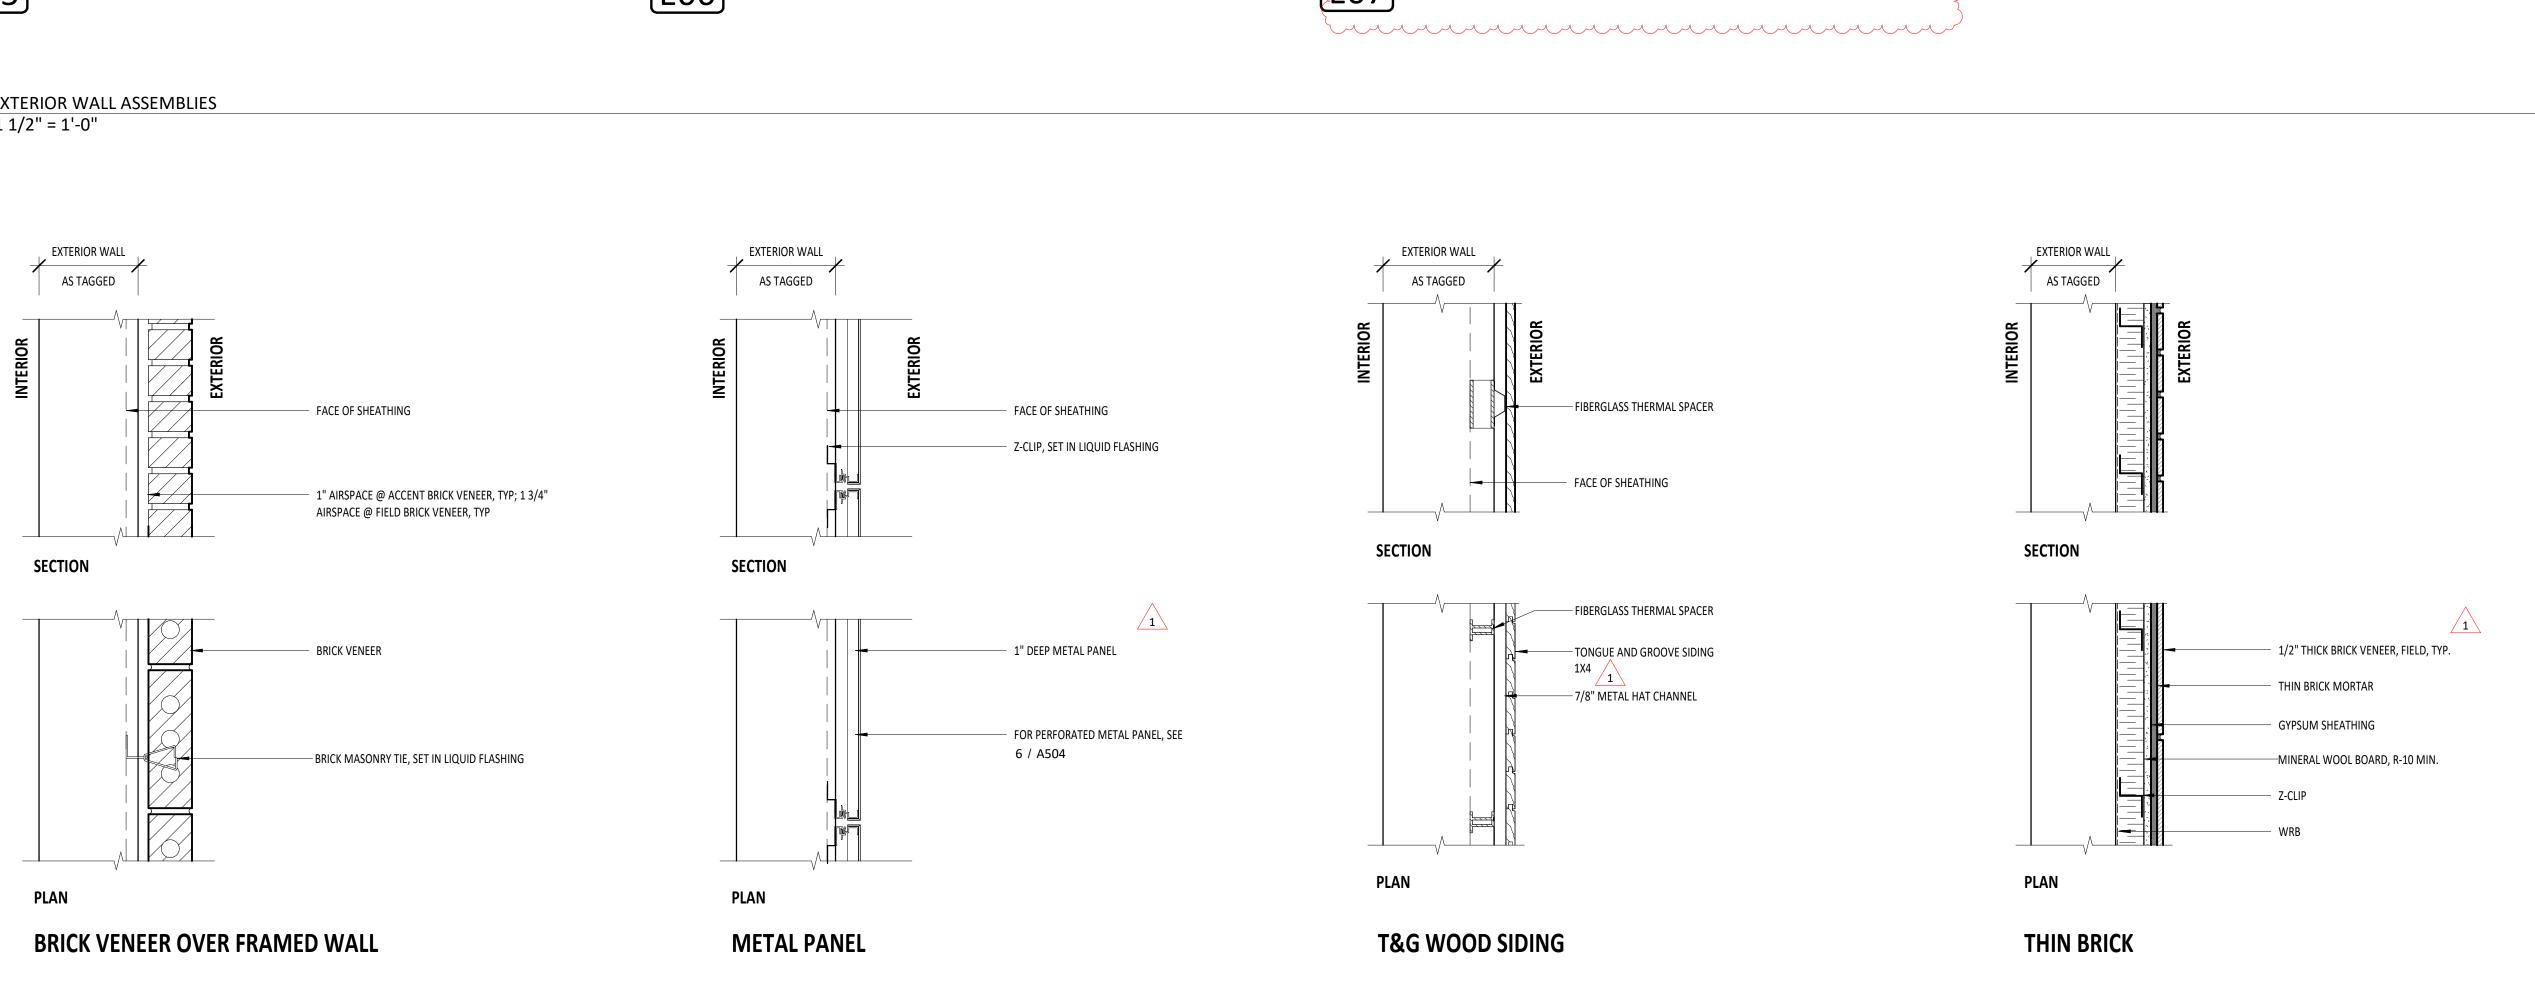

2 SKIN TYPES G521 1 1/2" = 1'-0"

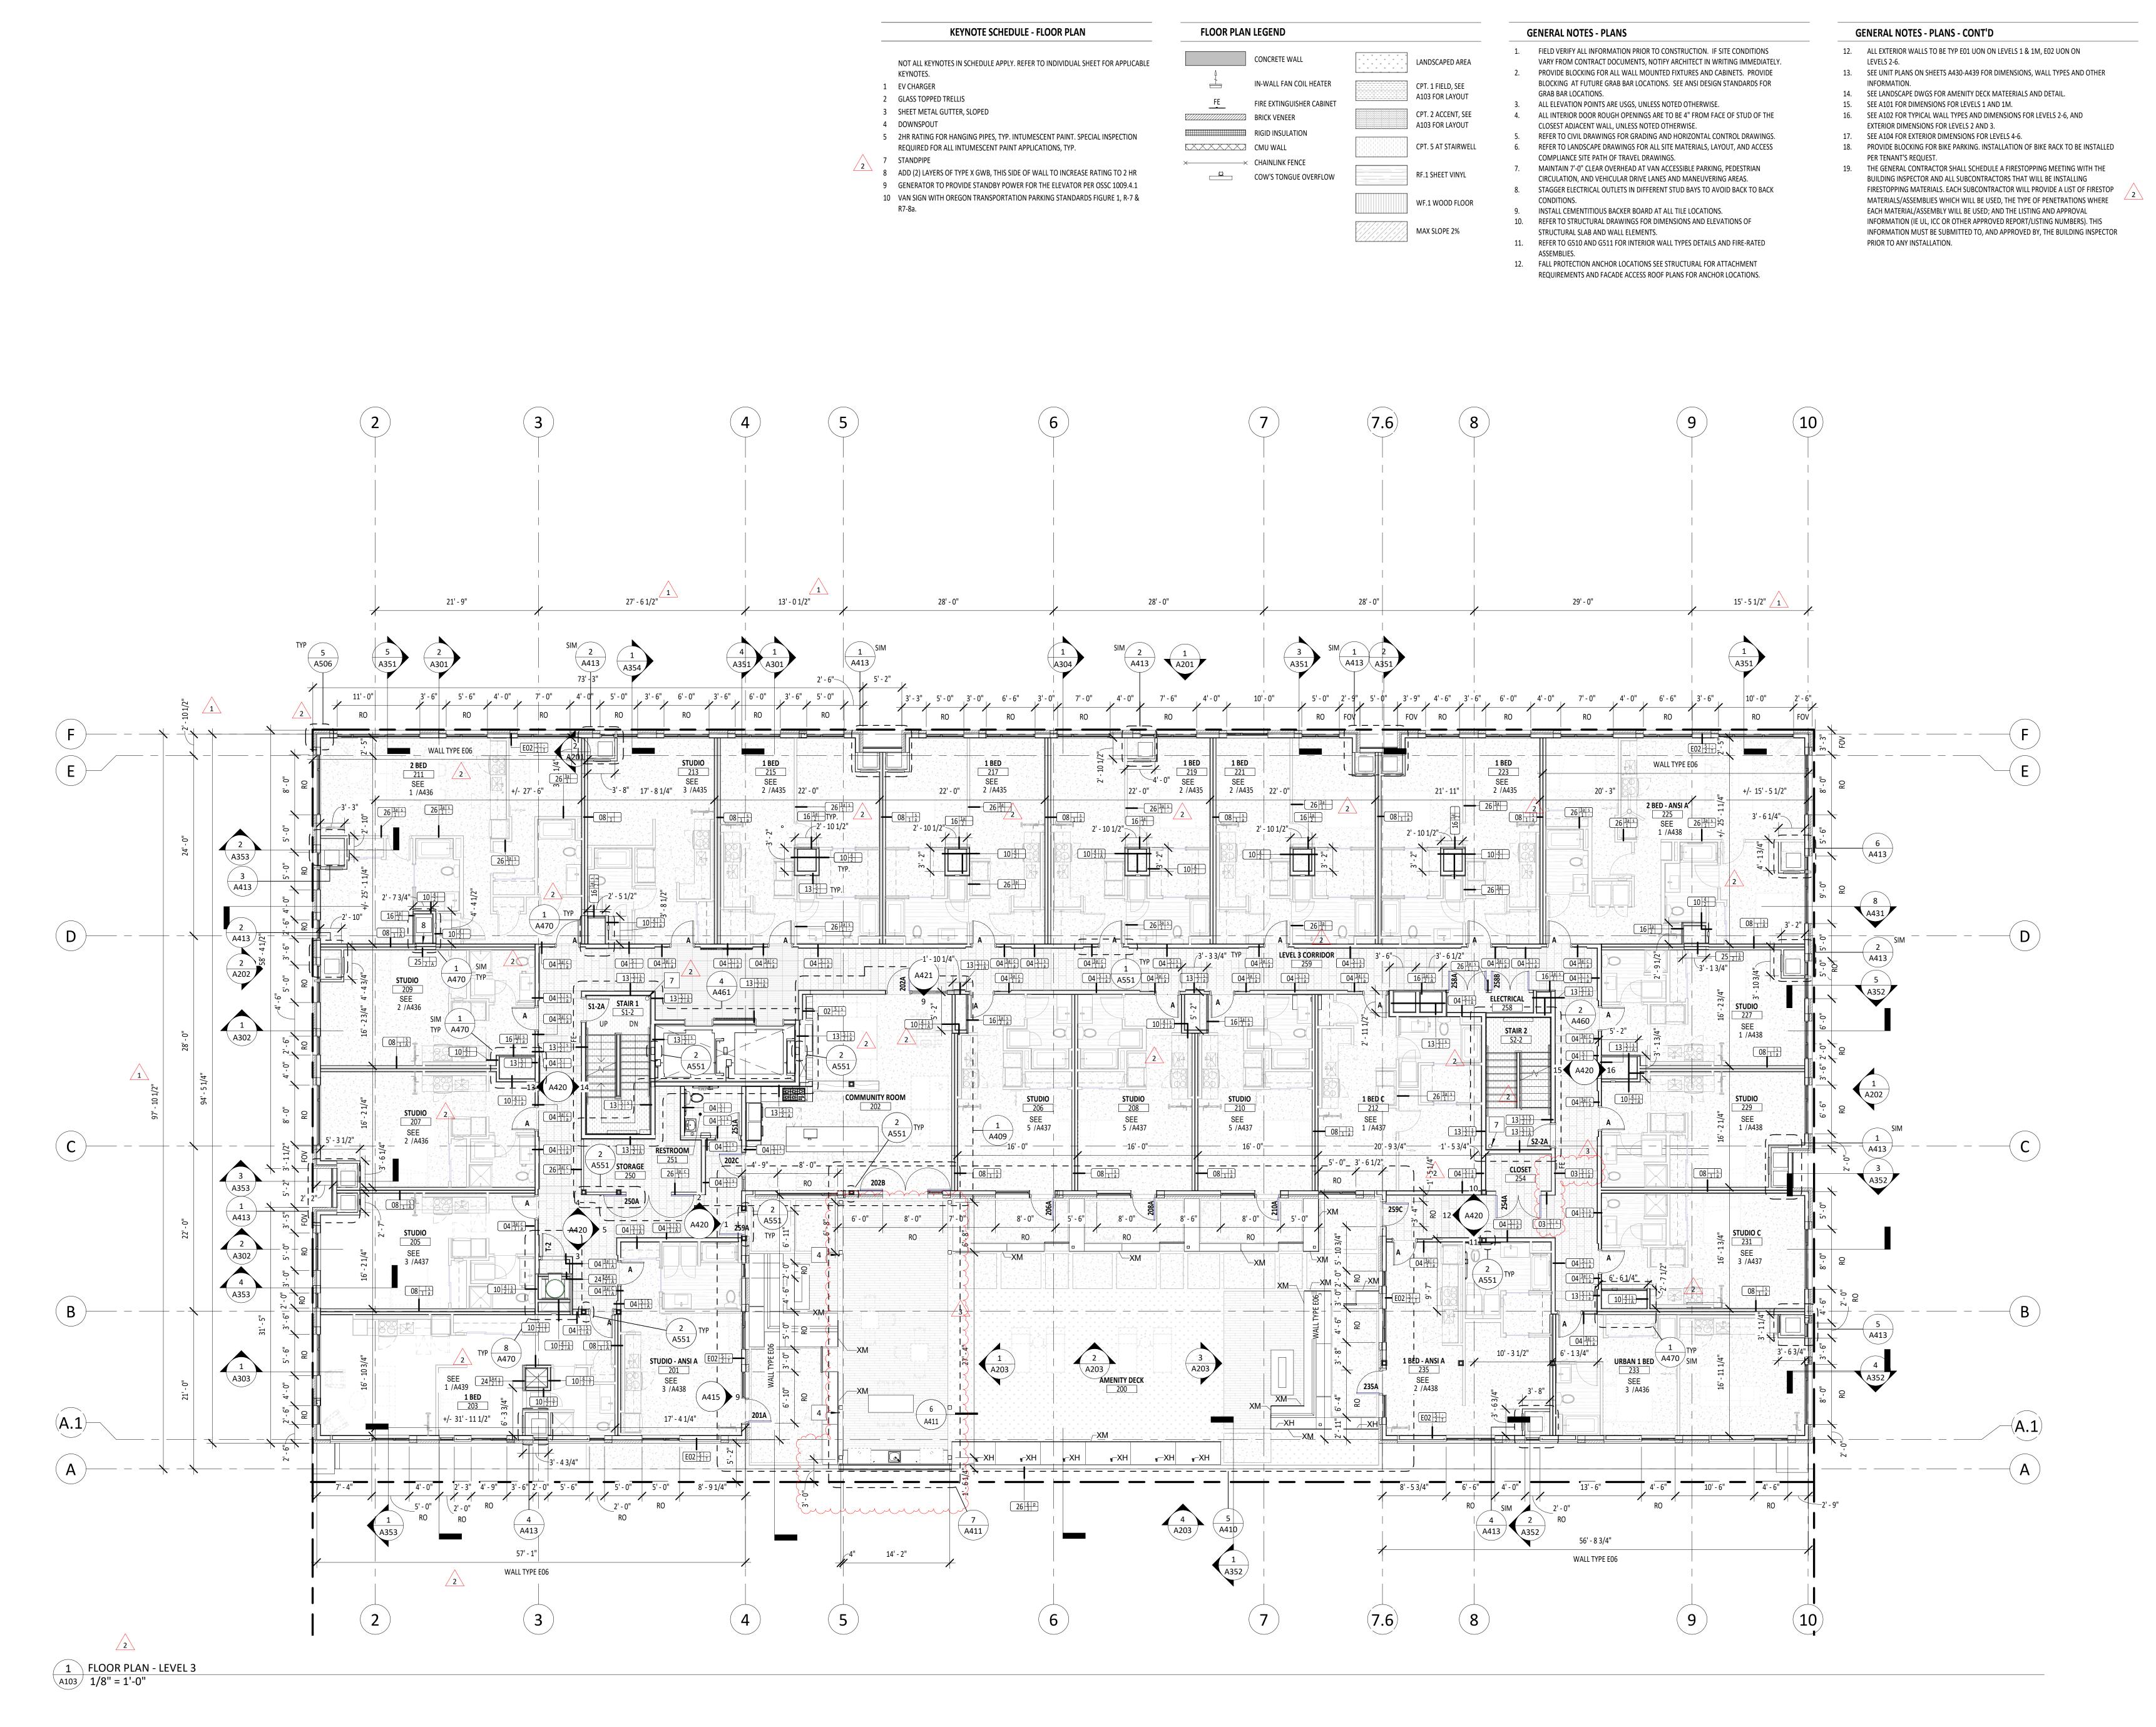



ALEXANDER J. YALE PORTLAND, OREGON OF OREGON

PC ASI 03 09.24.2021
BDS MBP Checksheet 10.28.2021
BDS MBP Checksheet 01.02.2022

TRUE PLAN NORTH

NORTH 18

HMS NORTH18, LLC
NW NORTHRUP STREET & NW 18TH AVE

90% v2.0 HUD / Permit Set

PROJECT NUMBER
200080

DATE
April 19, 2021

April 19, 2021

FULL SHEET SIZE

30 X 42

DRAWING TITLE

FLOOR PLAN - LEVEL 3

SHEET NUMBER

A103 ^2

KEYNOTE SCHEDULE - TRELLIS

- NOT ALL KEYNOTES IN SCHEDULE APPLY. REFER TO INDIVIDUAL SHEET FOR APPLICABLE
- 2 GLASS TOPPED TRELLIS
- 3 SHEET METAL GUTTER, SLOPED
- 4 DOWNSPOUT
- 5 TEMPERED GLAZING OR LAMINATED GLASS WITH A MINIMUM OF 30-MIL POLYVINYL **BUTYRAL INTERLAYER**



BDS MBP Checksheet 10.28.2021 BDS MBP Checksheet 01.02.2022

TRUE PLAN NORTH NORTH 18

HMS NORTH18, LLC NW NORTHRUP STREET & NW 18TH AVE

90% v2.0 HUD / Permit Set

PROJECT NUMBER 200080

DATE **April 19, 2021** FULL SHEET SIZE 30 X 42

DRAWING TITLE COMPOSITE PLANS - TRELLIS

A411