## **Development Services**

### From Concept to Construction







Status: Decision Rend	Cica				
Appeal ID: 24872		Appellant Name: Dan Petrescu  Appellant Phone: 5034845428  Plans Examiner/Inspector: Preliminary  Stories: 10 Occupancy: Group B Construction Type: Type: II-B  Fire Sprinklers: Yes - existing building is fully sprinklered  LUR or Permit Application No.: Preliminary - pre-permit application submittal			
Hearing Date: 5/19/21  Case No.: B-001  Appeal Type: Building  Project Type: commercial  Building/Business Name: Studio Building  Appeal Involves: Alteration of an existing structure					
			Plan Submitted Option	n: pdf [File 1]	Proposed use: Group B (existing, no change)
			Appeal item 1 Code Section	ASHRAE 90.1 - Section 3 Definitions	
			Requires	In Section 3 - Definitions, ASHRAE defines a "roof" as: "Upper portion of the building envelope, including opaque areas and fenestrations, that is horizontal and tilted at an angle of less than 60 degrees from horizontal."	
			Code Modification or Alternate Requested	Confirm that the upper level exterior tilted walls of the Studio Building are classified as a "wall" not a "roof" based on the definition for "roof".	
			Proposed Design	The owner is proposing a building repair - to replace the existing metal standing seam panels at the upper level tilted walls with new metal standing seam panels. The existing upper level exterior tilted walls were designed to appear as a roof. However, they are tilted wall because the vertical surfaces are greater than 60 degrees from vertical.	
Reason for alternative	With this appeal we are requesting degrees from vertical be classified	confirmation that the exterior surfaces with tilt greater than 60 as a "wall" not a "roof".			
	We are not asking for an alternative, we are asking for confirmation of this ASHRAE section.				
Appeal item 2					
Code Section	ASHRAE 90.1 - Section 5.1.3 - Env	velope Alterations			
Requires	"Alterations to the building envelope need to comply with the requirements of Section 5 for insulationapplicable to those specific portions of the building that are being altered"				

Exception to Section 5.1.3 - Envelope Alterations

Exception 4 - The following need not comply with these requirements provided such alterations will not increase the energy use of the building.

"Alterations to walls and floors, where the existing structure is without framing cavities and no new framing cavities are created"

#### Code Modification or Alternate Requested

No proposed alternate. We are asking that this exception applies to our project.

#### **Proposed Design**

The owner is proposing a building repair - to replace the existing metal standing seam panels at the upper level tilted walls with new metal standing seam panels because the existing metal panels are deteriorated. The existing upper level exterior tilted walls are "walls" because the vertical surfaces of the top level are greater than 60 degrees from vertical.

The existing building structure is a solid cast-in place concrete tilted wall without roof cavities.


Reason for alternative With this appeal we are requesting confirmation that the Exception 4 applies to our project and that the proposed alteration (replace existing standing seam metal panels) does not require compliance with ASHRAE Section 5, and that additional insulation is not required. The building energy use will not be increased.

#### APPEAL DECISION

- 1. Determination of exterior tilted construction as a wall and not a roof: Granted as proposed.
- 2. Omission of insulation in tilted walls as allowed by ASHRAE 90.1: Granted as proposed.

The Administrative Appeal Board finds that the information submitted by the appellant demonstrates that the approved modifications or alternate methods are consistent with the intent of the code; do not lessen health, safety, accessibility, life, fire safety or structural requirements; and that special conditions unique to this project make strict application of those code sections impractical.

Pursuant to City Code Chapter 24.10, you may appeal this decision to the Building Code Board of Appeal within 90 calendar days of the date this decision is published. For information on the appeals process, go to www.portlandoregon.gov/bds/appealsinfo, call (503) 823-7300 or come in to the Development Services Center.

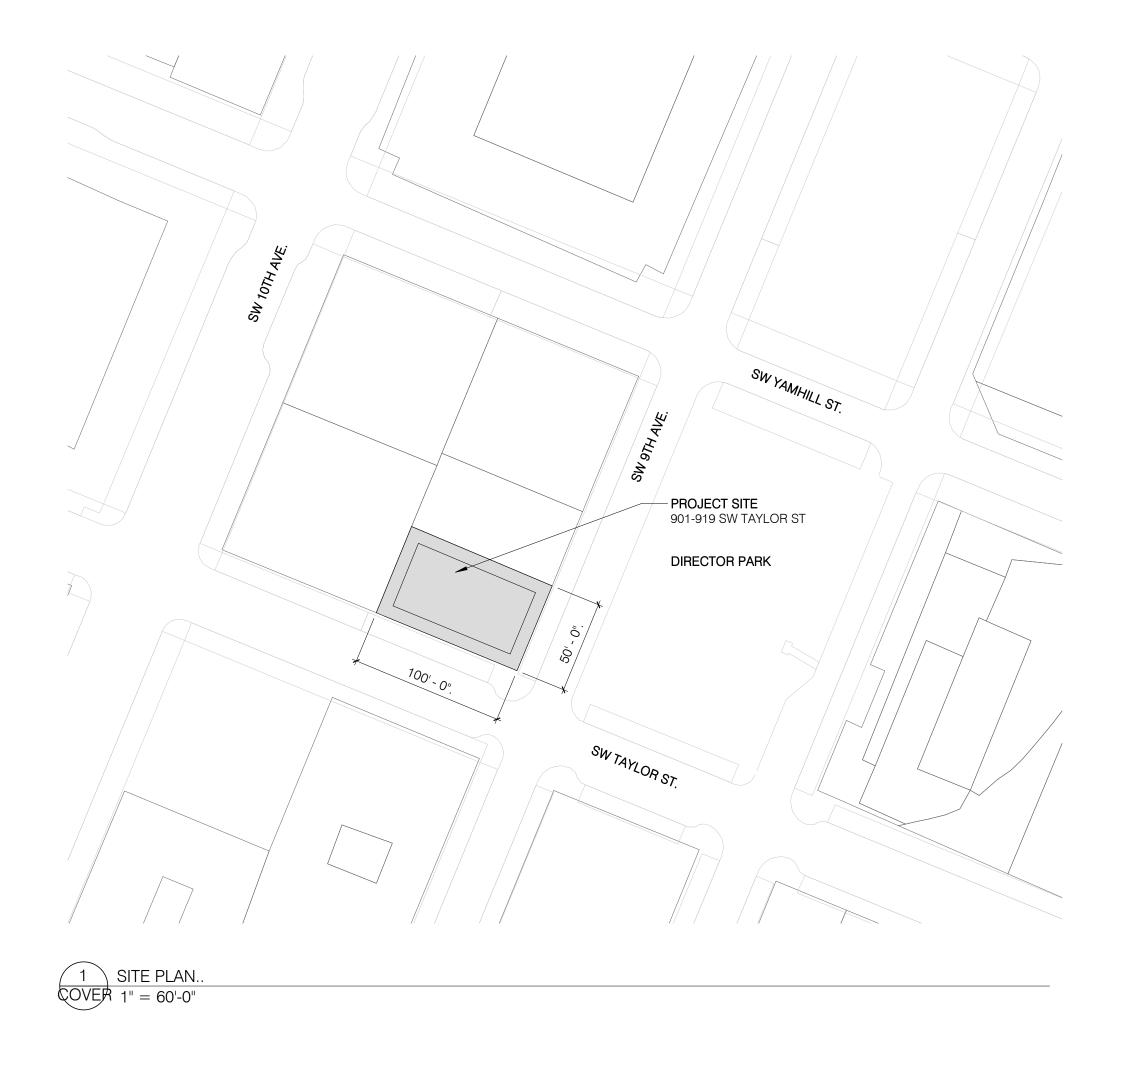

# DRAWING SHEET INDEX

COVER SHEET

ARCHITECTURAL

A000 DEMOLITION ROOF PLAN A001 REFERENCE ELEVATIONS

REFERENCE ELEVATIONS DEMOLITION ELEVATIONS -SOUTH & EAST A102 DEMOLITION ELEVATIONS -NORTH & WEST

ENLARGED ELEVATIONS -SOUTH & EAST A302 ENLARGED ELEVATIONS -WEST & NORTH

A802 DETAILS A803 DETAILS

# PROJECT DIRECTORY

### OWNER

TMT DEVELOPMENT 760 SW 9TH AVE SUITE 2250 PORTLAND, OR 97205 CONTACT: ADAM PUSHKAS 503.241.1111 ADAM@TMTDEVELOPMENT.COM

# ARCHITECT

HENNEBERY EDDY ARCHITECTS, INC 921 SW WASHINGTON STREET PORTLAND, OR 97205 CONTACT: DAN PETRESCU 503.227.4860 DPETRESCU@HENNEBERYEDDY.COM

## **ROOF CONSULTANT**

PROFESSIONAL ROOF CONSULTANTS, INC 1108 SE GRAND AVE SUITE 300 PORTLAND, OR 97214 CONTACT: BRUCE RYAN 503.280.8759 DPETRESCU@HENNEBERYEDDY.COM



# Hennebery Eddy

921 SW WASHINGTON STREET SUITE 250 PORTLAND OREGON 97205 503 227 4860 TEL 503 227 4920 FAX www.henneberyeddy.com TMT DEVELOPMENT

STUDIO BUILDNG - METAL PANELS REPLACEMENT 919 SW TAYLOR ST PORTLAND, OR 97205

HEA Project no. 04.01.2021 50% CONSTRUCTION DOCUMENTS


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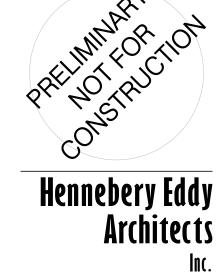
3 REFERENCE ELEVATION -SOUTH A001 1" = 10'-0"



1 REFERENCE ELEVATION -EAST A001 1" = 10'-0"

1 A302 ENLARGED ELEVATION, PROPOSED

1 ENLARGED ELEVATION, DEMOLITION

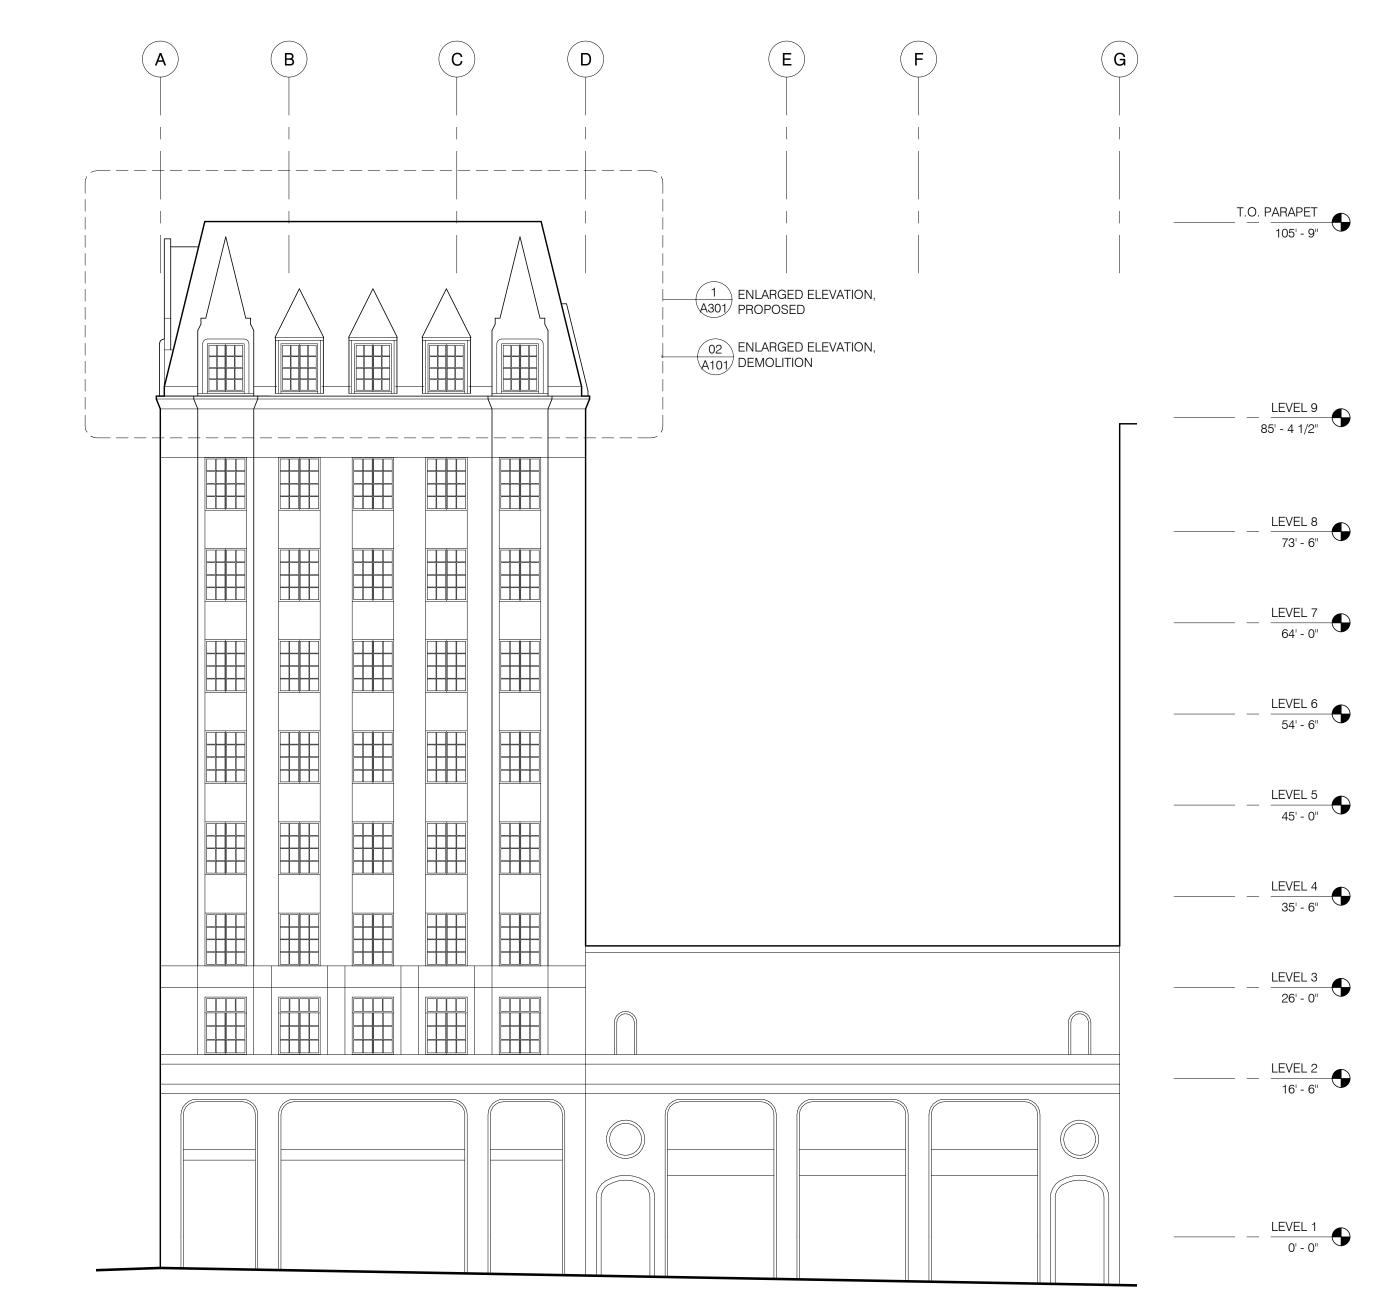


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REFERENCE **ELEVATIONS** 



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503 227 4920 FAX
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REFERENCE **ELEVATIONS** 

1 REFERENCE ELEVATION -WEST A002 1" = 10'-0"

2 REFERENCE ELEVATION -NORTH A002 1" = 10'-0"

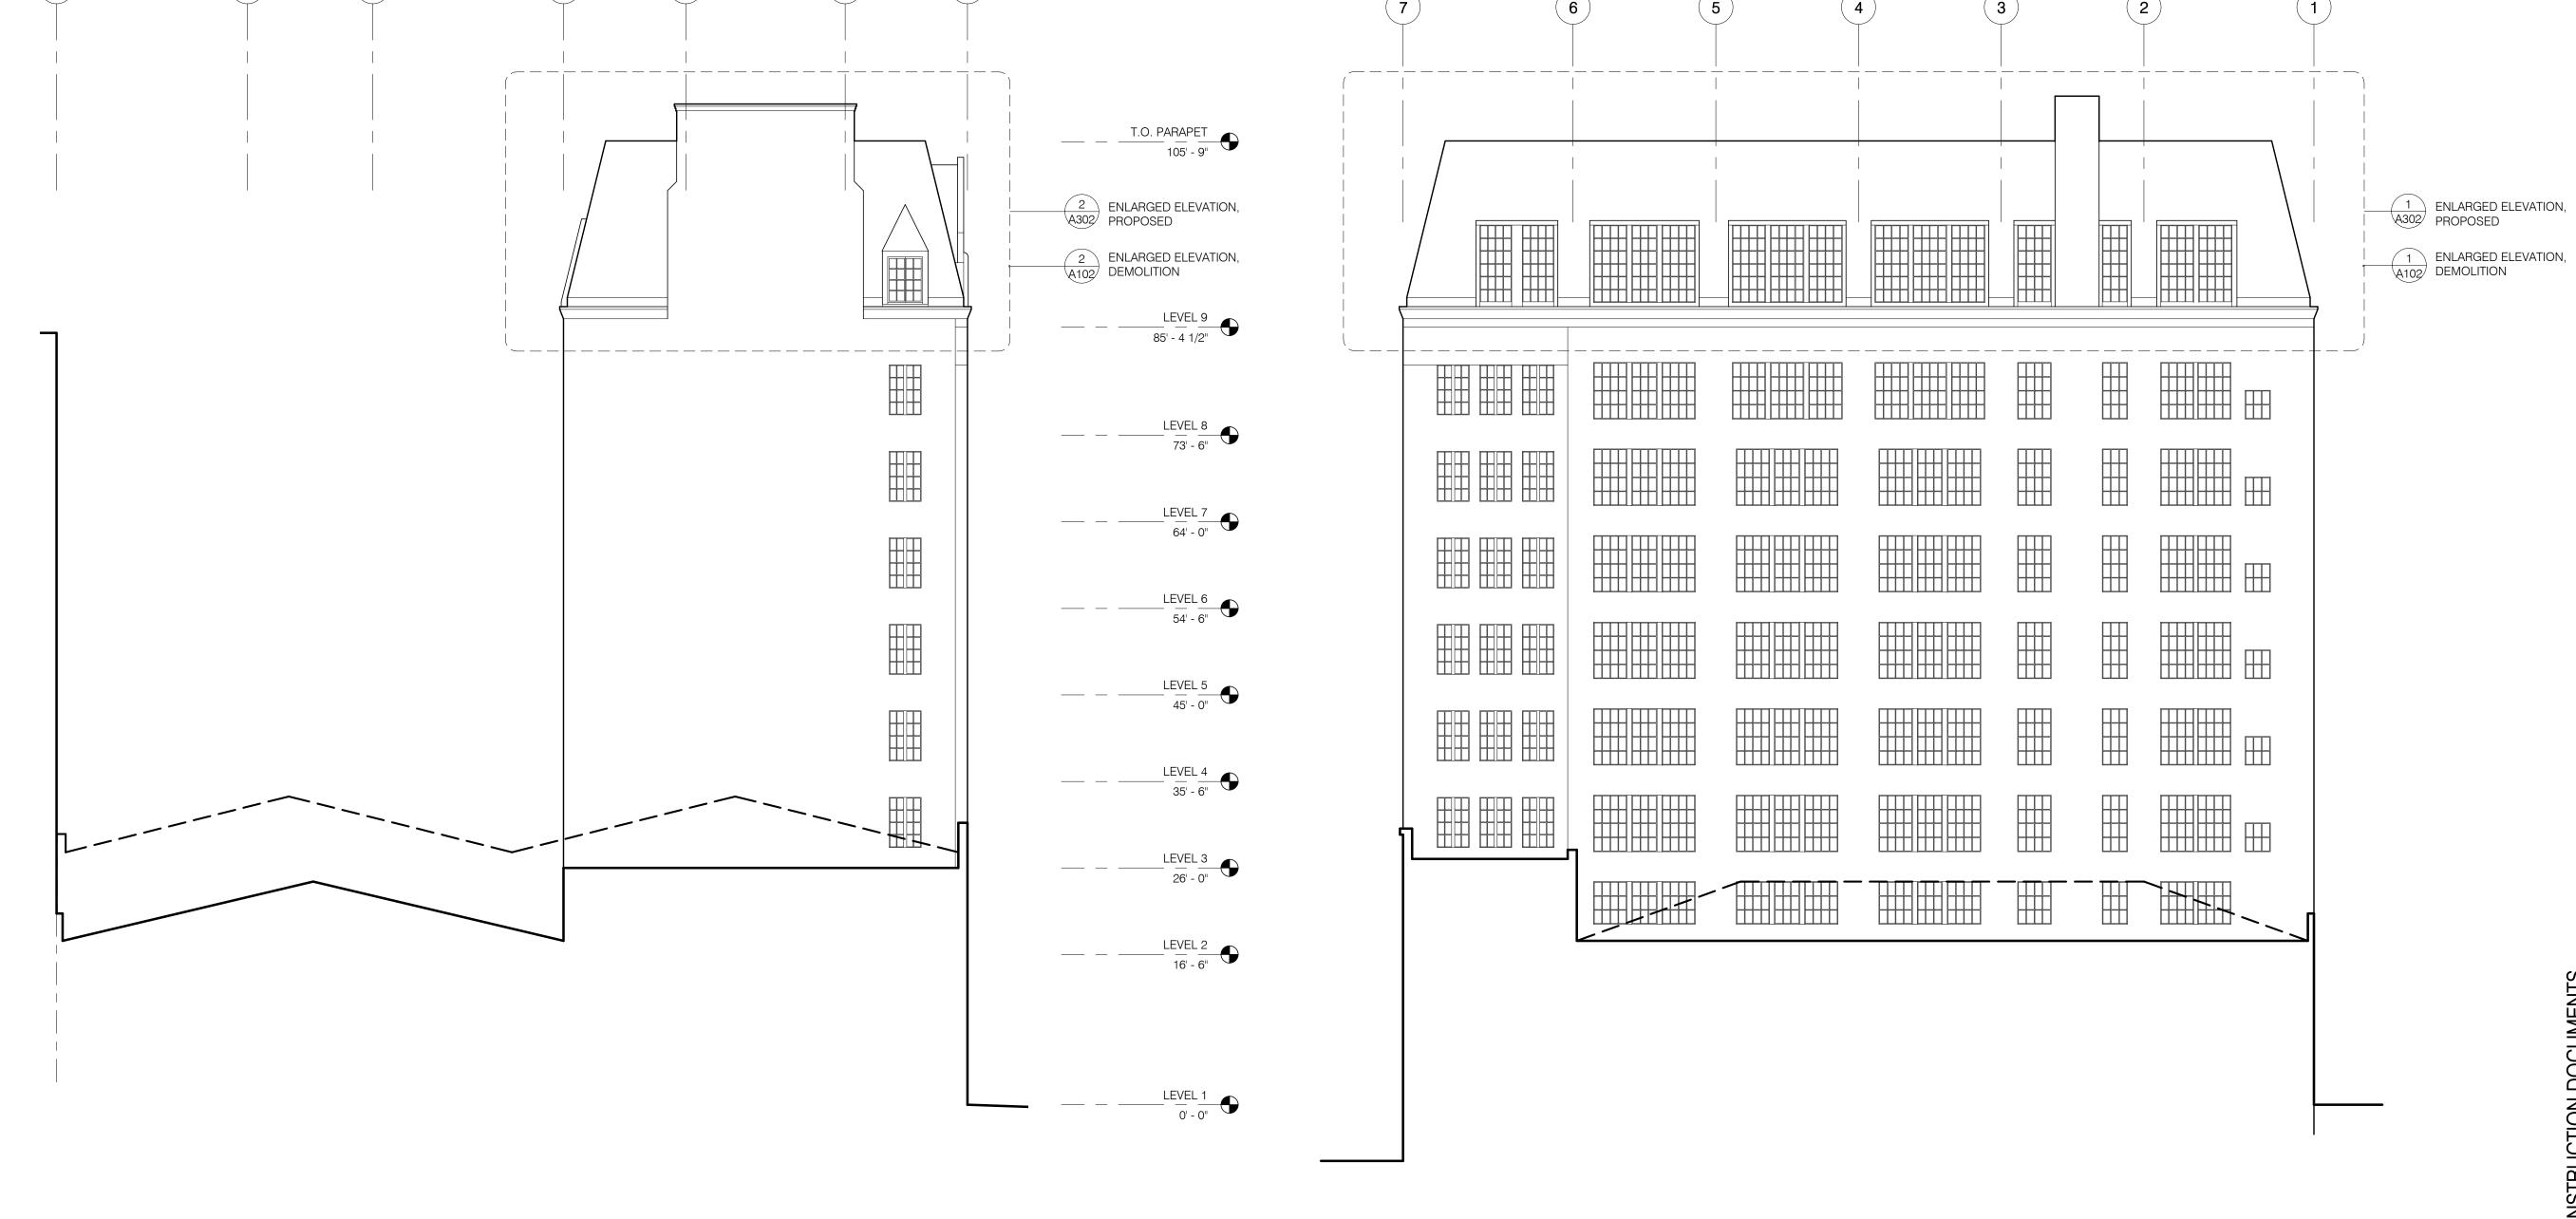
(A)

05 A801

1 ELEVATION -EAST A301 1/4" = 1'-0"

# **EXTERIOR ELEVATION NOTES**

- 1. SEE SHEET AG00 FOR GENERAL NOTES.
- 2. GRADE LINES INDICATED ARE APPROXIMATE AND SHOWN FOR REFERENCE ONLY. REFER TO CIVIL AND LANDSCAPE DRAWINGS FOR GRADING INFORMATION.
- 3. LINE OF FOUNDATIONS (SHOWN DASHED) ARE APPROXIMATE AND SHOWN FOR REFERENCE ONLY. REFER TO STRUCTURAL DRAWINGS FOR FOOTING ELEVATIONS.
- 4. DIMENSIONS ARE SHOWN TO DIMENSION POINT OF REFERENCED DETAIL WHERE APPLICABLE.
- 5. ALIGN MATERIAL, CONTROL AND EXPANSION JOINTS VERTICALLY AND HORIZONTALLY WITH ADJACENT JOINTS AND DOOR, WINDOW AND LOUVER HEADS/JAMBS/SILLS AS INDICATED ON THE DRAWINGS. VERIFY DIMENSIONS WITH DETAIL CONDITIONS. VERIFY LOCATION AND ALIGNMENT WITH ARCHITECT.
- 6. MOUNTING LOCATION OF DEVICES AS INDICATED, VERIFY WITH ARCHITECT IF NOT INDICATED ON ARCHITECTURAL DRAWINGS.

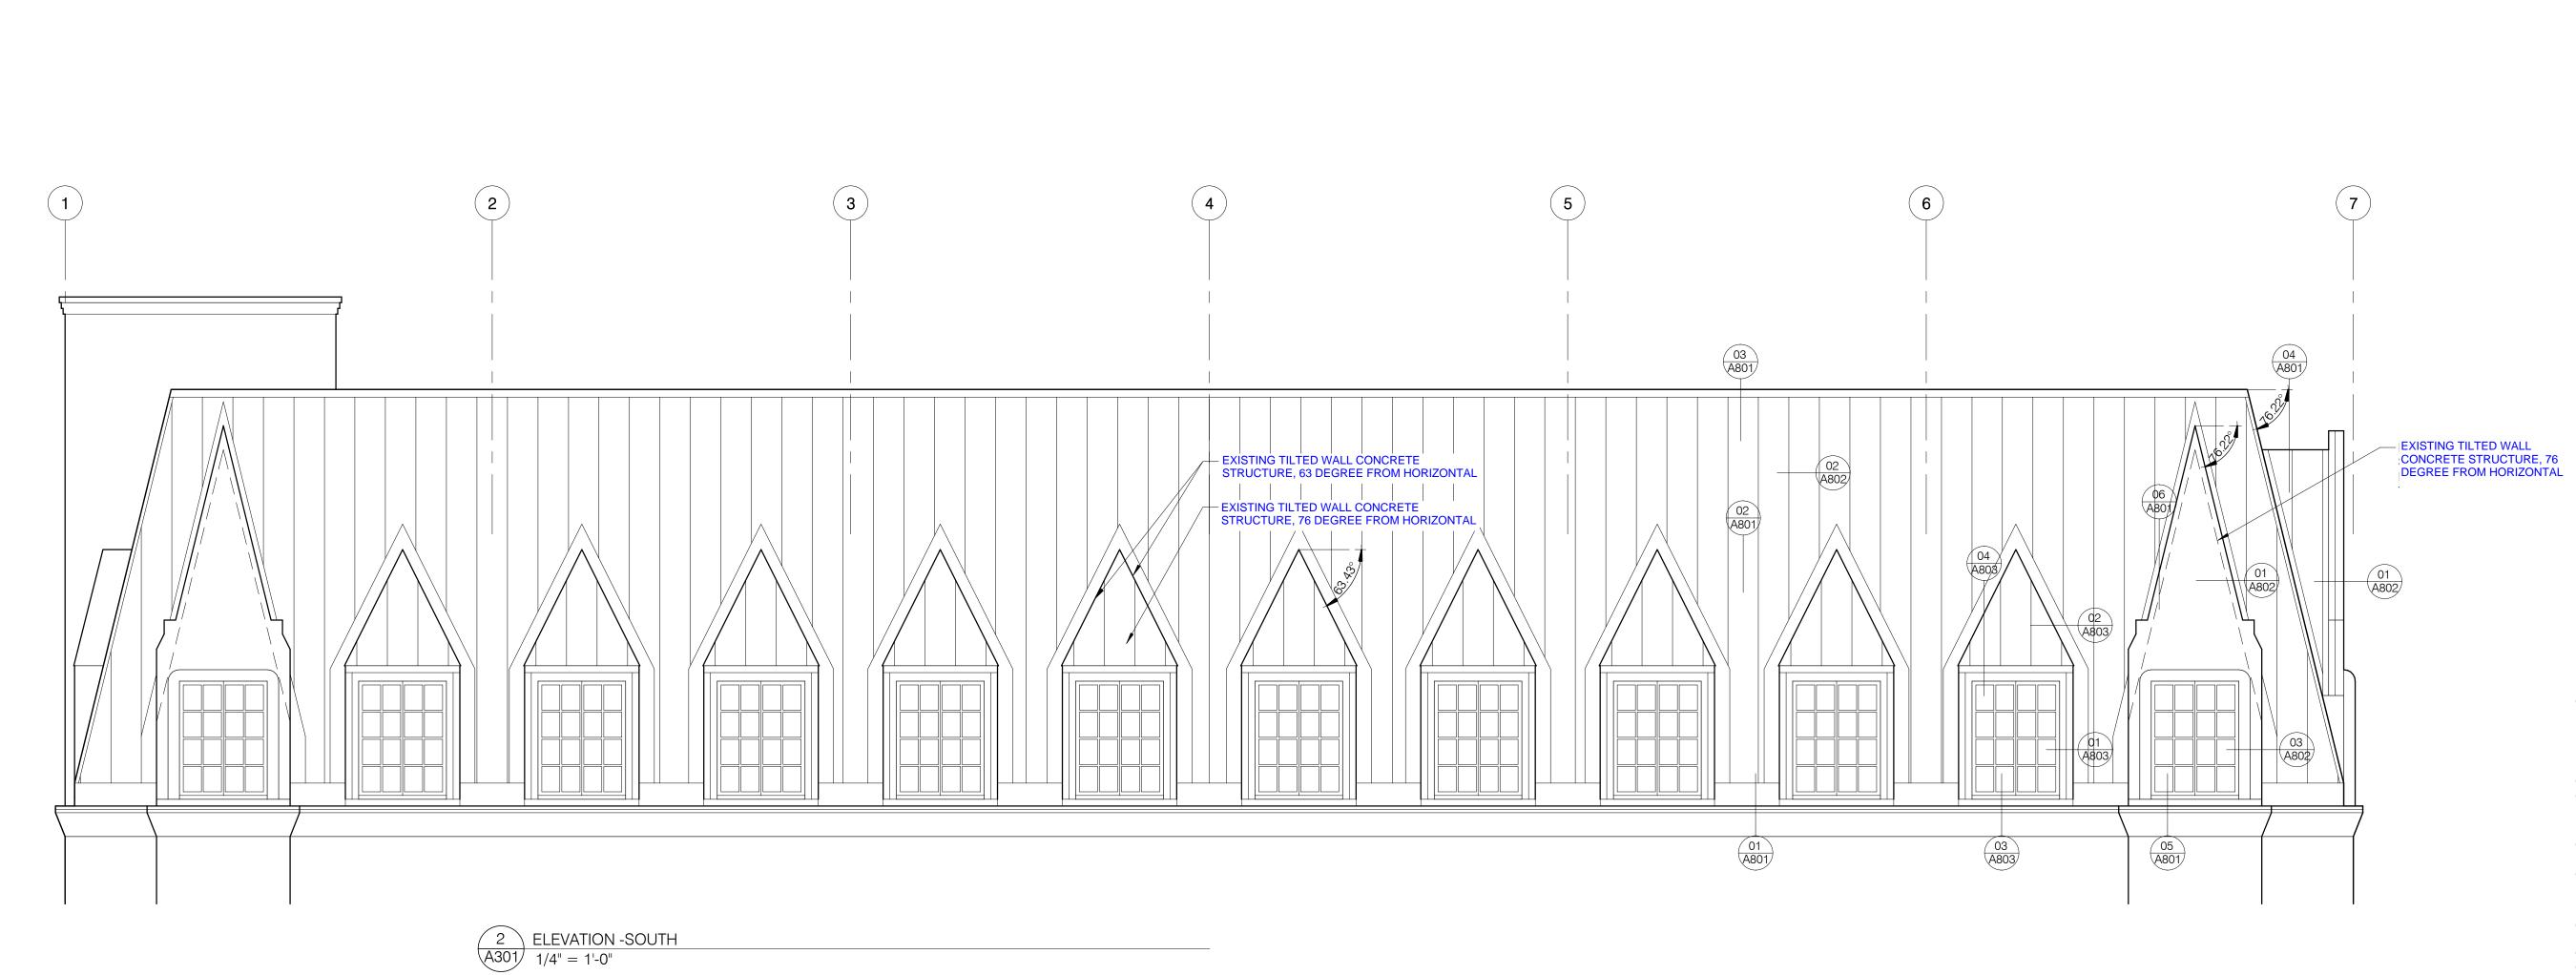

(D)



# Hennebery Eddy Architects

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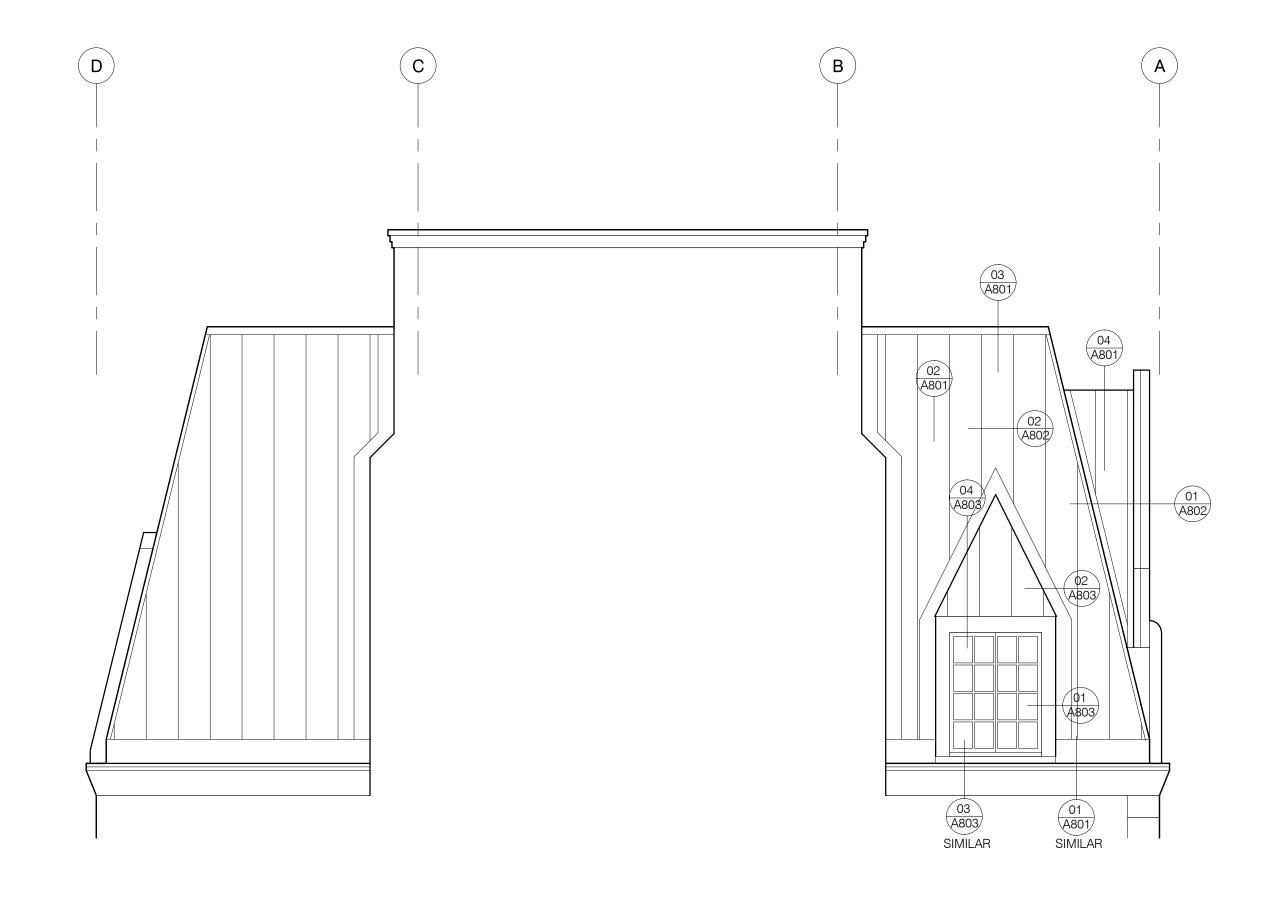
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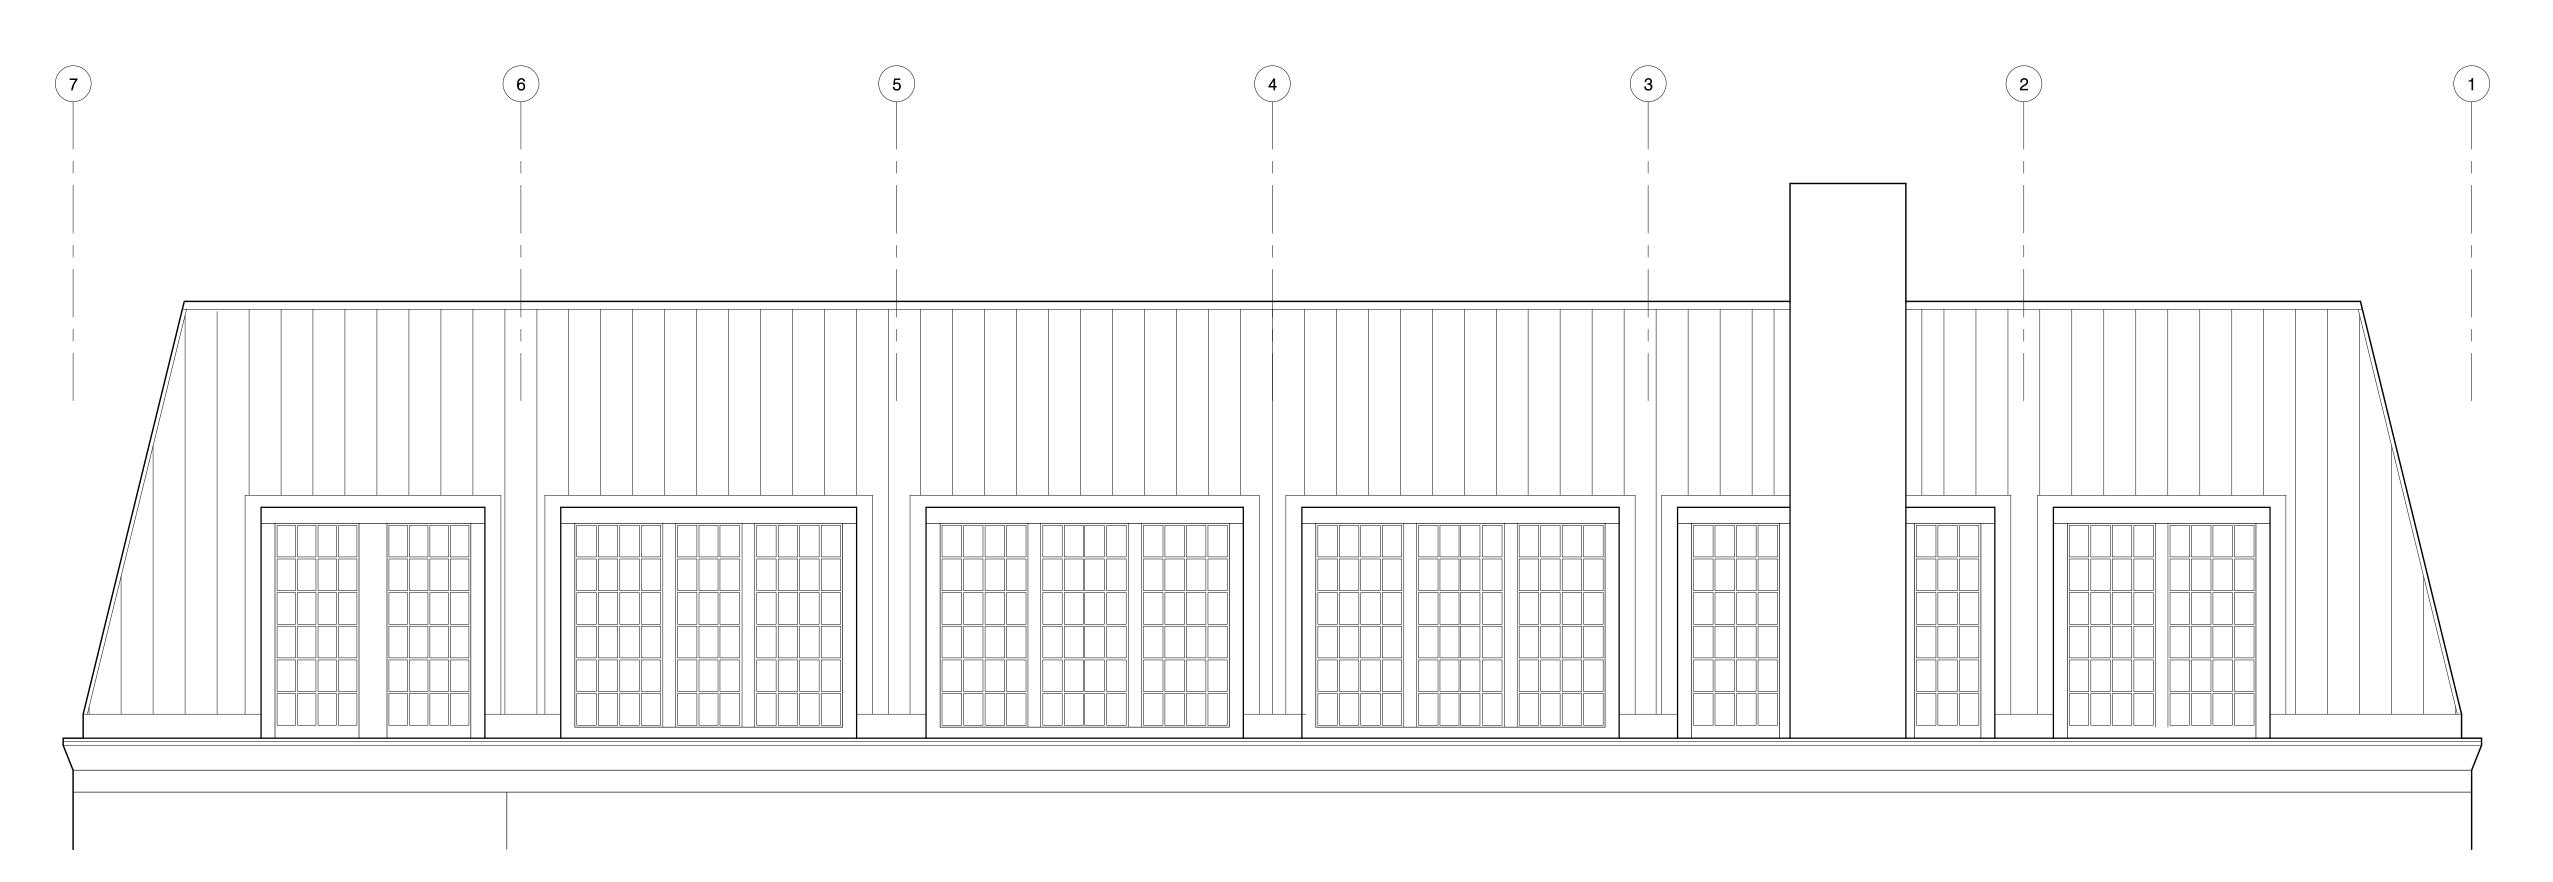
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**ENLARGED ELEVATIONS** -SOUTH & EAST






2 ELEVATION -WEST A302 1/4" = 1'-0"



1 ELEVATION -NORTH A302 1/4" = 1'-0"

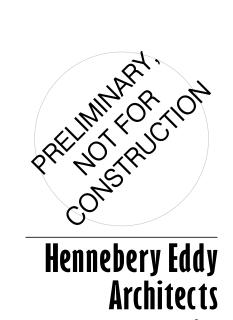

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PORTLAND OREGON 97205
503 227 4860 TEL
503 227 4920 FAX
www.henneberyeddy.com
TMT DEVELOPMENT

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HEA Project no. 20028

Date: 04.01.2021


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DOCUMENTS

Revisions:

Drawn by: Author Checked by: Checker Sheet:

ENLARGED ELEVATIONS
-WEST & NORTH



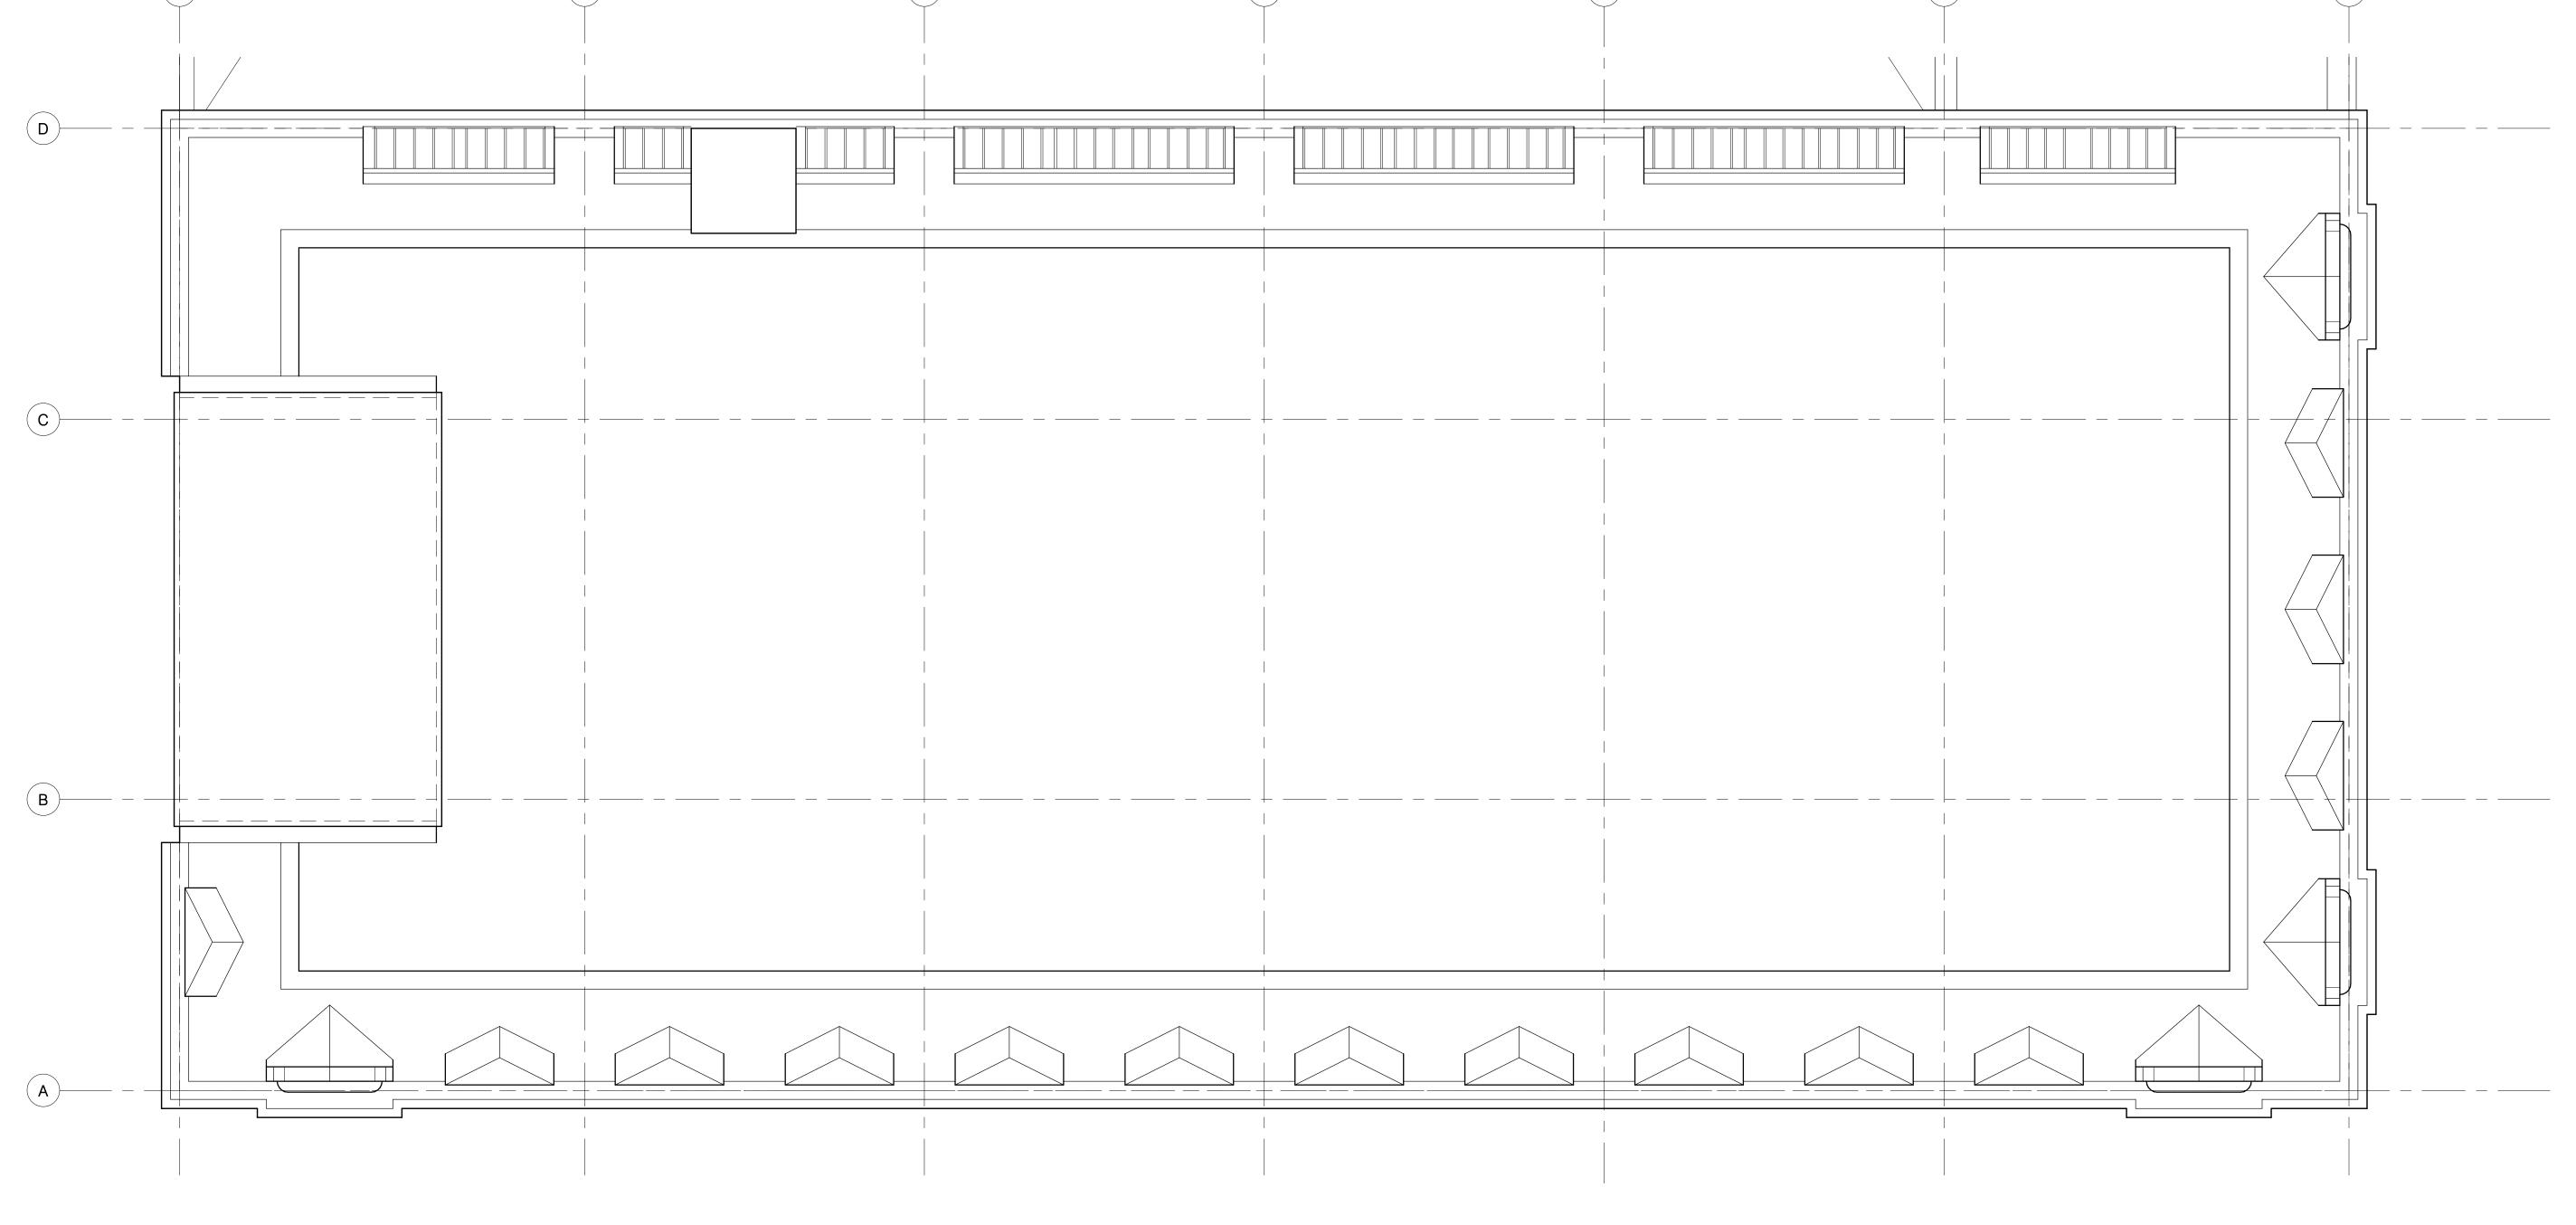

DEMOLITION ROOF PLAN
A000 1/4" = 1'-0"

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DEMOLITION ROOF
PLAN PLAN

