ADJACENT

BUILDING

**ADJACENT** 

BUILDING

**ROOF TOP DECK** 

**TO BE REPLACED** 

# **PROJECT NARRATIVE**

FAIL STRUCTURALLY. AREA OF WORK IS

#### PROJECT DIRECTORY

FH Honeyman Lofts, LLC 2251 Linda Flora Dr. Los Angeles, CA 90077

357 Clackamas, OR 97015

6712 N Cutter Cir. Portland, OR 97217

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### PROJECT INFORMATION


NW QUADRANT OF BLOCK "COTTER BUILDING"

BUILDING AREA OF "COTTER BUILDING": OCCUPANCY GROUP:

**CONSTRUCTION TYPE** 

BUILDING CODE: 2019 OREGON STRUCTURAL SPECIALTY CODE

#### **LOCATION MAP PROJECT LOCATION** (ROOFTOP DECKS)

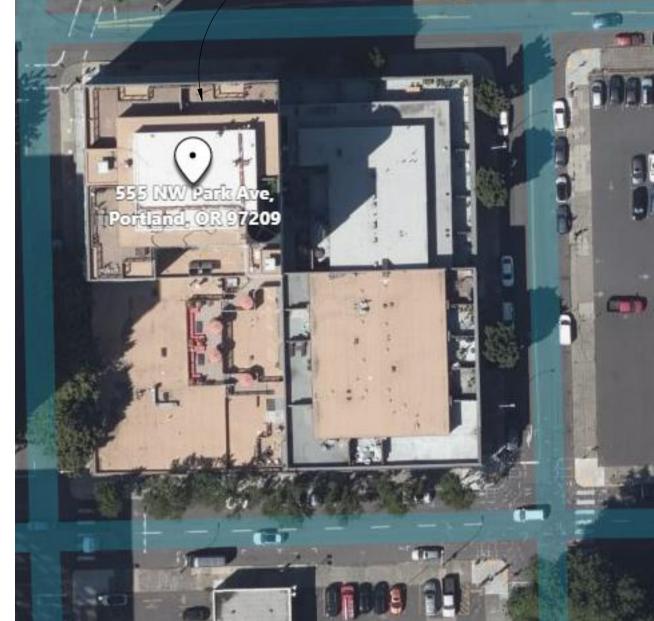

2. THE CONTRACTOR IS RESPONSIBLE FOR CHECKING THE PLANS AND SITE CONDITIONS AND TO NOTIFY THE ENGINEER OF ANY ERRORS OR OMISSIONS PRIOR TO THE START OF CONSTRUCTION

4. DO NOT SCALE DRAWINGS

1. WOOD FRAMING MEMBERS SHALL BE TREATED FOR EXTERIOR TO MEET SERVICE LIFE OF STRUCTURE AND GRADES ARE AS

POSTS, BEAMS, (6X) - NO 1 DOUGLAS FIR LARCH - TREATED

LVL BEAMS – PWT, WITH Fb = 3100 PSI - TREATED

4. ALL EXTERIOR FASTENERS, EXPOSED TO ELEMENTS TO BE STAINLESS STEEL OR GALVANIZED, INCLUDING NAILS, STAPLES, CLIPS. ETC. AND COMPATABLE WITH TREATMENT OF MEMBERS NOTED 5. ALL JOISTS AND RAFTERS NOT BEARING ON BEAMS OR SUPPORTS SHALL HAVE HANGERS MATCHING MEMBER CAPACITY.

8. TREAT ALL PENETRATIONS TO MEET LVL REQUIREMENTS 9. ALL FINISHED HARDWARE SHALL BE COMPATABLE WITH SELECTED WOOD TREATMENT

3.GALVANIZE ALL STEEL PERMANENTLY EXPOSED TO THE ELEMENTS. 4. PROVIDE VENT HOLES AT ALL EXTERIOR CLOSED SECTIONS

1. PROTECT ALL EXISTING FRAMING, PRIME/PAINT EXISTING HARDWARE AND SUPPORT. 2. ALL NEW ASSEMBLIES SHALL MATCH EXISTING FINISH REQUIREMENTS. COORDINATE WITH OWNER.

401.2 COMPLIANCE – THIS WORK DOES NOT MAKE THE BUILDING COMPLY LESS THAN BEFORE THE WORK WAS UNDERTAKEN. 403.1 FIRE PROTECTION – THIS WORK WILL MAINTAIN THE LEVEL OF FIRE PROTECTION THAT IS THERE CURRENTLY.

LIST OF ABBREVIATIONS

<u> </u>	OI ADDITE INTITUTE	_	
A.B.	ANCHOR BOLT	LVF	LOW VELOCITY FASTENER
ACI	AMERICAN CONCRETE INSTITUTE	MAX.	MAXIMUM
ADD'L.	ADDITIONAL	MBMA	METAL BUILDING MANUFACTURERS ASSOCIATION
AESS	ARCHITECTURAL EXPOSED STRUCTURAL STEEL	MECH.	MECHANICAL
AISC	AMERICAN INSTITUTE OF STEEL CONSTRUCTION INCORPORATED	MFR.	MANUFACTURER
ALT.		MIN.	MINIMUM
ALT.	ALTERNATE	MISC.	M CELLANEOUS
ALUM.	ALUMINUM	MPH	M ES PER HOUR
ARCH.	ARCHITECT	MT	M GNETIC PARTICLE TESTING
ASCE	AMERICAN SOCIETY OF CIVIL ENGINEERS	(N)	NI V
ASTM	AMERICAN SOCIETY FOR	N.I.C.	No i in contract
	TESTING AND MATERIALS  AMERICAN WELDING SOCIETY  BUILDING	NOM.	NOMINAL
AWS		NO.	NUMBER
BLDG.		N.T.S.	NOT TO SCALE
ВОТ.	воттом	0.C.	ON CENTER
BRBF	BUCKLING RESTRAINED BRACED FRAME	0.D.	OUTSIDE DIAMETER
C.G.	CENTER OF GRAVITY	OPP.	OPPOSITE
C.I.P.	CAST IN PLACE	OWJ	OPEN WEB JOIST
C.J.	CONTROL JOINT	PAF	POWDER ACTUATED FASTENER

Permit #: 22 165936 CO

COMPLETE JOINT PENETRATION POUNDS PER CUBIC FOOT **CONCRETE MASONRY UNIT** PARTIAL PENETRATION POUNDS PER SQUARE FOOT POUNDS PER SQUARE INCH CONTINUOUS POST-TENSIONED DEFORMED BAR ANCHOR POLYVINYL CHLORIDE DETAIL R, RAD. **RADIUS** RESEARCH COUNCIL ON

DIAMETER RCSC STRUCTURAL CONNECTIONS DIAGONAL REFERENCE DEAD LOAD RETURN DRAWING REINFORCING ELECTRICAL REQ'D. REQUIRED

REQ'MTS. REQUIREMENTS SCHED. SCHEDULE **EXISTING** SLIP CRITICAL SIMILAR **EXTERIOR** SEISMIC LOAD RESISTING SYSTEM SLRS

**ELEVATION** 

GAUGE

LOCATION

LONGITUDINAL

**FOUNDATION** S.O.G. SLAB ON GRADE FINISH SPECIFICATION FL00R F00T STAINLESS STEEL **FOOTING** 

GALVANIZED GLULAM STRUCT. HORIZONTAL SYM. HOLLOW STRUCTURAL STEEL

INTERNATIONAL BUILDING CODE TONGUE AND GROOVE T & G INTERNATIONAL CONFERENCE TRANSVERSE OF BUILDING OFFICIALS TRUSS JOIST INSIDE DIAMETER LIGHT GAUGE TUBE STEEL

**INTERIOR** U.N.O. UNLESS NOTED OTHERWISE ULTRASONIC TESTING KIPS PER SQUARE FOOT VERT. VERTICAL KIPS PER SQUARE INCH VERIFY IN FIELD

WITH LIVE LOAD WIDE FLANGE LONG LEG HORIZONTAL WITHOUT LONG LEG VERTICAL

**WORK POINT** WELDING PROCEDURE SPECIFICATION WELDED WIRE FABRIC

STEEL STUD MANUFACTURERS

ASSOCIATION

STANDARD

STRUCTURAL

SYMMETRICAL

THROUGH

101' - 1" 555 NW PARK AVE.

NW HOYT ST.

SURROUNDING PARK

NO SCOPE


NW GLISAN ST.

ADJACENT BUILDING

9TH AVE.

 $\geq$ 



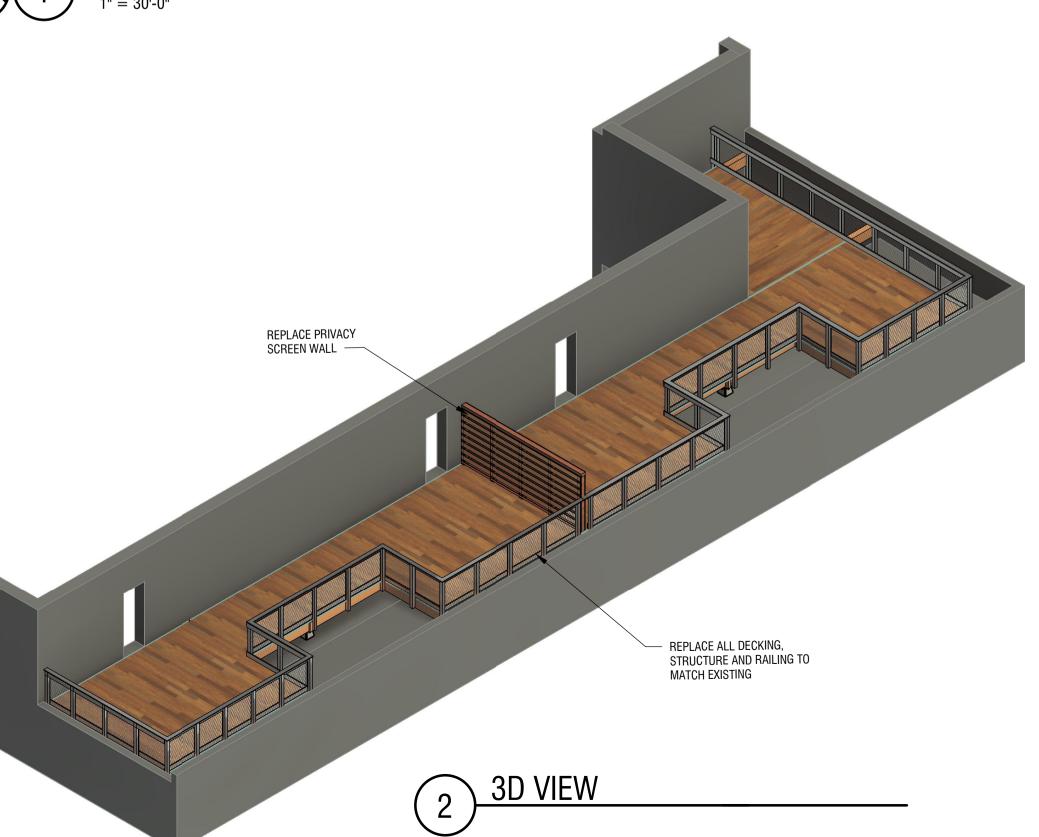

SURROUNDING PARKING LOT

GENERAL CONDITIONS

1. ALL WORK SHALL COMPLY WITH THE 2019 OREGON STRUCTURAL SPECIALTY CODE 3. WRITTEN DIMENSIONS HAVE PRECEDENCE OVER SCALED DIMENSIONS

5. COODINATE EXISTING DIMENSIONS AND ALL OTHER INFORMATION NOT SHOWN ON THE STRUCTURAL DRAWINGS. 6. ALL TEMPORARY SHORING, AND POSTING SHALL BE BY THE GENERAL CONTRACTOR. DO NOT REMOVE TEMPORARY

SHORING UNTIL FRAMING COMPLETE 7. DO NOT IMPACT EXISTING DRAINAGE, ROOFING, AND FLASHING. COORDINATE ALL REQUIREMENTS WITH NEW FRAMING.

FOLLOWS UNLESS OTHERWISE NOTED ON THE PLANS A. POSTS , BEAMS, HEADERS (4X AND LESS) - NO 2 DOUGLAS FIR LARCH - TREATED

B. JOISTS AND RAFTERS – NO1 DOUGLAS FIR LARCH - TREATED C. PLATES, BLOCKING AND BRIDGING - NO 2. HEM FIR OR DOUGLAS FIR LARCH - TREATED

2. UNLESS OTHERWISE, ALL JOISTS SHALL BE A MINIMUM OF 2X12 3. DESIGN LOADS:

6. SELECTED DECKING SHALL HAVE A SPAN RATING TO MEET THE INTENDED DESIGN LOADING AT 16" O.C. CONTRACTOR RESPONSIBLE FOR CONFIRMING DECK RATING AND COORDINATING FINAL JOIST SPACING.

STEEL

1.STEEL SHALL HAVE THE FOLLOWING PROPERTIES WT SECTIONS, CHANNELS, ANGLES PLATES – ASTM A 36

7. SEAL ENDS AND TOP OF ALL PRIMARY BEAM MEMBERS PER PLAN

2.WELDING SHALL BE WITH E70XX ELECTRODES

THIS WORK FALLS UNDER IEBC 0301.2 REPAIRS AND THUS MUST COMPLY WITH THE REQUIREMENTS OF CHAPTER 4.

404.1 MEANS OF EGRESS – NO EGRESS ROUTES WILL BE CHANGED WITH THIS WORK. 405.1 STRUCTURAL – THIS WORK WILL BE STRUCTURALLY COMPLIANT WITH ALL

Date: 09/22/22

22-165936-000-00-CO

CHECK SHEET COMMENTS

City / proval Stamp

**Engineer Certification** 

Consultant FH Honeyman Hardware

Lofts, LLC

Drawing Info

Project No.: 22087 Sheet Size: 24x36 Drawn By: DTF Checked By: NJF

**Honeyman Hardware Lofts - Deck** Replacement 555 NW Park Ave.

Portland, OR 97209


FH Honeyman Hardware Lofts, LLC

Phase: Issue Date: 07.18.2022

**Sheet Name** 

PROJECT INFORMATION, LIST OF ABBREVIATIONS & SITE PLAN

Sheet No.

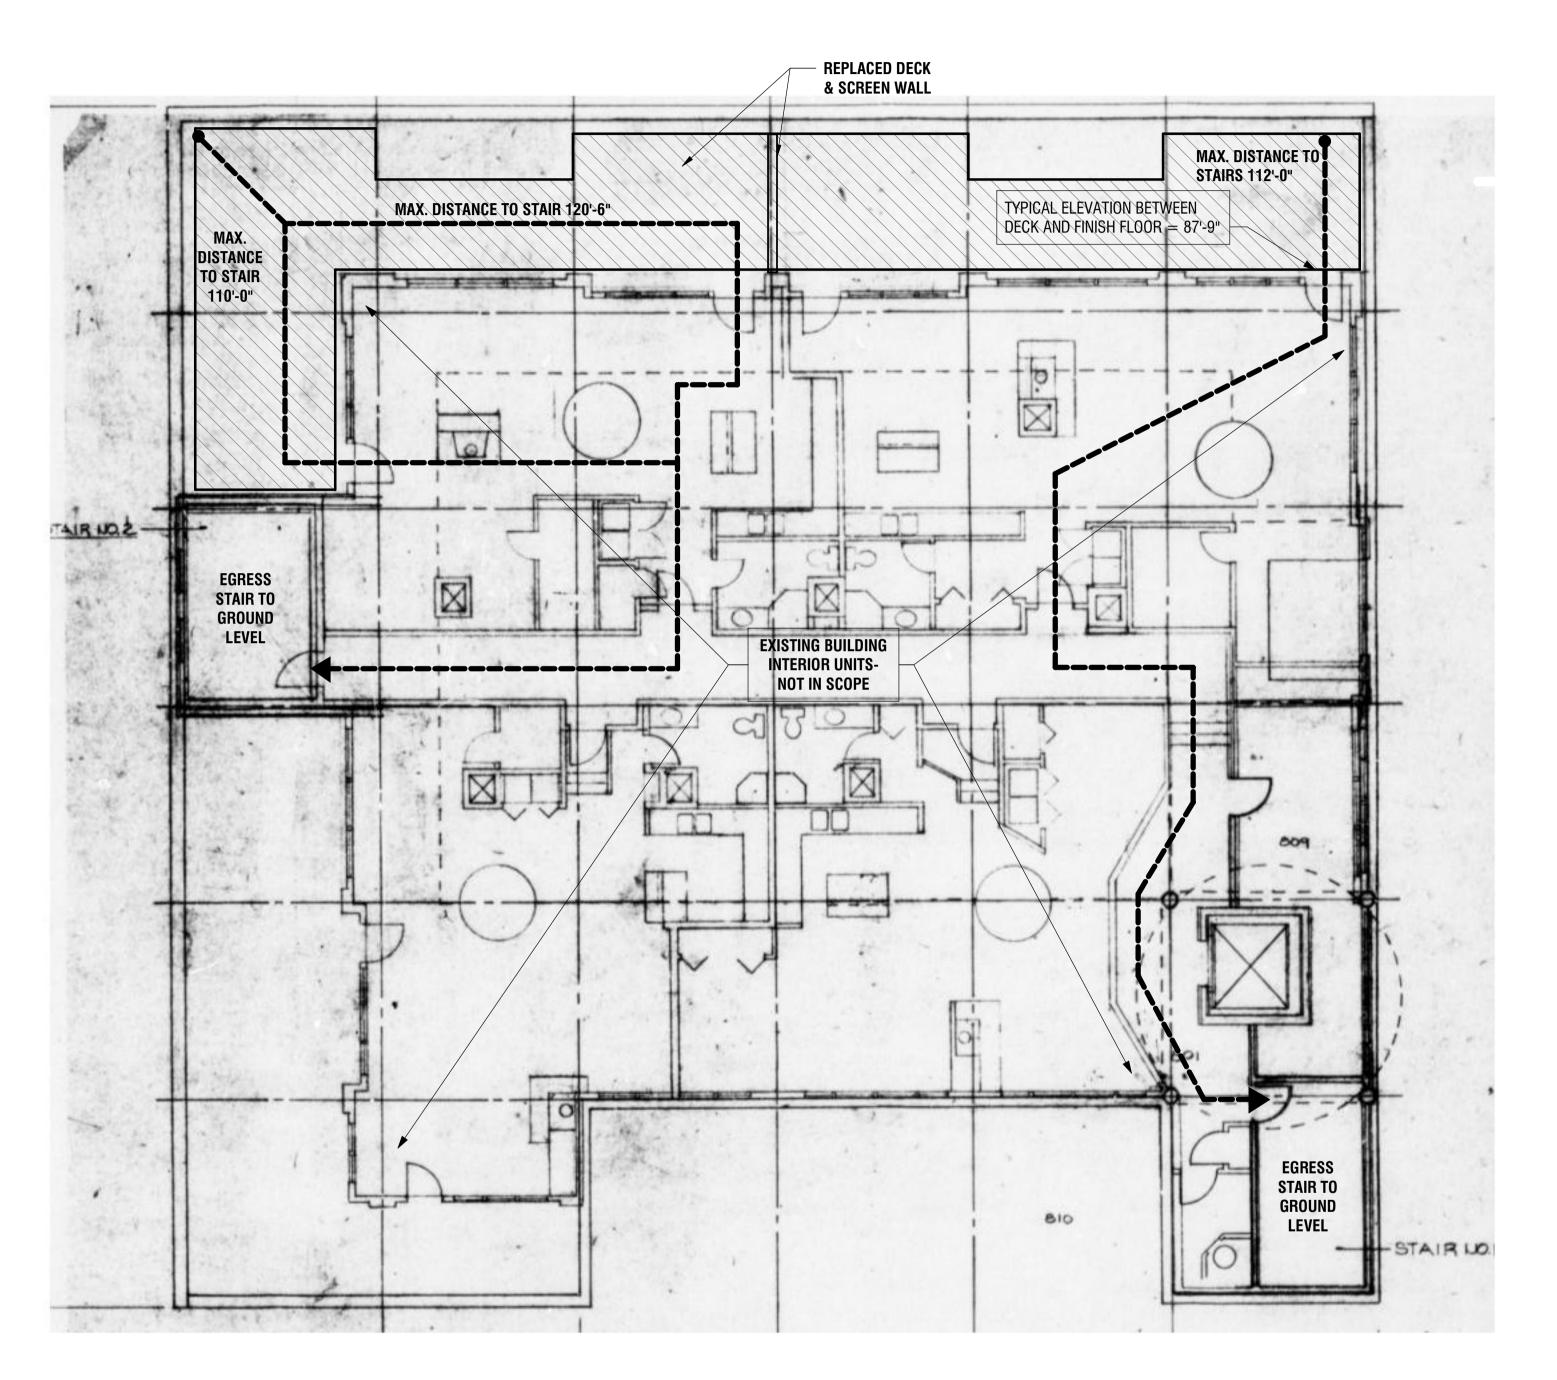


EGRESS PLAN - FOR REFERENCE ONLY



22-165936-000-00-CO

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1 CHECK SHEET COMMENTS
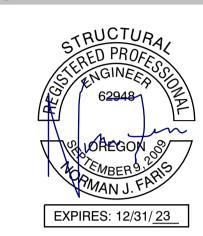
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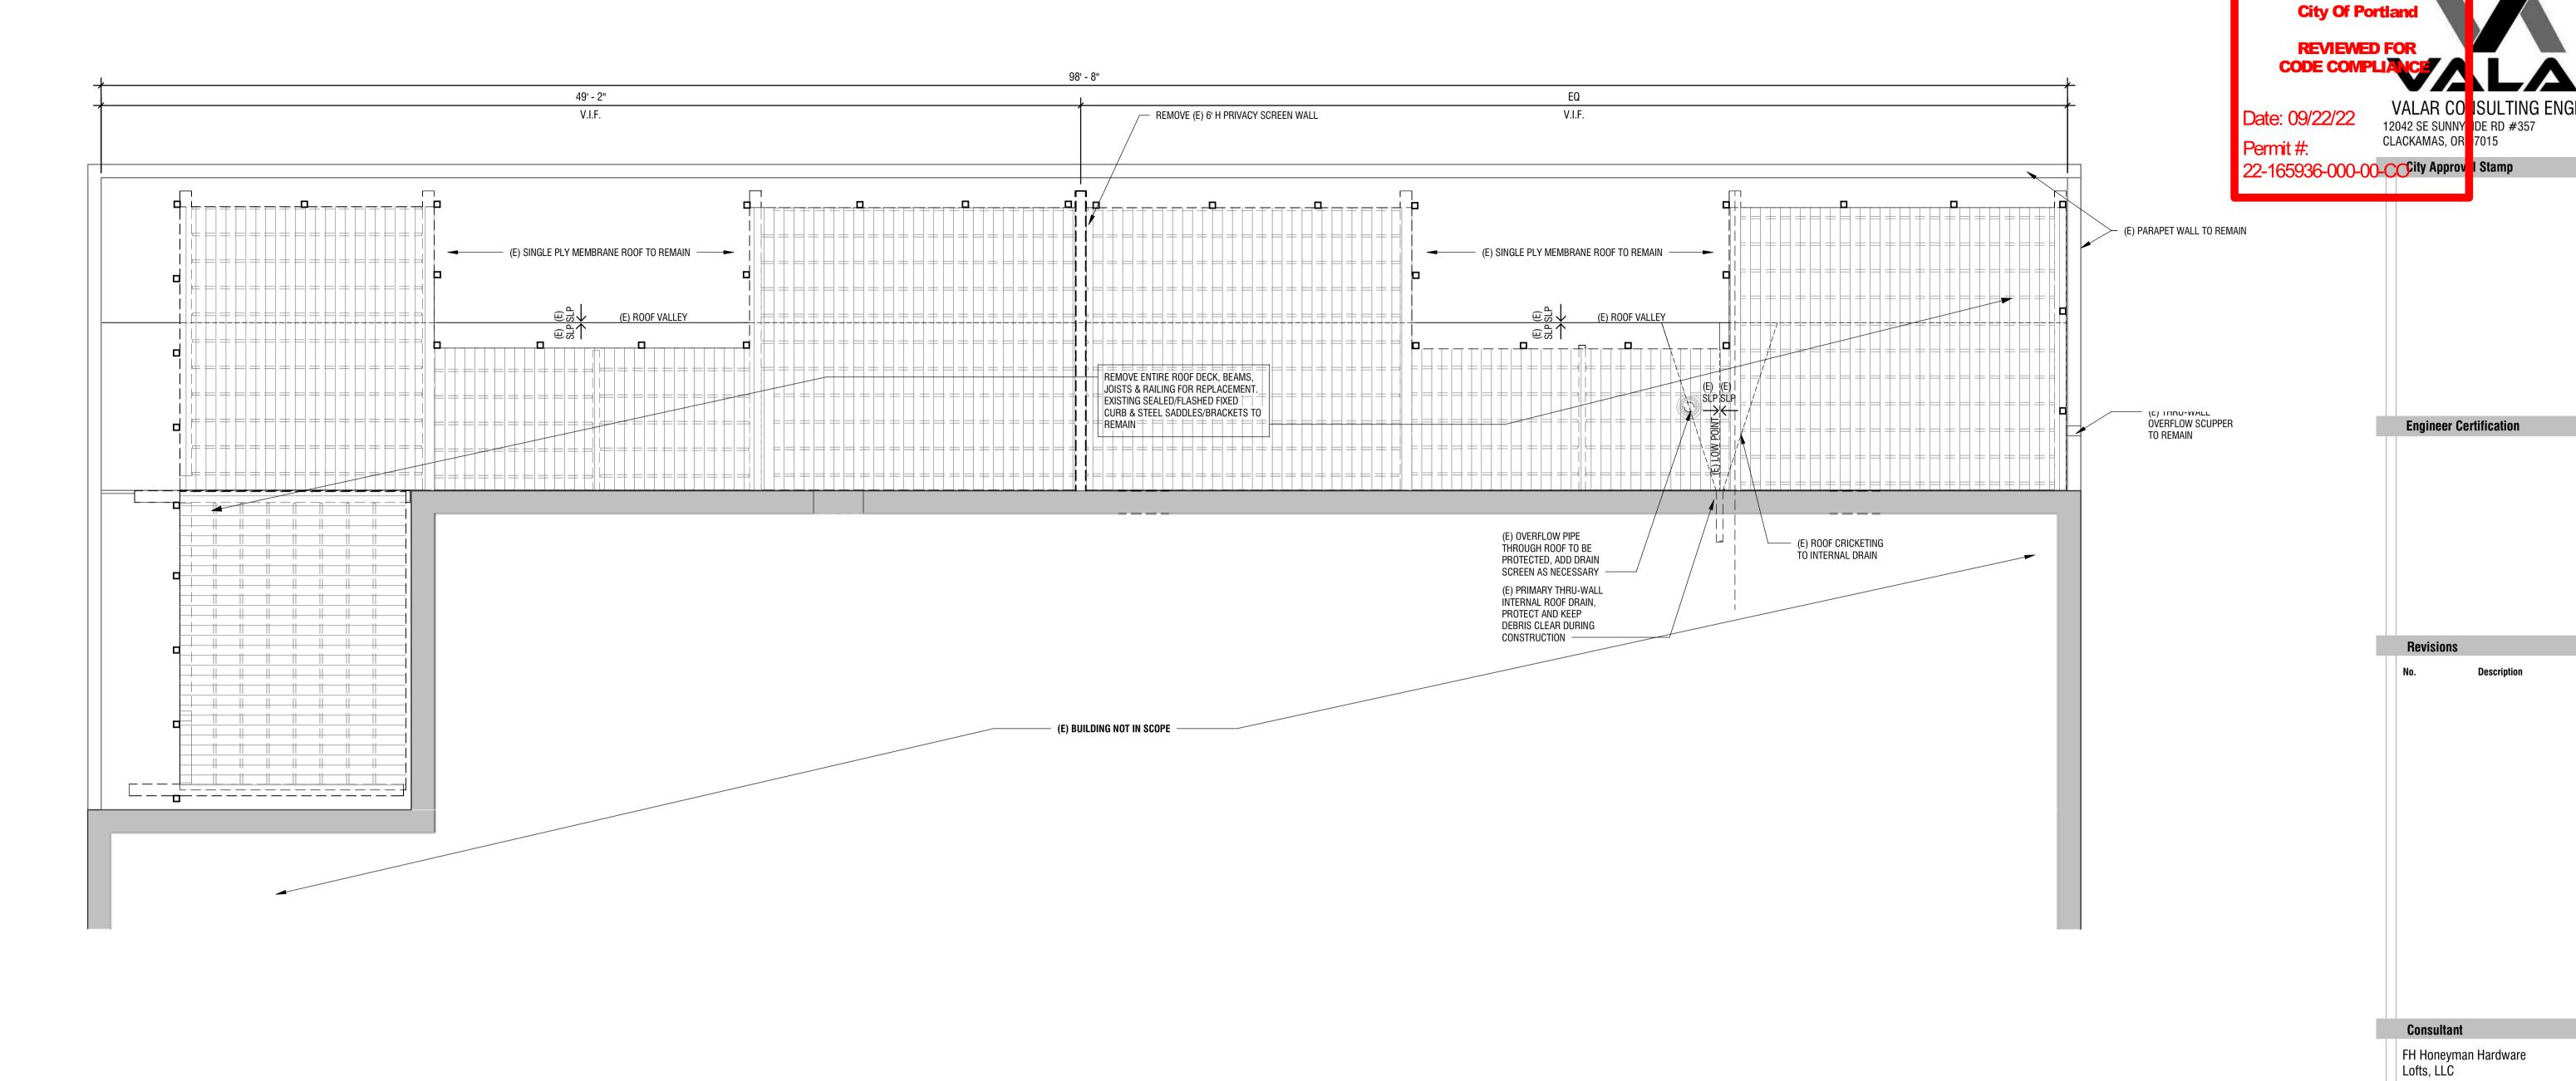
Honeyman Hardware **Lofts - Deck** Replacement
555 NW Park Ave.
Portland, OR 97209

FH Honeyman Hardware

Lofts, LLC

PERMIT Issue Date: 07.18.2022

Sheet Name EGRESS PLAN



1 ROOFTOP DECK DEMOLITION PLAN

1/4" = 1'-0"

Sheet Name

ROOFTOP DECK
DEMOLITION PLAN

**Drawing Info** 

Project

Project No.: 22087
Sheet Size: 24x36
Drawn By: DTF
Checked By: NJF

**Lofts - Deck** 

Replacement


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**Honeyman Hardware** 

Lofts, LLC


FH Honeyman Hardware

D1.1



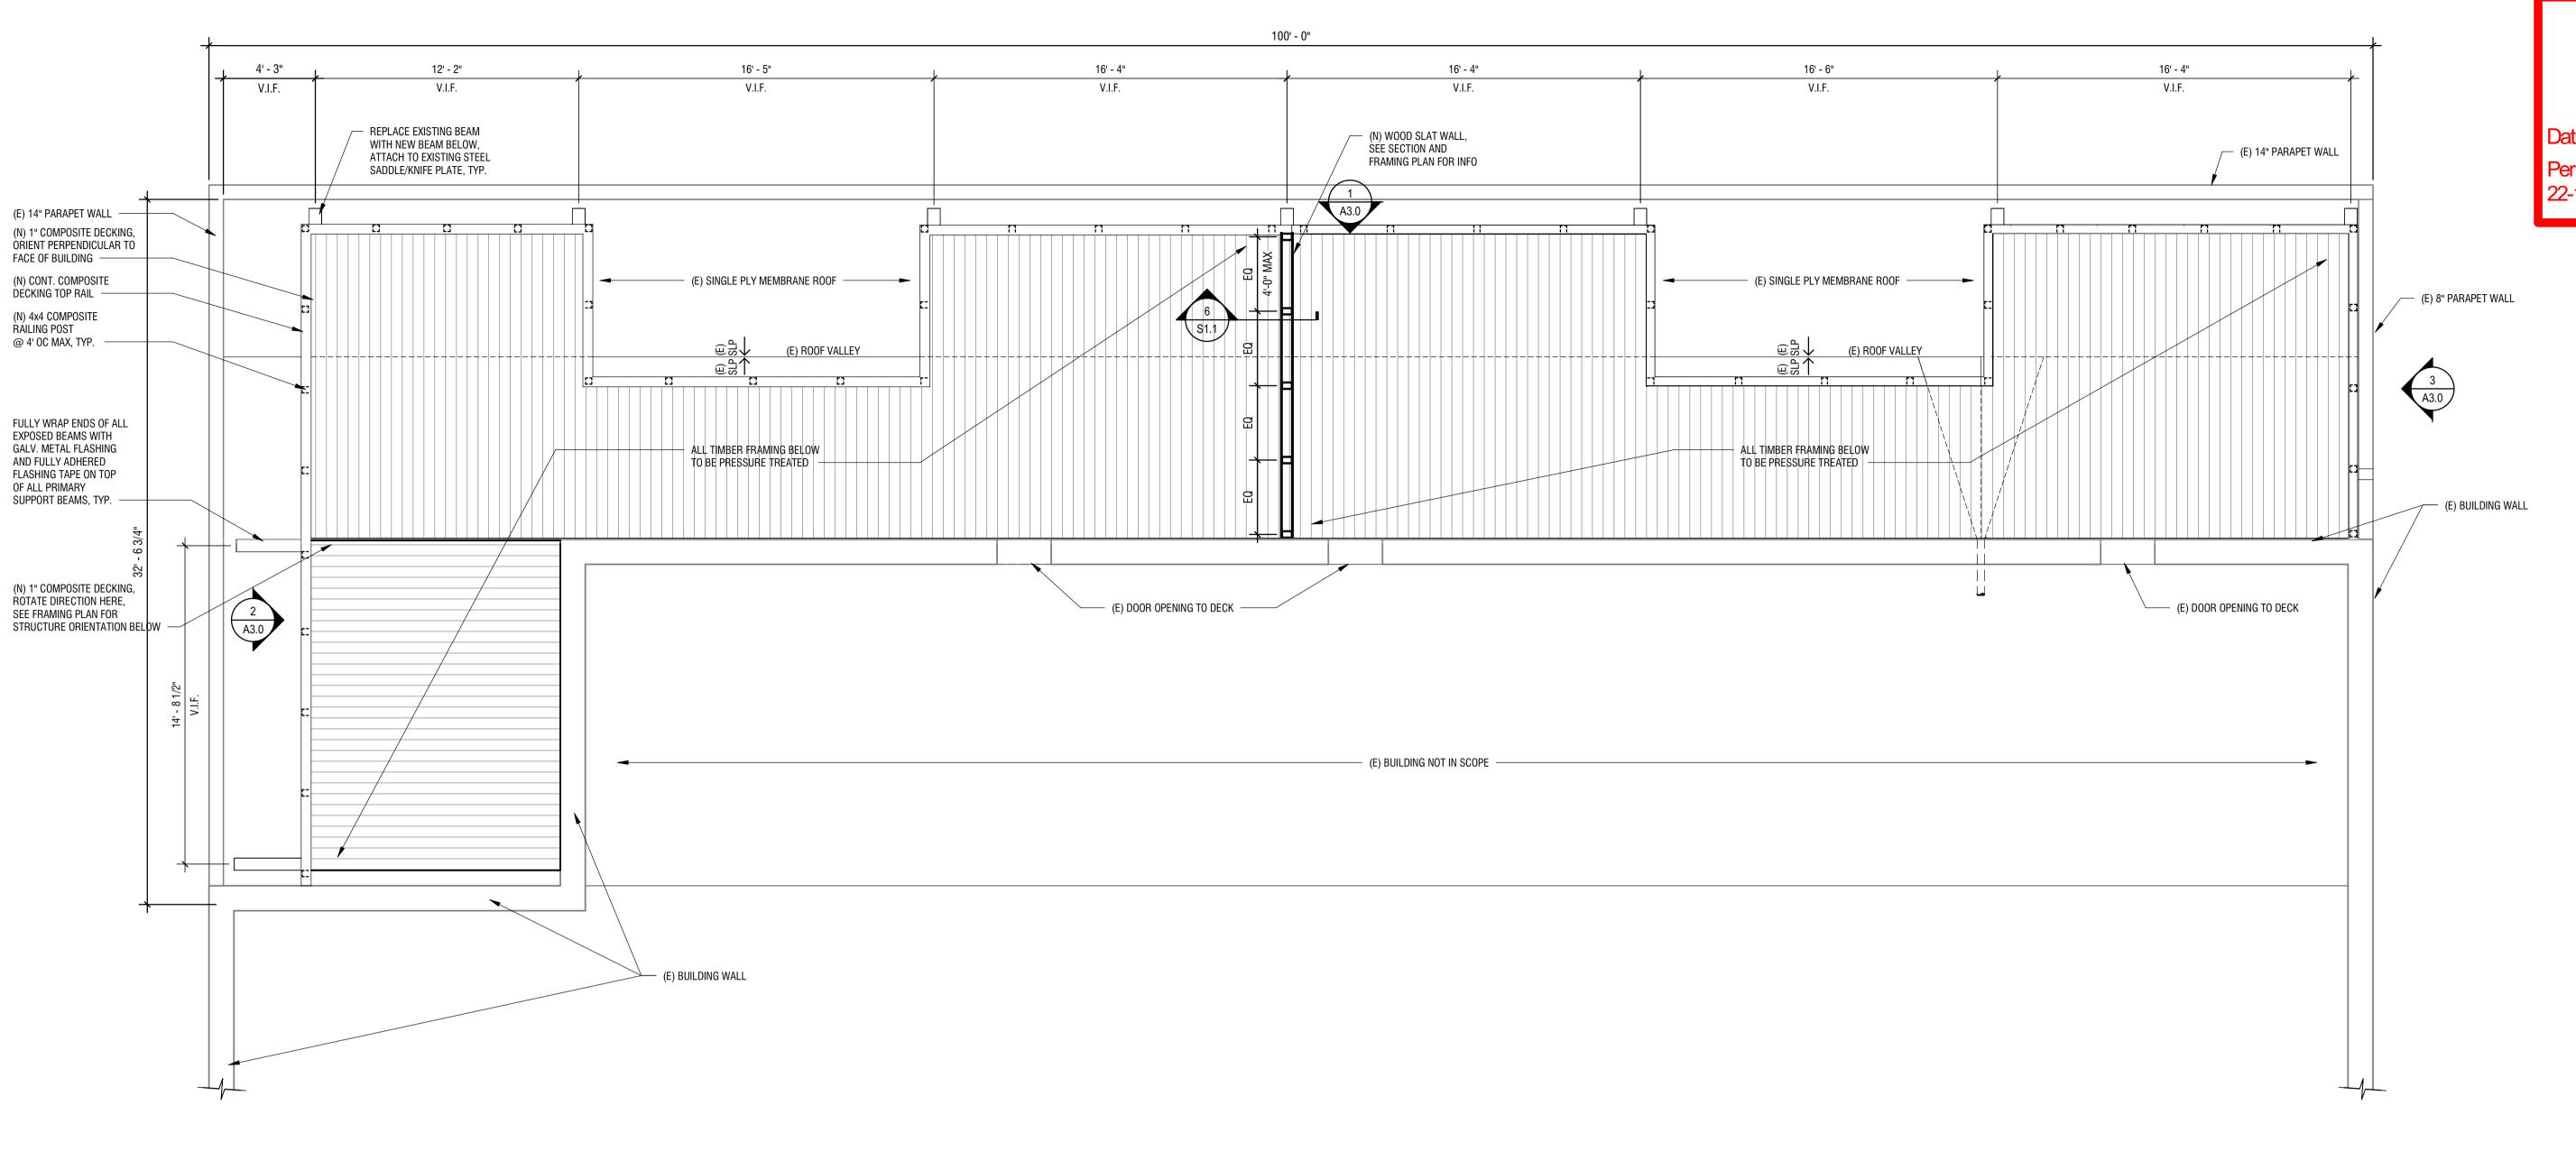

**Engineer Certification** 

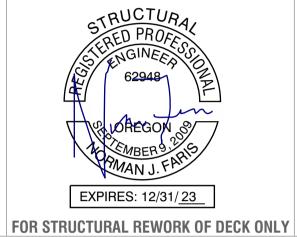

Consultant

FH Honeyman Hardware Lofts, LLC

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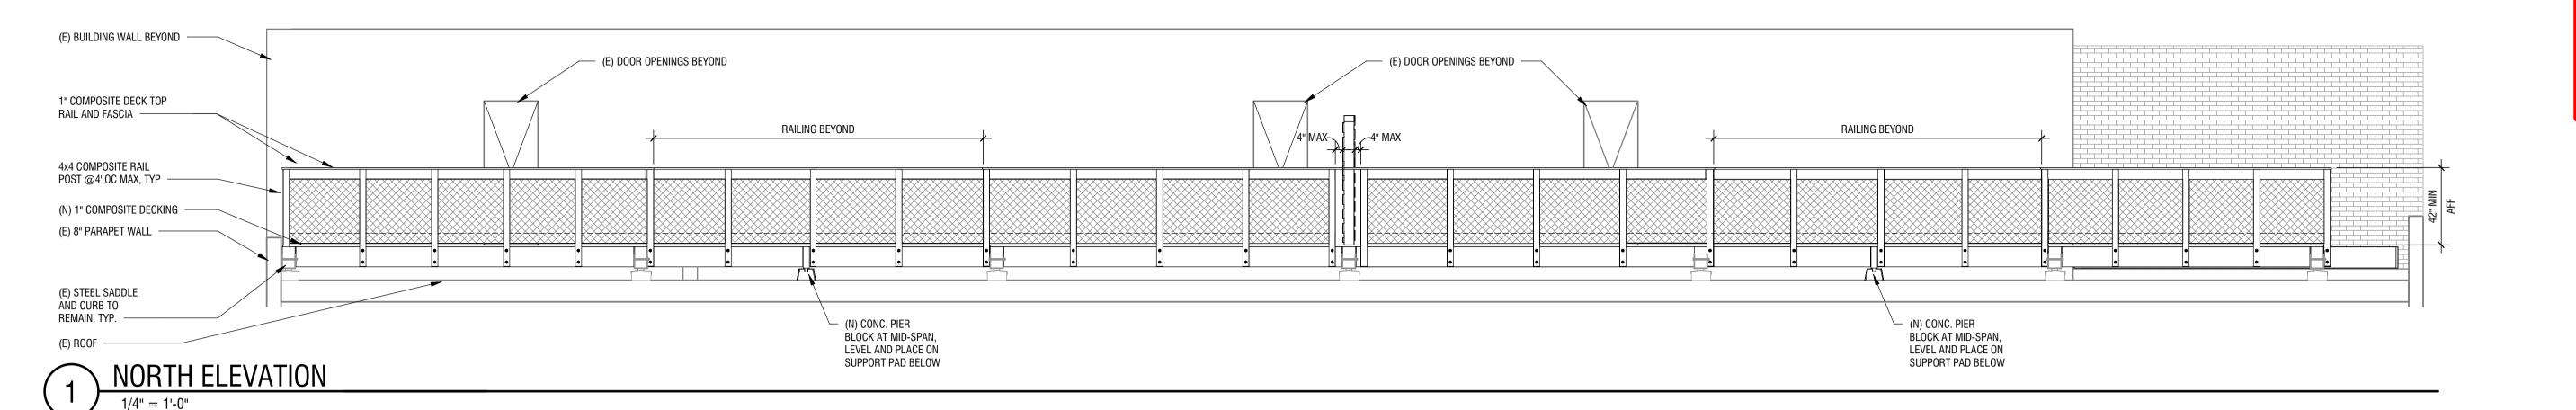
FH Honeyman Hardware Lofts, LLC


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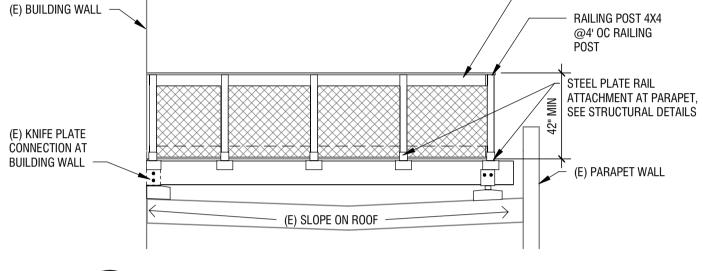
Sheet Name

ROOFTOP DECK PLAN

ROOF DECK PLAN





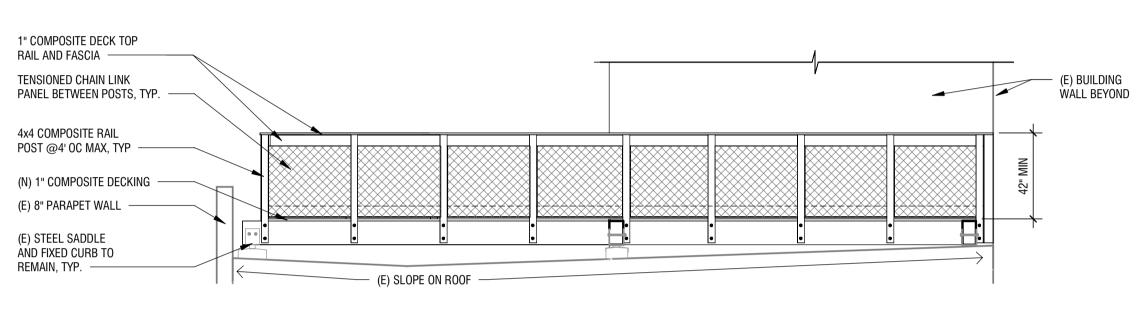

TENSIONED CHAIN LINK PANEL BETWEEN POSTS, TYP.






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**Engineer Certification** 



Consultant

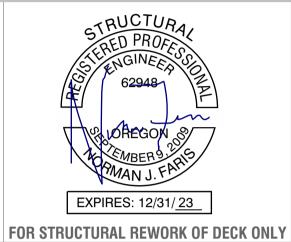FH Honeyman Hardware Lofts, LLC

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ELEVATIONS

Sheet Name

