## **Development Services**

#### From Concept to Construction







APPEAL SUMMARY

Status:	Decision	Rend	lered	
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Appeal ID: 21950	Project Address: 3434 NE Sandy Blvd
Hearing Date: 10/2/19	Appellant Name: KEN MYERS
Case No.: B-011	Appellant Phone: 518-364-9914
Appeal Type: Building	Plans Examiner/Inspector: John Cooley
Project Type: commercial	Stories: 1 Occupancy: M, B, A-2 Construction Type: III-B
Building/Business Name: PICCONE'S CORNER MARKE	ET Fire Sprinklers: Yes - throughout
Appeal Involves: other: CODE	LUR or Permit Application No.: 19-127919-CO
Plan Submitted Option: pdf [File 1]	Proposed use: RETAIL/ BAR

#### APPEAL INFORMATION SHEET

#### Appeal item 1

Code Section	1108.2.9	

<b>Requires</b> That a section of the bar be at 34" tall for wheelchair acc	essibility.
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#### **Proposed Design** We propose a height of 42" above finish floor for the entire bar top area, and that the remaining tables throughout the dining area to be Handicap accessible tables.

#### Reason for alternative The federal guidelines are as follows:

28 Code of Federal Regulations (CFR) part 36, 5.2 Counters and Bars- Where food or drink is served at counters exceeding 34 in (865 mm) in height for consumption by customers seated on stools or standing at the counter, a portion of the main counter which is 60 in (1525 mm) in length minimum shall be provided in compliance with 4.32 or service shall be available at accessible tables within the same area.


All additional tables provided within the facility will be at an accessible height and equal services will be provided throughout. As we are in compliance with the federal guidelines we feel that we are also complying with the intent of this code.

In addition to this the following appeals: appeal ID 6985 from 04/08/10, appeal ID 7208 from 07/08/10, and Appeal ID: 18979 from 03/07/19 have been reviewed and granted in similar cases.

#### APPEAL DECISION

Omission of accessible bar space: Denied. Proposal does not provide an equivalent level of accessibility. Appellant may contact John Butler (503 823-7339) with questions.

Pursuant to City Code Chapter 24.10, you may appeal this decision to the Building Code Board of Appeal within 90 calendar days of the date this decision is published. For information on the appeals process, go to www.portlandoregon.gov/bds/appealsinfo, call (503) 823-7300 or come in to the Development Services Center.

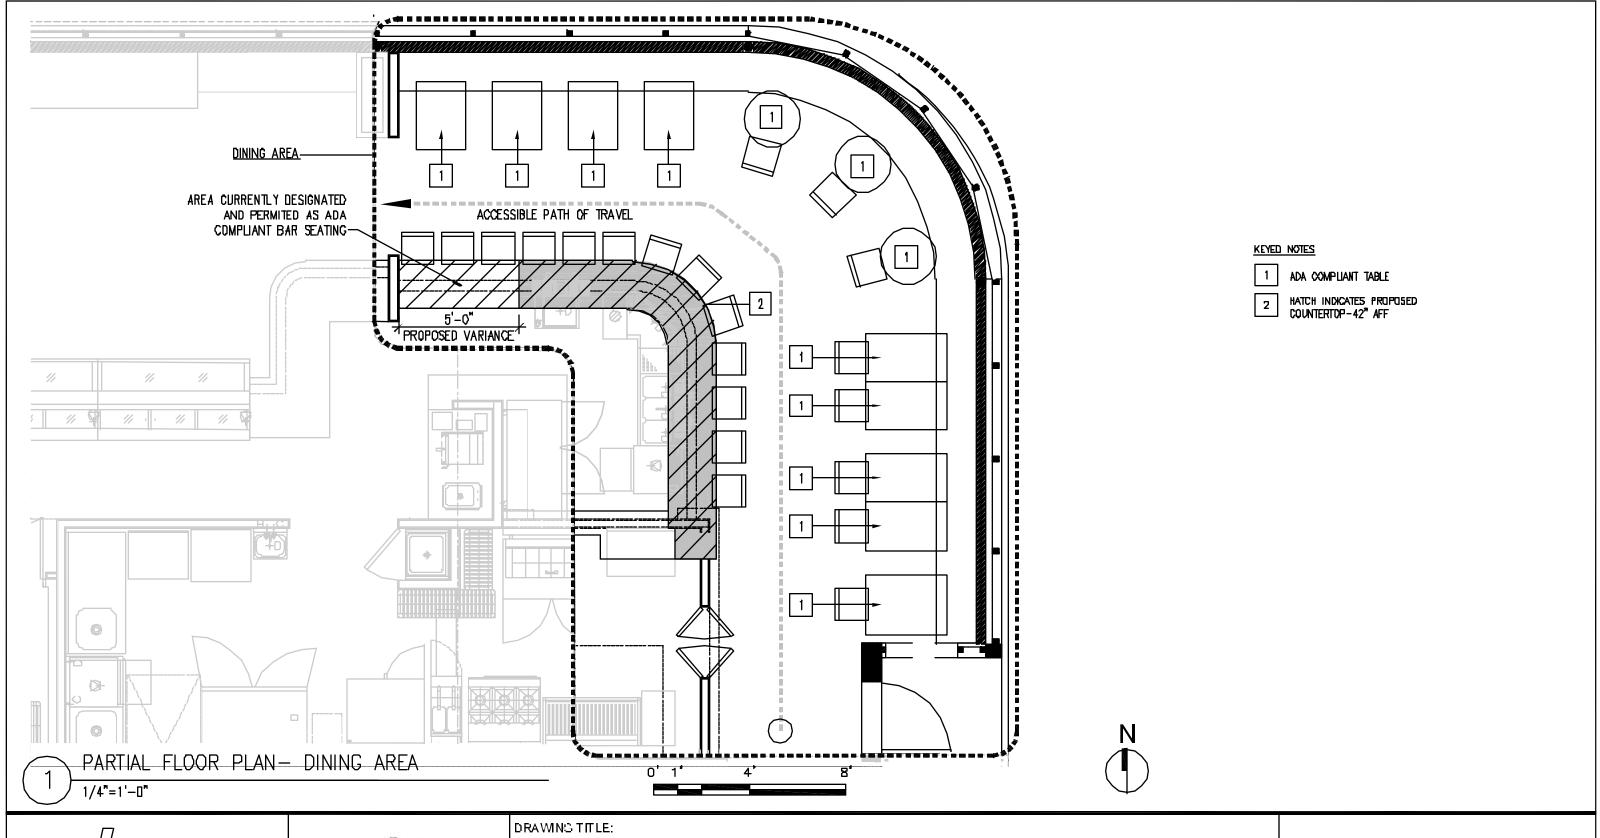



Cam bridge, MA 02139 617.714.3369 646.526.5564



PARTIAL FLOOR PLAN— DINING AREA

PROJECT:

PICCONE'S CORNER

ISSUE DATE:

2019-09-25

SCALE: SEE PLAN DRAWN BY:

APPROVEDBY:

ASK

V1.1

## PROJECT INFORMATION / CODE REVIEW / LIFE SAFETY REVIEW

## Site Information Project Address:

3434 NE Sandy Blvd Portland Oregon 97232-1974

Business Name: Piccone's Corner Market

## <u>Legal Description</u> Tax Roll: LaureInurst, Block 35 Lot 9-11

Tax ID: R203026 19,250 Sq Pt (0.44 acres)

## <u>Seismic Zone</u>

Design Category D

dining programs.

Project Narrative/Description
The proposed project is a TI for a new first time tenant of a recently completed adaptive re-use project. The tenant space is +2100 NSF currently vacant and was originally permitted under a Shell Permit as part of IVR # 3932719. The proposed project includes retail, food preparation, and

Existing building is 2 stories Type III-B Concrete Structure =18,100 GSF 16,500 NSF Sprinklered.

## Zoning Information Base Zone – Zoning District – CM3

Overlay – Design

Plan District-Sandy Boulevard Plan District,

### Applicable Codes and Regulations

2014 Oregon Structural Safety Code 2014 Oregon Mechanical SpecialtyCode

2014 Oregon Plumping Specialty Code 2014 Oregon Electrical Specialty Code

ICC A117.1 -2009 Accessible and Useable Buildings 2010 ADA Standards for Accessible Design

#### BUILDING CODE SUMMARY

## Occupancy and Separation-Chapter 3.5

Classification – Multiple use space includes M, B, and A2 uses. A2 use is accessory (secondary to primary operation as market), under 50 persons, 391 sqft pecomes Biclassification. Use Bill classification overall as most restrictive.

Applicable Adjacent Occupancy F-1 (Neignboring unit), Bi-No separation required as per 508.4

#### Building Height / Allowable Area – Chapter 5

-No Change / Non-Applicable

## Fire Resistance Ratings-Chapter 6,7

Floor Construction

Fire Resistance Rating Requirements for Building Elements in Hours-Table 601 Building Element Req. Type -IIIB Prop. Type-IIIB Primary Structural Frame Bearing Walls – Exterior Bearing Walls – Interior Non-Bearing Walls and Partitions-Interior

Roof Construction Fire Resistance Rating Requirements for Exterior Non-Bearing Walls Based on Fire Separation Distance (Table 902)

Fire Separation Distance 0'-0" 46'-6" 30'-10" 0'-0" 1 nr 1 nr Keep Exat. Keep Exat. N/A Proposed Exterior Wall Rating Note: South and West Distances are measured to Property Line, North and East Distances are measured to the center of right-of-way.

## Maximum Area of Exterior Wall Openings (Table 705.8)

North 0'-0" Fire Separation Distance 40'-0" 30'-10" 0'-0" Max area of unprotected openings (Building Sprinklered) No Limit No Limit N/A

### Shafts and Chutes-Chapter7

## -No Change / Non-Applicable

Fire Alarm System

Interior Finishes-Chapter 8

Wall/Ceiling Max Flame Spread Classifications and Ratings (Table 803.9)

**NE SANDY BOULEVARD** 

## Corridors and Exit Access Enclosures

Rooms and Enclosed Spaces

Life Safety Systems - Chapter 9	<b>)</b> )		
	Required	Pro∨ided	Type/Class
Automatic Sprinkler System	No Per 903.2	Yes	NFPA13
Fire Sprinkler Riser	No Per 905.3	Yes	NFPA 14 -Cla
Fire Purnos	No Per 903.2	No	
Fire Extinguisners	Yes Per 906.3	Yes	Minimum 2A10
<u>-</u>	-75" Max Travel		Portable Fire
	Distance		Extinguisners t

Audible and Visible Alarms Yes Per 907.2 NFPA 72 NFPA 72 Smoke Detection System Yes Per 905., 907.2.1/2/4/7

ADDRESS NUMBER

EXIT DOOR CAPACITY

R 32\*

350 OCCUPANTS SERVED

COMMON PATH OF

TRAVEL - 16'-3"

TRAVEL | - 77'-10"

201-0" LOCATION, SEE NOTE 3

provided.

RETAIL

SPIT PEGUPANTS

362 12

EXITS CICUPANCY LYPE

KITCHEN &

FOOD STORAGE

### with provided life safety systems and build-on to existing pase systems referenced above.

## Proposed Occupant Load pertable 1004.1.2

Occupant Load Factor Square Footage/ Total Occupants Function of Space Linear Footage Kitchen/Food preparation 583 SF Food Storage/Walk-inis 300 GSF 288 SF 30 GSF 362 SF Retail Area Dining Area

40 LF Bench Seating 18" Linear Seating Adiacent Seating 318 NSF 22 area and Bar Total Proposed Occupants 68

## Egress Width Per Occupant Served 1005.3

Stairways: 0.3/OCC (n/a) Other Egress Components 0.2/OCC Min width of 44" (36" when serving area less than 50 OCC) per 1009.4

## Number of Exits 1015 Two Exits Required /Two Exits Required (Table 1015.1)

One Required / One Provided I Illuminated Exit Signs

Accessible Means of Egress 1007

#### Required per 1011.1 Exit Access - Sprinklered (Table 1014.3)

B Occupancy Continion Path 100 Exit Access Travel Distance - Sprinklered (Table 1016.2)

#### BiOccupancy - 3001 Dead End Corridors (1018.4)

B Occupancy with Sprinkler-50" Means of Egress Illumination (1006) Egress lighting required per 1006.1

Emergency egress lighting required per 1006.3 See legend for location and fixture

# Minimum Corridor Width (Table 1018.2)

Access to and utilization of Mechanical, Plumping, or Electrical Systems and Equipment With a required occupancy, less than 50 36"

All other locations

<u>Interior Environment—Chapter 12</u> Ventilation of Occupied Rooms and pathrooms (1263) provided by Mechanical Ventilation in compliance with Mechanical Code see M Series Drawings Note: the above chart is referenced from the base building permit. All new tenant work to comply Lighting of Human Occupied Spaces (1205) – Net glazed area greater than 8% of total floor area.

## Artificial light provided in accordance with 1205.3.

Energy Efficiency - Chapter 13, OEESC CH 5 Building Envelope Requirements Opaque Assembly's (Table 502.1.1) Walls – R-21

Roofs - R38

Slap on Grade – Unineated-NR

Basic Wind Speed 120 MPH. Wind Exposure B Fire Classification C / Type III Construction Non-Compustible

Roofing and Cladding Requirements Chapter 15 and 16

## Plumbing Fixtures Chapter 29 and IPC

	Tota	al Occ	прапсу	/ Wate	r Closet	Urinals	Lava	atories	Drinking Fountain:
Docupancy	Т	М	F	М	F	М	М	F	
B (A2<50) and N	r 62	31	31	1	1	1	1	1	See Note*

## CITY OF PORTLAND / JURISDICTIONAL REQUIREMENTS

410.4 as substitution for drinking fountain.

## Firestopping City of Portland Code Guide

Firestopping installed as per requirements outlined by the City of Portland. Information available at Public Right of way Improvements –ADA compliant cross/slopes, curb cuts, entry slopes. inttp://www.poirtlaindonlline.com/anaired/afm/intage.afm?id=68669

## Vehicle Parking Chapter 11, COP 33.266.11, ANSI 502

1690 NSF

As per pase building permit, no minimum required parking per well served publictransitexemption. Accessible Entry

#### Bicycle Parking COP 33.266 Long and short term picycle parking provided under pase building permit WR#3932719 per table

4 long term bicycle spaces provided 19 short term bicycle spaces provided

## Seismic Upgrade Chapter 24, COP 24.85, Table 24.85-A, Table 24.85-B

The below charts are cumulative showing overall building changes from pire-2004 to the current. proposed TI.

7,753 NSF

# \_Seisnic upgrade referending OSSC - Netsqft.

No increase of building A-2 class 5 nazard from IVR 3932719. Cumulative net floor change \ \ \ remains at 14.4 % less than 1/3 of area changed \ \ \ \ \ \ \ \ \ \ \ \ \ \ \ \ \ \ \					
Оссиралсу	Pre-2004	IVR # 3932719	IVR # 4127285	Proposed TI	
A-2	N/A	2,375 NSF	2,375 NSF(NC)	_2,375 NSF(NC) {	
<b>⟩</b> В	2216 NSF	5,712 NSF	5,712 NSF(NC)	= 5,350 NSF (-362) = (	

7,753 NSF(NC) 7,753 NSF(NC)

ADDRESS NUMBER

EXIT DOOR GAPACITY

R 32"

P 34.5" i

160 DCCUPANTS SERVED

LOCATION, SEE NOTE 3

362 (+362)

N/A (NC)

Total

12,706 NSF 707 NSF 16,612 NSF 16,547 NSF

707 NSF(NC) 707 NSF(NC) 16,547 NSF 16,547 NSF

## Seismic upgrade referencing OSSC-OCCUPANCY

IVR #4127285 was a Ti for 1385 sqft restaurant with a Bioccupancy as per C/O 17-278565. Assume occupancy of 49. Occupancy for space as per pase building permit IVR #3932719 14. Increase of 35 occupants

Proposed TI has B Occupant load of 68. Occupancy for tenant space as per base building permit. IVR #3932719 22. Increase of 46 occupants

Total Increase of Occupants to date from Pre-2004 is 120 Occupants. No seismic upgrades required as a result of proposed  $\Pi$ .

•				
Оссиралсу	P re-2004	IVR#3932719	IVR # 4127285	ProposedT
A-2	N/A	79 (+79)	79 (NC)	79 (NC)
В	27	65 (+38)	100 (+35)	134 (+34)
F-1	N/A	67 (+67)	67(NC)	67(NC)
М	<b>9</b> 0	N/A (NC)	N/À (ŃC)	12 (+12)
S-1	90	5 (-8Š)	5 (NĈ)	5 (NC)
T-4-1	477	nae '	neu '	207

#### Accessibility Improvements OSSC Chapter 34, 3411 Provided under base building permit NR#3932719:

To be provided this application: Accessible single use pathroom (x2)

Accessible Seating for dining area (min 5%)

## Fire Marshall Office Separate Regd Permits COP Title 31

Fire Sprinkler –Alteration to existing pase system Fire Alarm -Alteration to existing pase system

## Fixed Extinguishing System / Cooking Hood

Fire Marshall Office General Notes Title 31 All work and scope show in the drawings related to Fire Sprinkler, Alarm, Extinguishing systems is for reference only. Any Scope of work under the purview of the Fire Marshalls Office is to be reviewed by the trade during the trade plan review with the office directly.

PATH TO EXIT FROM

MOST REMOTE POINT

EXIT FIXTURE, DOUBLE FACED, DIRECTION OF ARROW(S) AS SHOWN

EXIT FIXTURE, SINGLE FACED, DIRECTION OF ARROW(S) AS SHOWN

LIFE SAFETY SUMMARY TAG

INFORMATION

A - 44" MIN B - 54" MIN

C - 74 MIN

REQUIREMENTS

EGRESS LIGHTS

1) EMERGENCY & LIGHTING TO BE PROVIDED, SEE ELEC

4) PROVIDE LED STRIPLIGHT WITH BATTERY PACK FOR

2) EGRESS WIDTH CALCULATED BASED ON OSC SECTION 1005.1 3) ADDRESS NUMBERS SHALL BE IN COMPLIANCE WITH PFC

ZL1N-L24-1500LM-FST-MVOLT-50K-80CRI-E10WLCP-MB, CONNECT SO FIXTURE WILL BE NORMALLY OFF AND TO ACTIVATE ON BATTERY UPON LOSS OF NORMAL POWER,

COORDINATE EXACT LOCATIONS WITH ARCHITECT, SEE

E-SERIES FOR ADDITIONAL INFORMATION, LIGHT TO BE

L-01

505.1, SEE PLAN FOR LOCATIONS

EMERGENCY LIGHTING, LITHONIA

VERIFIED BY FIELD TEST

NOTES:

WIDTHS

MINIMUM REQUIRED EGRESS WIDTH PROVIDED (CLEAR) ECRESS WIDTH

EGRESS PATH WITH EGRESS LIGHTING, SEE NOTE 4 BELOW FOR ADDITIONAL

EMERGENCY EGRESS LIGHT, SEE NOTE

4 BELOW & E-SERIES FOR

L-01 FIXTURE WITH E2 OPTIONAL

BATTERY PACK FOR EMERGENCY

Piccone's

Corner Market

Portland, OR

KEY PLAN

PLAN REVIEW REVISIONS |FS - FM9714380038 LS - fil 0429034D78 04.12.2019 STRUCT - C59644459043 REVISION






Project PICCONE'S CORNER MARKET Drawn By: JC Checked By: AJS/SMC

Date: 02.20.2019 Scale: 1/4" = 1'-0"

Drawing Title:

EGRESS PLAN, CODE SUMMARY, LIFE SAFETY

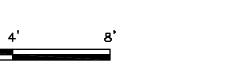





EGRESS / LIFE SAFETY PLAN 1/4"=1"-0"

L-01

G0.3

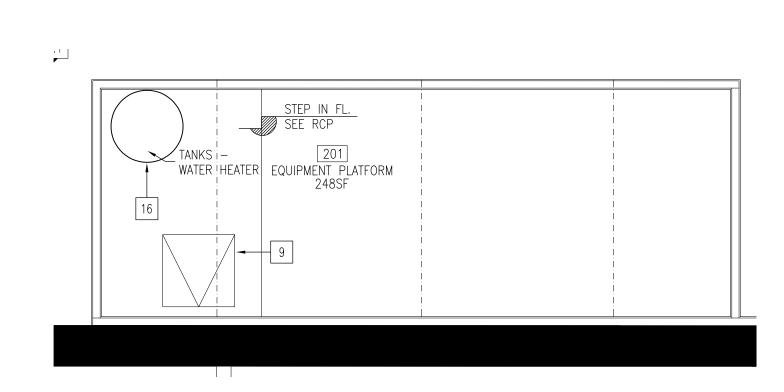



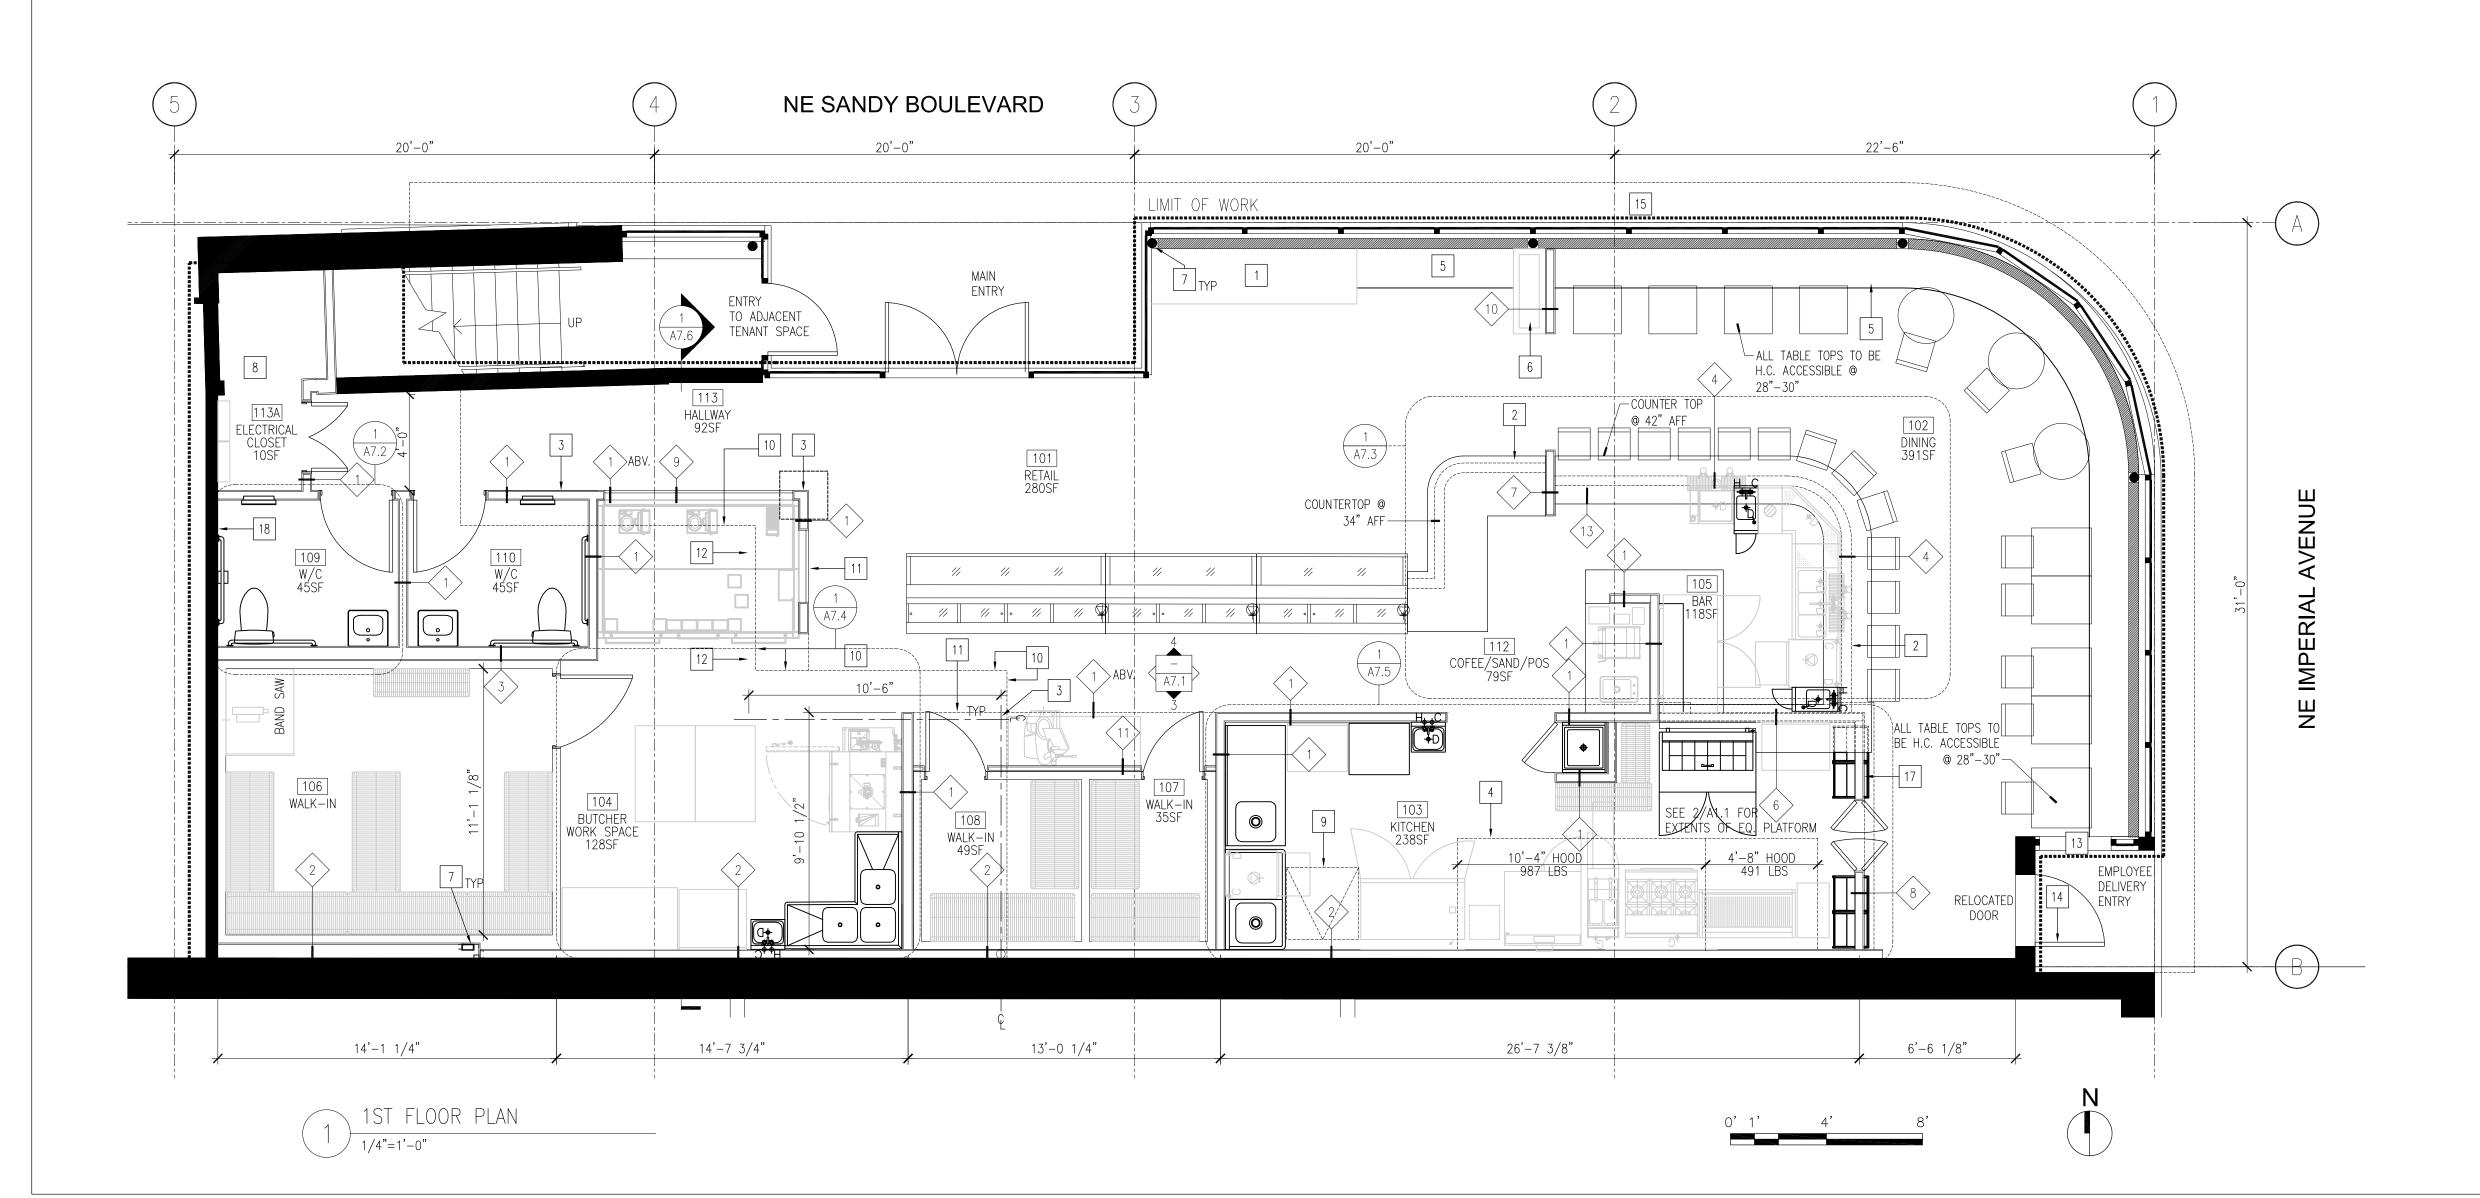

### 1ST FLOOR PLAN LEGEND

EXISTING WALL CONSTRUCTION TO REMAIN, SEE ELEVATIONS FOR FINISH

NEW WALL CONSTRUCTION

EX EXTENTS OF 2nd FLOOR


NEW EXTENTS OF 2nd FLOOR

----- EX BEAM CENTER LINE


LIMIT OF WORK 1' OFFSET FROM

ACTUAL LOW.

NEW BEAM, SEE STRUCT
GRID LINE

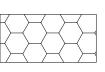

TILE, SEE A5.2

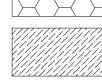

EPOXY COATED CONCRETE, SEE SPECIFICATIONS

### GENERAL NOTES

- 1) REFER TO EQUIPMENT SCHEDULES FOR ADDITIONAL
- INFORMATION.

  2) SEE FINISH SCHEDULE FOR WALL TYPE ASSEMBLIES

  3) SEE P-SERIES DRAWINGS FOR FLOOR SINKS/FLOOR DRAINS, CONTRACTOR TO SLOPE FLOOR FOR POSITIVE DRAINAGE TO FIXTURES. ALL LOCATIONS TO BE CONFIRMED W/ CLIENT & ARCHITECT/ ENGINEER PRIOR TO PLACEMENT OF CONCRETE FLOOR.
- FOR WALK-INS (RMS 106, 107, 108), SEE

  MANUFACTURER'S CUT-SHEETS & SPECIFICATIONS.

  WALK-IN DIMENSIONS TO BE CONFIRMED AFTER

  STRUCTURE AND FRAMING PRIOR TO SHOP DRAWINGS.
- 5) WALK-INS SHOWN FOR PLANNING PURPOSES ONLY,
  CONTRACTOR TO SECURE SEPARATE PERMIT FOR
  WALK-INS AND RELATED SCOPE.


### KEY NOTES

- 1 RETAIL FIXTURE, SEE A8.5 FOR DTL
- 2 DIE WALL BELOW
- 3 NEW COLUMN W/ FOOTING, SEE STRUCT
- 4 HOOD EXTENTS, COORDINATE W/ M SERIES, SEE PLAN FOR WEIGHT
- 5 BUILT-IN SEATING, SEE 8/A8.1 FOR DTL
- 6 BUILT-IN PLANTER, SEE 9/A8.2 FOR DTL
- 7 EX COLUMN TO REMAIN, SEE STRUCT
- 8 MAINTAIN 36" CLR FROM FACE OF ELEC PANEL TO INSIDE FACE OF FINISH WALL
- 9 ACCESS HATCH
- 10 EX EXTENTS OF CEILING
- 11 NEW EXTENTS OF CEILING, SEE ELEVATIONS
- 12 NEW BEAM, SEE STRUCT
- 13 INFILL STOREFRONT MATCH EXST WALLTOP
- 14 RECLOCATE SALVAGED DOOR TO ORIGINAL LOCATION
- ADD ALT: PROVIDE POWDER COAT TO EX. STOREFRONT
- 16 SEE MEP FOR DHW LOCATION
- 17 SEE STRUCT FOR 2nd FLOOR FRAMING
- 18 ALL PARTITIONS ABUTING OTHER TENANTS TO HAVE A RATING OF 1HR

# Piccone's Corner Market

Portland, OR

KEY PLAN

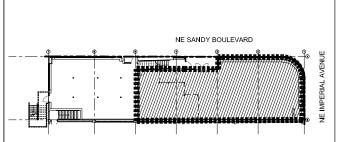

OWNER REQUESTED/
AS BUILT CONDITIONS

PLAN REVIEW REVISIONS
STRUCT - CS12397520070

PLAN REVIEW REVISIONS
FS - FM9714380038
LS - fI10429034078
STRUCT - CS9644459043

O8.05.2019

04.29.2019

04.12.2019

REVISION



18 Market St Cambridge, MA 02139 617.714.3369 646.526.5564

Project: PICCONE'S CORNER MARKET

Drawn By: JC Checked By: AJS/SMC


Date: 02.20.2019


Scale: 1/4" = 1'-0"

Drawing Title:

1ST & EQ. PLATFORM FLOOR PLANS


A1.1

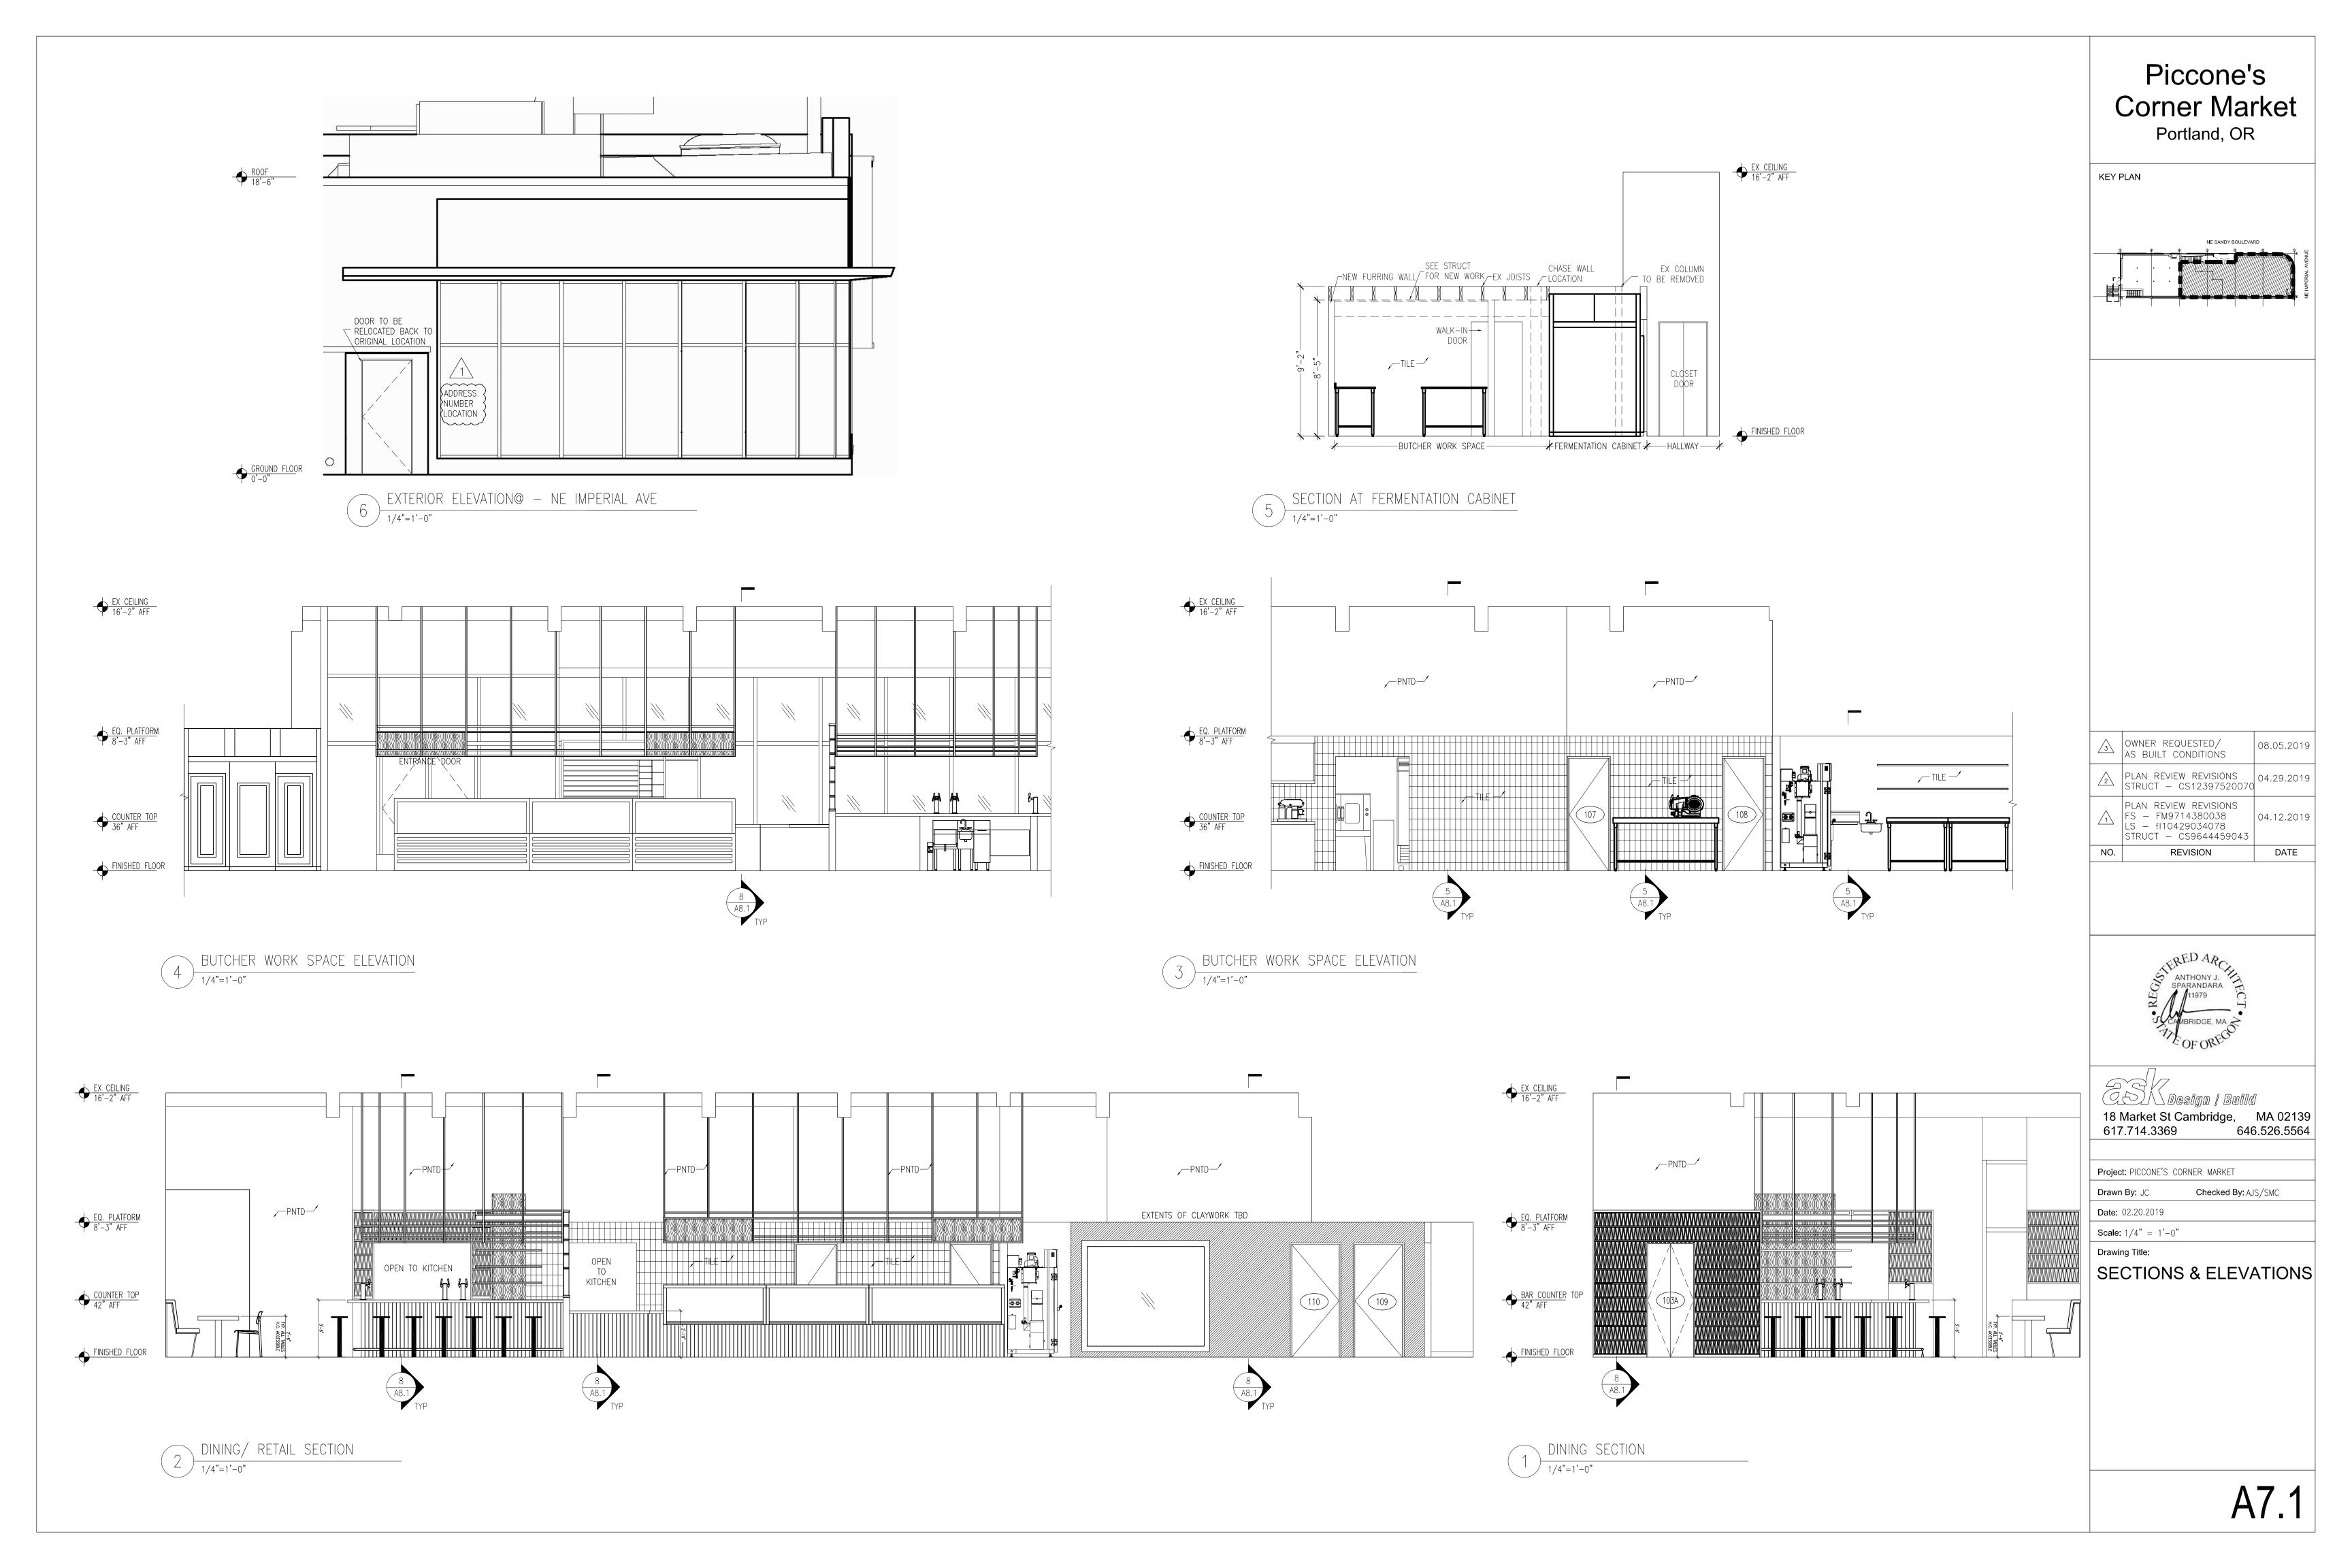

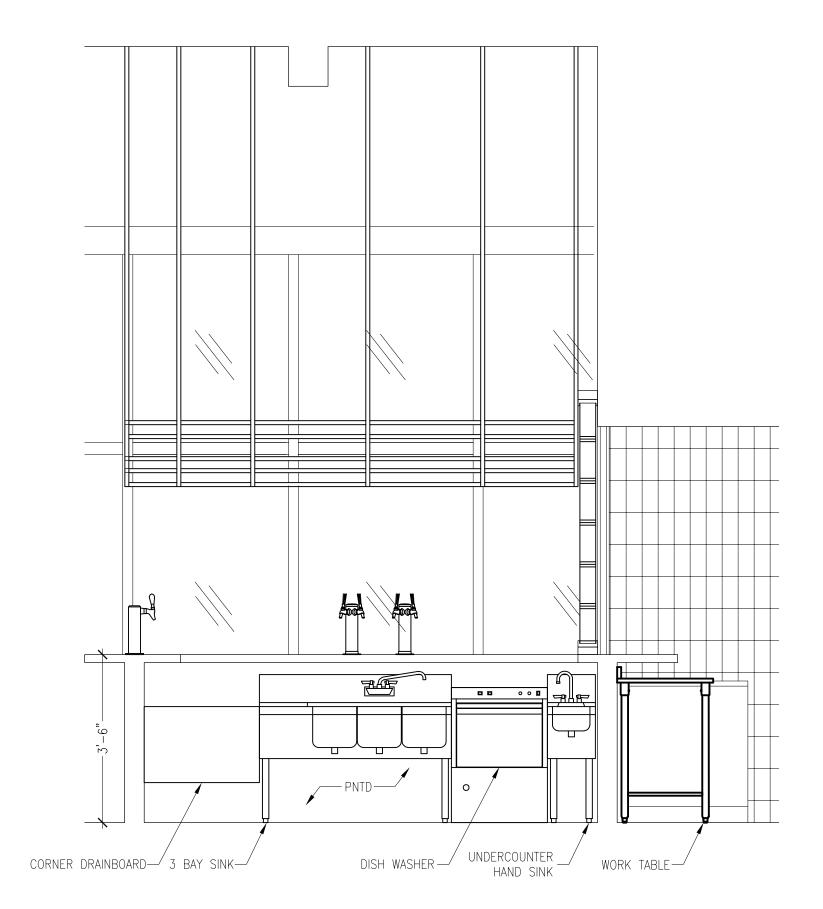


BAR EQUIPMENT ELEVATION

1/2"=1'-0"

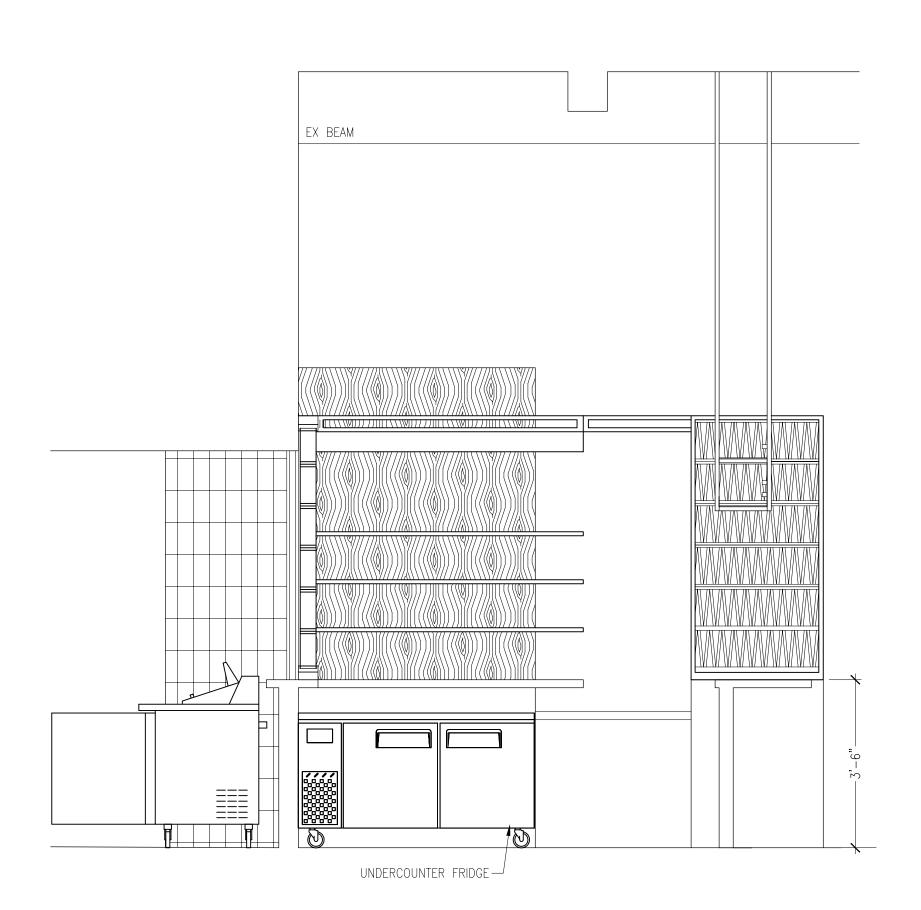


BAR EQUIPMENT ELEVATION

1/2"=1'-0"

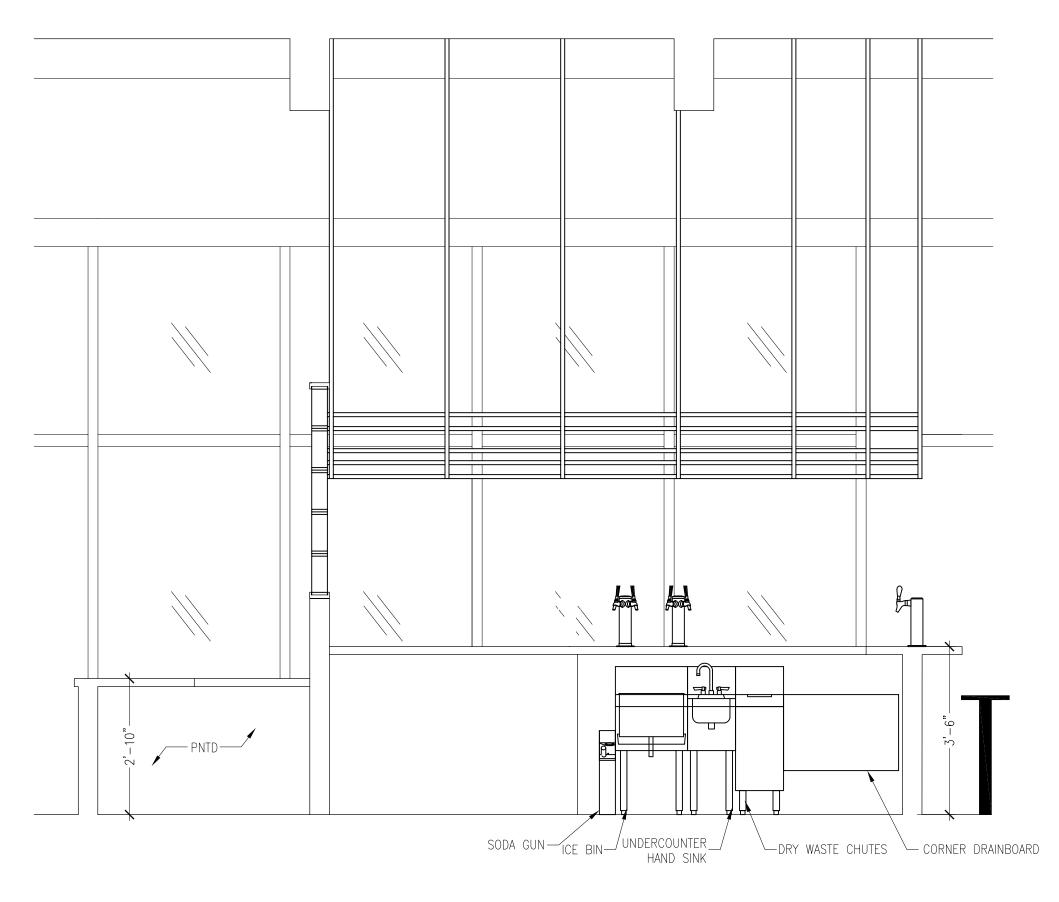


BAR EQUIPMENT ELEVATION

1/2"=1'-0"

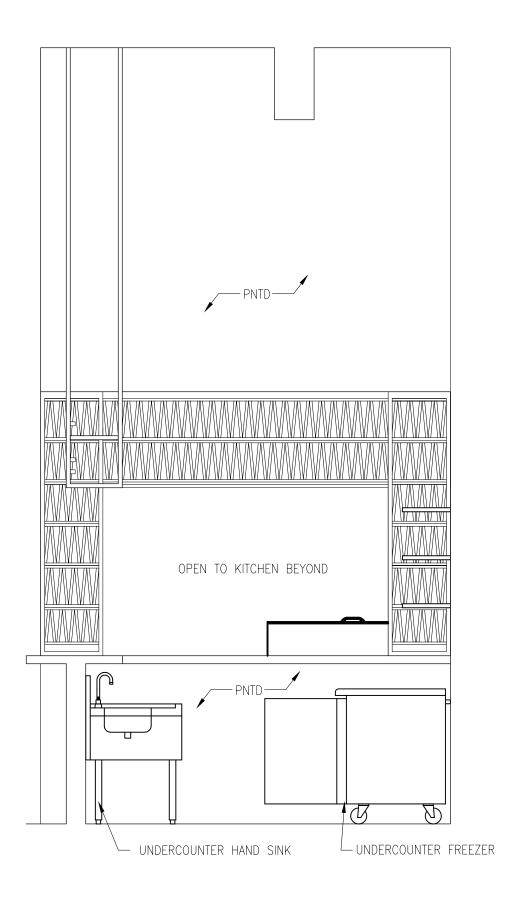

BAR EQUIPMENT ELEVATION

1/2"=1'-0"

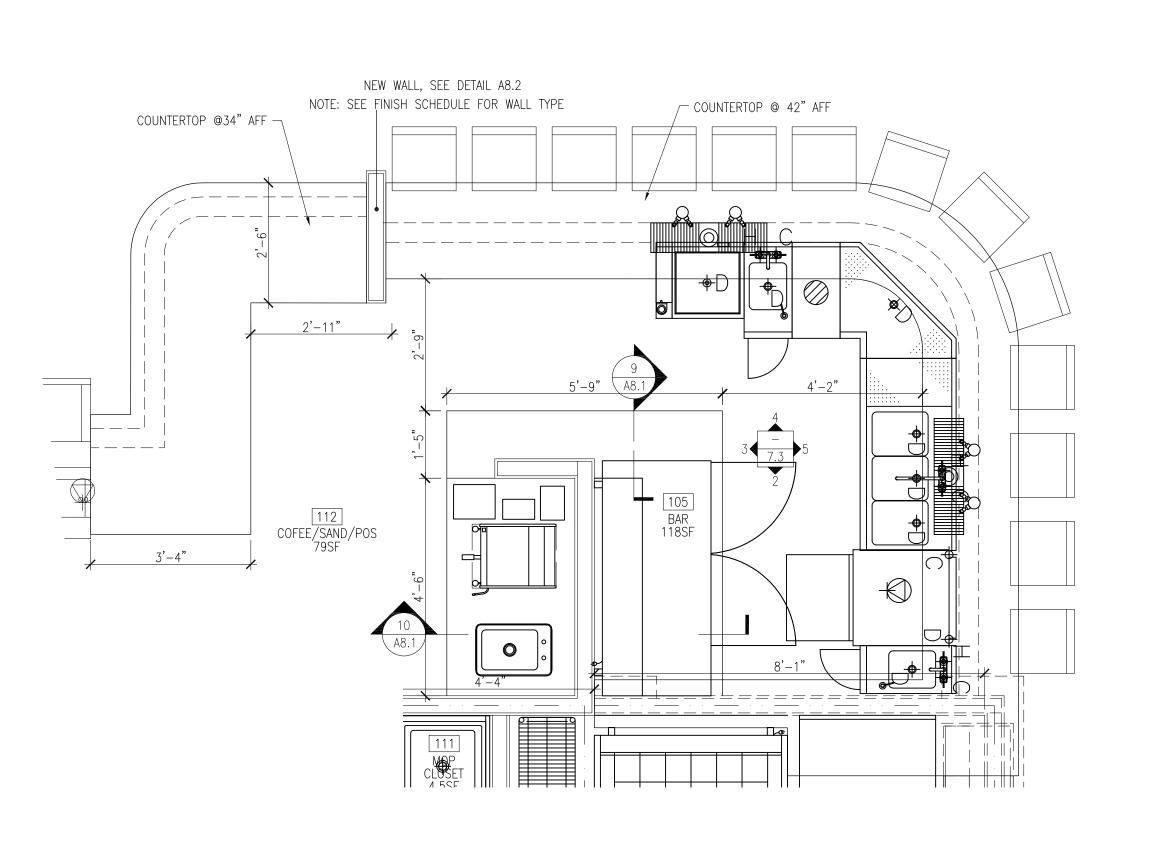


BAR ENLARGED PLAN

1/2"=1'-0"

# Piccone's Corner Market Portland, OR

KEY PLAN

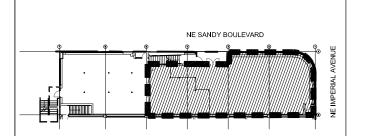

OWNER REQUESTED/
AS BUILT CONDITIONS

PLAN REVIEW REVISIONS
STRUCT - CS12397520070

PLAN REVIEW REVISIONS
FS - FM9714380038
LS - fl10429034078
STRUCT - CS96444459043

08.05.2019

04.29.2019

04.12.2019

NO. REVISION DAT



Design | Build

18 Market St Cambridge, MA 02139
617.714.3369 646.526.5564

Project: PICCONE'S CORNER MARKET

Drawn By: JC Checked By: AJS/SMC

Date: 02.20.2019

Scale: 1/2" = 1'-0"

Drawing Title:

BAR ENLARGED

PLAN & ELEVATIONS

A7.3