Development Services

From Concept to Construction







APPEAL SUMMARY

Status: Decision Rendered - Held over from ID 20210 (4	(4/3/19) for additional information
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Appeal ID: 20267	Project Address: 1440 N Rivergate Blvd
Hearing Date: 4/17/19	Appellant Name: Gary M. Livermore
Case No. : B-018	Appellant Phone: 503-892-3002
Appeal Type: Building	Plans Examiner/Inspector: Connie Jones
Project Type: commercial	Stories: 1 Occupancy: B Construction Type: V-B
Building/Business Name:	Fire Sprinklers: Yes - 13d Sprinklers in Trailer
Appeal Involves: Erection of a new structure	LUR or Permit Application No.: 18-269100-CO
Plan Submitted Option: pdf [File 1] [File 2] [File 3] [File 4]	Proposed use: General Office

APPEAL INFORMATION SHEET

Appeal item 1

Code Section

503.1, 602.1

Requires

OSSC Section 503.1 states that the building height and area shall not exceed the limits specified in Table 503 based on the type of construction as determined by Section 602 and the occupancies as determined by Section 302 except as modified thereafter. Each portion of a building separated by one or more fire walls complying with Section 706 shall be considered a separate building.

OSSC Section 602.1 states that buildings and structures erected or to be erected, altered altered or extended in height or area shall be classified in one of the five construction types defined in Sections 602.2 through 602.5. The building elements and exterior walls shall have fire ratings as identified in Chapter 6.

Proposed Design

EVRAZ intends to install two trailers at the south side of the existing Pipe Forming Mill Building on their site. The Pipe Forming Mill is approximately 232,000 square feet, single-story, Type IIB construction (nonsprinklered) and F-2 occupancy. It was permitted in 2005 as an unlimited area building. The trailers are 480 square feet and 2,160 square feet respectively and are premanufactured units of VB. The 480 square foot unit will be located 9'-0" from the face of the Pipe Forming Mill Building and the 2,160 square foot unit will be located 5'-0" from the face of the existing building.

The trailers will have NFPA 13d sprinklers throughout.

Reason for alternative The trailers are premanufactured units of VB construction that cannot be modified or their "gold seal" certification will be invalidated. They must be located adjacent to the existing Pipe Forming Mill to provide the required support functions to the existing building. The roadway to the south

does not allow the buildings to be moved any further away from the existing Pipe Forming Mill Building.

NFPA 13d sprinklers will be provided in the two trailers. This sprinkler system will be provided in another trailer that will be installed on site (Fire Code Appeal #19026). Four fire hydrants are located in the roadway to the south of the trailers and existing building. One hydrant is directly in front of the trailers (see drawing FR1.00).

The combined area of the trailers is approximately 1% of the area of the Pipe Forming Mill Building. They provide little danger to the existing noncombustible building. Trailers are also approximately 75'-0" from the property line to the south.

Appeal item 2

Code Section

507.5

Requires

OSSC Section 507.5 allows for a reduction in the 60 foot yards of unlimited area buildings. This section applies to nonsprinklered, one story Group F-2 buildings among others.

Proposed Design

EVRAZ intends to install two trailers on the south side and adjacent to the existing :Pipe Forming Mill Building. One trailer will be 9'-0" from the face of the Pipe Forming Mill Building and the other trailer will be 5-0" from the face of the building. The trailer that is located 9'-0" from the Pipe Forming Mill Building is 480 square feet. The second trailer is 2,160 square feet. The buildings will provide support office and toilet room space for the adjacent Pipe Forming Mill Building and are Type VB construction and B occupancy. EVRAZ intends to install NFPA 13d sprinkers in these trailers.

The Pipe Forming Mill is approximately 232,000 square feet, single-story and Type IIB construction (nonsprinklered) and F-2 occupancy. It was permitted in 2005 as an unlimited area building. An appeal (#1858) was approved during the permitting of this building to allow an approximately 77'-7" length of wall section to be to have a reduced yard distance of 56'-5'.

Directly north of the existing Pipe Forming Mill Building is the Pipe Coating Mill Building. Approximately 95'-0" of this building is within approximately 20'-0" of the face of the Pipe Forming Mill Building. Approximately 180'-0" of this building is with 45'-0" of the face of the Pipe Forming Mill Building. The Coating Mill Building is 107,675 square feet, single-story. It was permitted in 2006 as Type IIB construction (sprinklered) and F-2 occupancy. Accessory occupancies in this building (H-3 and B) are approximately 8.1% of the overall area of the building.

A reconsideration is requested of the encroachment of the Coating Mill Building to the north into the 60 foot yard of the Pipe Forming Mill Building. It appears that this condition was not previously

addressed when it was permitted adjacent to the Pipe Forming Mill Building. It seems that these buildings should be considered as a single unlimited area building.

A reconsideration is also requested of Appeal #1858 which allowed no future expansion in the 60'-0" yard to the south of the Pipe Forming Mill Building. The trailers will be installed in this 60'-0" yard.

Reason for alternative The trailers are premanufactured units of VB construction and cannot be modified. They must be located adjacent to the existing Pipe Forming Mill Building to provide the required function.

> The installation of the trailers creates a reduction in the 60 foot yards of the two existing buildings of 100 feet which is approximately the same amount of the previously approved Appeal #1858. Even with the reduced yards related to Appeal #1858 and the two trailers, the buildings maintain

60 foot yards around approximately 95% of their perimeter. It should also be noted that although the two trailers, which total 2,640 square feet, are within the 60 foot yard of the existing building, they provide a 75'-0" yard to the adjacent property line to the south.


The trailers will be equipped with NFPA 13d sprinklers. The south side of the Pipe Forming Mill Building as well as the trailers, are further protected by 4 fire hydrants along the roadway at the south of the Pipe Forming Mill Building. One hydrant is directly in front of the trailers (see attached Fire & Rescue Plan FR1.00).

APPEAL DECISION

- 1. Separation between Type VB and Type IIB construction: Granted as proposed.
- 2. Encroachment into 60 foot yards for unlimited area building: Granted as proposed.

The Administrative Appeal Board finds that the information submitted by the appellant demonstrates that the approved modifications or alternate methods are consistent with the intent of the code; do not lessen health, safety, accessibility, life, fire safety or structural requirements; and that special conditions unique to this project make strict application of those code sections impractical.

Pursuant to City Code Chapter 24.10, you may appeal this decision to the Building Code Board of Appeal within 180 calendar days of the date this decision is published. For information on the appeals process and costs, including forms, appeal fee, payment methods and fee waivers, go to www.portlandoregon.gov/bds/appealsinfo, call (503) 823-7300 or come in to the Development Services Center.

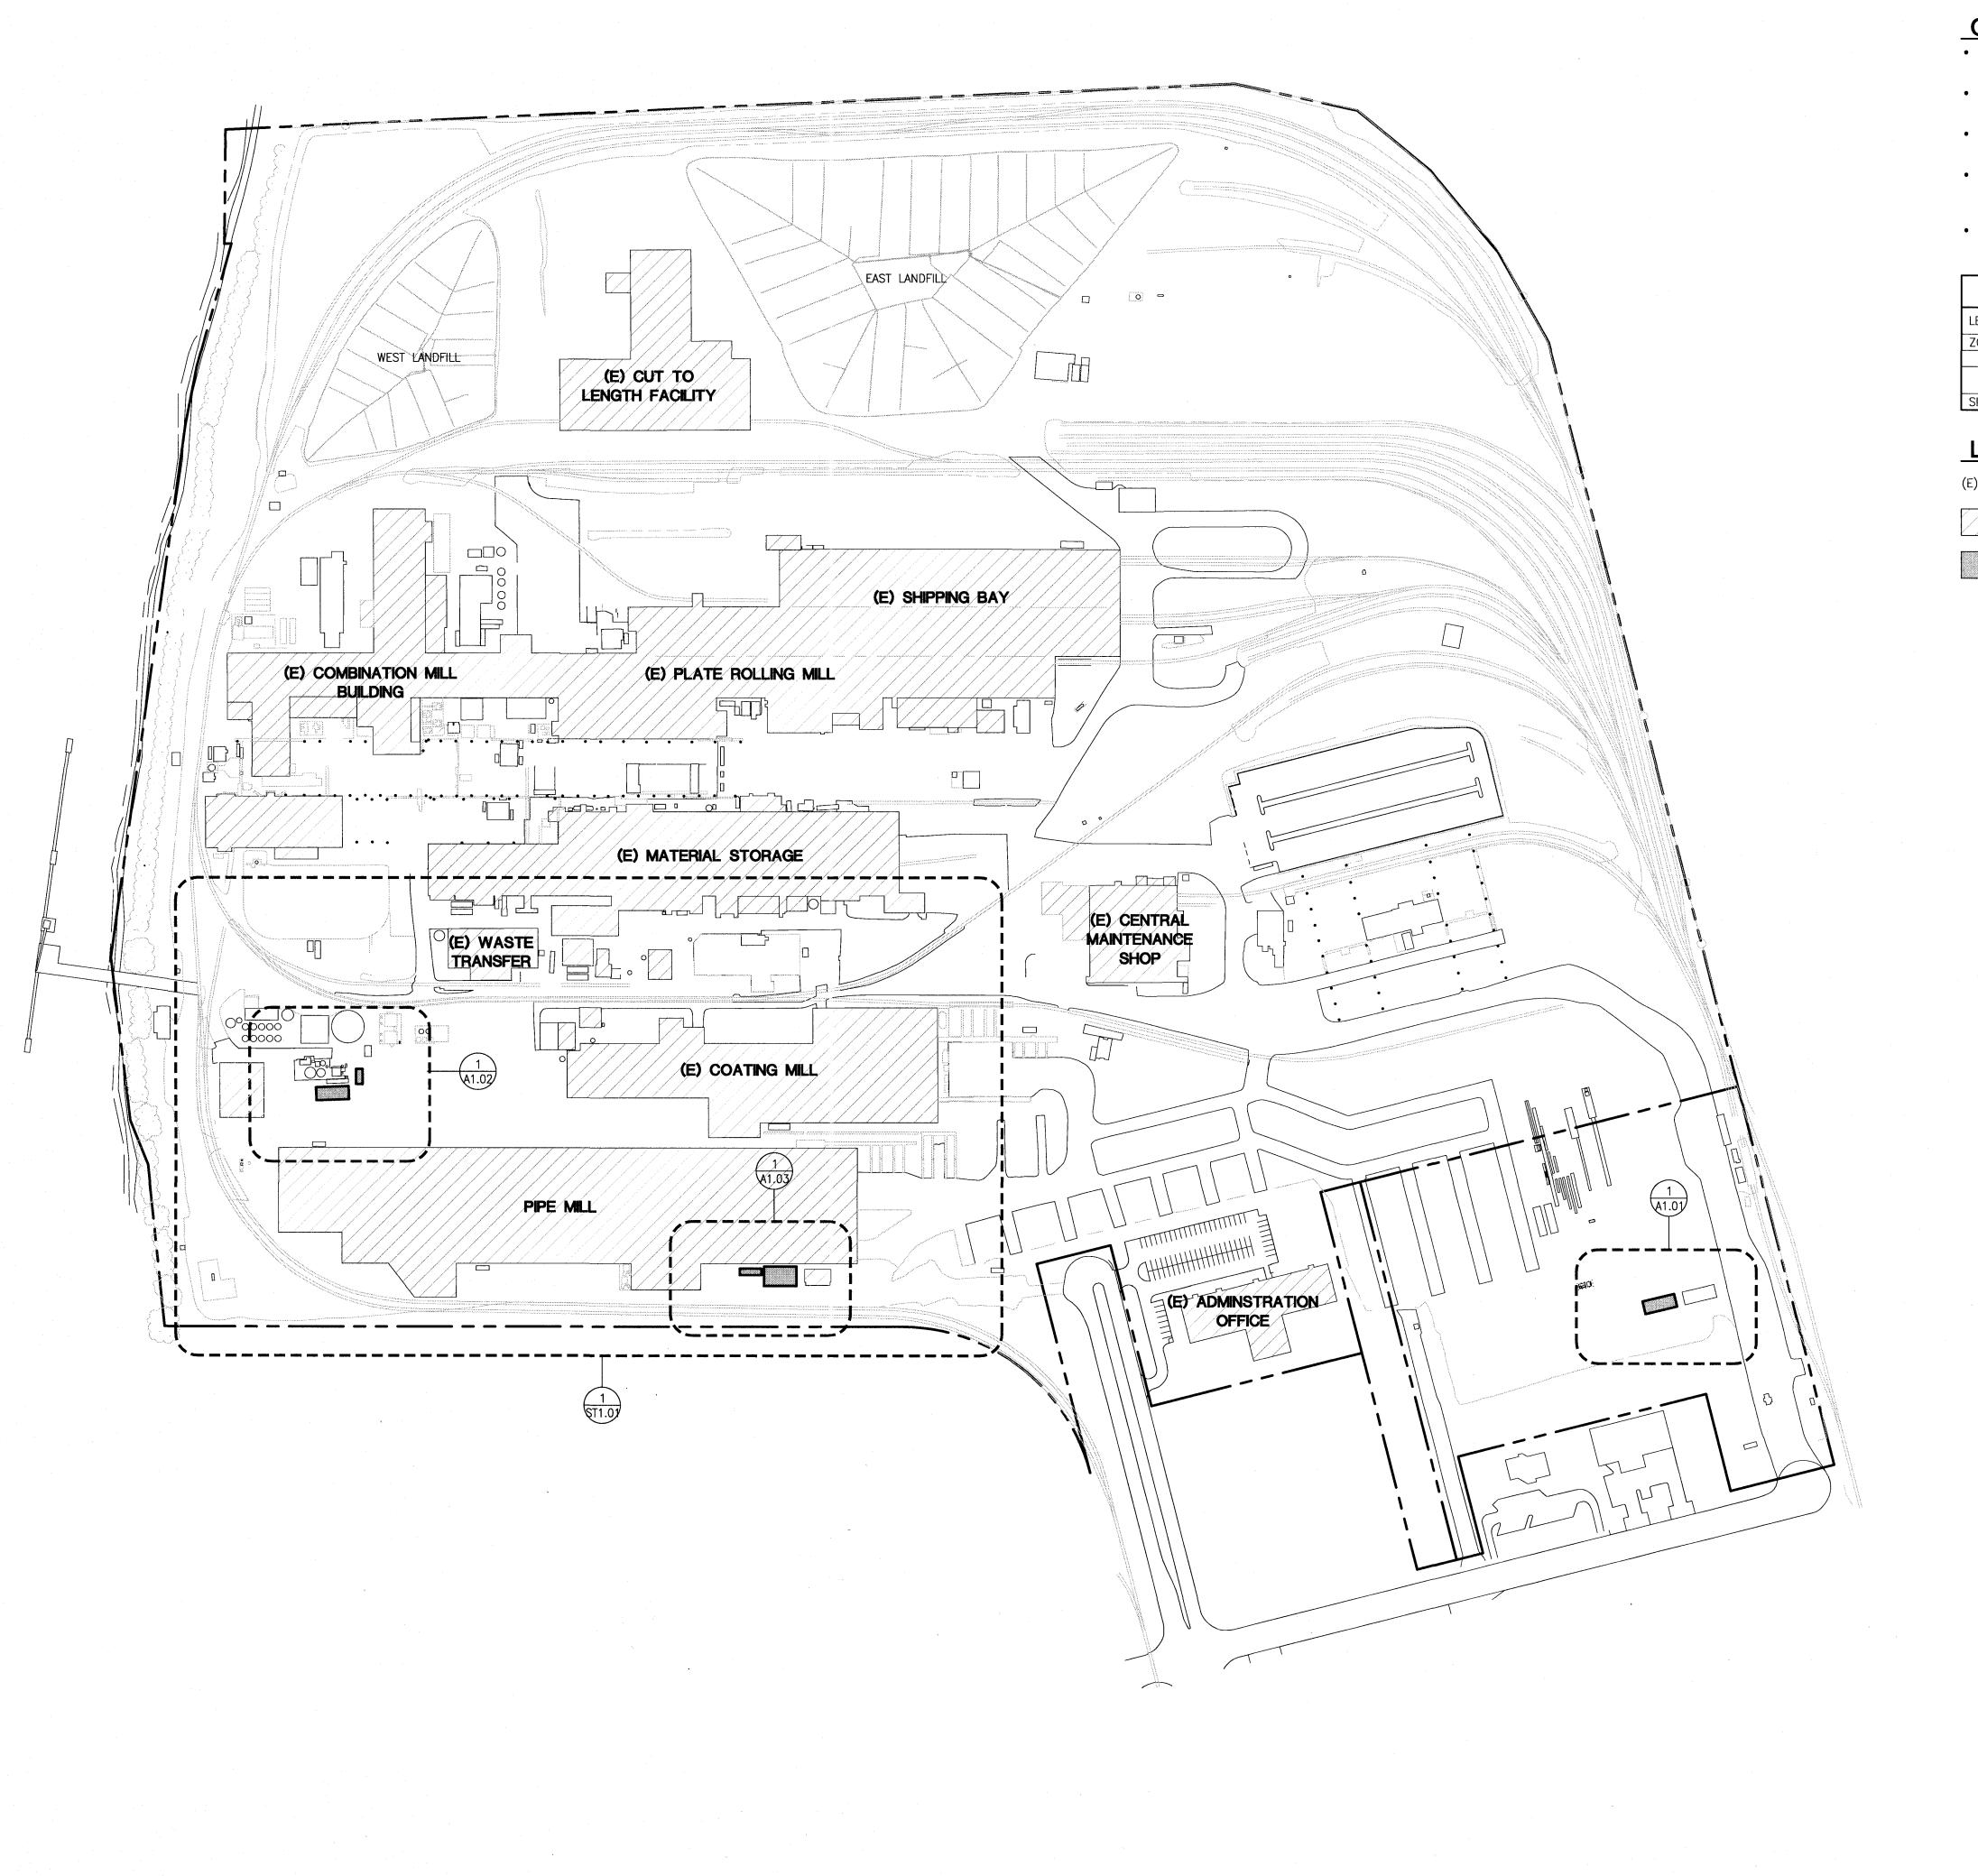

GENERAL NOTES

- THE CONTRACTOR SHALL HAVE A FULL SET OF THE CURRENT APPROVED CONSTRUCTION DOCUMENTS INCLUDING ADDENDA ON THE PROJECT SITE AT ALL TIMES
- THE CONTRACTOR SHALL COMPLY WITH LOCAL UTILITY PROVIDERS REQUIRING NOTIFICATION OF INTENDED EXCAVATION.
- ALL WORK SHALL COMPLY WITH THE LOCAL JURISDICTION REQUIREMENTS AND THE PROJECT SPECIFICATIONS.
- THE CONTRACTOR SHALL VERIFY ALL EXISTING CONDITIONS AND DIMENSIONS SHOWN OR IMPLIED WHICH MAY AFFECT THE WORK PRIOR TO THE START OF CONSTRUCTION AND NOTIFY THE ENGINEER OF RECORD OF ANY DISCREPANCIES.
- EXISTING CONDITIONS BASED ON DRAWINGS BY EVRAZ DATED 07/26/2018

	GENERAL SITE INFORMATION		OR PE	FOR PE	OR CIT	EAL	OR CIT	
LEGAL DESCRIPTION	TAX LOT-22, 25, 27, 71 - SECTION 26, T2N, R1W, WM		SC.	SED		APP	ED	-
ZONING			SSL SSL	REVI	ISS	NS	SSU	
BASE	IH — HEAVY INDUSTRIAL		<u> </u>	Tac.	57		0)	
OVERLAY	h,i,k — AIRCRAFT LANDING, RIVER INDUSTRIAL, PRIME INDUSTRIAL		TE 25/18	15/18	7	29/19	5/19	
SITE AREA	145.82 ACRES	- 1	2 5	11/	I 🔨 I	3/2	4/1	
		l	* -	2	3	5	9	

LEGEND

EXISTING

EXISTING BUILDING

TRAILER INSTALLATION

GARY LIVERMORE 5844

1500 SW First Ave. Suite 240 Phone: 503-892-3002 Portland Oregon 97201 www livermoreae com

Livermore A&E JOB NO: 218064.00

FEEL PORTLAND


OREGON STE RIVERGATE BLVD.

DRAWING TITL

drawn by: TKP checked by: GML

ST1.00

1 SITE PLAN 6T100 1" = 160'-0"

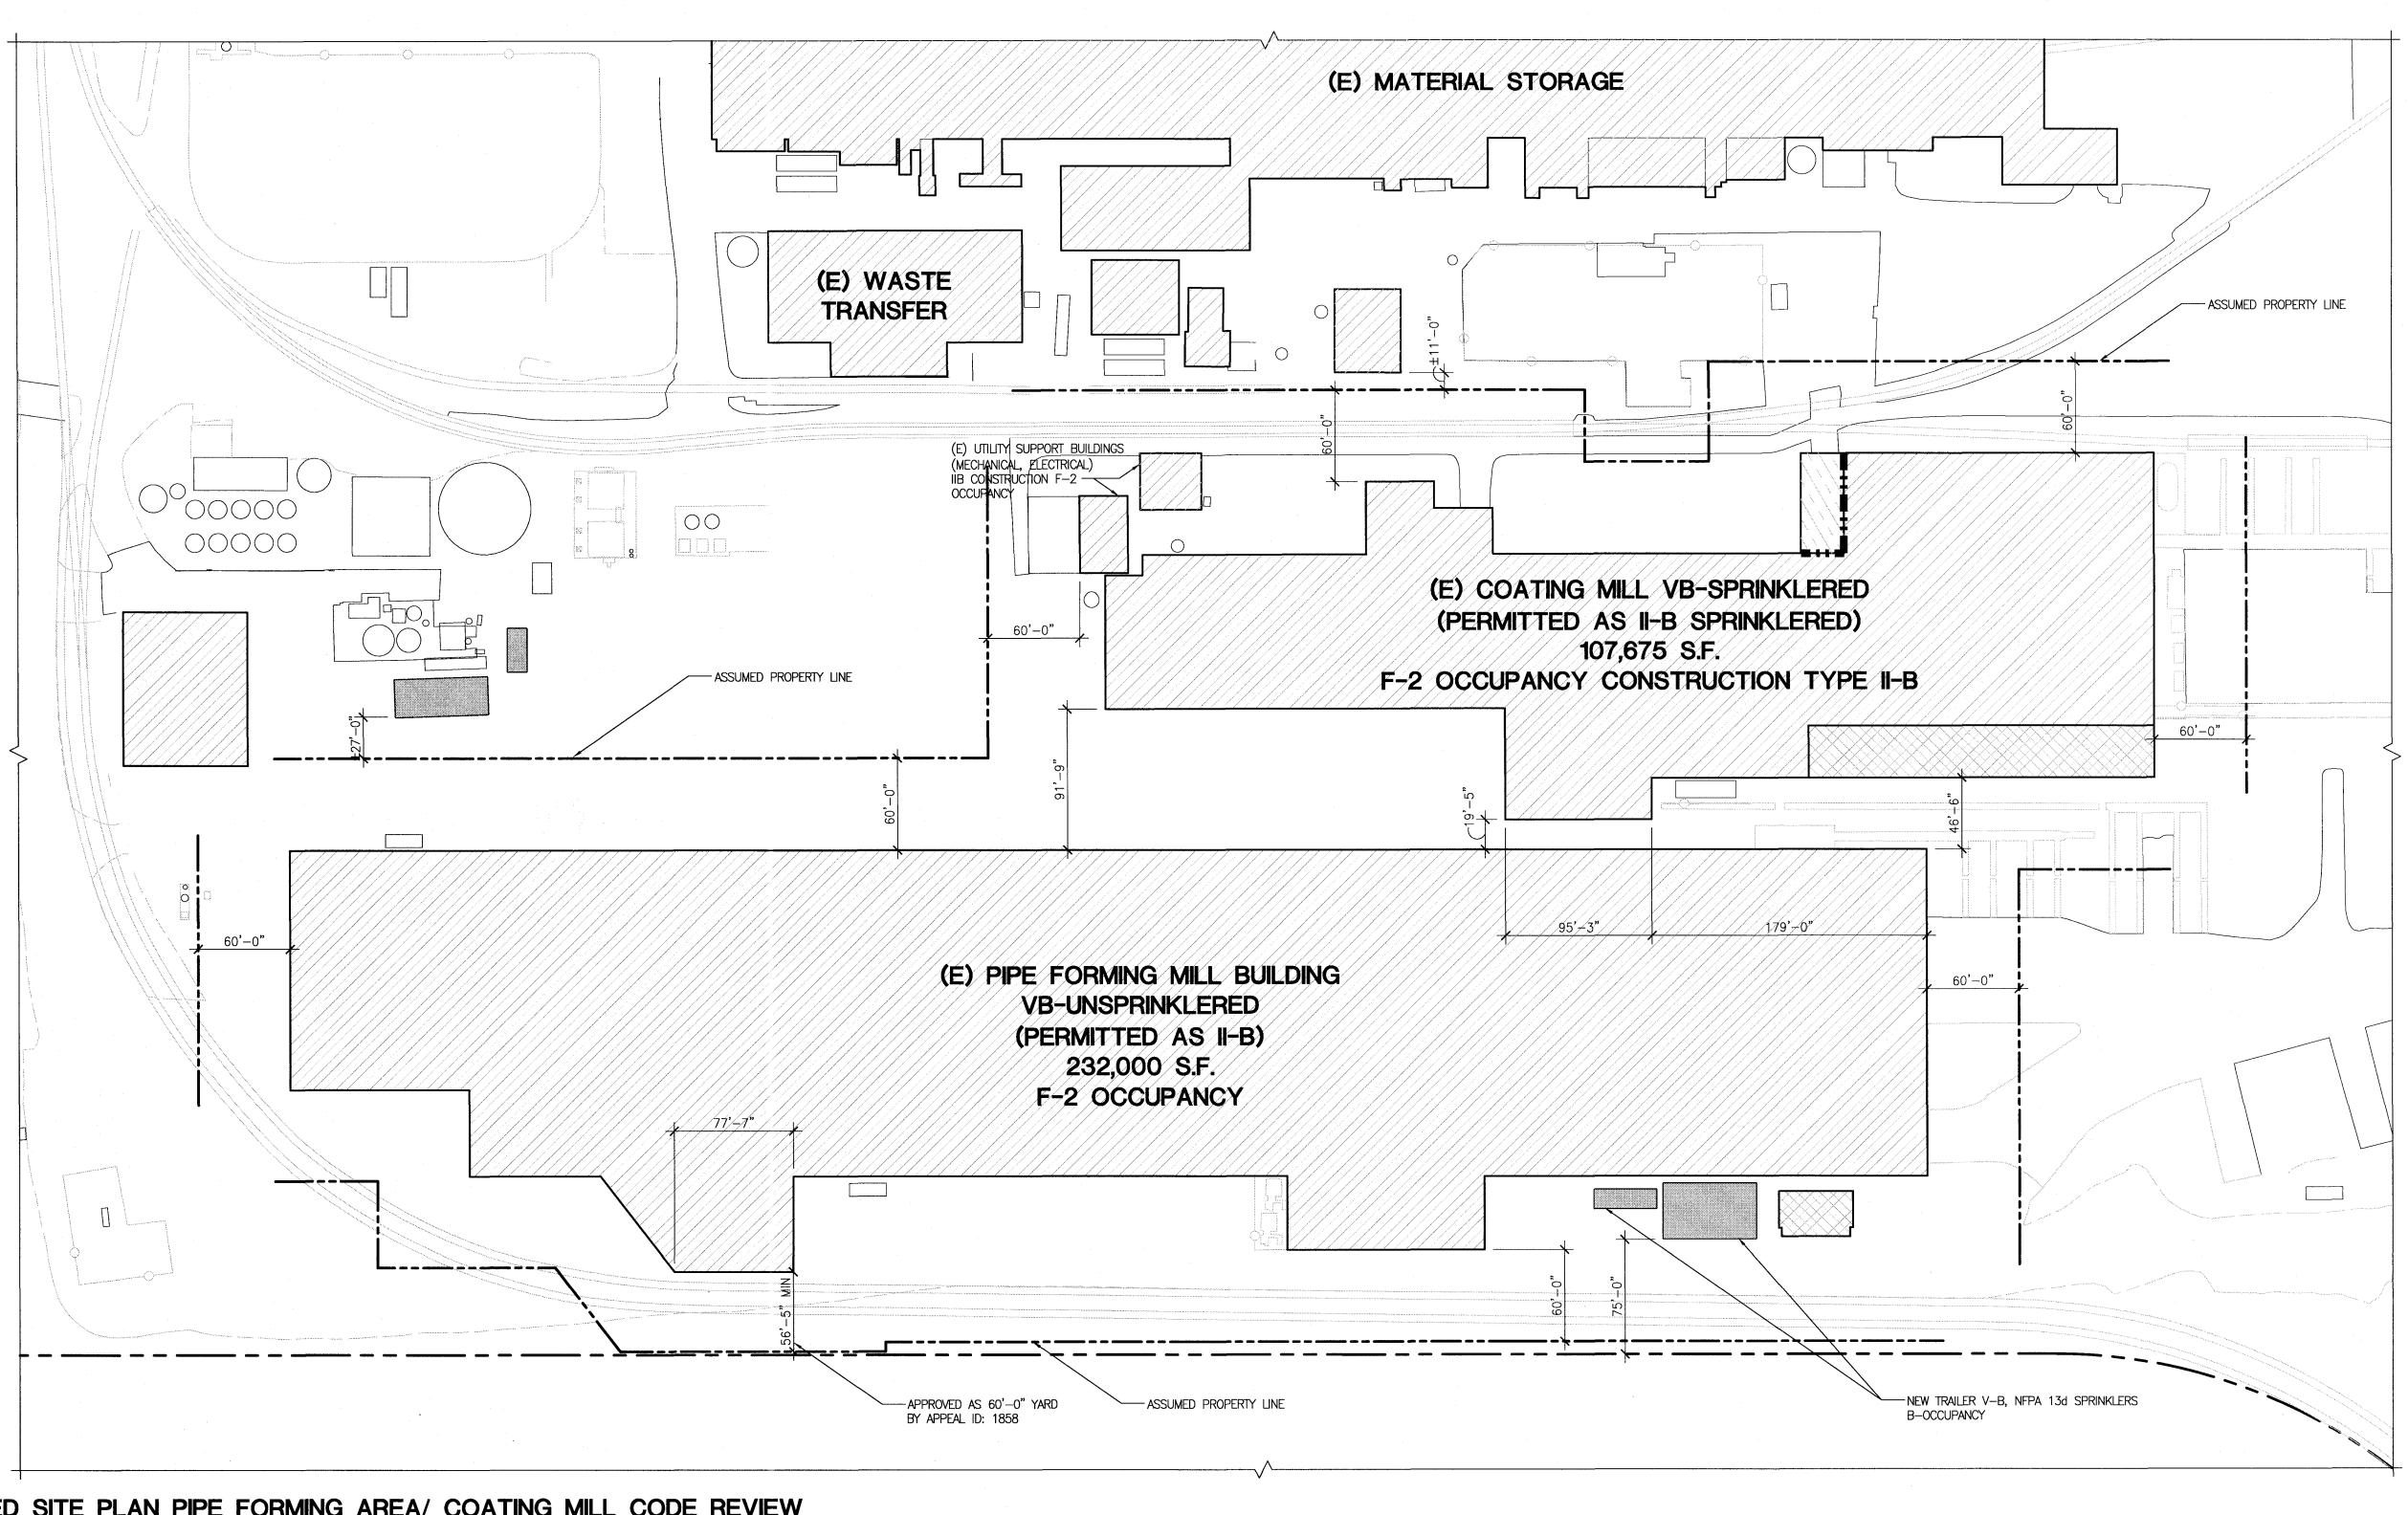

1 ENLARGED SITE PLAN PIPE FORMING AREA/ COATING MILL CODE REVIEW

1" = 60'-0"

(E) COATING MILL CODE REVIEW

PERMIT No.: 06-130004-000-00-CO

APPROVED OCCUPANCY: F2, H-3 PAINT STORAGE ROOM, II-B CONSTRUCTION, SPRINKLERED, ONE STORY

ACTUAL BUILDING AREA: 107,675 SF. H-3 OCCUPANCY AREA: 1,820 SF. B OCCUPANCY AREA: 6,915 SF.

ACCESSORY TO F-2 OCCUPANCY AREA: 8,735 SF. (B OCCUPANCY) TOTAL ACCESSORY AREA/ ACTUAL BUILDING AREA: 8,735 SF./ 107,675 SF. = 8.11% < 10%

(E) PIPE FORMING MILL CODE REVIEW

PERMIT No.: 05-117941-000-00-CO

APPROVED OCCUPANCY: F2, II-B CONSTRUCTION, UNSPRINKLERED, ONE STORY.

ACTUAL BUILDING AREA: 232,000 SF.

(N) TRAILERS

OCCUPANCY: B, VB CONSTRUCTION, NFPA 13d SPRINKLERS.

ACTUAL BUILDING AREA: 480 SF. + 2,160 SF. = 2,640 SF.

CODE PLAN LEGEND

(E) EXISTING

OCCUPANCY GROUPS:

F-2

H-3

TRAILER INSTALLATION

(E) FIRE BARRIER — 2 HR FIRE RATING

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- EXISTING CONDITIONS BASED ON DRAWINGS BY EVRAZ DATED 07/26/2018

DATE DESC.

1 3/04/19 ISSUED FOR CITY COMMENTS
5 3/29/19 LNS APPEAL
6 4/15/19 ISSUED FOR CITY COMMENTS

GARY LIVERMORE 5844

500 SW First Ave. Suite 240 Phone: 503-892-3002 ontland. Oregon 97201 www.livermoreae.com

JOB NO: 218064.00


N STEEL PORTLAND

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DRAWING TITLE:
ENLARGED SITE PLAN
PIPE FORMING AREA

drawn by: MGV checked by: GML

ST1.01

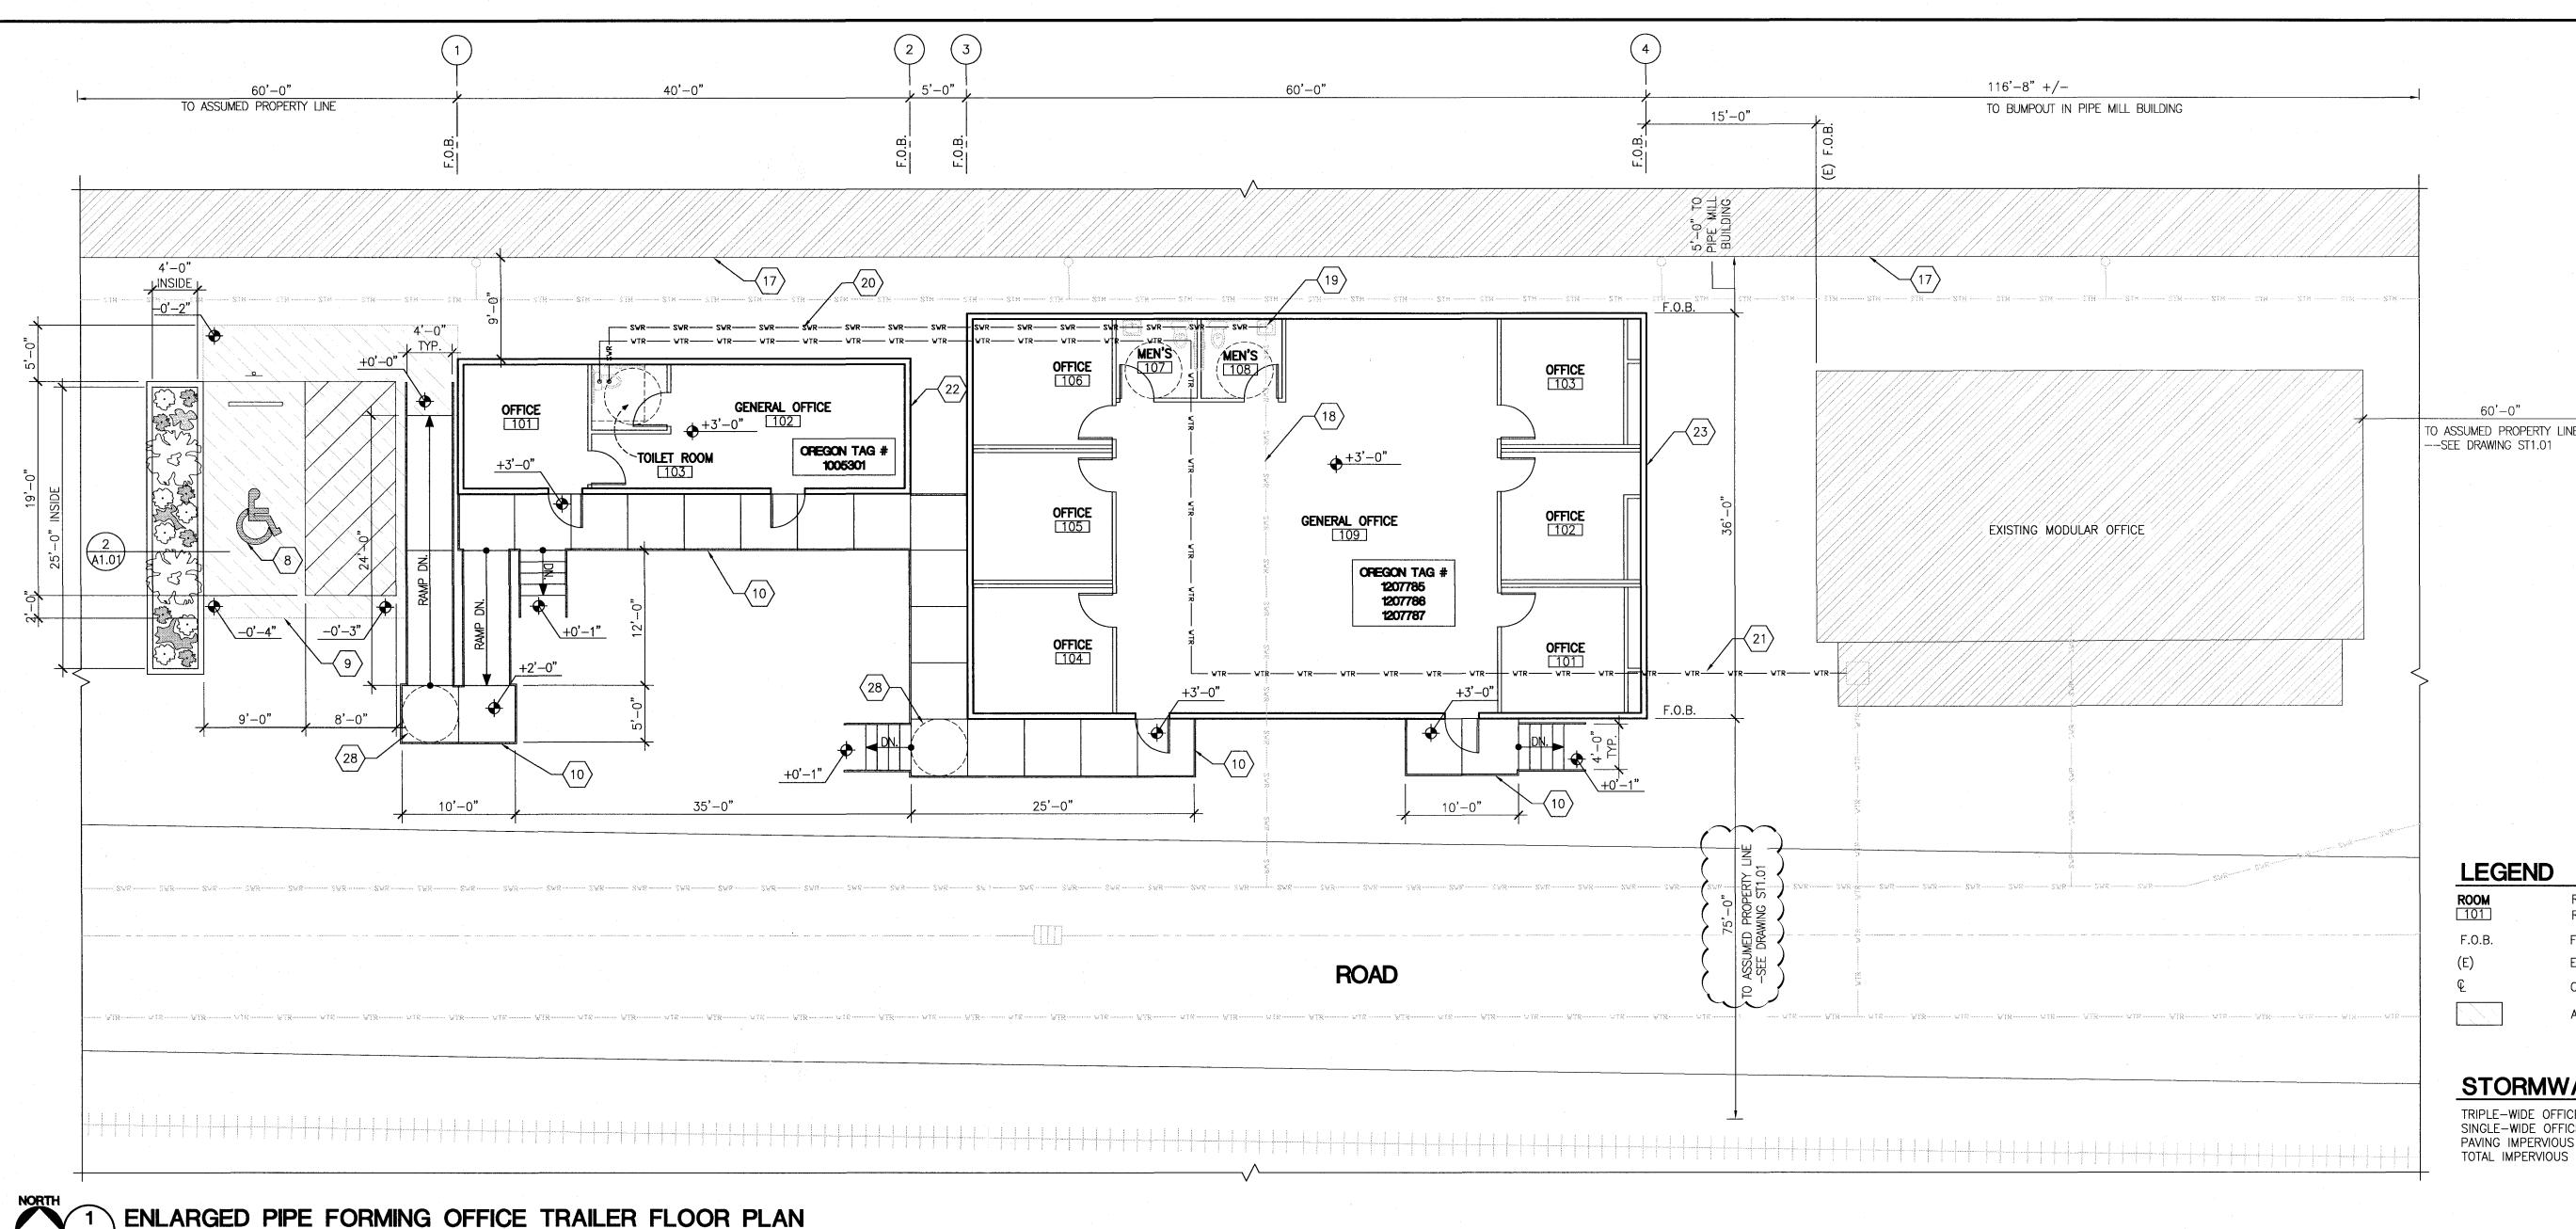

LEGEND

ROOM ### FACE OF BUILDING EXISTING

CENTERLINE ASPHALT PAVING

STORMWATER NOTES

TRIPLE-WIDE OFFICE TRAILER IMPERVIOUS AREA = 2,160 S.F. SINGLE-WIDE OFFICE TRAILER IMPERVIOUS AREA = 480 S.F. PAVING IMPERVIOUS AREA = 505 S.F. TOTAL IMPERVIOUS AREA = 3,145 S.F.

FLOOR PLAN GENERAL NOTES

- APPLICABLE CODES: ALL WORK SHALL BE IN CONFORMANCE WITH ALL FEDERAL, STATE, AND LOCAL CODES. SPECIFICATIONS AND STANDARDS SHALL MEAN, AND ARE INTENDED TO BE, THE LATEST EDITION, AMENDMENT OR REVISION OF SUCH REFERENCE STANDARD, IN EFFECT AS OF THE DATE OF THE CONTRACT DOCUMENTS.
- CONTRACTOR TO VERIFY EXISTING CONDITIONS AND DIMENSIONS SHOWN OR IMPLIED PRIOR TO START OF CONSTRUCTION AND NOTIFY A/E OF ANY DISCREPANCIES.
- CONTRACTOR SHALL PROVIDE ALL NECESSARY TESTING AND COORDINATE ALL REQUIRED INSPECTIONS.

STAIR/RAMP NOTES

PROVIDE 48" WIDE COMMERCIAL PREFABRICATED ALUMINUM STAIRS & RAMP. SEE DRAWING A2.01 MEET ALL OSSC ACCESSIBILITY REQUIREMENTS.

- RAMPS 1:12 SLOPE WITH GUARDRAILS/HANDRAILS EACH SIDE.
- PROVIDE HANDRAIL EXTENSIONS AT STAIRS & RAMPS PER OSSC ACCESSIBILITY REQUIREMENTS.
- STAIRS & RAMPS SHALL BE DESIGNED FOR 100 PSF LIVE LOAD AND HANDRAIL AND GUARDRAIL LOADS AS REQUIRED BY CODE.
- STAIRS & RAMPS SHALL BE SUBMITTED BY THE SUPPLIER AS A DEFERRED SUBMITTAL.

UTILITY NOTES

SANITARY

SANITARY: CAST IRON PIPE: SERVICE WEIGHT FITTING: JOINTS:

4", MIN. 2% SLOPE ASTM A74, HUBLESS, CAST IRON

NEOPRENE GASKETS AND STAINLESS STEEL CLAMP AND SHIELD ASSEMBLIES. HUSKY SD4000 OR APPROVED SUBSTITUTE. J.R. SMITH, ZURN, WADE, OR EQUAL

CLEANOUT:

WATER PIPING, ABOVE GRADE COPPER TUBING: ASTM B88, TYPE L, HARD DRAWN FITTING: ANSI/ASTM 16.22 SOLDER, GRADE 95TA INSULATION: 1/2 INCH DISINFECT, CLEAN, AND TEST: PER CODE


WATER PIPING, BELOW GRADE AS APPROVED BY CITY OF PORTLAND

FLOOR PLAN KEYNOTES

- (1) EXISTING MANHOLE, GRINDER PUMP.
- (2) EXISTING 1" UNDERGROUND WATER LINE.
- EXISTING 4" UNDERGROUND SANITARY SEWER LINE --2% SLOPE.
- 24'-0" WIDE x 60'-0" LONG DOUBLE-WIDE TRAILER. PROVIDE FOUNDATIONS PER STRUCTURAL DRAWINGS. CONNECT WATER AND SEWER TO EXISTING UTILITY STUB-OUT UNDER TRAILER. EXISTING ELECTRICAL SERVICE.
- SAWCUT AND REMOVE EXISTING CONCRETE SLAB UNDER TRAILER FOOTPRINT.
- EXISTING CONCRETE SLAB ON GRADE.
- VAN ACCESSIBLE PARKING STRIPING AND SIGNAGE -- SEE 1/A2.01.
- 3" ASPHALT PAVING OVER 6" CRUSHED ROCK BASE --SLOPE 2% MAX.
- ACCESSIBLE PRE-FABRICATED STAIRS/RAMP SYSTEM BY OTHERS. PROVIDE GUARDRAIL & HANDRAIL EACH SIDE. SEE NOTES THIS SHEET AND DRAWING A2.01
- EXISTING CONCRETE PAD.
- EXISTING CONCRETE BASE AT EXISTING COOLING TOWER.
- EXISTING STEEL STORAGE UNIT.
- LANDSCAPING PLANTER --SEE DETAIL 2/A1.01.
- 12'-0" WIDE x 28'-0" LONG SINGLE-WIDE TRAILER. PROVIDE FOUNDATIONS PER STRUCTURAL DRAWINGS. CONNECT WATER AND SEWER TO UTILITY LINE EXTENSIONS.
- 24'-0" WIDE x 60'-0" LONG DOUBLE-WIDE TRAILER. PROVIDE FOUNDATIONS PER STRUCTURAL DRAWINGS. CONNECT WATER AND SEWER TO UTILITY LINE EXTENSIONS.
- FACE OF EXISTING BUILDING.
- EXISTING UNDERGROUND SANITARY SEWER LINE --VERIFY SIZE AND DEPTH (4" LINE, 2% SLOPE).
- EXISTING SANITARY SEWER LINE STUB-IP --VERIFY SIZE AND DEPTH. EXTEND LINE TO THE WEST IF POSSIBLE.

- UNDERGROUND SANITARY SEWER LINE EXTENSION --4" LINE, 2% SLOPE. VERIFY DEPTH OF LINE AT CONNECTION TO EXISTING LINE.
- EXTEND EXISTING 1" UNDERGROUND WATER LINE FROM EXISTING TRAILER. VERIFY SIZE OF EXISTING LINE. 12'-0" WIDE x 40'-0" LONG SINGLE-WIDE TRAILER. PROVIDE FOUNDATIONS PER STRUCTURAL
- DRAWINGS. CONNECT WATER AND SEWER TO UTILITY LINE EXTENSIONS. 36'-0" WIDE x 60'-0" LONG TRIPLE-WIDE TRAILER. PROVIDE FOUNDATIONS PER STRUCTURAL
- DRAWINGS. CONNECT SEWER TO EXISTING STUB-UP. CONNECT WATER TO UTILITY EXTENSION.
- EXISTING WATER STUB --1" LINE (FIELD VERIFY).
- (25) MANHOLE FOR LIFT STATION AND GRINDER PUMP.
- (26) SANITARY SEWER PRESSURE LINE.
- EXISTING POWER LINE.
- $\langle 28 \rangle$ 5'-0" MINIMUM TURNING RADIUS AT ALL STAIR AND RAMP LANDINGS --TYP.

PLANT LEGEND

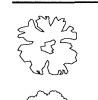

(2) TREE - VINE MAPLE (ACER CIRCINATUM) MIN. OF 5 FOOT TALL, 2 INCH CALIPER FULLY BRANCHED

(10) SHRUBS - SHINY LEAF SPIREA (SPIRAEA BETULIFOLIA VAR. LUCIOA)



(6) SHRUBS - SNOW BERRY (SYMPHORICAPROS ALBUS)

GROUND COVER 12" ON CENTER, TRIANGULAR SPACING

MIN 4" CONTAINER SIZE TO COVER 50% OF VEGETATED MOUND

50% COLUMBIA SEDGE (CAREX APERTA)

50% MANNA GRASS (GLYCERIA OCCIDENTALIS) IRRIGATION: OPTION 2 WITH CONTROLLER

CODE REVIEW

OCCUPANCY: B OFFICE, VB CONSTRUCTION, NFPA 13d SPRINKLERS.

ACTUAL BUILDING AREA: TRIPLE-WIDE TRAILER: $36'-0" \times 60'-0" = 2,160 \text{ SF}.$ SINGLE-WIDE TRAILER: $12'-0" \times 40'-0" = 480 \text{ SF}$

OCCUPANCY LOAD (TRIPLE-WIDE): (2,160 SF /100) = 21.6 OCCUPANTS TABLE 1004.1.1

MINIMUM EGRESS WIDTH = 0.3 INCHES x 21.6 OCCUPANTS = 6.48 INCHES

MINIMUM EGRESS WIDTH PROVIDED 2-36" DOORS = 72 INCHES

EXIT ACCESS TRAVEL DISTANCE = 200 FEET

EXIT DISCHARGE ILLUMINATION SHALL BE NOT LESS THAN 1fc AT THE WALKING SURFACE. EXIT PATH SHALL BE ILLUMINATED BY EMERGENCY LIGHTS FOR A DURATION OF NOT LESS THAN 90 MINUTES.

FIRE RESISTIVE REQUIREMENTS							
STRUCTURAL FI	RAME		O HR				
EXTERIOR BEAR	ING WALLS		O HR				
INTERIOR BEAR	NG WALLS		O HR				
EXTERIOR NON-	-BEARING WALLS						
	WALLS	DIST. TO PROPERTY LINE	FIRE RATING	PROTECTED OPENINGS REQ'D	FIRE RATING REQ'D (OPENINGS)		
	NORTH		O HR	NA	NA		
	SOUTH	>60'	O HR	NA	NA		
	EAST	>60'	O HR	NA	NA		
	WEST	>60'	O HR	NA	NA		
INTERIOR NON-BEARING WALLS & PARTITIONS		0 HR	NA	NA			
FLOORS			0 HR	NA	NA		
ROOFS			0 HR	NA	NA		
CORRIDORS			0 HR	NA	NA		

ivermore A&E JOB NO: 218064.00


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SE O 0 4

DRAWING TITLE: ENLARGED TRAILER

FLOOR PLANS DRAWN BY: TKP CHECKED BY: GML

A1.03

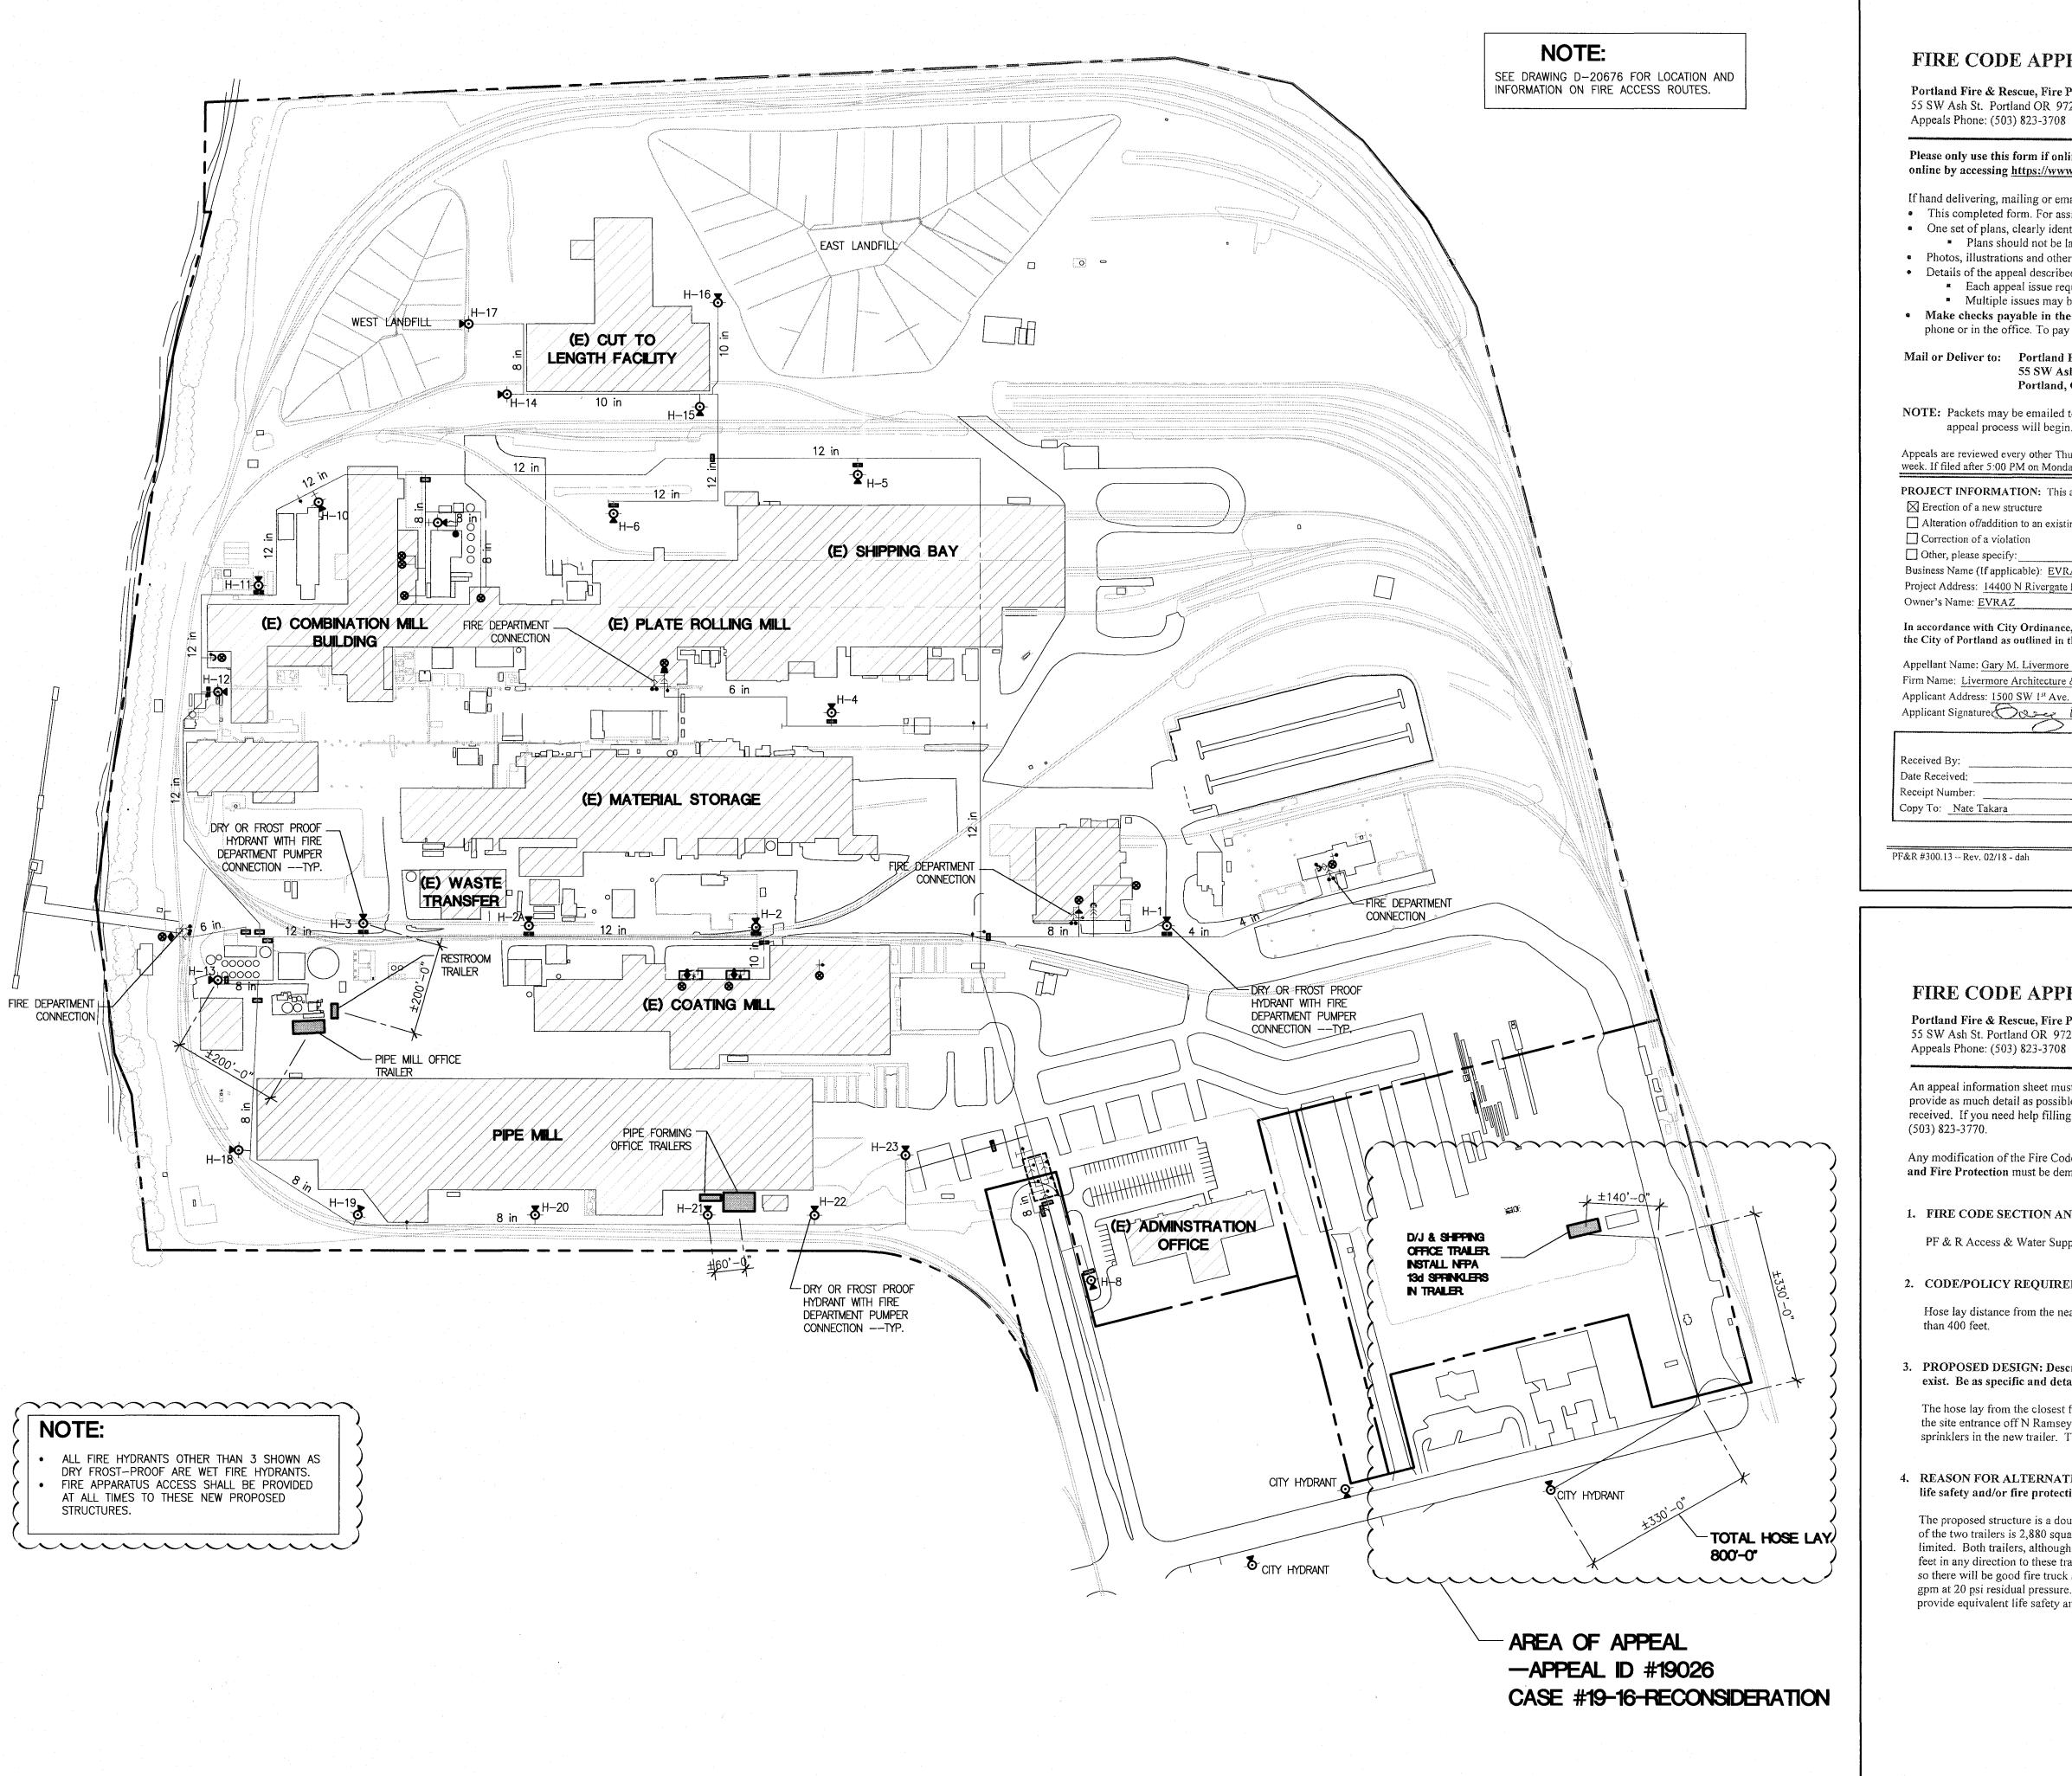

FIRE & RESCUE PLAN

FIRE CODE APPEAL FORM

Portland Fire & Rescue, Fire Prevention Division 55 SW Ash St. Portland OR 97204 Appeals Phone: (503) 823-3708 Fax: (503) 823-3710



Please only use this form if online submission is not an option. Appeal applications may be submitted and paid for online by accessing https://www.portlandoregon.gov/bds/appeals and choosing New Appeal.

If hand delivering, mailing or emailing the appeal, submit a complete packet with the \$200 fee. Packet must include:

- This completed form. For assistance, consult the PF&R member requiring the corrections. • One set of plans, clearly identifying the areas being appealed and the conditions affecting the item(s) being appealed.
- Plans should not be larger than 11" x 17".
- Photos, illustrations and other information that may provide further clarification for the appeal.
- Details of the appeal described on the attached Fire Code Appeal Information Sheet(s). Each appeal issue requires a separate appeal information sheet.
- Multiple issues may be submitted in one appeal packet.
- Make checks payable in the amount of \$200 to "City Treasurer". Credit card payments cannot be taken over the phone or in the office. To pay by credit card, submit the appeal online.

Mail or Deliver to: Portland Fire & Rescue, Attn: Lisa Lillard 55 SW Ash Street

Portland, OR 97204

NOTE: Packets may be emailed to fireappeals@portlandoregon.gov. However, payment MUST be received before the appeal process will begin.

Appeals are reviewed every other Thursday and must be filed by 5:00 PM on the Monday of the appeal review week to be heard that week. If filed after 5:00 PM on Monday of the appeal review week, the review will be scheduled for the next session, two weeks later.

PROJECT INFORMATION: This appeal involves (Check One): Erection of a new structure Building Permit #: 18-269100-CO Alteration of/addition to an existing structure Plans Examiner Name: Joe Thornton Correction of a violation Fire Inspector Name:

Other, please specify: Business Name (If applicable): EVRAZ Oregon Steel Project Address: 14400 N Rivergate Blvd. Cross Streets: N Ramsey and N Rivergate

Owner's Address: 14400 N Rivergate Blvd., Ptld.

In accordance with City Ordinance, I hereby make application to appeal the requirements of the Fire Code and or Policies of the City of Portland as outlined in the attached information.

Phone Number: Firm Name: Livermore Architecture & Eng Email: garyl@livermoreae.com Applicant Signature PAR APPROPRIES AND V

	FOR OFFICE USE ONLY
Received By:	Appeal Date:
Date Received:	Appeal Number:
Receipt Number:	Previous Appeals:
Copy To: Nate Takara	

PF&R #300.13 - Rev. 02/18 - dah Fire Code Appeal Form

FIRE CODE APPEAL INFORMATION SHEET Portland Fire & Rescue, Fire Prevention Division 55 SW Ash St. Portland OR 97204 Appeals Phone: (503) 823-3708 Fax: (503) 823-3710

An appeal information sheet must be completed for each item being appealed. All sections must be addressed. Please provide as much detail as possible. Failure to do so may cause the appeal to be held over until adequate information is received. If you need help filling out the form, consult with the Fire Bureau member requiring the corrections or call

Any modification of the Fire Code and/or Policies requires an appeal. A reasonable degree of Equivalent Life Safety and Fire Protection must be demonstrated before any appeal may be considered.

1. FIRE CODE SECTION AND/OR POLICY:

PF & R Access & Water Supply Guide

2. CODE/POLICY REQUIREMENTS:

Hose lay distance from the nearest fire hydrant to the most remote portion of the exterior of the building shall be less

3. PROPOSED DESIGN: Describe the alternate methods and/or materials of construction to be used or that exist. Be as specific and detailed as possible.

The hose lay from the closest fire hydrant is approximately 800 feet. This is a public hydrant located to the west of the site entrance off N Ramsey. Since the allowable hose lay distance is exceeded, we propose to install NFPA 13d sprinklers in the new trailer. The trailer is served by a 1" water line so the capacity is available for these sprinklers.

4. REASON FOR ALTERNATE: Describe the details of the alternate design and how it will provide equivalent life safety and/or fire protection.

The proposed structure is a double-wide trailer that will be located in the same area as an existing trailer. Total area of the two trailers is 2,880 square feet. The trailers will be used for general office functions so occupant load will be limited. Both trailers, although very small, will have two means of egress. There are no other structures within 150 feet in any direction to these trailers. The fire hydrant that will serve this trailer is located at the main entry to the site so there will be good fire truck access to the area. The fire flow at the hydrant has been confirmed to exceed 2,500 gpm at 20 psi residual pressure. The addition of the NFPA 13d sprinklers, in addition to the items listed above, will provide equivalent life safety and fire protection.

PF&R #300.13 - Rev. 02/18 - dah Fire Code Appeal Form **DE** ISSU

GARY

JOB NO: 218064.00

ORTL


STEEL .VD BL 97. OREGON RIVERGATE
), OREGON INSTALLATION


VRA DRAWING TITLE:
FIRE & RESCUE PLAN

CHECKED BY: GML

DRAWN BY: MGV

FR1.00

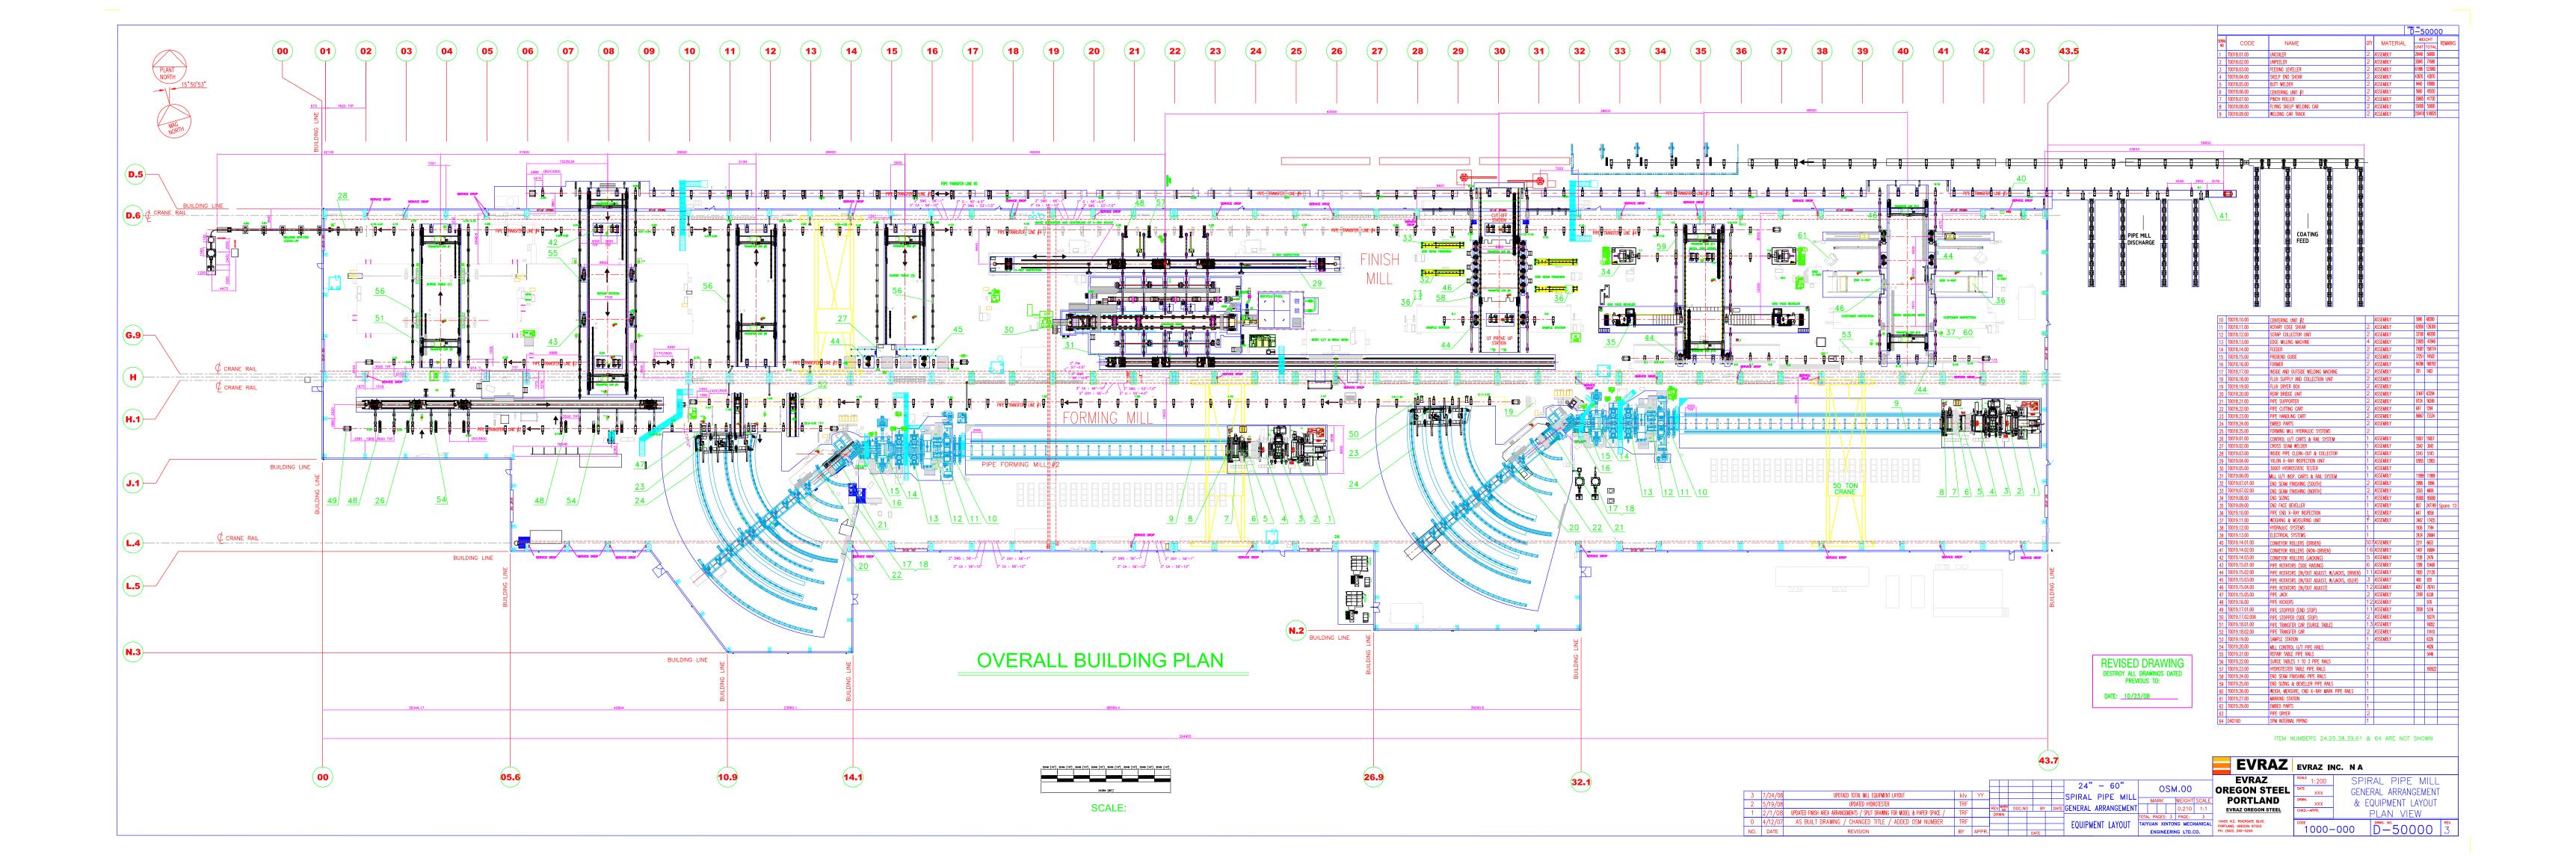

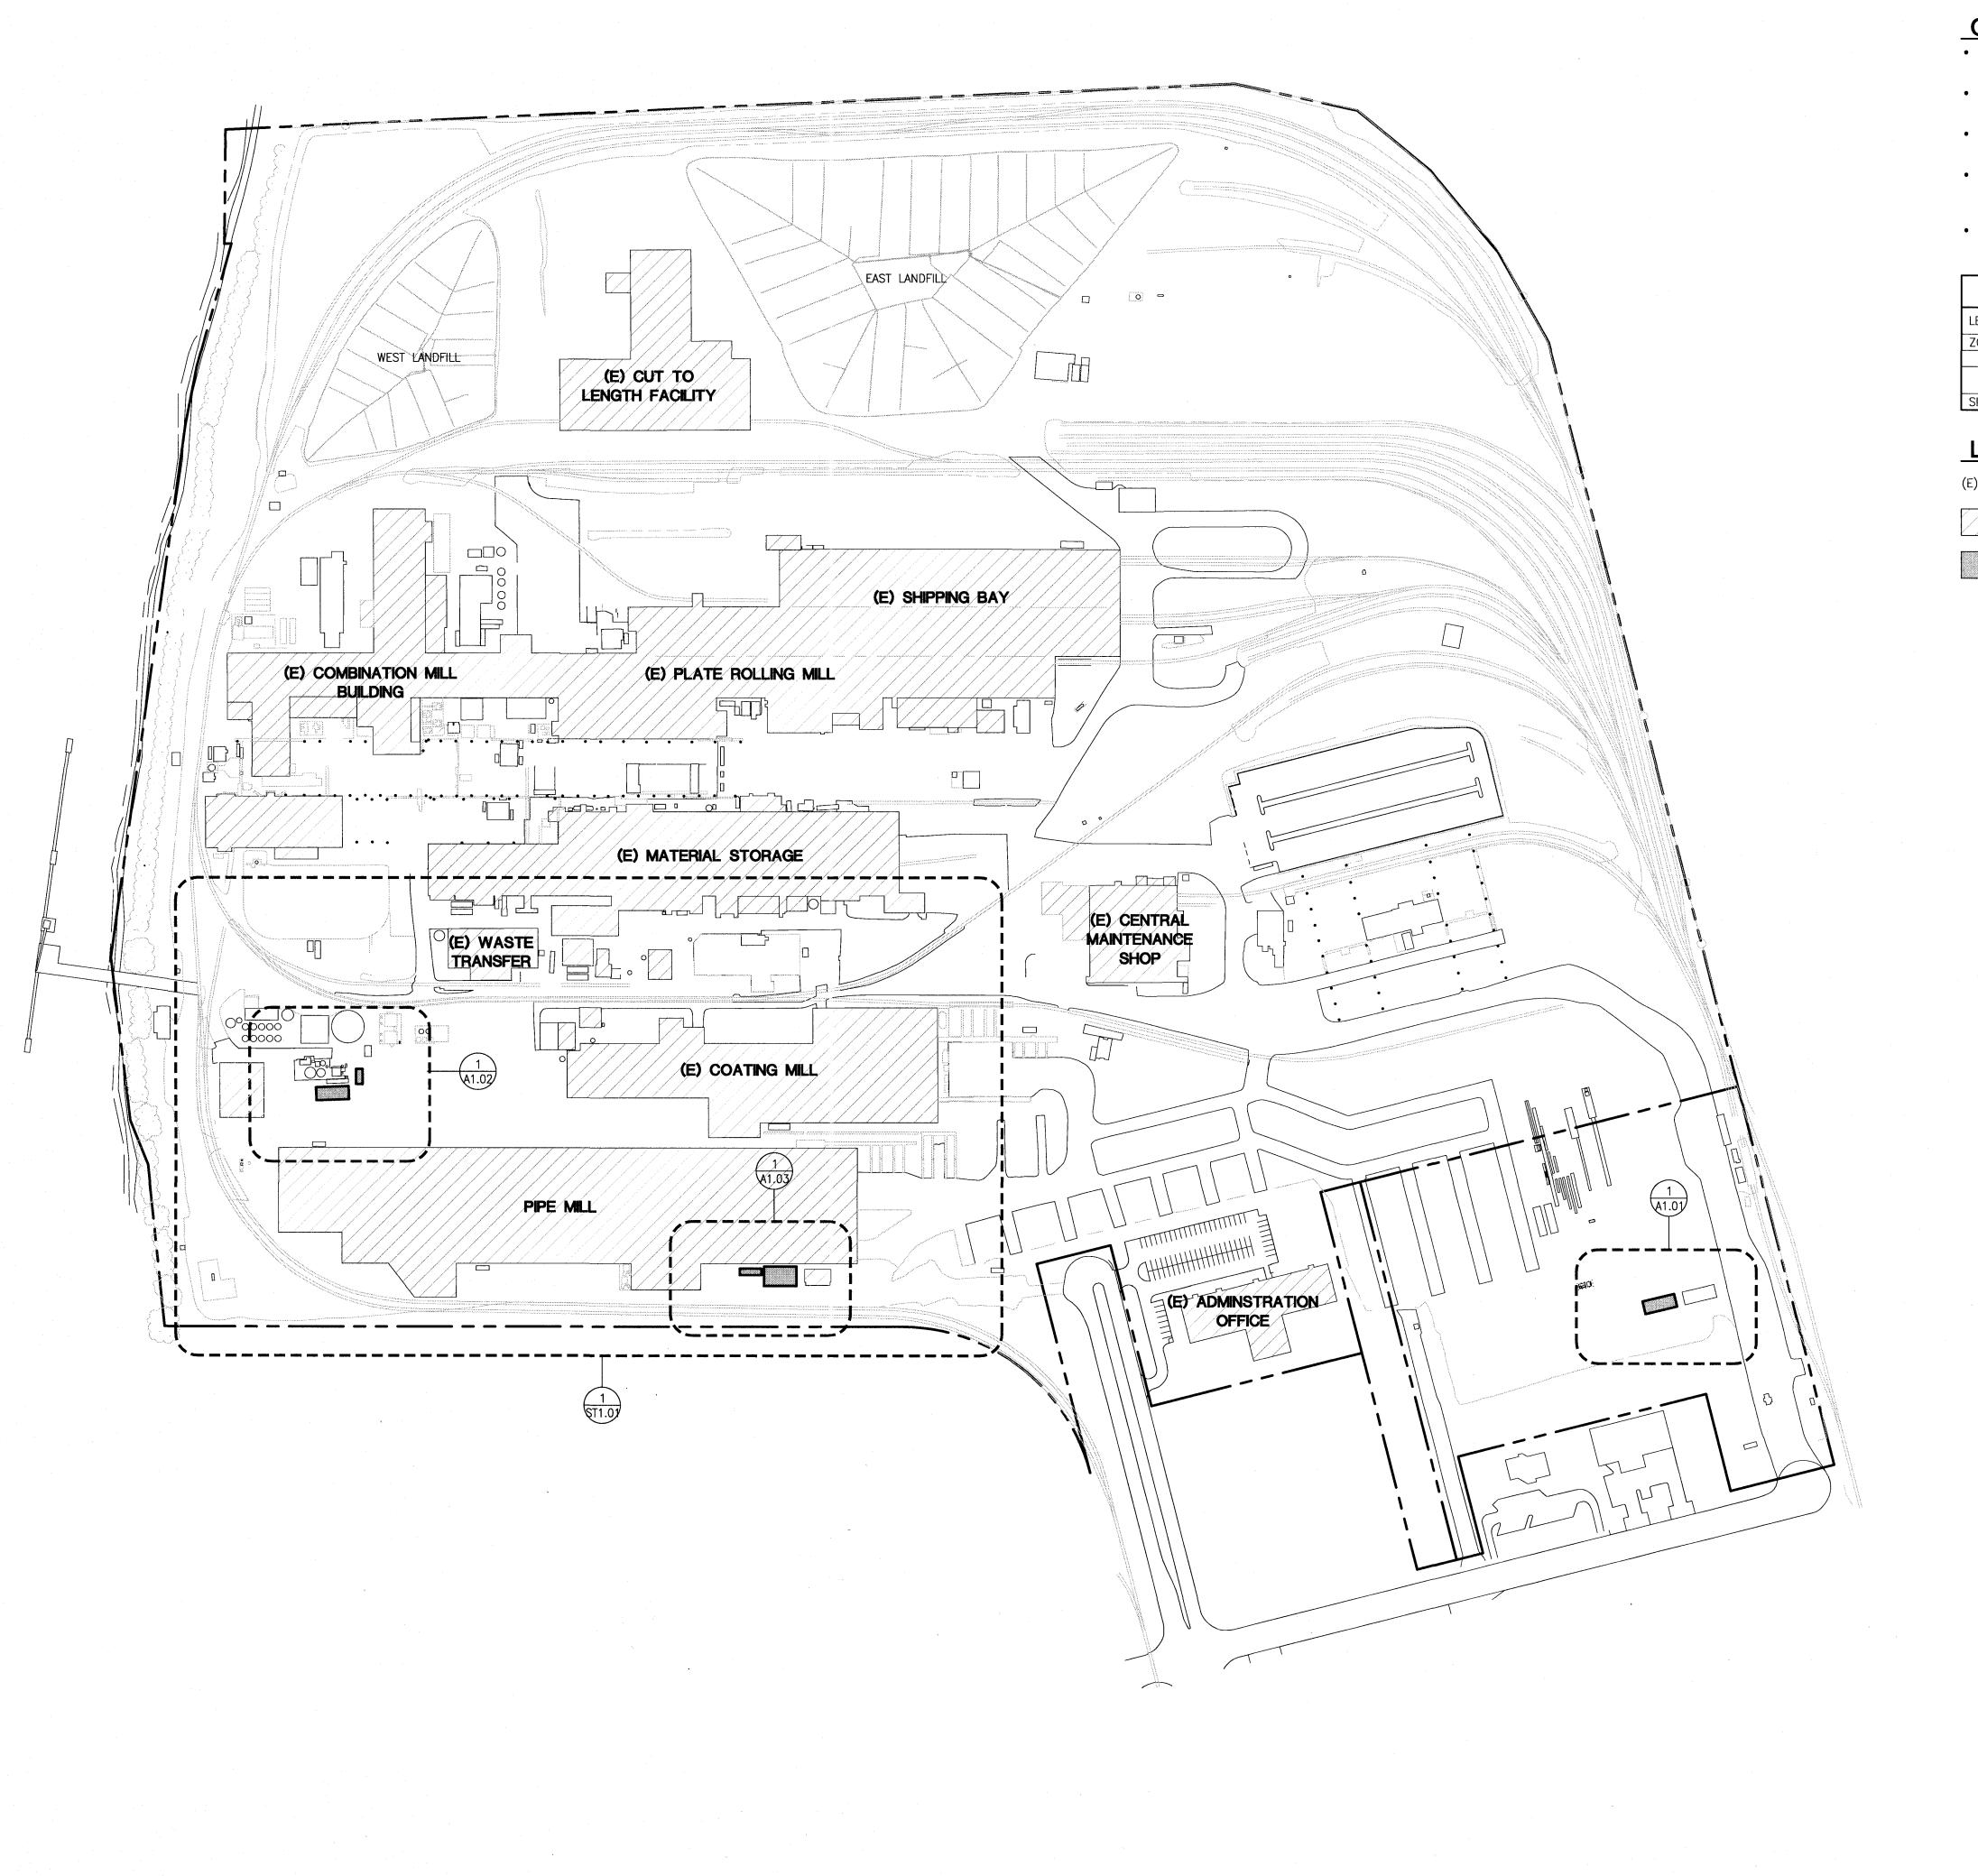

GENERAL NOTES

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ZONING			SSL SSL	REVI	ISS	NS	SSU	
BASE	IH — HEAVY INDUSTRIAL		<u> </u>	Tac.	57		0)	
OVERLAY	h,i,k — AIRCRAFT LANDING, RIVER INDUSTRIAL, PRIME INDUSTRIAL		TE 25/18	15/18	7	29/19	5/19	
SITE AREA	145.82 ACRES	- 1	2 5	11/	I 🔨 I	3/2	4/1	
		l	* -	2	3	5	9	

LEGEND

EXISTING

EXISTING BUILDING

TRAILER INSTALLATION

GARY LIVERMORE 5844

1500 SW First Ave. Suite 240 Phone: 503-892-3002 Portland Oregon 97201 www livermoreae com

Livermore A&E JOB NO: 218064.00

FEEL PORTLAND


OREGON STE RIVERGATE BLVD.

DRAWING TITL

drawn by: TKP checked by: GML

ST1.00

1 SITE PLAN 6T100 1" = 160'-0"

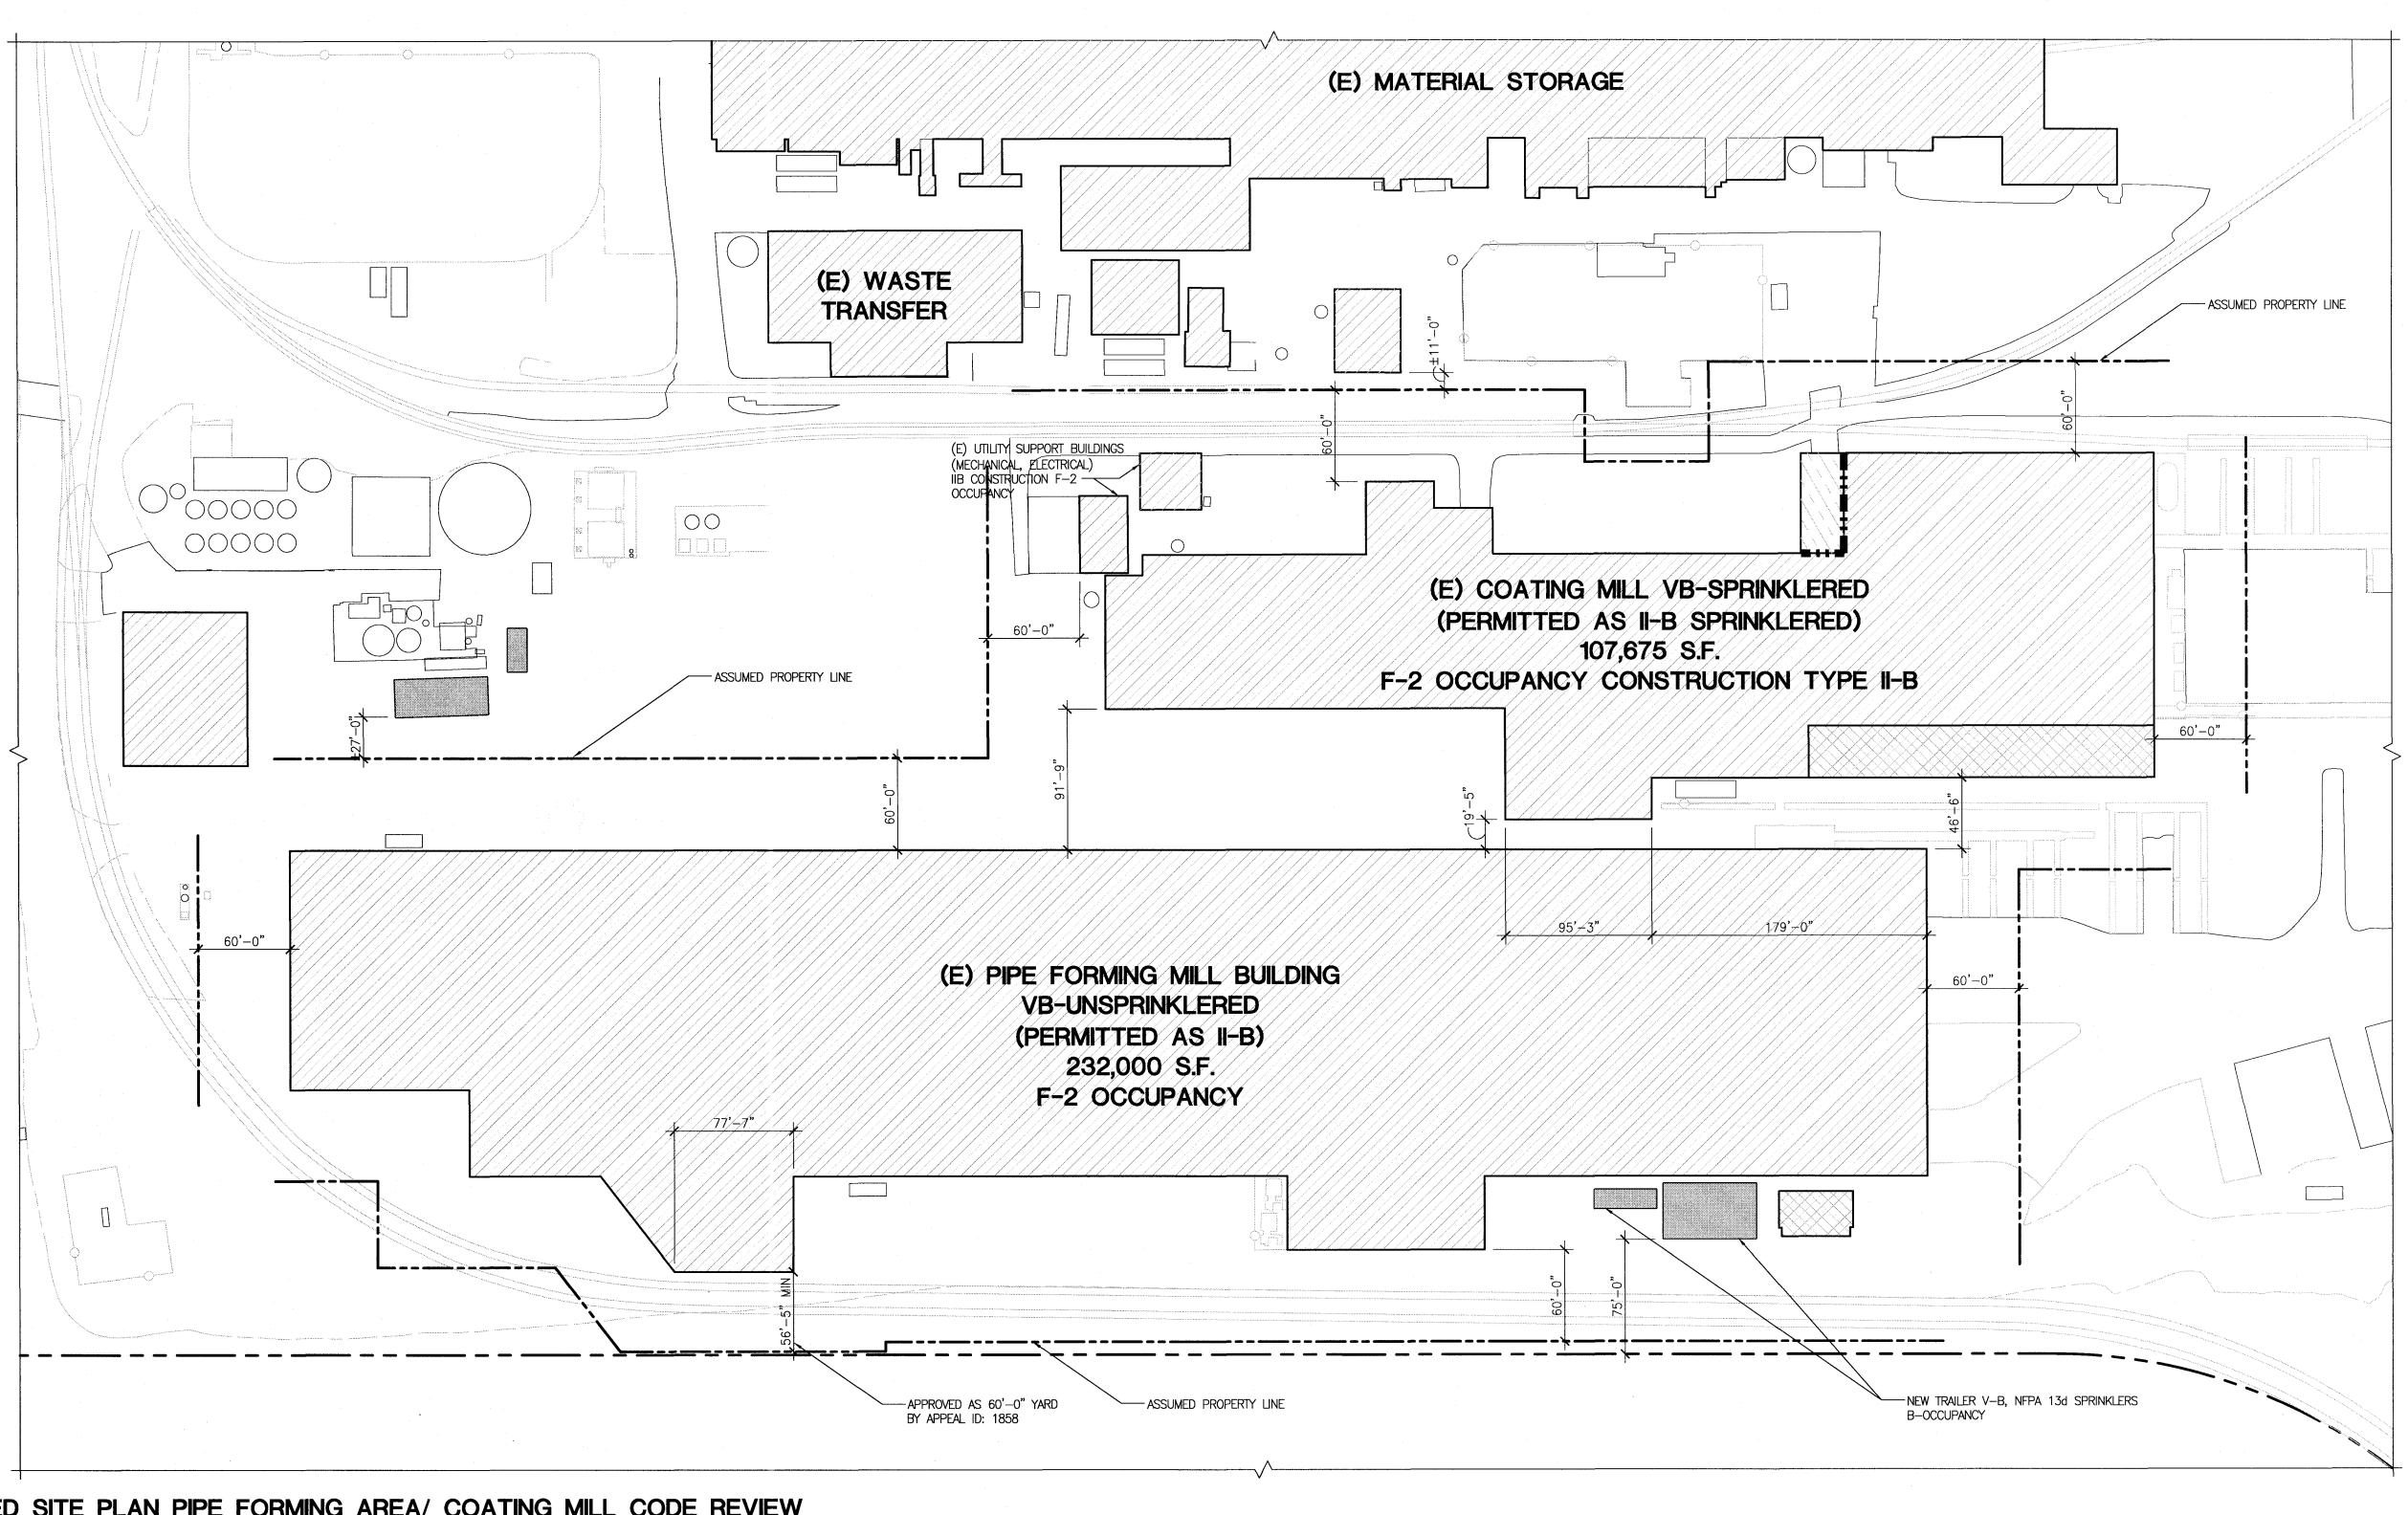

1 ENLARGED SITE PLAN PIPE FORMING AREA/ COATING MILL CODE REVIEW

1" = 60'-0"

(E) COATING MILL CODE REVIEW

PERMIT No.: 06-130004-000-00-CO

APPROVED OCCUPANCY: F2, H-3 PAINT STORAGE ROOM, II-B CONSTRUCTION, SPRINKLERED, ONE STORY

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(E) PIPE FORMING MILL CODE REVIEW

PERMIT No.: 05-117941-000-00-CO

APPROVED OCCUPANCY: F2, II-B CONSTRUCTION, UNSPRINKLERED, ONE STORY.

ACTUAL BUILDING AREA: 232,000 SF.

(N) TRAILERS

OCCUPANCY: B, VB CONSTRUCTION, NFPA 13d SPRINKLERS.

ACTUAL BUILDING AREA: 480 SF. + 2,160 SF. = 2,640 SF.

CODE PLAN LEGEND

(E) EXISTING

OCCUPANCY GROUPS:

F-2

H-3

TRAILER INSTALLATION

(E) FIRE BARRIER — 2 HR FIRE RATING

GENERAL NOTES

- THE CONTRACTOR SHALL HAVE A FULL SET OF THE CURRENT APPROVED CONSTRUCTION DOCUMENTS INCLUDING ADDENDA ON THE PROJECT SITE AT ALL TIMES
- THE CONTRACTOR SHALL COMPLY WITH LOCAL UTILITY PROVIDERS REQUIRING NOTIFICATION OF INTENDED EXCAVATION.
- ALL WORK SHALL COMPLY WITH THE LOCAL JURISDICTION REQUIREMENTS AND THE PROJECT SPECIFICATIONS.
- THE CONTRACTOR SHALL VERIFY ALL EXISTING CONDITIONS AND DIMENSIONS SHOWN OR IMPLIED WHICH MAY AFFECT THE WORK PRIOR TO THE START OF CONSTRUCTION AND NOTIFY THE ENGINEER OF RECORD OF ANY DISCREPANCIES.
- EXISTING CONDITIONS BASED ON DRAWINGS BY EVRAZ DATED 07/26/2018

DATE DESC.

1 3/04/19 ISSUED FOR CITY COMMENTS
5 3/29/19 LNS APPEAL
6 4/15/19 ISSUED FOR CITY COMMENTS

GARY LIVERMORE 5844

500 SW First Ave. Suite 240 Phone: 503-892-3002 ontland. Oregon 97201 www.livermoreae.com

JOB NO: 218064.00


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DRAWING TITLE:
ENLARGED SITE PLAN
PIPE FORMING AREA

drawn by: MGV checked by: GML

ST1.01



LEGEND

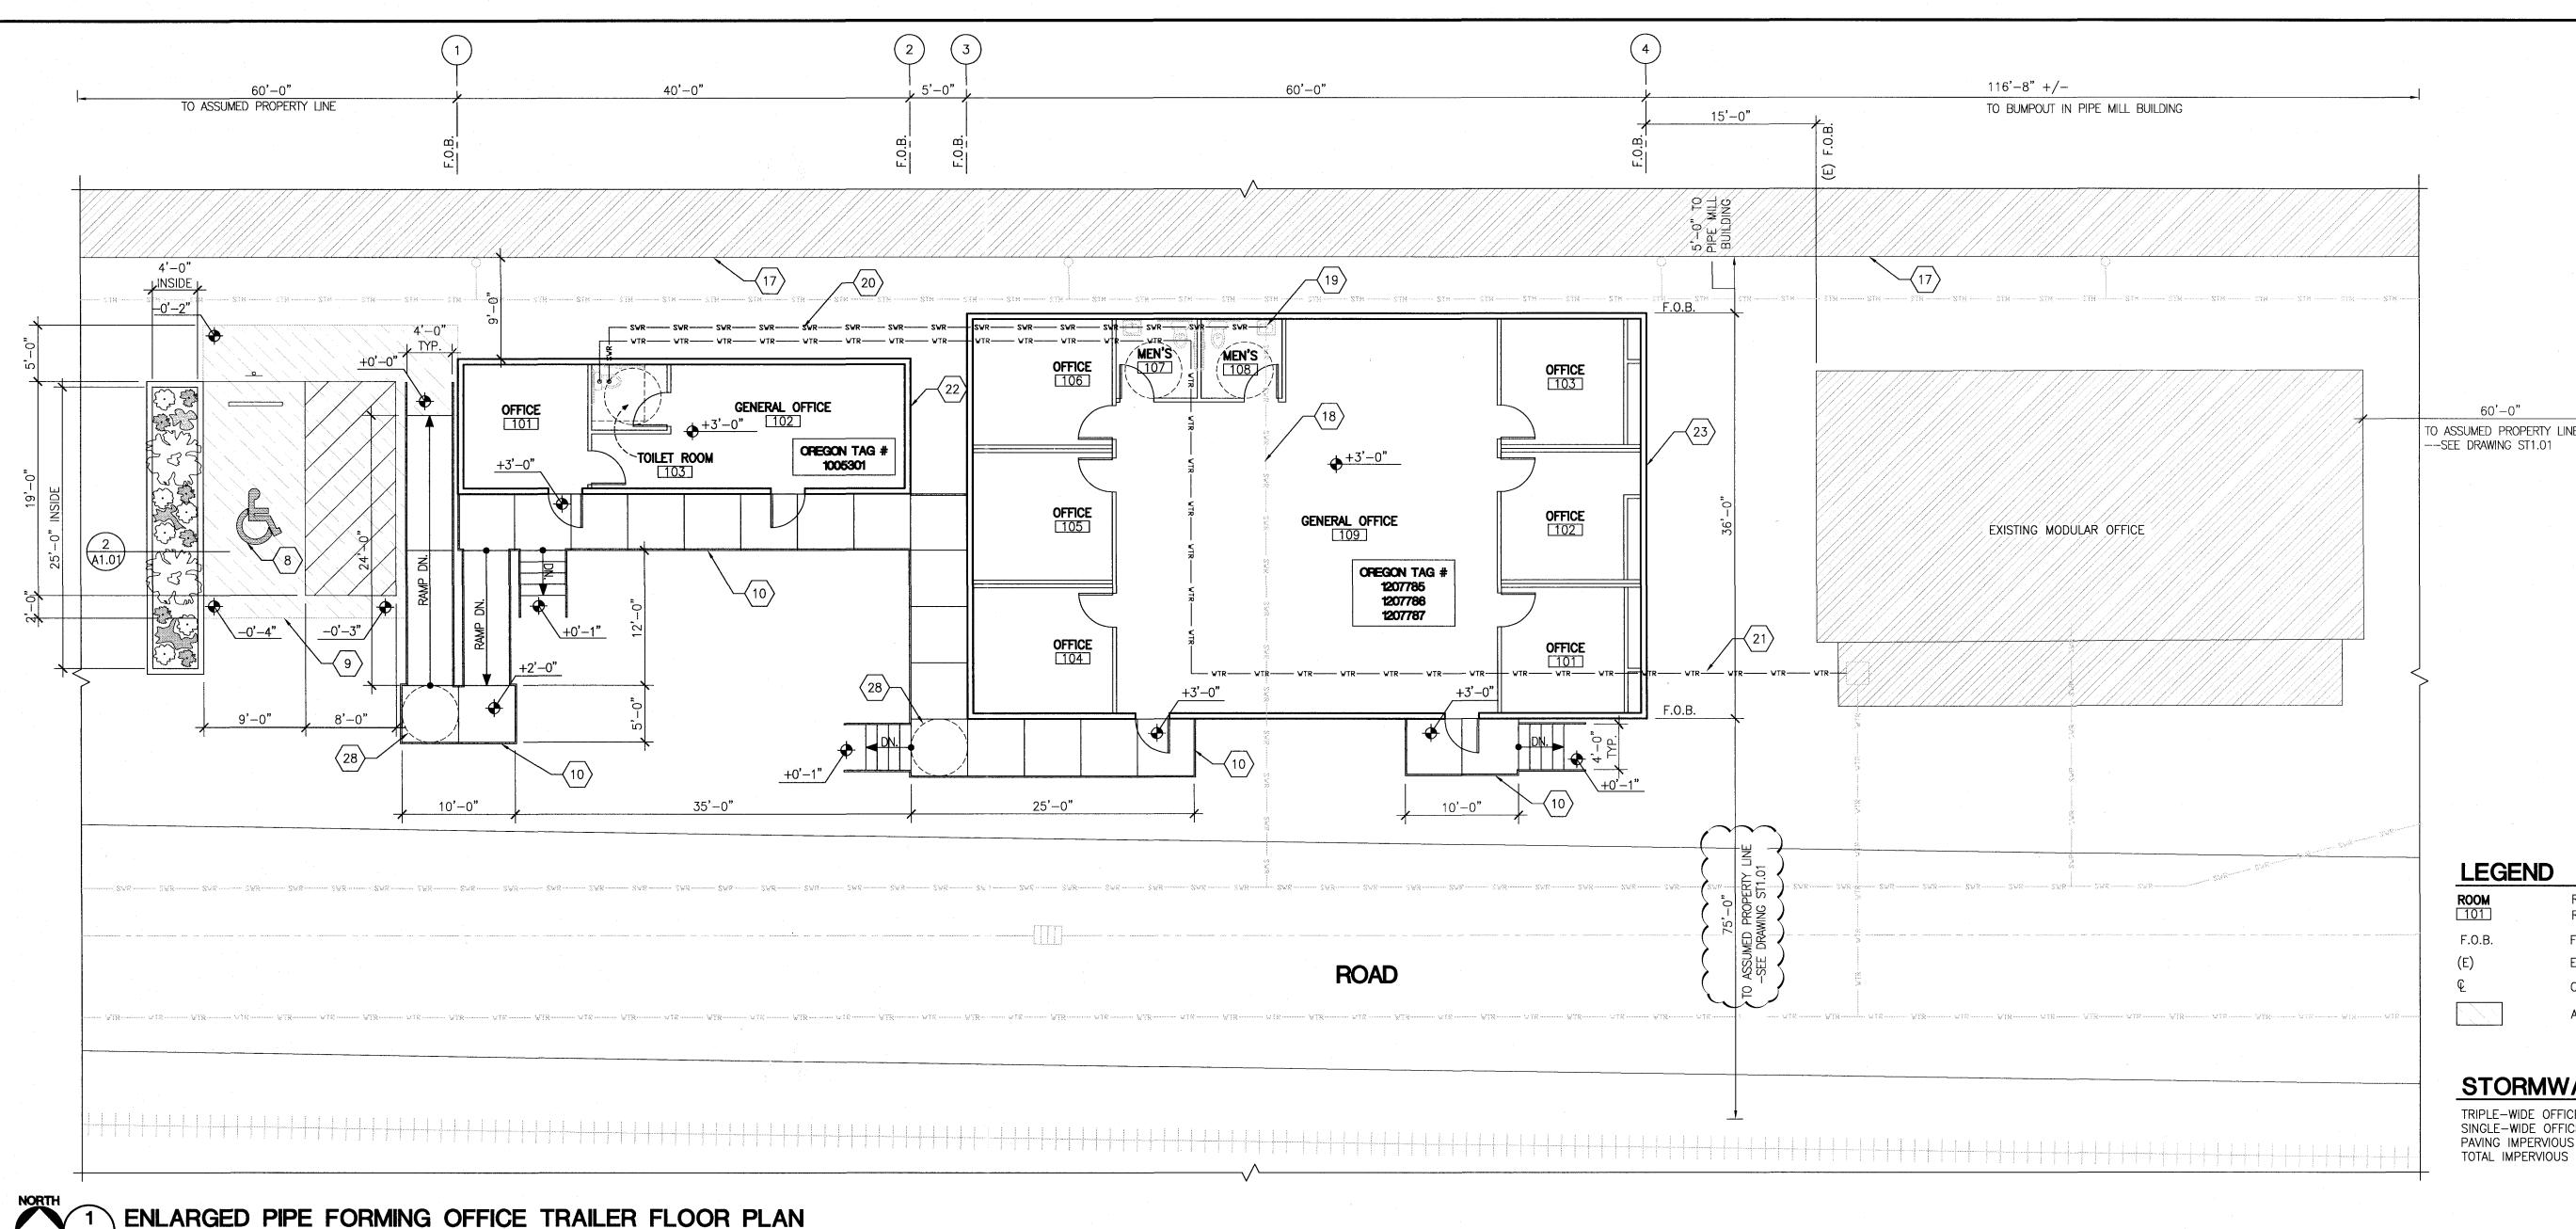ROOM ### FACE OF BUILDING EXISTING

CENTERLINE ASPHALT PAVING

STORMWATER NOTES

TRIPLE-WIDE OFFICE TRAILER IMPERVIOUS AREA = 2,160 S.F. SINGLE-WIDE OFFICE TRAILER IMPERVIOUS AREA = 480 S.F. PAVING IMPERVIOUS AREA = 505 S.F. TOTAL IMPERVIOUS AREA = 3,145 S.F.

FLOOR PLAN GENERAL NOTES

- APPLICABLE CODES: ALL WORK SHALL BE IN CONFORMANCE WITH ALL FEDERAL, STATE, AND LOCAL CODES. SPECIFICATIONS AND STANDARDS SHALL MEAN, AND ARE INTENDED TO BE, THE LATEST EDITION, AMENDMENT OR REVISION OF SUCH REFERENCE STANDARD, IN EFFECT AS OF THE DATE OF THE CONTRACT DOCUMENTS.
- CONTRACTOR TO VERIFY EXISTING CONDITIONS AND DIMENSIONS SHOWN OR IMPLIED PRIOR TO START OF CONSTRUCTION AND NOTIFY A/E OF ANY DISCREPANCIES.
- CONTRACTOR SHALL PROVIDE ALL NECESSARY TESTING AND COORDINATE ALL REQUIRED INSPECTIONS.

STAIR/RAMP NOTES

PROVIDE 48" WIDE COMMERCIAL PREFABRICATED ALUMINUM STAIRS & RAMP. SEE DRAWING A2.01 MEET ALL OSSC ACCESSIBILITY REQUIREMENTS.

- RAMPS 1:12 SLOPE WITH GUARDRAILS/HANDRAILS EACH SIDE.
- PROVIDE HANDRAIL EXTENSIONS AT STAIRS & RAMPS PER OSSC ACCESSIBILITY REQUIREMENTS.
- STAIRS & RAMPS SHALL BE DESIGNED FOR 100 PSF LIVE LOAD AND HANDRAIL AND GUARDRAIL LOADS AS REQUIRED BY CODE.
- STAIRS & RAMPS SHALL BE SUBMITTED BY THE SUPPLIER AS A DEFERRED SUBMITTAL.

UTILITY NOTES

SANITARY

SANITARY: CAST IRON PIPE: SERVICE WEIGHT FITTING: JOINTS:

4", MIN. 2% SLOPE ASTM A74, HUBLESS, CAST IRON

NEOPRENE GASKETS AND STAINLESS STEEL CLAMP AND SHIELD ASSEMBLIES. HUSKY SD4000 OR APPROVED SUBSTITUTE. J.R. SMITH, ZURN, WADE, OR EQUAL

CLEANOUT:

WATER PIPING, ABOVE GRADE COPPER TUBING: ASTM B88, TYPE L, HARD DRAWN FITTING: ANSI/ASTM 16.22 SOLDER, GRADE 95TA INSULATION: 1/2 INCH DISINFECT, CLEAN, AND TEST: PER CODE


WATER PIPING, BELOW GRADE AS APPROVED BY CITY OF PORTLAND

FLOOR PLAN KEYNOTES

- (1) EXISTING MANHOLE, GRINDER PUMP.
- (2) EXISTING 1" UNDERGROUND WATER LINE.
- EXISTING 4" UNDERGROUND SANITARY SEWER LINE --2% SLOPE.
- 24'-0" WIDE x 60'-0" LONG DOUBLE-WIDE TRAILER. PROVIDE FOUNDATIONS PER STRUCTURAL DRAWINGS. CONNECT WATER AND SEWER TO EXISTING UTILITY STUB-OUT UNDER TRAILER. EXISTING ELECTRICAL SERVICE.
- SAWCUT AND REMOVE EXISTING CONCRETE SLAB UNDER TRAILER FOOTPRINT.
- EXISTING CONCRETE SLAB ON GRADE.
- VAN ACCESSIBLE PARKING STRIPING AND SIGNAGE -- SEE 1/A2.01.
- 3" ASPHALT PAVING OVER 6" CRUSHED ROCK BASE --SLOPE 2% MAX.
- ACCESSIBLE PRE-FABRICATED STAIRS/RAMP SYSTEM BY OTHERS. PROVIDE GUARDRAIL & HANDRAIL EACH SIDE. SEE NOTES THIS SHEET AND DRAWING A2.01
- EXISTING CONCRETE PAD.
- EXISTING CONCRETE BASE AT EXISTING COOLING TOWER.
- EXISTING STEEL STORAGE UNIT.
- LANDSCAPING PLANTER --SEE DETAIL 2/A1.01.
- 12'-0" WIDE x 28'-0" LONG SINGLE-WIDE TRAILER. PROVIDE FOUNDATIONS PER STRUCTURAL DRAWINGS. CONNECT WATER AND SEWER TO UTILITY LINE EXTENSIONS.
- 24'-0" WIDE x 60'-0" LONG DOUBLE-WIDE TRAILER. PROVIDE FOUNDATIONS PER STRUCTURAL DRAWINGS. CONNECT WATER AND SEWER TO UTILITY LINE EXTENSIONS.
- FACE OF EXISTING BUILDING.
- EXISTING UNDERGROUND SANITARY SEWER LINE --VERIFY SIZE AND DEPTH (4" LINE, 2% SLOPE).
- EXISTING SANITARY SEWER LINE STUB-IP --VERIFY SIZE AND DEPTH. EXTEND LINE TO THE WEST IF POSSIBLE.

- UNDERGROUND SANITARY SEWER LINE EXTENSION --4" LINE, 2% SLOPE. VERIFY DEPTH OF LINE AT CONNECTION TO EXISTING LINE.
- EXTEND EXISTING 1" UNDERGROUND WATER LINE FROM EXISTING TRAILER. VERIFY SIZE OF EXISTING LINE. 12'-0" WIDE x 40'-0" LONG SINGLE-WIDE TRAILER. PROVIDE FOUNDATIONS PER STRUCTURAL
- DRAWINGS. CONNECT WATER AND SEWER TO UTILITY LINE EXTENSIONS. 36'-0" WIDE x 60'-0" LONG TRIPLE-WIDE TRAILER. PROVIDE FOUNDATIONS PER STRUCTURAL
- DRAWINGS. CONNECT SEWER TO EXISTING STUB-UP. CONNECT WATER TO UTILITY EXTENSION.
- EXISTING WATER STUB --1" LINE (FIELD VERIFY).
- (25) MANHOLE FOR LIFT STATION AND GRINDER PUMP.
- (26) SANITARY SEWER PRESSURE LINE.
- EXISTING POWER LINE.
- $\langle 28 \rangle$ 5'-0" MINIMUM TURNING RADIUS AT ALL STAIR AND RAMP LANDINGS --TYP.

PLANT LEGEND

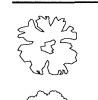

(2) TREE - VINE MAPLE (ACER CIRCINATUM) MIN. OF 5 FOOT TALL, 2 INCH CALIPER FULLY BRANCHED

(10) SHRUBS - SHINY LEAF SPIREA (SPIRAEA BETULIFOLIA VAR. LUCIOA)



(6) SHRUBS - SNOW BERRY (SYMPHORICAPROS ALBUS)

GROUND COVER 12" ON CENTER, TRIANGULAR SPACING

MIN 4" CONTAINER SIZE TO COVER 50% OF VEGETATED MOUND

50% COLUMBIA SEDGE (CAREX APERTA)

50% MANNA GRASS (GLYCERIA OCCIDENTALIS) IRRIGATION: OPTION 2 WITH CONTROLLER

CODE REVIEW

OCCUPANCY: B OFFICE, VB CONSTRUCTION, NFPA 13d SPRINKLERS.

ACTUAL BUILDING AREA: TRIPLE-WIDE TRAILER: $36'-0" \times 60'-0" = 2,160 \text{ SF}.$ SINGLE-WIDE TRAILER: $12'-0" \times 40'-0" = 480 \text{ SF}$

OCCUPANCY LOAD (TRIPLE-WIDE): (2,160 SF /100) = 21.6 OCCUPANTS TABLE 1004.1.1

MINIMUM EGRESS WIDTH = 0.3 INCHES x 21.6 OCCUPANTS = 6.48 INCHES

MINIMUM EGRESS WIDTH PROVIDED 2-36" DOORS = 72 INCHES

EXIT ACCESS TRAVEL DISTANCE = 200 FEET

EXIT DISCHARGE ILLUMINATION SHALL BE NOT LESS THAN 1fc AT THE WALKING SURFACE. EXIT PATH SHALL BE ILLUMINATED BY EMERGENCY LIGHTS FOR A DURATION OF NOT LESS THAN 90 MINUTES.

FIRE RESISTIVE REQUIREMENTS							
STRUCTURAL FI	RAME		O HR				
EXTERIOR BEAR	ING WALLS		O HR				
INTERIOR BEAR	NG WALLS		O HR				
EXTERIOR NON-	-BEARING WALLS						
	WALLS	DIST. TO PROPERTY LINE	FIRE RATING	PROTECTED OPENINGS REQ'D	FIRE RATING REQ'D (OPENINGS)		
	NORTH		O HR	NA	NA		
	SOUTH	>60'	O HR	NA	NA		
	EAST	>60'	O HR	NA	NA		
	WEST	>60'	O HR	NA	NA		
INTERIOR NON-BEARING WALLS & PARTITIONS		0 HR	NA	NA			
FLOORS			0 HR	NA	NA		
ROOFS			0 HR	NA	NA		
CORRIDORS			0 HR	NA	NA		

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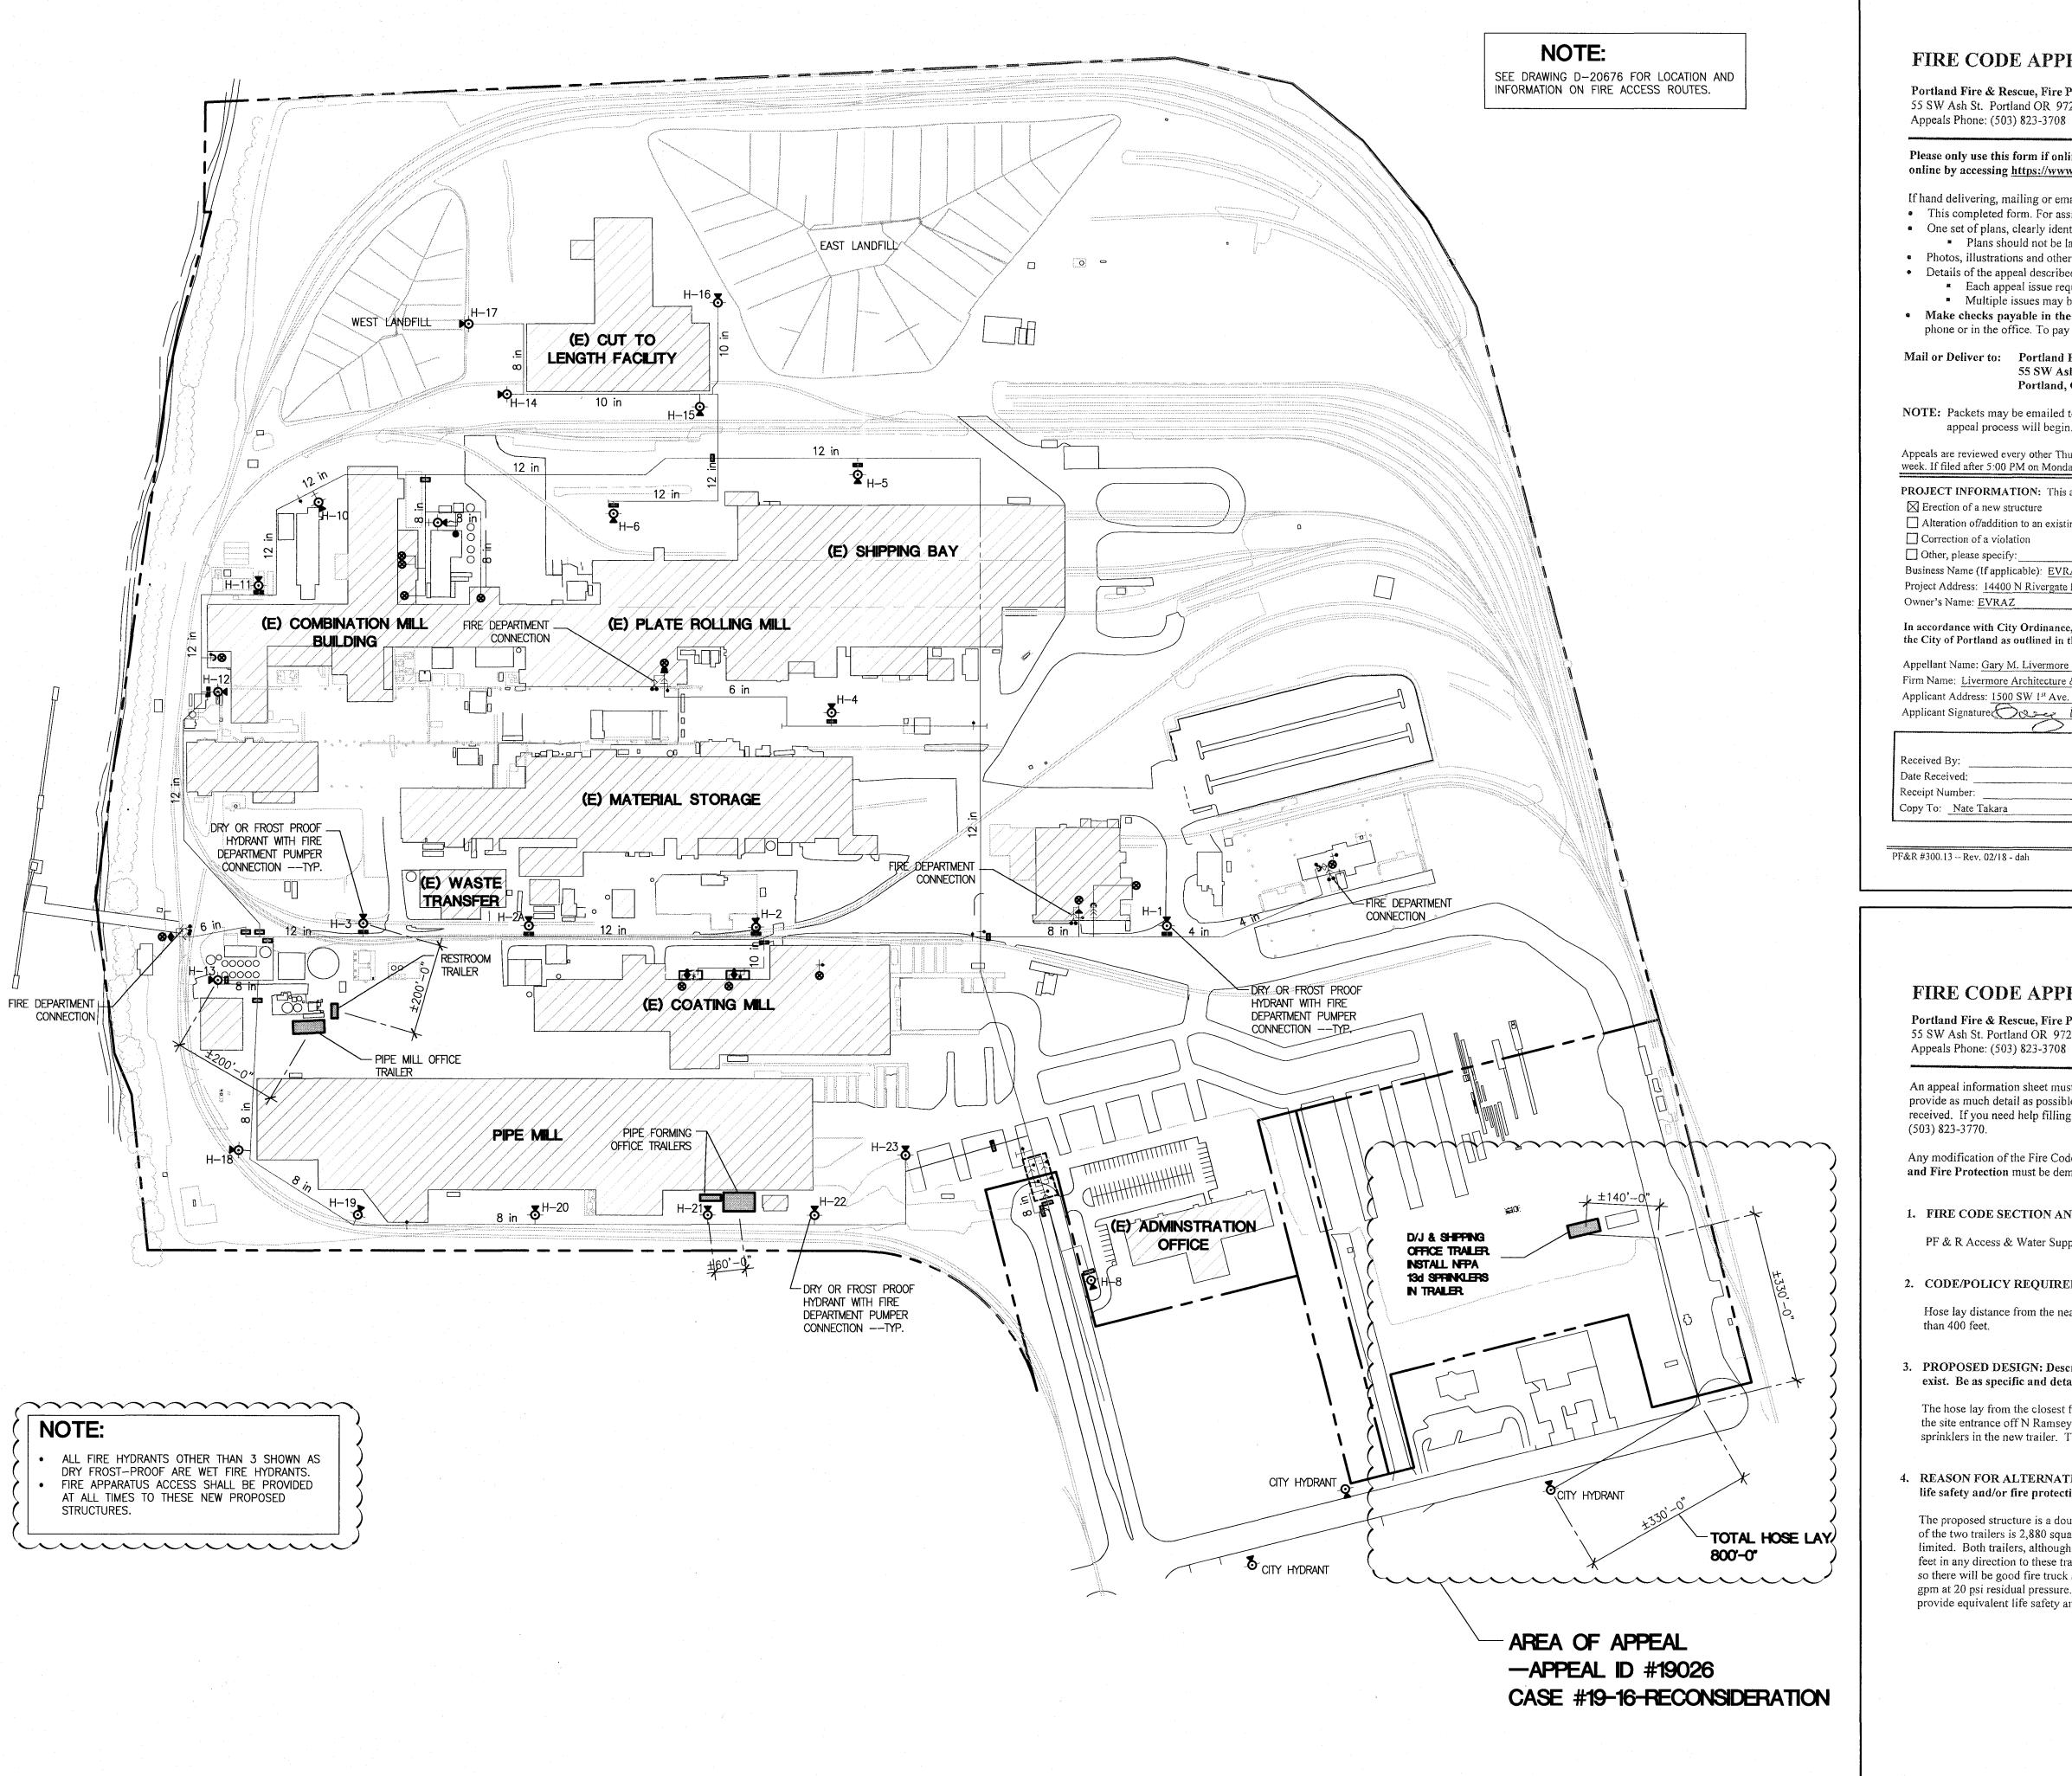
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SE O 0 4

DRAWING TITLE: ENLARGED TRAILER

FLOOR PLANS DRAWN BY: TKP CHECKED BY: GML

A1.03



FIRE & RESCUE PLAN

FIRE CODE APPEAL FORM

Portland Fire & Rescue, Fire Prevention Division 55 SW Ash St. Portland OR 97204 Appeals Phone: (503) 823-3708 Fax: (503) 823-3710



Please only use this form if online submission is not an option. Appeal applications may be submitted and paid for online by accessing https://www.portlandoregon.gov/bds/appeals and choosing New Appeal.

If hand delivering, mailing or emailing the appeal, submit a complete packet with the \$200 fee. Packet must include:

- This completed form. For assistance, consult the PF&R member requiring the corrections. • One set of plans, clearly identifying the areas being appealed and the conditions affecting the item(s) being appealed.
- Plans should not be larger than 11" x 17".
- Photos, illustrations and other information that may provide further clarification for the appeal.
- Details of the appeal described on the attached Fire Code Appeal Information Sheet(s). Each appeal issue requires a separate appeal information sheet.
- Multiple issues may be submitted in one appeal packet.
- Make checks payable in the amount of \$200 to "City Treasurer". Credit card payments cannot be taken over the phone or in the office. To pay by credit card, submit the appeal online.

Mail or Deliver to: Portland Fire & Rescue, Attn: Lisa Lillard 55 SW Ash Street

Portland, OR 97204

NOTE: Packets may be emailed to fireappeals@portlandoregon.gov. However, payment MUST be received before the appeal process will begin.

Appeals are reviewed every other Thursday and must be filed by 5:00 PM on the Monday of the appeal review week to be heard that week. If filed after 5:00 PM on Monday of the appeal review week, the review will be scheduled for the next session, two weeks later.

PROJECT INFORMATION: This appeal involves (Check One): Erection of a new structure Building Permit #: 18-269100-CO Alteration of/addition to an existing structure Plans Examiner Name: Joe Thornton Correction of a violation Fire Inspector Name:

Other, please specify: Business Name (If applicable): EVRAZ Oregon Steel Project Address: 14400 N Rivergate Blvd. Cross Streets: N Ramsey and N Rivergate

Owner's Address: 14400 N Rivergate Blvd., Ptld.

In accordance with City Ordinance, I hereby make application to appeal the requirements of the Fire Code and or Policies of the City of Portland as outlined in the attached information.

Phone Number: Firm Name: Livermore Architecture & Eng Email: garyl@livermoreae.com Applicant Signature PAR APPROPRIES AND V

	FOR OFFICE USE ONLY
Received By:	Appeal Date:
Date Received:	Appeal Number:
Receipt Number:	Previous Appeals:
Copy To: Nate Takara	

PF&R #300.13 - Rev. 02/18 - dah Fire Code Appeal Form

FIRE CODE APPEAL INFORMATION SHEET Portland Fire & Rescue, Fire Prevention Division 55 SW Ash St. Portland OR 97204 Appeals Phone: (503) 823-3708 Fax: (503) 823-3710

An appeal information sheet must be completed for each item being appealed. All sections must be addressed. Please provide as much detail as possible. Failure to do so may cause the appeal to be held over until adequate information is received. If you need help filling out the form, consult with the Fire Bureau member requiring the corrections or call

Any modification of the Fire Code and/or Policies requires an appeal. A reasonable degree of Equivalent Life Safety and Fire Protection must be demonstrated before any appeal may be considered.

1. FIRE CODE SECTION AND/OR POLICY:

PF & R Access & Water Supply Guide

2. CODE/POLICY REQUIREMENTS:

Hose lay distance from the nearest fire hydrant to the most remote portion of the exterior of the building shall be less

3. PROPOSED DESIGN: Describe the alternate methods and/or materials of construction to be used or that exist. Be as specific and detailed as possible.

The hose lay from the closest fire hydrant is approximately 800 feet. This is a public hydrant located to the west of the site entrance off N Ramsey. Since the allowable hose lay distance is exceeded, we propose to install NFPA 13d sprinklers in the new trailer. The trailer is served by a 1" water line so the capacity is available for these sprinklers.

4. REASON FOR ALTERNATE: Describe the details of the alternate design and how it will provide equivalent life safety and/or fire protection.

The proposed structure is a double-wide trailer that will be located in the same area as an existing trailer. Total area of the two trailers is 2,880 square feet. The trailers will be used for general office functions so occupant load will be limited. Both trailers, although very small, will have two means of egress. There are no other structures within 150 feet in any direction to these trailers. The fire hydrant that will serve this trailer is located at the main entry to the site so there will be good fire truck access to the area. The fire flow at the hydrant has been confirmed to exceed 2,500 gpm at 20 psi residual pressure. The addition of the NFPA 13d sprinklers, in addition to the items listed above, will provide equivalent life safety and fire protection.

PF&R #300.13 - Rev. 02/18 - dah Fire Code Appeal Form **DE** ISSU

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JOB NO: 218064.00

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STEEL .VD BL 97. OREGON RIVERGATE
), OREGON INSTALLATION

VRA DRAWING TITLE:
FIRE & RESCUE PLAN

CHECKED BY: GML

DRAWN BY: MGV

FR1.00

