Development Services

From Concept to Construction

Phone: 503-823-7300 Email: bds@portlandoregon.gov 1900 SW 4th Ave, Portland, OR 97201 More Contact Info (http://www.portlandoregon.gov//bds/article/519984)

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APPEAL SUMMAR									
Status: Decision Rende	ered	Project Address: 7837 SE Harrison Rd							
Appeal ID: 16066		Appellant Name: Michelle Hess							
Hearing Date: 11/1/17 Case No.: B-006 Appeal Type: Building Project Type: residential		Appellant Phone: 503-388-1328 Plans Examiner/Inspector: Preliminary Stories: 1 Occupancy: R-5 Construction Type: V							
					Building/Business Nan Appeal Involves: Altera to an existing structure	tion of an existing structure,Addition	Fire Sprinklers: No LUR or Permit Application No.:		
Plan Submitted Option	: pdf [File 1]	Proposed use: Single-family dwelling							
APPEAL INFORMA									
Code Section	ORSC 302.3								
Requires	Dwelling units in two-family dwellings shall be separated from each other by wall and/or floor assemblies having not less than a 1-hour fire-resistance rating when tested in accordance with ASTME119 or UL263. Fire-resistance-rated floor-ceiling and wall assemblies shall extend to and be tight against the exterior wall and wall assemblies shall extend to the underside of the roof sheathing.								
Proposed Design	Converting an existing attached garage to a 2-story ADU. The proposed alternate method of construction would leave the 1/2" drywall along the interior of the existing dwelling in place, and apply 2 layers of 5/8" type X gypsum wall board to the interior side of both floors of the proposed ADU. The existing 2x4 wall will be furred out to 2x6 and filled with R-19 minimum batt insulation. The GWB will be nailed to 2x6 wood studs from sill to top plate.								
Reason for alternative	house, which will be disruptive to the access the wall from the garage/ADU side, whic a continuous non-combustible surface	use side will require excessive demolition to the existing inhabitants as well as expensive. It will be more efficient to h will already be demolished. The 2-layer system will provide we with no openings between the two units. In combination nouse side, this assembly will provide equivalent or excessive							

APPEAL DECISION





Appeals | The City of Portland, Oregon

Note: Five eights inch Type X gypsum sheathing to be installed on exterior of wall at 2nd floor level.

The Administrative Appeal Board finds that the information submitted by the appellant demonstrates that the approved modifications or alternate methods are consistent with the intent of the code; do not lessen health, safety, accessibility, life, fire safety or structural requirements; and that special conditions unique to this project make strict application of those code sections impractical.

Pursuant to City Code Chapter 24.10, you may appeal this decision to the Building Code Board of Appeal within 180 calendar days of the date this decision is published. For information on the appeals process and costs, including forms, appeal fee, payment methods and fee waivers, go to www.portlandoregon.gov/bds/appealsinfo, call (503) 823-7300 or come in to the Development Services Center.

GA-600-2012 FIRE RESISTANCE DESIGN MANUAL

Approval reference


wall. Please


see


A-10 For proposed design


GA FILE NO. WP 3242	· · · ·	GENERIC	1 HOUF	2 ·	50 to 54 STC
GYPSUM WALLBO MINERAL OR GLASS F Resilient channels 16" o.c. attached at o.c. with 11/4" Type S drywall screws veneer base applied at right angles with vertical joints located midway b stud space. OPPOSITE SIDE: One layer 5/8" type > parallel or at right angles to studs wit 15/64" heads, 7" o.c. Vertical joints staggered 24" on opposi	TIBER INSULATION right angles to Ol of One layer 5/8" type to channels with between studs. 3" of gypsum wallboar th 6d cement coate	NE SIDE of 2 x 4 wood studs 24" be X gypsum wallboard or gypsum 1" Type S drywall screws 8" o.c. mineral or glass fiber insulation in d or gypsum veneer base applied ed nails, 1 ⁷ /s" long, 0.0915" shank,	FIRE FIRE Thickness: Approx. Weight: Fire Test: Sound Test:	Based 0 05NK0 UL Des NRCC	SOUND
GA FILE NO. WP 3243		GENERIC	1 HOUF	2	50 to 54 STC SOUND

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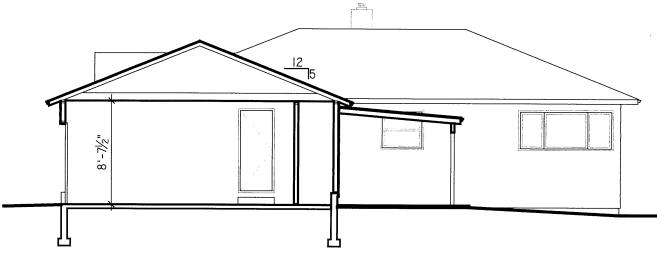


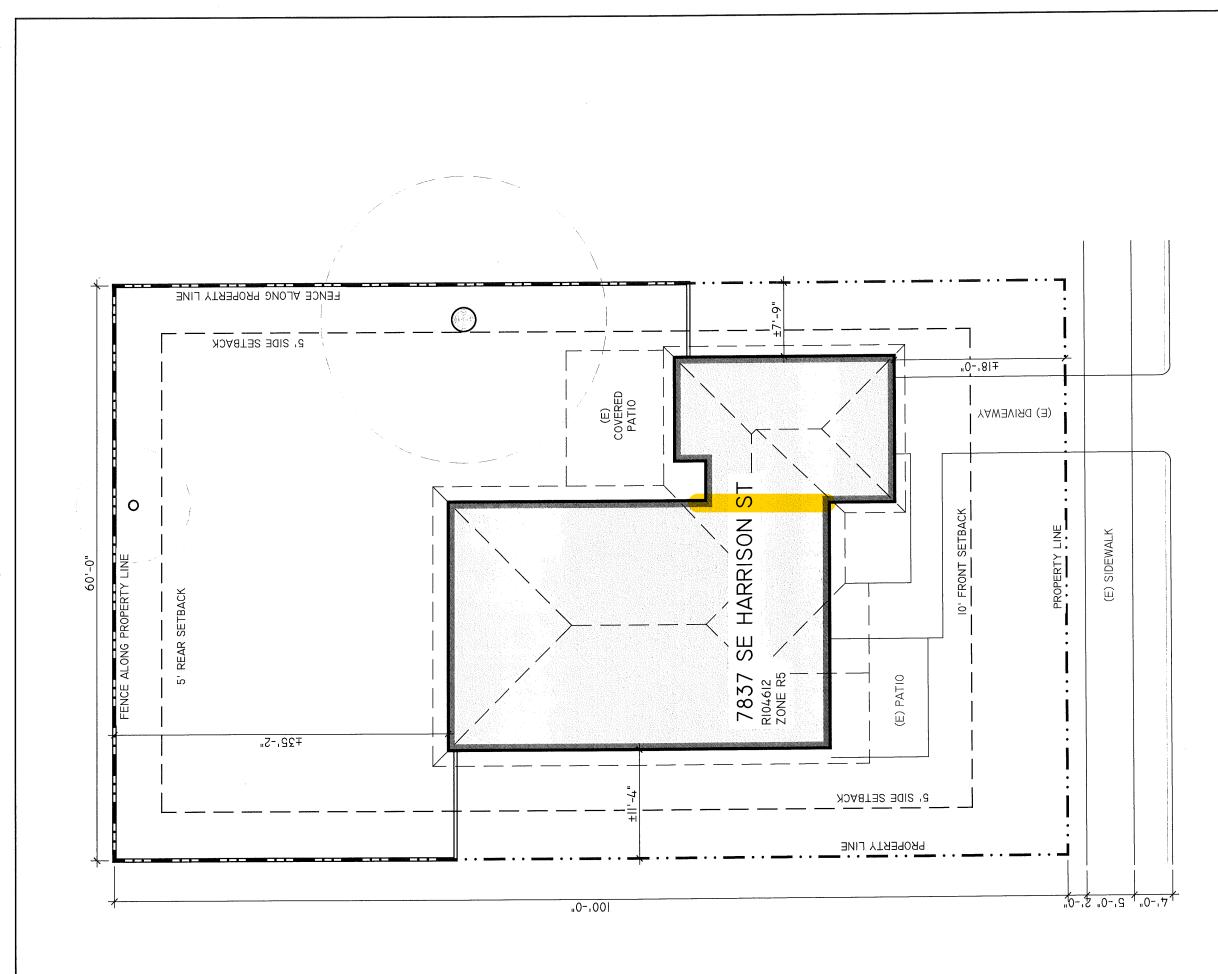


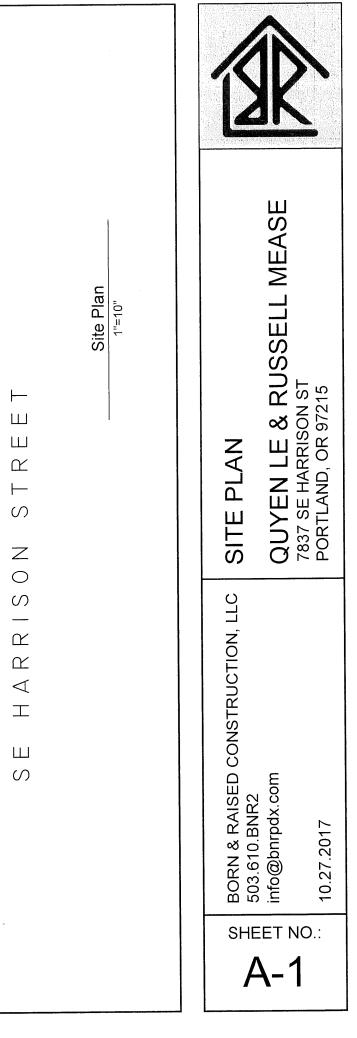

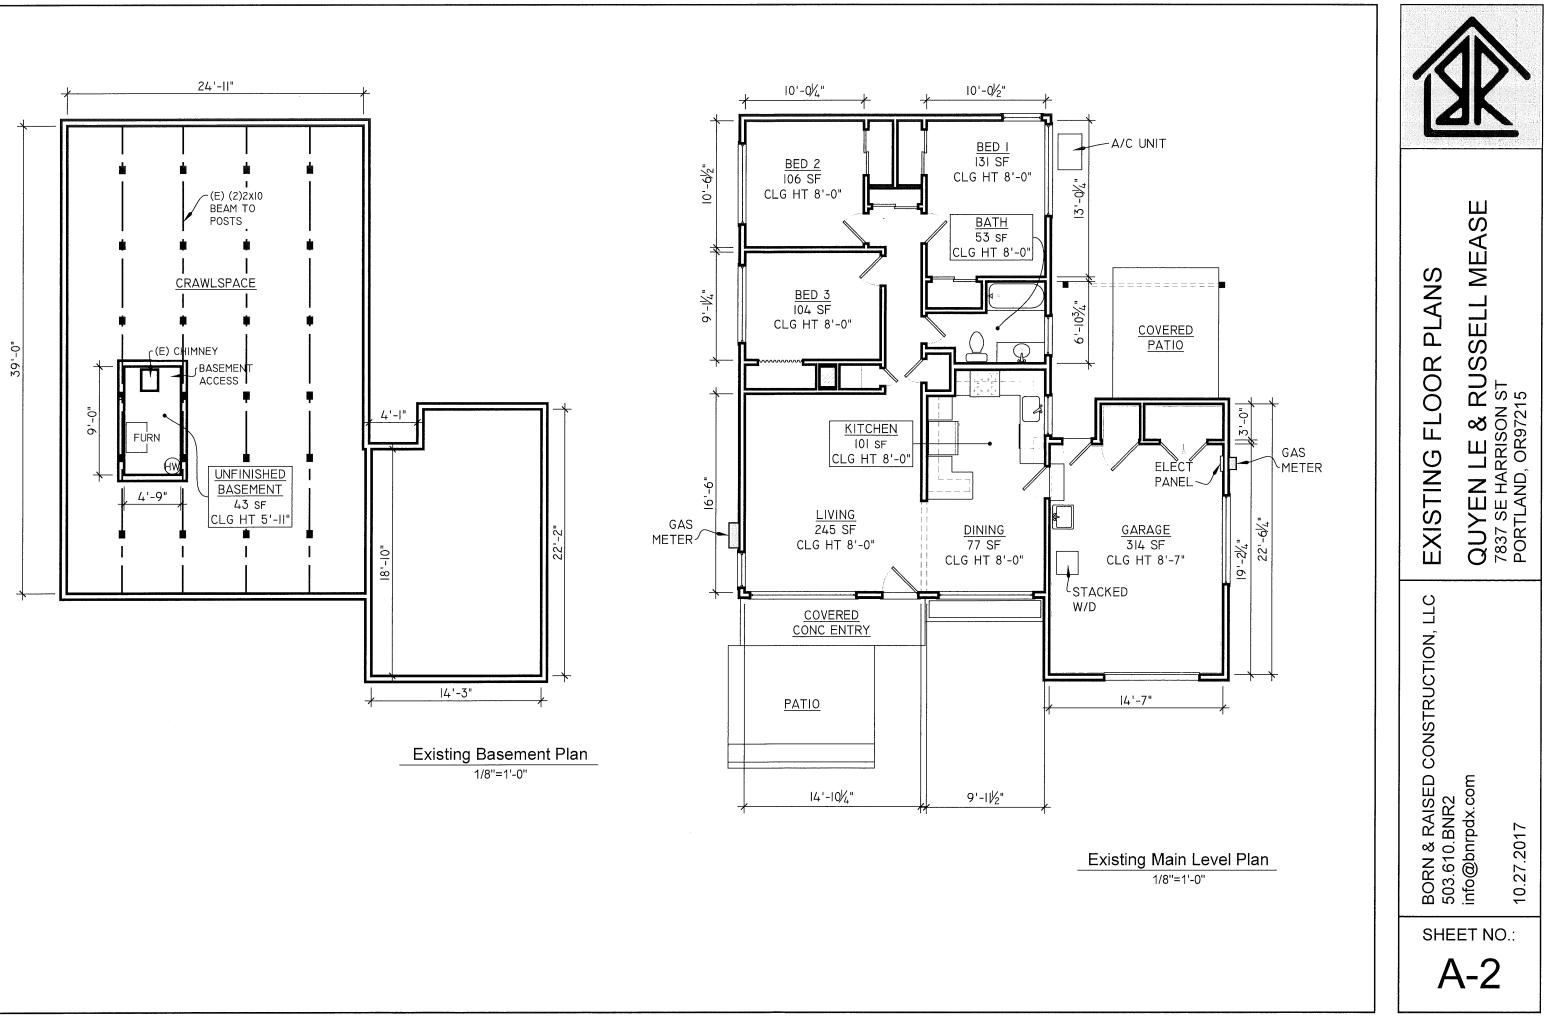

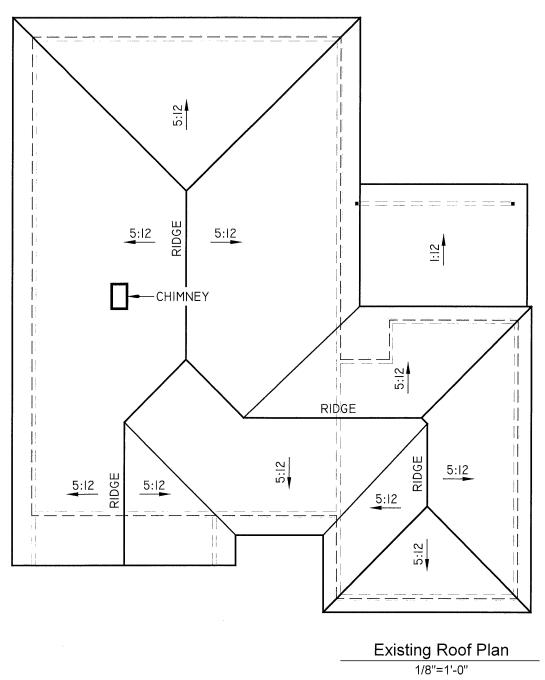




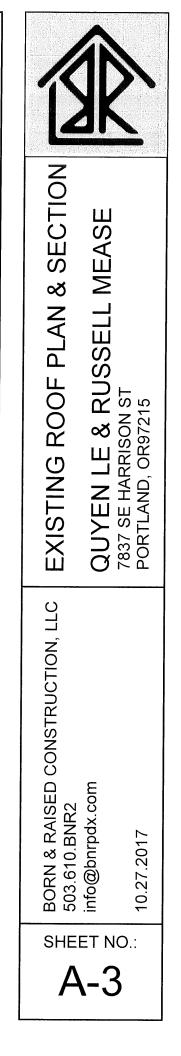



Existing Section


1/8"=1'-0"



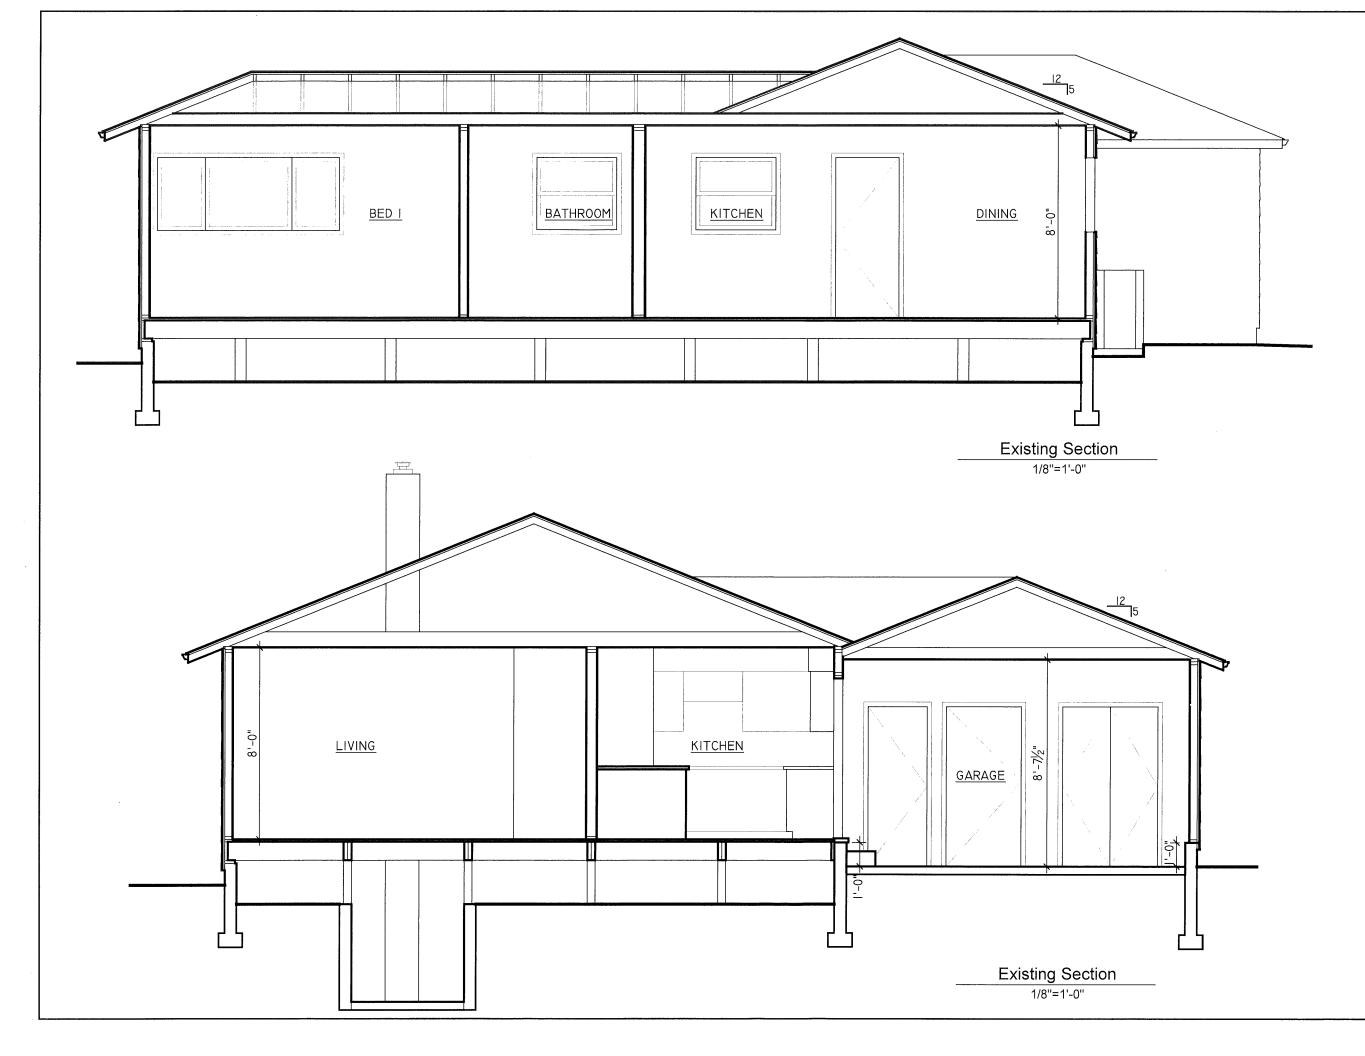

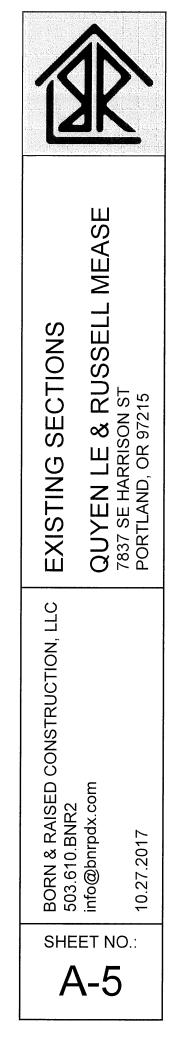

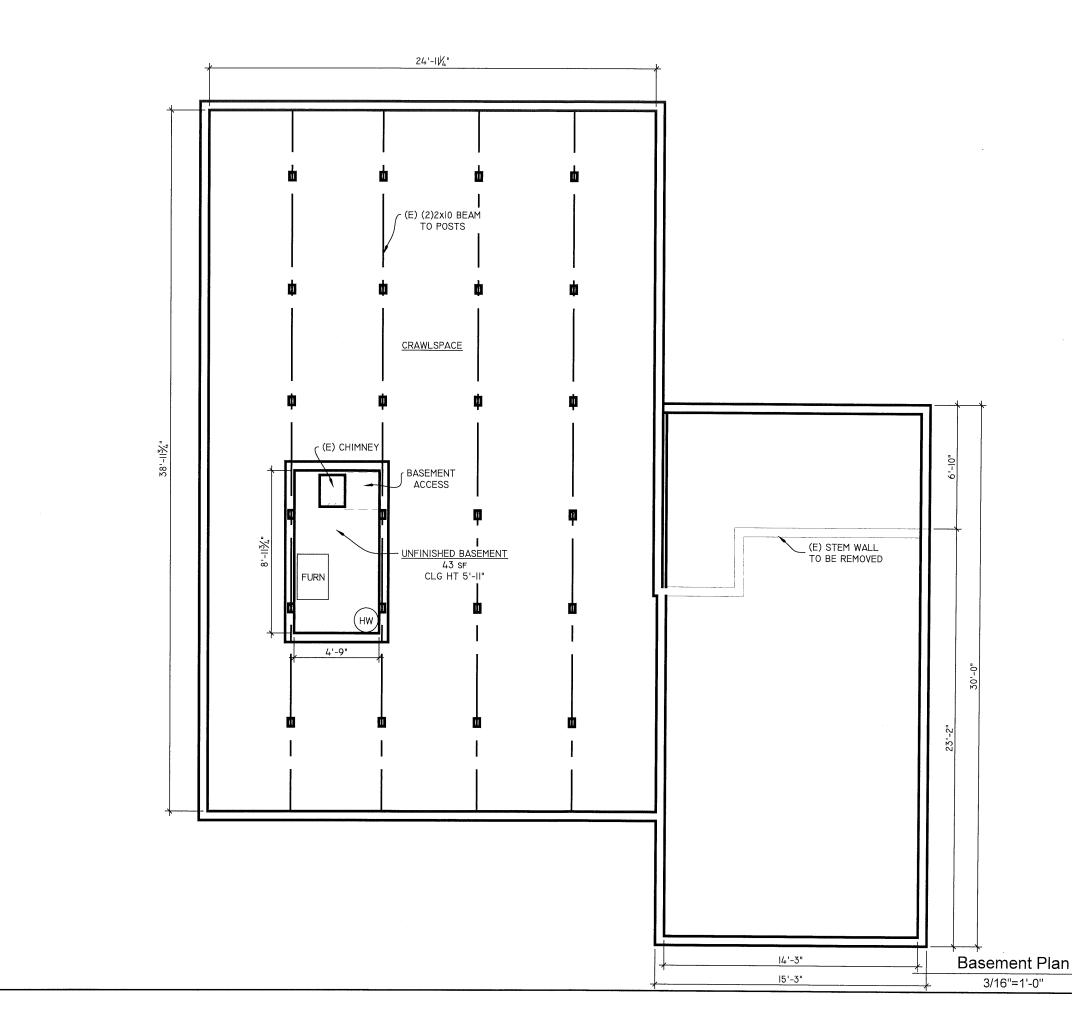

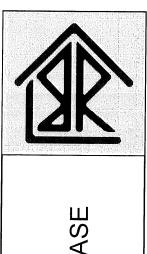

QUYEN LE & RUSSELL MEASE 7837 SE HARRISON ST PORTLAND, OR 97215 FOUNDATION PLAN BORN & RAISED CONSTRUCTION, LLC 503.610.BNR2 info@bnrpdx.com 10.27.2017 SHEET NO .: A-6

