DEMO & INFILL BUILDING PERMIT PACKAGE

Level No.	Туре	Structural Frame	Bearing Walls		Non-Bearing	Non-Bearing	Floors	Roof
			Ext.	Int.	Walls-Ext.	Walls & Part. Int.		
В	V-B	0	1*	0	1*	0	0	N/A
01	V-B	0	1*	0	1*	0	0	0
02	V-B	0	1*	0	1*	0	0	0

* Value aligns with most, but not all exposures. refer to Table 602 below for more detailed breakdown

FIRE RESISTIVE RATINGS (Table 602)

FIRE SEPARATION DISTANCE (FEET)	TYPE OF CONSTRUCTION	OCCUPANCY GROUP H	OCCUPANCY GROUP F-1, M, S-1	OCCUPANCY GROUP A, B, E, F-2, R,S-2, U
X < 5 (NORTH, EAST, SOUTH)	ALL	3	2	1
X > 30 (WEST)	ALL	0	0	0

FIRE RESISTIVE RATINGS (Table 705.5)

rating of exterior walls with a fire separation distance of greater than 10 feet shall be rated for exposure to fire from the inside. The required fire-resistive rating of exterior walls with a fire separation distance of less than or equal to 10 feet shall

EXTERIOR WALL FIRE RATING BASED ON FIRE SEPARATION DISTANCE (Table 602) AND MAX. **OPENINGS (Table 705.8)**

Building Face	Construction Type	Occupancy	Distance to Property Line	Required Fire Resistance Rating (Table 602)	Max Opening % Allowed (Table 705.8)	Opening % Provided
North	V-B	B/S2	0'	1	NOT PERMITTED	N/A
East	V-B	B/S2	0'	1	NOT PERMITTED	N/A
South	V-B	B/S2	0'	1	NOT PERMITTED	N/A
West	V-B	B/S2	30'	0	NOT REQ'D	N/A

* PER CITY OF PORTLAND CODE GUIDE IBC/6/#4

ARCHITECTURAL GENERAL NOTES

- NOTIFY THE ARCHITECT IN WRITING, OF ANY DISCREPANCIES PRIOR TO PRECEDING WITH WORK. PROVIDE FIRE RESISTANT CLOSURE MEETING THE REQUIREMENTS OF THE GOVERNING FIRE AUTHORITIES AT ALL GAPS AROUND PENETRATING DUCTS, PIPES, CONDUITS, STRUCTURAL ELEMENTS, ETC. AT ALL FIRE RATED BUILDING PARTITIONS AND CEILINGS.
- ROOM AND DOOR NUMBERS SHOWN ON DRAWINGS ARE FOR CONSTRUCTION PURPOSES ONLY. WORK SHALL CONFORM TO APPLICABLE BUILDING CODES AND ORDINANCES, AS MODIFIED FOR THIS BUILDING BY APPEALS ON RECORD AT THE PORTLAND BUREAU OF BUILDINGS. IN CASE OF CONFLICT WHERE THE METHODS OR STANDARDS OF INSTALLATION OF THE MATERIALS

SPECIFIED DO NOT EQUAL OR EXCEED THE REQUIREMENTS OF THE LAWS OR ORDINANCES, THE

- LAW OR ORDINANCE SHALL GOVERN. NOTIFY ARCHITECT OF CONFLICTS. IT IS THE CONTRACTOR'S RESPONSIBILITY TO VERIFY EXISTING CONDITIONS. NO ALLOWANCE WILL BE MADE FOR UNFAVORABLE CONDITIONS OR EVENT WHICH MIGHT HAVE BEEN UNFORESEEN FROM A THOROUGH EXAMINATION OF THE SITE. CONTRACTOR SHALL ASSUME FULL RESPONSIBILITY FOR THE CONSEQUENCES OF ACTING ON CONCLUSIONS DRAWN FROM INFORMATION AVAILABLE AT THE TIME.
- THE CONTRACTOR SHALL CONSULT PLANS OF ALL TRADES FOR ALL OPENINGS AND ROUGH-OUTS THROUGH SLABS, WALLS, CEILINGS AND ROOFS FOR DUCTS, PIPES, CONDUITS, CABINETS AND EQUIPMENT, AND SHALL VERIFY SIZE AND LOCATION BEFORE PROCEEDING WITH WORK.
- CONTRACTOR TO PROVIDE ALL LABOR, TRANSPORTATION, EQUIPMENT AND SERVICES NECESSARY TO PERFORM WORK SHOWN ON THE DRAWINGS AND DESCRIBED IN THE PROJECT SPECIFICATIONS.
- ALL BUILDING ELEMENTS SHOWN ARE EXISTING AND TO REMAIN UNLESS OTHERWISE NOTED.
- EXISTING STRUCTURE TO BE LEFT UNDISTURBED AND INTACT. PERFORM NO DEMOLITION THAT MAY COMPROMISE THE STRUCTURAL INTEGRITY OF THE BUILDING WITHOUT WRITTEN APPROVAL OF THE ARCHITECT / ENGINEER.
- EXTREME CARE SHALL BE TAKEN BY THE CONTRACTOR TO PROTECT ALL EXISTING AREAS FROM DAMAGES THAT MIGHT OCCUR DURING DEMOLITION. THE CONTRACTOR WILL BE HELD RESPONSIBLE FOR ALL AREAS THAT HAVE BEEN DAMAGED DUE TO INADEQUATE PROTECTION. SALVAGE/RECYCLE REMOVED MATERIALS. RETURN AND BUILDING STANDARD MATERIALS WHICH
- ARE REUSABLE TO BUILDING STOCK. ALL WALLS, DOORS, FLOORS, CEILINGS DENOTED AS EXISTING TO REMAIN WITHIN THE LIMITS OF WORK, ARE TO BE PATCHED, PLASTERED, SANDED AND PREPARED READY FOR THE NEW FINISH

SITE INFORMATION

PORTLAND, OR 97204 BLOCK 31, NORTH 1/2 OF LOT 6 LEGAL DESCRIPTION

PROPERTY ID YEAR BUILT

OLD TOWN COMMUNITY ASSOCIATION **NEIGHBORHOOD ASSOCIATION**

PROJECT DESCRIPTION

AN EXISTING 2-STORY LOW-RISE OFFICE BUILDING WITH AN EXISTING 1-STORY BASEMEN

EXTERIOR WALL AND FILLING OF THE OPENINGS WITH NEW 1-HOUR EXTERIOR MASONRY WALL

APPLICABLE CODES

2014 OREGON STRUCTURAL SPECIALTY CODE (BASED ON 2012 IBC) 2016 PORTLAND FIRE CODE (BASED ON 2007 OREGON FIRE CODE)

ZONING CODE

PROJECT IS NOT SUBJECT TO DESIGN REVIEW

LUR NUMBER CXd, CENTRAL CITY (SUBDISTRICT - DOWNTOWN) BASE ZONE

OVERLAY ZONE Design Overlay, Historic Distric (SKIDMORE/OLD TOWN)

MAXIMUM HEIGHT MAXIMUM FAR

OCCUPANCY TYPES

S-2 / STORAGE -OFFICE SPACE (POTENTIAL USE) B / OFFICE

ENTIRE BUILDING IS TYPE IV HEAVY TIMBER CONSTRUCTION ALLOWED UNLIMITED AREA FOR MOST RESTRICTIVE. NO SEPARATION REQUIRED.

NO SEPARATION IS REQUIRED BETWEEN ACCESSORY OCCUPANCIES AND THE MAIN OCCUPANCY (ACCESSORY USE< 10% OF FLOOR AREAS)

*No changes to any building elements affecting occupancy are proposed in this permit package. All elements shown herein are existing UON.

ALLOWABLE HEIGHT AND AREA

ALLOWABLE HEIGHT AND AREA (TABLE 503)

CONSTRUCTION TYPE	ALLOWABLE HEIGHT				
TYPE V-B	40' (+20' = 60' TOTAL)*	[VARIED]			
OCCUPANCY GROUP	ALLOWABLE STORIES	ALLOWABLE AREA			
S-2	2 (+2 = 4 TOTAL)*	13,500 SF (x2 = 27,000 SF)**			
В	2 (+2 = 4 TOTAL)*	9,000 SF (x2 = 18,000 SF)**			

* Per OSSC 2014 Section 504.2: buildings equipped throughout with approved automatic sprinkler systems in accordance with section 903.3.1.1 may increase listed allowable height by 20 feet and 2 stories. ** Per OSSC 2014 Section 506.3: buildings equipped throughout with approved automatic sprinkler systems in accordance with section 903.3.1.1 may increase listed allowable area by 200% for buildings with more than one story above the grade plane.

ACTUAL HEIGHT AND AREA

CONSTRUCTION TYPE	ACTUAL HEIGHT			
TYPE V-B	~35'	2,500 SF/FLR = 7,500 SF TO		
OCCUPANCY GROUP	ACTUAL STORIES	ACTUAL AREA		
S-2	1	2,500 SF		
В	2	5,000 SF		

All values shown are maximum expected use. No changes to any building elements affecting occupancy are proposed in this permit package. All elements shown herein are existing UON.

DRAWING INDEX

		*	
DRA	AWING ISSUE LOG	14 JUNE 2018	
	SEND: * INDICATES PERMIT SET X INCLUDED 0 ISSUED FOR REFERENCE ONLY X PREVIOUSLY ISSUED	BUILDING PERMIT	
	NERAL		
G001	DRAWING INDEX AND VINCINITY MAP	X	
05 - AR	RCHITECTURE		
A000	ARCHITECTURAL GENERAL INFORMATION	X	
A090	SITE PLAN	X	
A101	FLOOR PLANS	X	200
A102	FLOOR PLANS	X	
A201	EXTERIOR ELEVATIONS	X	
AZUI	EATERIOR ELEVATIONS		
A301	SECTIONS	X	
MOUI			

PROJECT TEAM

ITM INVESTMENTS LLC

1500 SW 5TH AVE. #1602 PORTLAND, OR 97201 Tel: (503) 719-3260 Contact: TIM MCMANN


Email: tim@mcmann.com CONTRACTOR LEASE CRUTCHER LEWIS

500 SW 12TH AVE PORTLAND, OR 97205 Tel: (503) 223-0500

Contact: PAUL RISO Email: paul.riso@lewisbuilds.com GBD ARCHITECTS INCORPORATED 1120 NW COUCH ST, SUITE 300 PORTLAND, OR 97209 Tel: (503) 224-9656 Contact: OMID NASERI Email: omid@gbdarchitects.com STRUCTURAL

KPFF CONSULTING ENGINEERS 111 SW 5TH AVE, SUITE 2500 PORTLAND, OR 97204 Tel: (503) 227-3251 Contact: NATHAN INGRAFFEA Email: nathan.ingraffea@kpff.pdx.com

VICINITY MAP

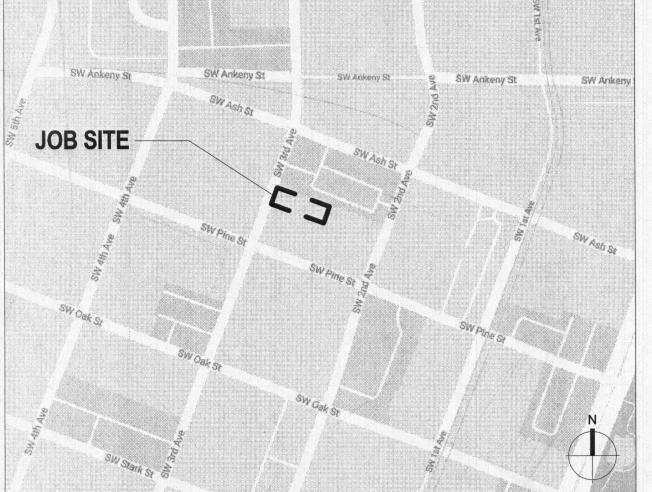

GBD Architects, Incorporated

1120 NW Couch St. Portland, OR 97209

Tel. (503) 224-9656 gbdarchitects.com

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TRIVET BUILDING

JUN 22


06/14/2018


SCALE 12" = 1'-0"


SHEET TITLE


DRAWING INDEX AND **VINCINITY MAP**

A/C AC AD ADJ AESS	AIR CONDITIONING	GA	GAUGE	R	RADIUS OR RISER
AD ADJ AESS AFF		GALV	GALVANIZED	RA	RETURN AIR
DJ ESS FF	ASPHALTIC CONCRETE	GB GC	GRAB BAR	RB RCP	RUBBER BASE REFLECTED CEILING PLAN
ESS FF	AREA DRAIN ADJUSTABLE	GL	GENERAL CONTRACTOR GLASS	RD RD	ROOF DRAIN
FF	ARCHITECTURALLY	GYP BD	GYPSUM BOARD	REF	REFERENCE
	EXPOSED STRUCTURAL STEEL			REFL	REFLECTED
	ABOVE FINISHED FLOOR			REINF	REINFORCED
FG	ABOVE FINISHED GRADE	HB	HOSE BIBB	REQD	REQUIRED
.HU .LT	AIR HANDLING UNIT ALTERNATE	HDR HDWD	HEADER HARDWOOD	RESIL REV	RESILIENT REVISION
LUM	ALUMINUM	HM	HOLLOW METAL	RM	ROOM
NOD	ANODIZE(D)	HORIZ	HORIZONTAL	RO	ROUGH OPENING
PPROX	APPROXIMATE	HR	HOUR		
RCH	ARCHITECT(URAL)	HT	HEIGHT	•	SOUTH
UTO	AUTOMATIC	HTG HTR	HEATING HEATER	S SAM	SELF ADHESIVE MEMBRANE
		HVAC	HEATING, VENTILATING & AIR	SC	SOLID CORE
D	BOARD		CONDITIONING	SCHED	SCHEDULE
FF	BELOW FINISH FLOOR			SD	SOAP DISPENSER
LDG	BUILDING	ID.	INSIDE DIAMETER	SF SHTHG	SQUARE FOOT OR SQUARE FEET SHEATHING
BLK BLKG	BLOCK BLOCKING	ID	OR INSIDE DIMENSION	SHT	SHEET
SM	BEAM OR BENCHMARK	IN	INCH	SIM	SIMILAR
OD	BOTTOM OF DECK	INCL	INCLUDE(D)	SND	SANITARY NAPKIN DISPENSER
BOT	воттом	INFO	INFORMATION	SNDU	SANITARY NAPKIN
BRG	BEARING	INSUL	INSULATION	000	DISPOSAL UNIT
BSMT	BASEMENT	INT IWRB	INTERIOR INTEGRAL WEATHER	SOG SPEC	SLAB ON GRADE SPECIFICATION
		IVVID	RESISTIVE BARRIER	SQ	SQUARE
СВ	CATCH BASIN			SST	STAINLESS STEEL
CH	COAT HOOK			ST	STREET
CIP	CAST-IN-PLACE	J-BOX	JUNCTION BOX	STD	STANDARD
CJ CJ	CONTROL JOINT CENTERLINE	JAN JT	JANITOR CLOSET JOINT	STL STOR	STEEL STORAGE
CLG	CEILING	JI	JOHNI	STRUCT	STRUCTURAL
CLR	CLEAR			SUSP	SUSPEND(ED)
CMU	CONCRETE MASONRY UNIT	LAV	LAVATORY	SV	SHEET VINYL
CNTR	COUNTER	LB	POUND	SYM	SYMMETRICAL
COL	COLUMN	LF	LINEAR FOOT OR FEET		
COMP	COMPOSITE CONCRETE			Т	TREAD
CONT	CONTINUE/CONTINUOUS	MATL	MATERIAL	T&G	TONGUE & GROOVE
CORR	CORRIDOR	MAX	MAXIMUM	TEMP	TEMPORARY
CPT	CARPET	MDF	MEDIUM DENSITY FIBERBOARD	THRU	THROUGH
CT	CERAMIC TILE	MECH	MECHANICAL	TOB	TOP OF CONCRETE
CTR	CENTER	MEMB MFR	MEMBRANE MANUFACTURER	TOC	TOP OF CONCRETE OR TOP OF CURB
		MH	MANHOLE	TOD	TOP OF DECK
OBL	DOUBLE	MIN	MINIMUM	TOFF	TOP OF FINISH FLOOR
DET	DETAIL	MIRR	MIRROR	TOS	TOP OF SLAB
)F	DRINKING FOUNTAIN	MISC	MISCELLANEOUS		OR UNDERLAYMENT
OIA	DIAMETER	MTD	MOUNTED	TP TPD	TOILET PARTITION TOILET PAPER DISPENSER
DIM DN	DIMENSION DOWN	MTL	METAL	TPNG	TOPPING
)P	DIMENSION POINT			TR	TOWEL RACK
DR .	DOOR	N	NORTH	TSD	TOILET SEAT COVER
OS	DOWNSPOUT	NA	NOT APPLICABLE		DISPENSER
OWG	DRAWING	NIC	NOT IN CONTRACT	TYP	TYPICAL
		NO NTS	NUMBER NOT TO SCALE		
E)	EXISTING	NTS	NOT TO SCALE	UNO	UNLESS NOTED OTHERWISE
E) E	EAST				
EA	EACH	OC	ON CENTER		
ΞJ	EXPANSION JOINT	OD	OUTSIDE DIAMETER	VENT	VENTILATION
L	ELEVATION ELECTRIC(AL)	OF/O	OR OUTSIDE DIMENSION	VERT	VERTICAL VESTIBULE
LEC	ELECTRIC(AL) ELEVATOR	OF/CI	OWNER FURNISHED, CONTRACTOR INSTALLED	VEST VFY	VERIFY
ENCL	ENCLOSURE	OF/OI	OWNER FURNISHED,	VFT	VERIFY VERIFY IN FIELD
ENGR	ENGINEER	31731	OWNER INSTALLED	VP VP	VENEER PLASTER
EQ	EQUAL	OPNG	OPENING		
EQUIP	EQUIPMENT	OPP	OPPOSITE		WEGT
EXIST	EXISTING	OPT	OPTIONAL	W W/	WEST WITH
EXP EXT	EXPANSION EXTERIOR	ORIG OSB	ORIGINAL ORIENTED STRAND BOARD	w/ WB	WOOD BASE
-/ (1	E (E (O)	335	C. WEITTED STITUTED DON'TO	WC	WATER CLOSET
				WD	WOOD
-A	FIRE ALARM	PC	PRECAST CONCRETE	W/O	WITHOUT
The state of the s	FLAT BAR	PERF	PERFORATED	WP	WATERPROOFING
	FLOOR DRAIN FOUNDATION	PL PLAM	PROPERTY LINE OR PLATE PLASTIC LAMINATE	WRAB	WATER RESISTANT AIR BARRIER
D	FIRE EXTINGUISHER	PLAM	PLUMBING	WRB	WATER RESISTANT BARRIER
D DTN	FIRE EXTINGUISHER CABINET	PLYWD	PLYWOOD	WT	WEIGHT
D DTN E		PNL	PANEL		
D DTN E EC	FINISH FLOOR		PRELIMINARY		
D DTN E E EC IN FLR	FINISH(ED)	PRELIM		- / mm n / mm	TO ALIGE CO.
FD FDTN FE FEC FIN FLR FIN FLASH	FINISH(ED) FLASHING	PSI	POUNDS PER CUBIC INCH	XFMR	TRANSFORMER
FD FDTN FE FEC FIN FLR FIN FLASH FLASH	FINISH(ED) FLASHING FLOOR	PSI PT	POST TENSIONED	XFMR	TRANSFORMER
ED EDTN EE EEC EIN FLR EIN ELASH ELR EOF	FINISH(ED) FLASHING FLOOR FACE OF FINISH	PSI PT PTD	POST TENSIONED PAPER TOWEL DISPENSER		
FD FDTN FE FEC FIN FLR FIN FLASH FLR FOF	FINISH(ED) FLASHING FLOOR	PSI PT	POST TENSIONED	XFMR YD	YARD
FD FDTN FE FEC FIN FLR FIN FLASH FLR FOF FOC FOM	FINISH(ED) FLASHING FLOOR FACE OF FINISH FACE OF CONCRETE FACE OF MASONRY FACE OF STUDS	PSI PT PTD PTN	POST TENSIONED PAPER TOWEL DISPENSER PARTITION		
FB FD FDTN FE FEC FIN FLR FIN FLASH FLASH FOF FOC FOM FOS FR FT	FINISH(ED) FLASHING FLOOR FACE OF FINISH FACE OF CONCRETE FACE OF MASONRY	PSI PT PTD	POST TENSIONED PAPER TOWEL DISPENSER		

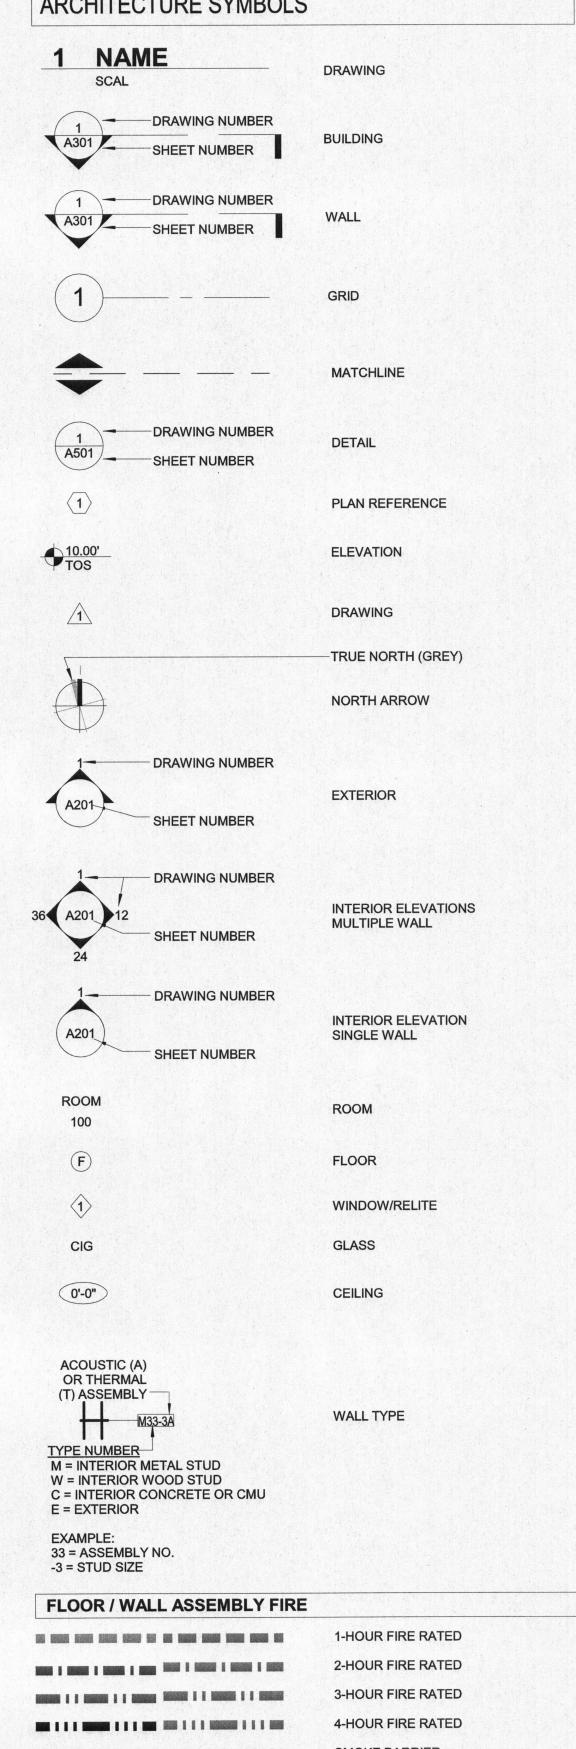

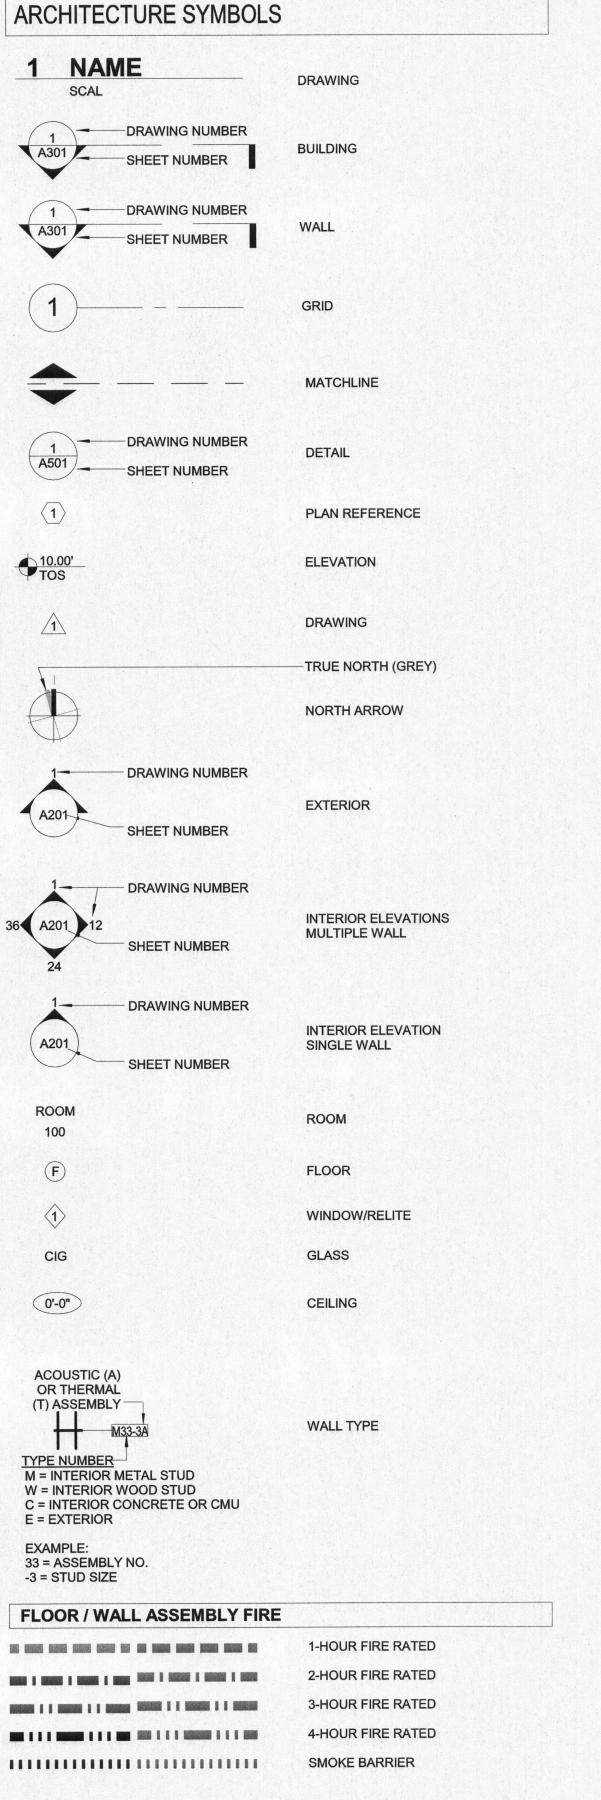

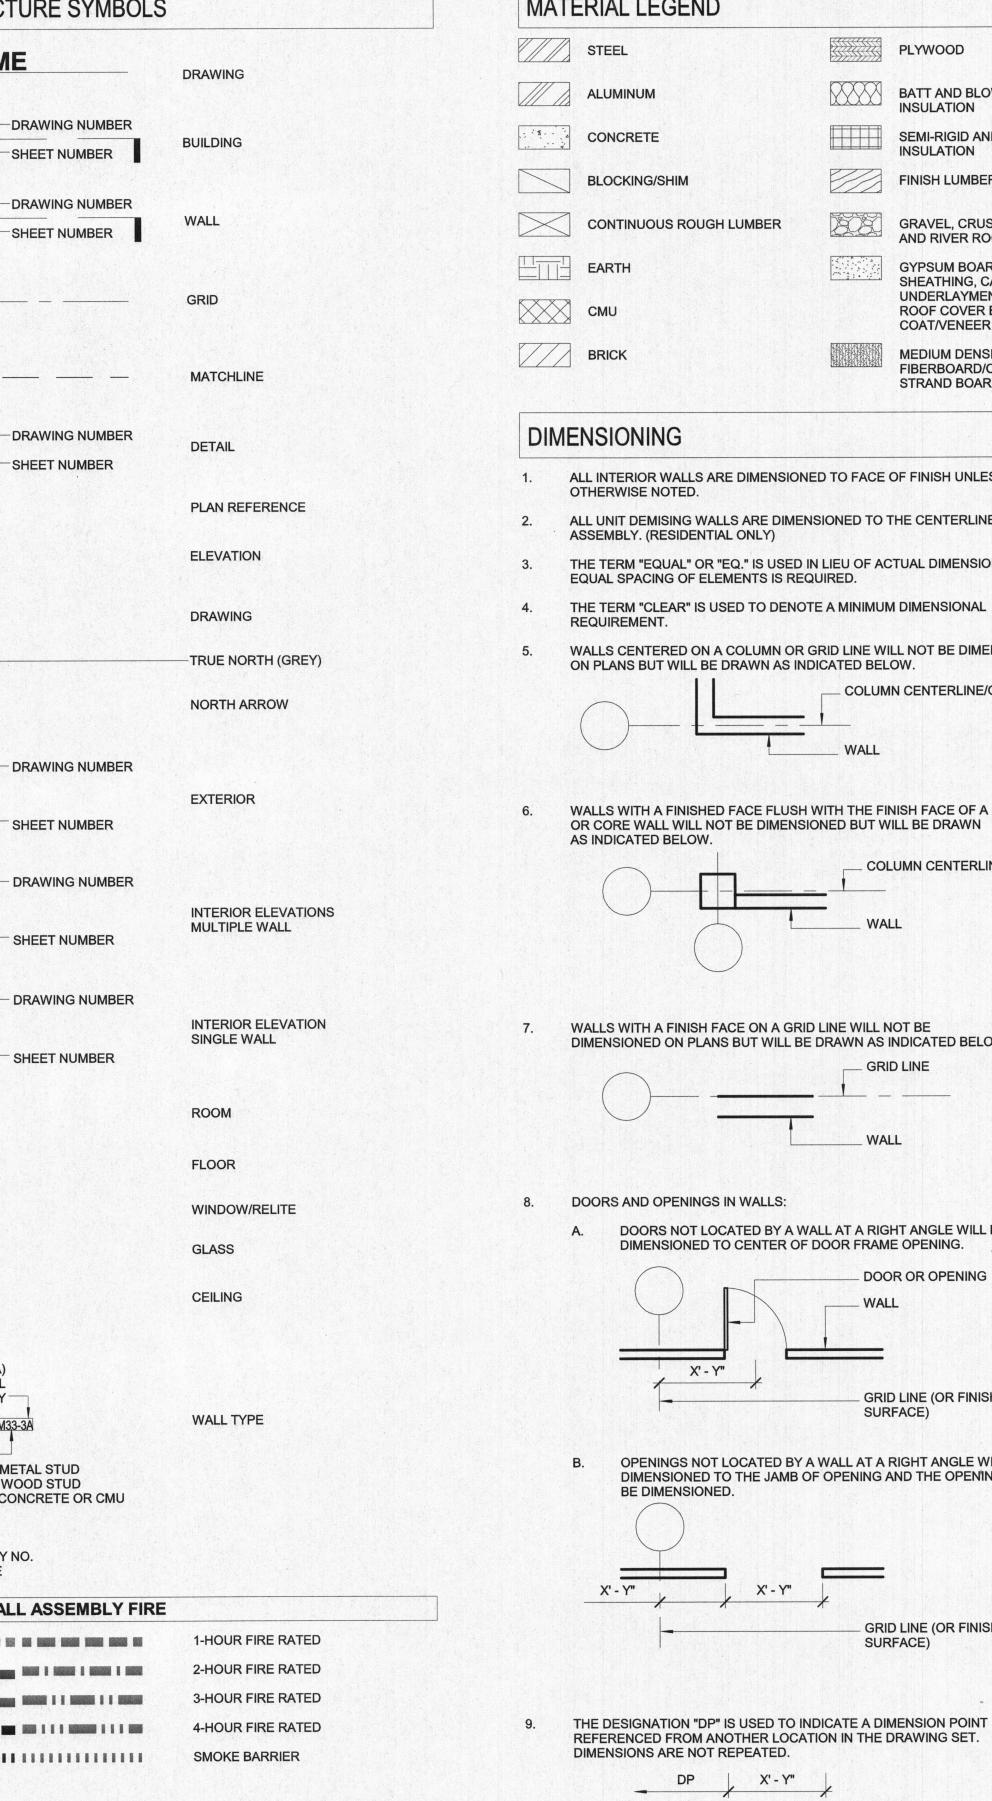

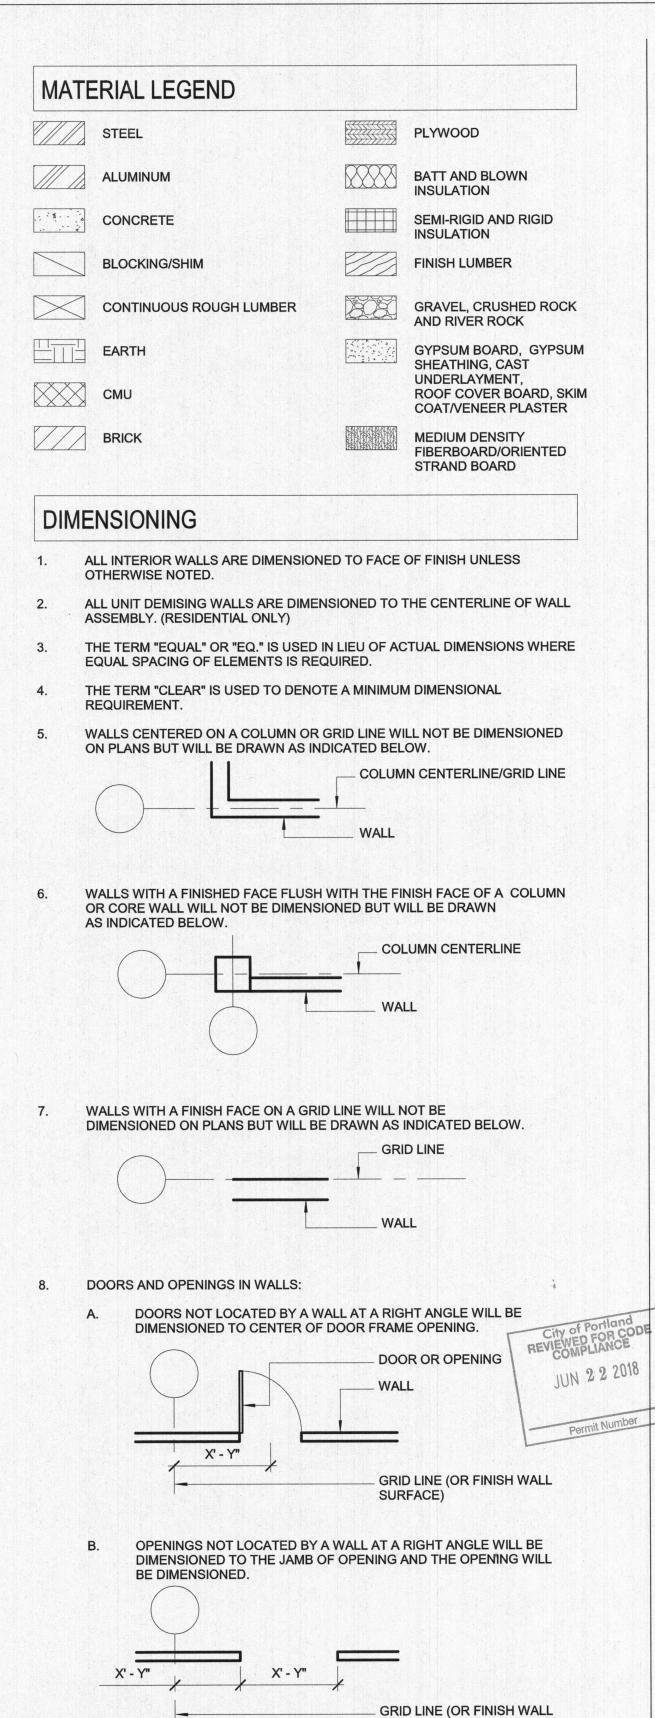



PROJECT

CLIENT

DATE

06/14/2018

20166150

12" = 1'-0"

SHEET TITLE

GENERAL

ARCHITECTURAL

INFORMATION

SCALE

SURFACE)

PROJECT NUMBER

TRIVET BUILDING

122 SW 3RD AVE

PORTLAND, OR 97204

ITM INVESTMENTS

LLC 1500 SW 5TH AVE #1602

PORTLAND, OR 97201


GBD

GBD Architects, Incorporated

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Tel. (503) 224-9656 gbdarchitects.com

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PROJECT

TRIVET BUILDING

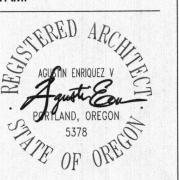122 SW 3RD AVE PORTLAND, OR 97204

CLIENT

ITM INVESTMENTS LLC 1500 SW 5TH AVE #1602 PORTLAND, OR 97201

REVISIONS

DATE

06/14/2018


PROJECT NUMBER 20166150

SCALE

1/16" = 1'-0"

SITE PLAN

A090

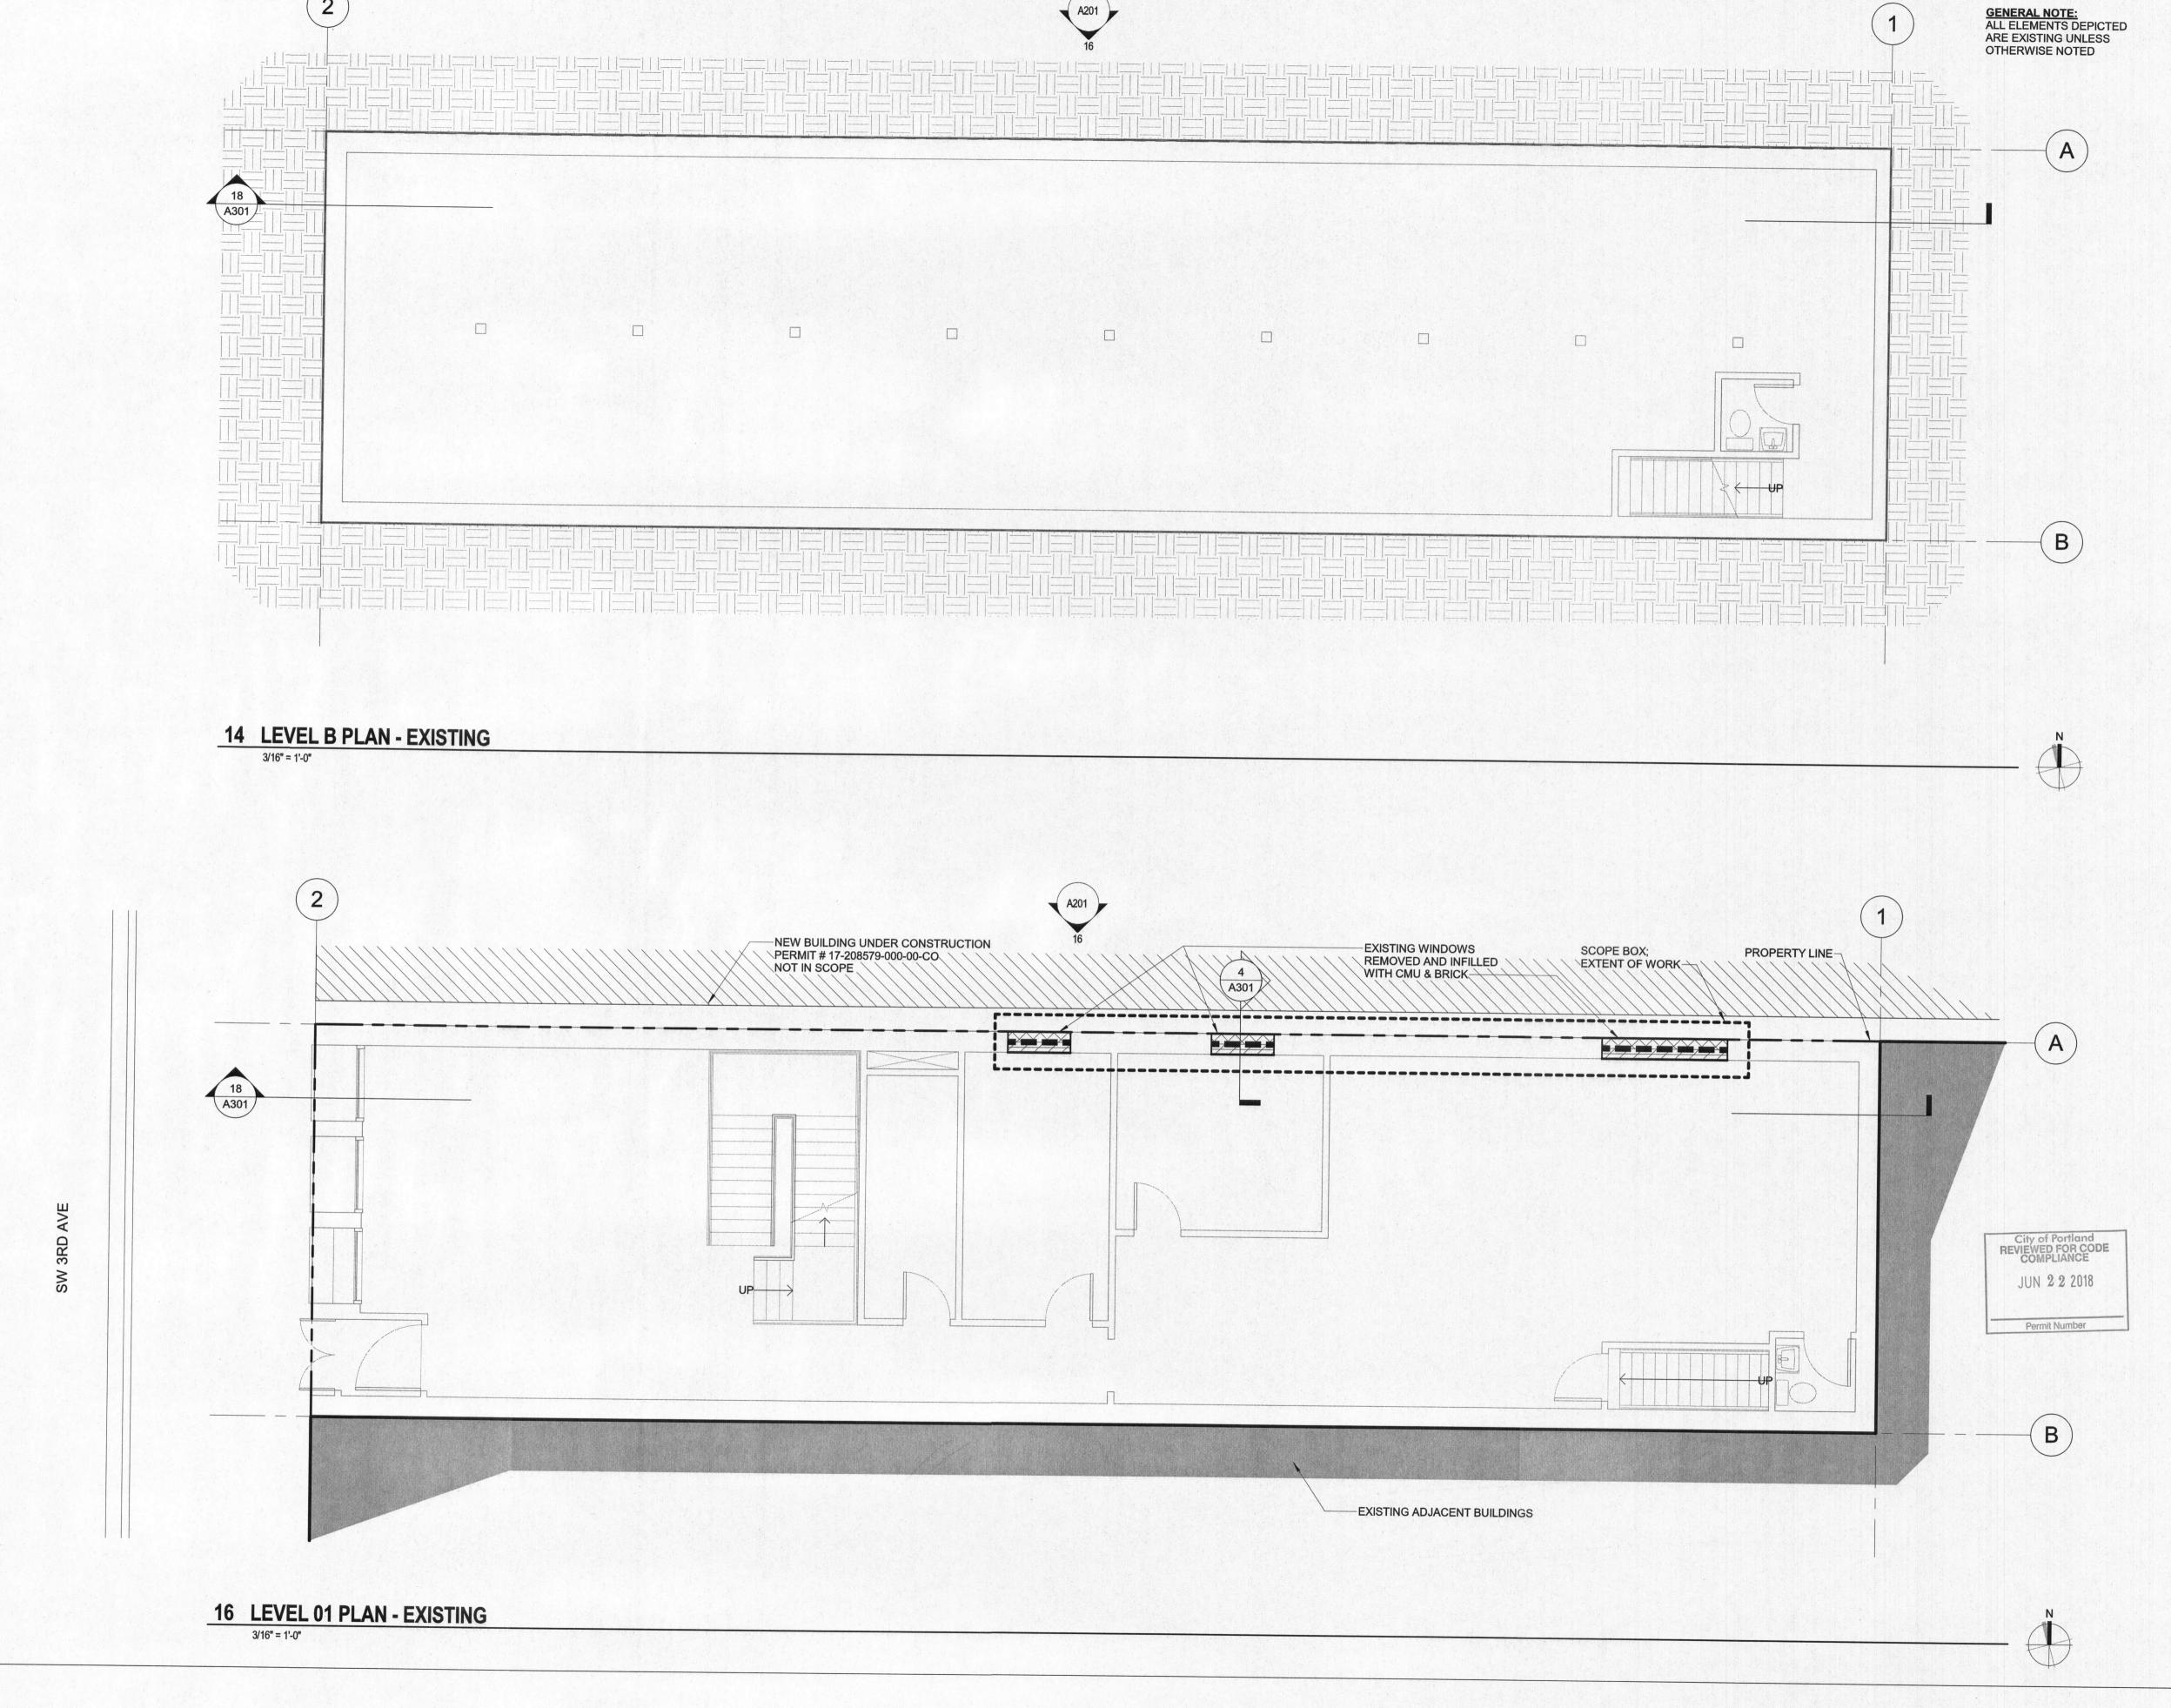

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PROJECT

TRIVET BUILDING

122 SW 3RD AVE PORTLAND, OR 97204

CLIENT

ITM INVESTMENTS LLC 1500 SW 5TH AVE #1602 PORTLAND, OR 97201

REVISIONS

DATE 06/14/2018


PROJECT NUMBER

20166150

3/16" = 1'-0"

SCALE

SHEET TITLE FLOOR PLANS

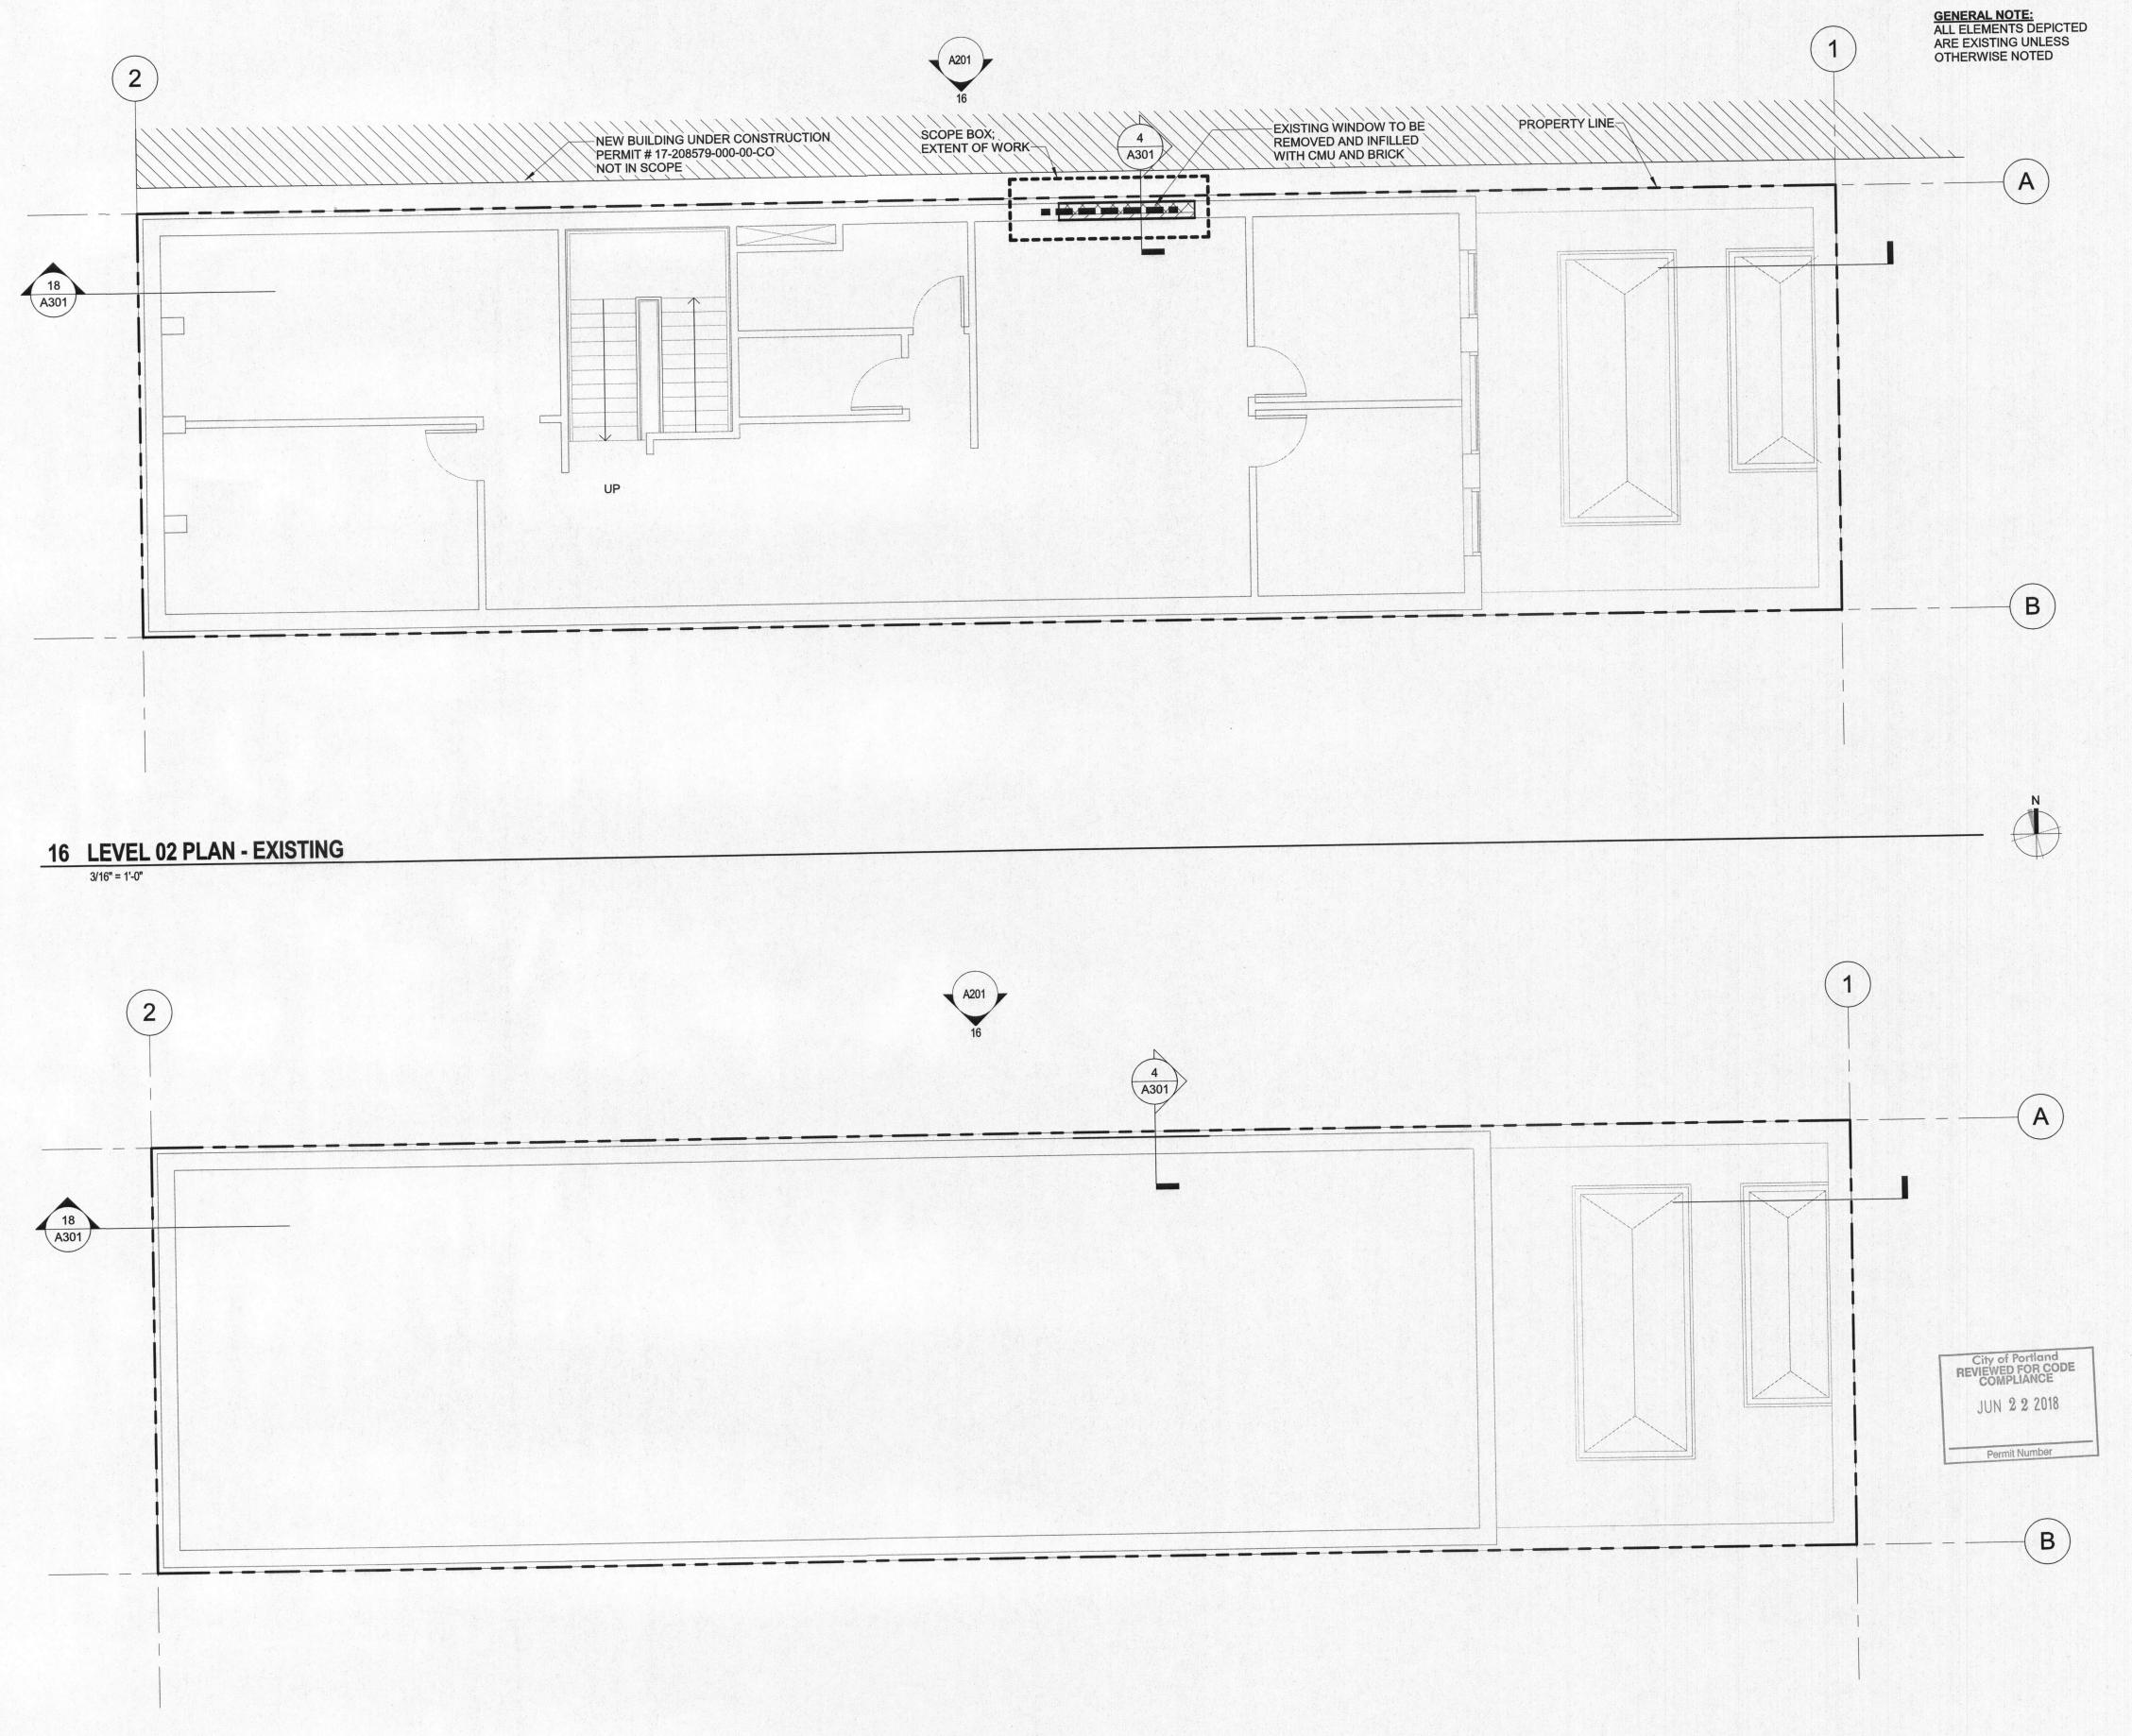

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PROJECT

TRIVET BUILDING 122 SW 3RD AVE PORTLAND, OR 97204

CLIENT

ITM INVESTMENTS LLC 1500 SW 5TH AVE #1602 PORTLAND, OR 97201

DATE 06/14/2018

PROJECT NUMBER

20166150

SCALE 3/16" = 1'-0"

SHEET TITLE FLOOR PLANS

14 ROOF PLAN - EXISTING
3/16" = 1'-0"

GENERAL NOTE:
ALL ELEMENTS DEPICTED
ARE EXISTING UNLESS
OTHERWISE NOTED

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AGUAN ENRIQUEZ V

AGUAN ENRIQUEZ V

PORTLAND, OREGON

5378

OF OREGON

City of Portland Bureau of Development Services By L. Paskins Date 6/21/18
Approved by
Planning and Zoning Review PARAPET 35'-0" PARAPET 35'-0" ROOF 30'-6" ROOF 30'-6" LEVEL 02 16'-0" LEVEL 02 16'-0" JUN 2 2 2018 Permit Number LEVEL 01 INFILL OPENINGS FROM DEMOLISHED EXISTING WINDOWS AT NORTH EXTERIOR WALL WITH NEW CMU CONSTRUCTION SCOPE BOX; EXTENT OF WORK EXISTING BRICK CONSTRUCTION LEVEL B -8'-0" LEVEL B

PROJECT

TRIVET BUILDING

122 SW 3RD AVE PORTLAND, OR 97204

CLIENT

ITM INVESTMENTS LLC 1500 SW 5TH AVE #1602 PORTLAND, OR 97201

REVISIONS

DATE

06/14/2018

PROJECT NUMBER 20166150

3/16" = 1'-0"

SHEET TITLE

EXTERIOR ELEVATIONS

A201

16 NORTH ELEVATION 3/16" = 1'-0"

