
LEWIS & CLARK COLLEGE - OUTFALL 10 REPAIR

PORTLAND, OREGON

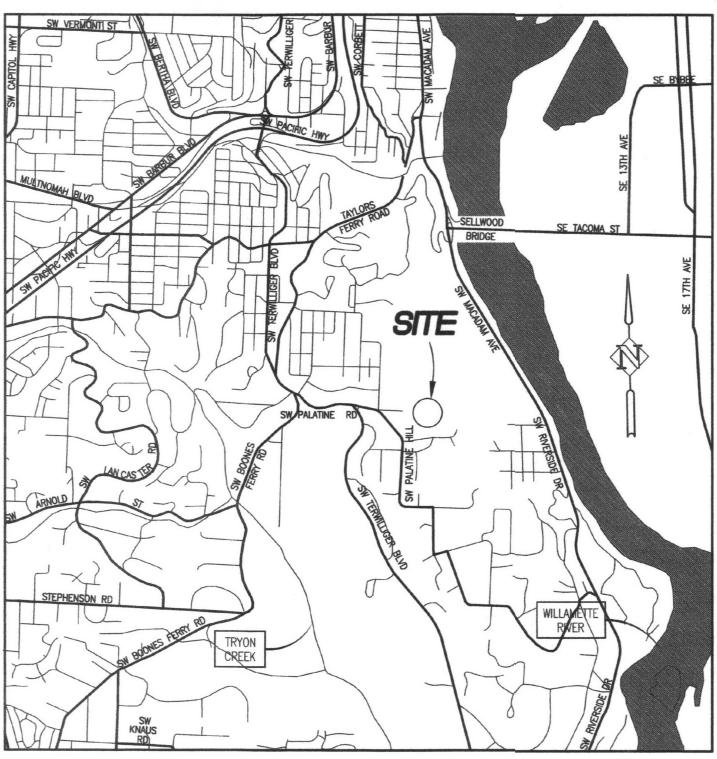

VICINITY MAP

OWNER

LEWIS AND CLARK COLLEGE 0615 SW PALATINE HILL RD PORTLAND, OREGON 97219-7899 CONTACT: CLARK IDE, PE 503-768-7978

PROJECT LOCATION

LEWIS AND CLARK COLLEGE 0615 SW PALATINE HILL RD PORTLAND, OREGON 97219-7899 MULTNOMAH COUNTY LATITUDE = $45^{\circ} 27' 3.3''$ LONGITUDE = 122' 40' 2.5"

TAX LOT NUMBER: TL100 LOCATED IN SECTION 27, TOWNSHIP 1 SOUTH, RANGE 1 EAST, WILLAMETTE MERIDIAN, MULTNOMAH COUNTY, OREGON

ENGINEER & LANDSCAPE

HARPER HOUF PETERSON RIGHELLIS INC. 205 SE SPOKANE ST. SUITE 200 PORTLAND, OREGON 97202 (503) 221-1131 CONTACT: RON PETERSON, PE SCOTT BANKER, RLA

GEOTECHNICAL ENGINEER

GEODESIGN, INC. 15575 SW SEQUOIA PARKWAY PORTLAND, OREGON 97224 503-968-8787 CONTACT: ERIC STALEY, PE, CEG

PLANTING PLAN PLANTING DETAILS STRUCTURAL PLAN AND DETAILS

COVER SHEET

EXISTING CONDITIONS PLAN

CONSTRUCTION DETAILS

CHANNEL RESTORATION PLAN & PROFILE

DRAWING INDEX

SHEET NO.



GRANULAR FILL = 95% MIN. (ASTM D 698) MAX. LIFT 12" TRENCH BACKFILL = 95% MIN. (ASTM D 698) TOP 8" OF PAVEMENT SUBGRADE = 98% MIN. (ASTM D 698) ASPHALT CONCRETE = 95% MIN. (ASTM D 2041)

ALL EXCESS MATERIAL INCLUDING BOULDERS SHALL BE HAULED OFF SITE UNLESS AGREED TO BY OWNER AND COORDINATED WITH FACILITIES STAFF. CONTRACTOR SHALL BE RESPONSIBLE TO HAUL OFF TO LEGAL DUMP SITE AND OBTAIN ALL NECESSARY PERMITS.

EROSION CONTROL NOTES

TEMPORARY EROSION CONTROL:

THE CONSTRUCTION NOTES AND DETAILS SHOWN REFLECT RECOMMENDED PROCEDURES AS PER THE CITY OF PORTLAND EROSION CONTROL MANUAL, LATEST VERSION.

IT IS THE INTENT OF THESE PLANS TO SHOW POSSIBLE APPLICATIONS OF RECOMMENDED PROCEDURES IN THE EVENT THAT EROSION CONTROL IS NEEDED. ALL RECOMMENDED PROCEDURES ARE DEPENDENT ON CONSTRUCTION METHODS, STAGING, SITE CONDITIONS, WEATHER, AND SCHEDULING. THE PROCEDURES SHOWN ON THE PLANS ARE NOT INTENDED TO BE INCLUSIVE OF ALL THE PROTECTION REQUIRED IN AN AREA AT A PARTICULAR INSTANT. THEY SHOULD BE USED AS A GUIDELINE ONLY.

ALTERNATIVE METHODS OF EROSION CONTROL MAY BE USED IF THEY ARE APPROVED BY THE ENGINEER AND MEET THE S.C.S. UNIVERSAL SOIL LOSS EQUATION CRITERIA.

THE CONTRACTOR IS RESPONSIBLE FOR CONTROL OF SEDIMENT TRANSPORT WITHIN PROJECT LIMITS DURING CONSTRUCTION. IF AN INSTALLED EROSION CONTROL SYSTEM DOES NOT ADEQUATELY CONTAIN SEDIMENT ON SITE, THEN THE EROSION CONTROL MEASURES MUST BE FIELD ADJUSTED BY THE CONTRACTOR AS NECESSARY.

PERMANENT EROSION CONTROL:


TEMPORARY EROSION CONTROL METHODS MUST REMAIN AND BE MAINTAINED UNTIL PERMANENT EROSION CONTROL METHODS ARE IN PLACE AND OPERATIONAL. VEGETATION ON ALL EMBANKMENTS AND DISTURBED AREAS SHOULD BE REESTABLISHED AS SOON AS CONSTRUCTION IS COMPLETED. ADDITIONAL INTERIM MEASURES WILL INCLUDE, AT A MINIMUM, INSTALLATION OF STRAW WATTLES OR SILT FENCES


AS PER PLAN AND DETAIL SHEET. THESE MEASURES WILL BE INSTALLED ALONG ALL EXPOSED EMBANKMENT AND CUT SLOPES TO PREVENT SEDIMENT TRANSPORT.


EFFECTIVE EROSION CONTROL IS REQUIRED. EROSION CONTROL DEVICES MUST BE INSTALLED AND MAINTAINED. THE COUNTY MAY AT ANY TIME ORDER CORRECTIVE ACTION AND STOPPAGE OF WORK TO ACCOMPLISH EFFECTIVE EROSION CONTROL.

ALL PROVISIONS FOR EROSION CONTROL SHALL BE INSTALLED, INSPECTED, AND APPROVED PRIOR TO PRIMARY EXCAVATION OCCURRING. CONTACT CITY OF PORTLAND, BUREAU PLANNING AND DEVELOPMENT SERVICES AT (503) 823-7000 FOR INSPECTIONS. FINAL INSPECTION IS REQUIRED AND MUST BE SCHEDULED BY THE CONTRACTOR.

COLLEGE ARK

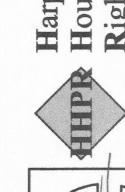

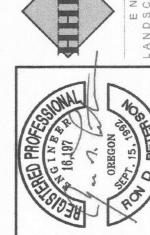

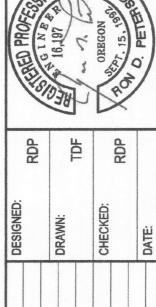




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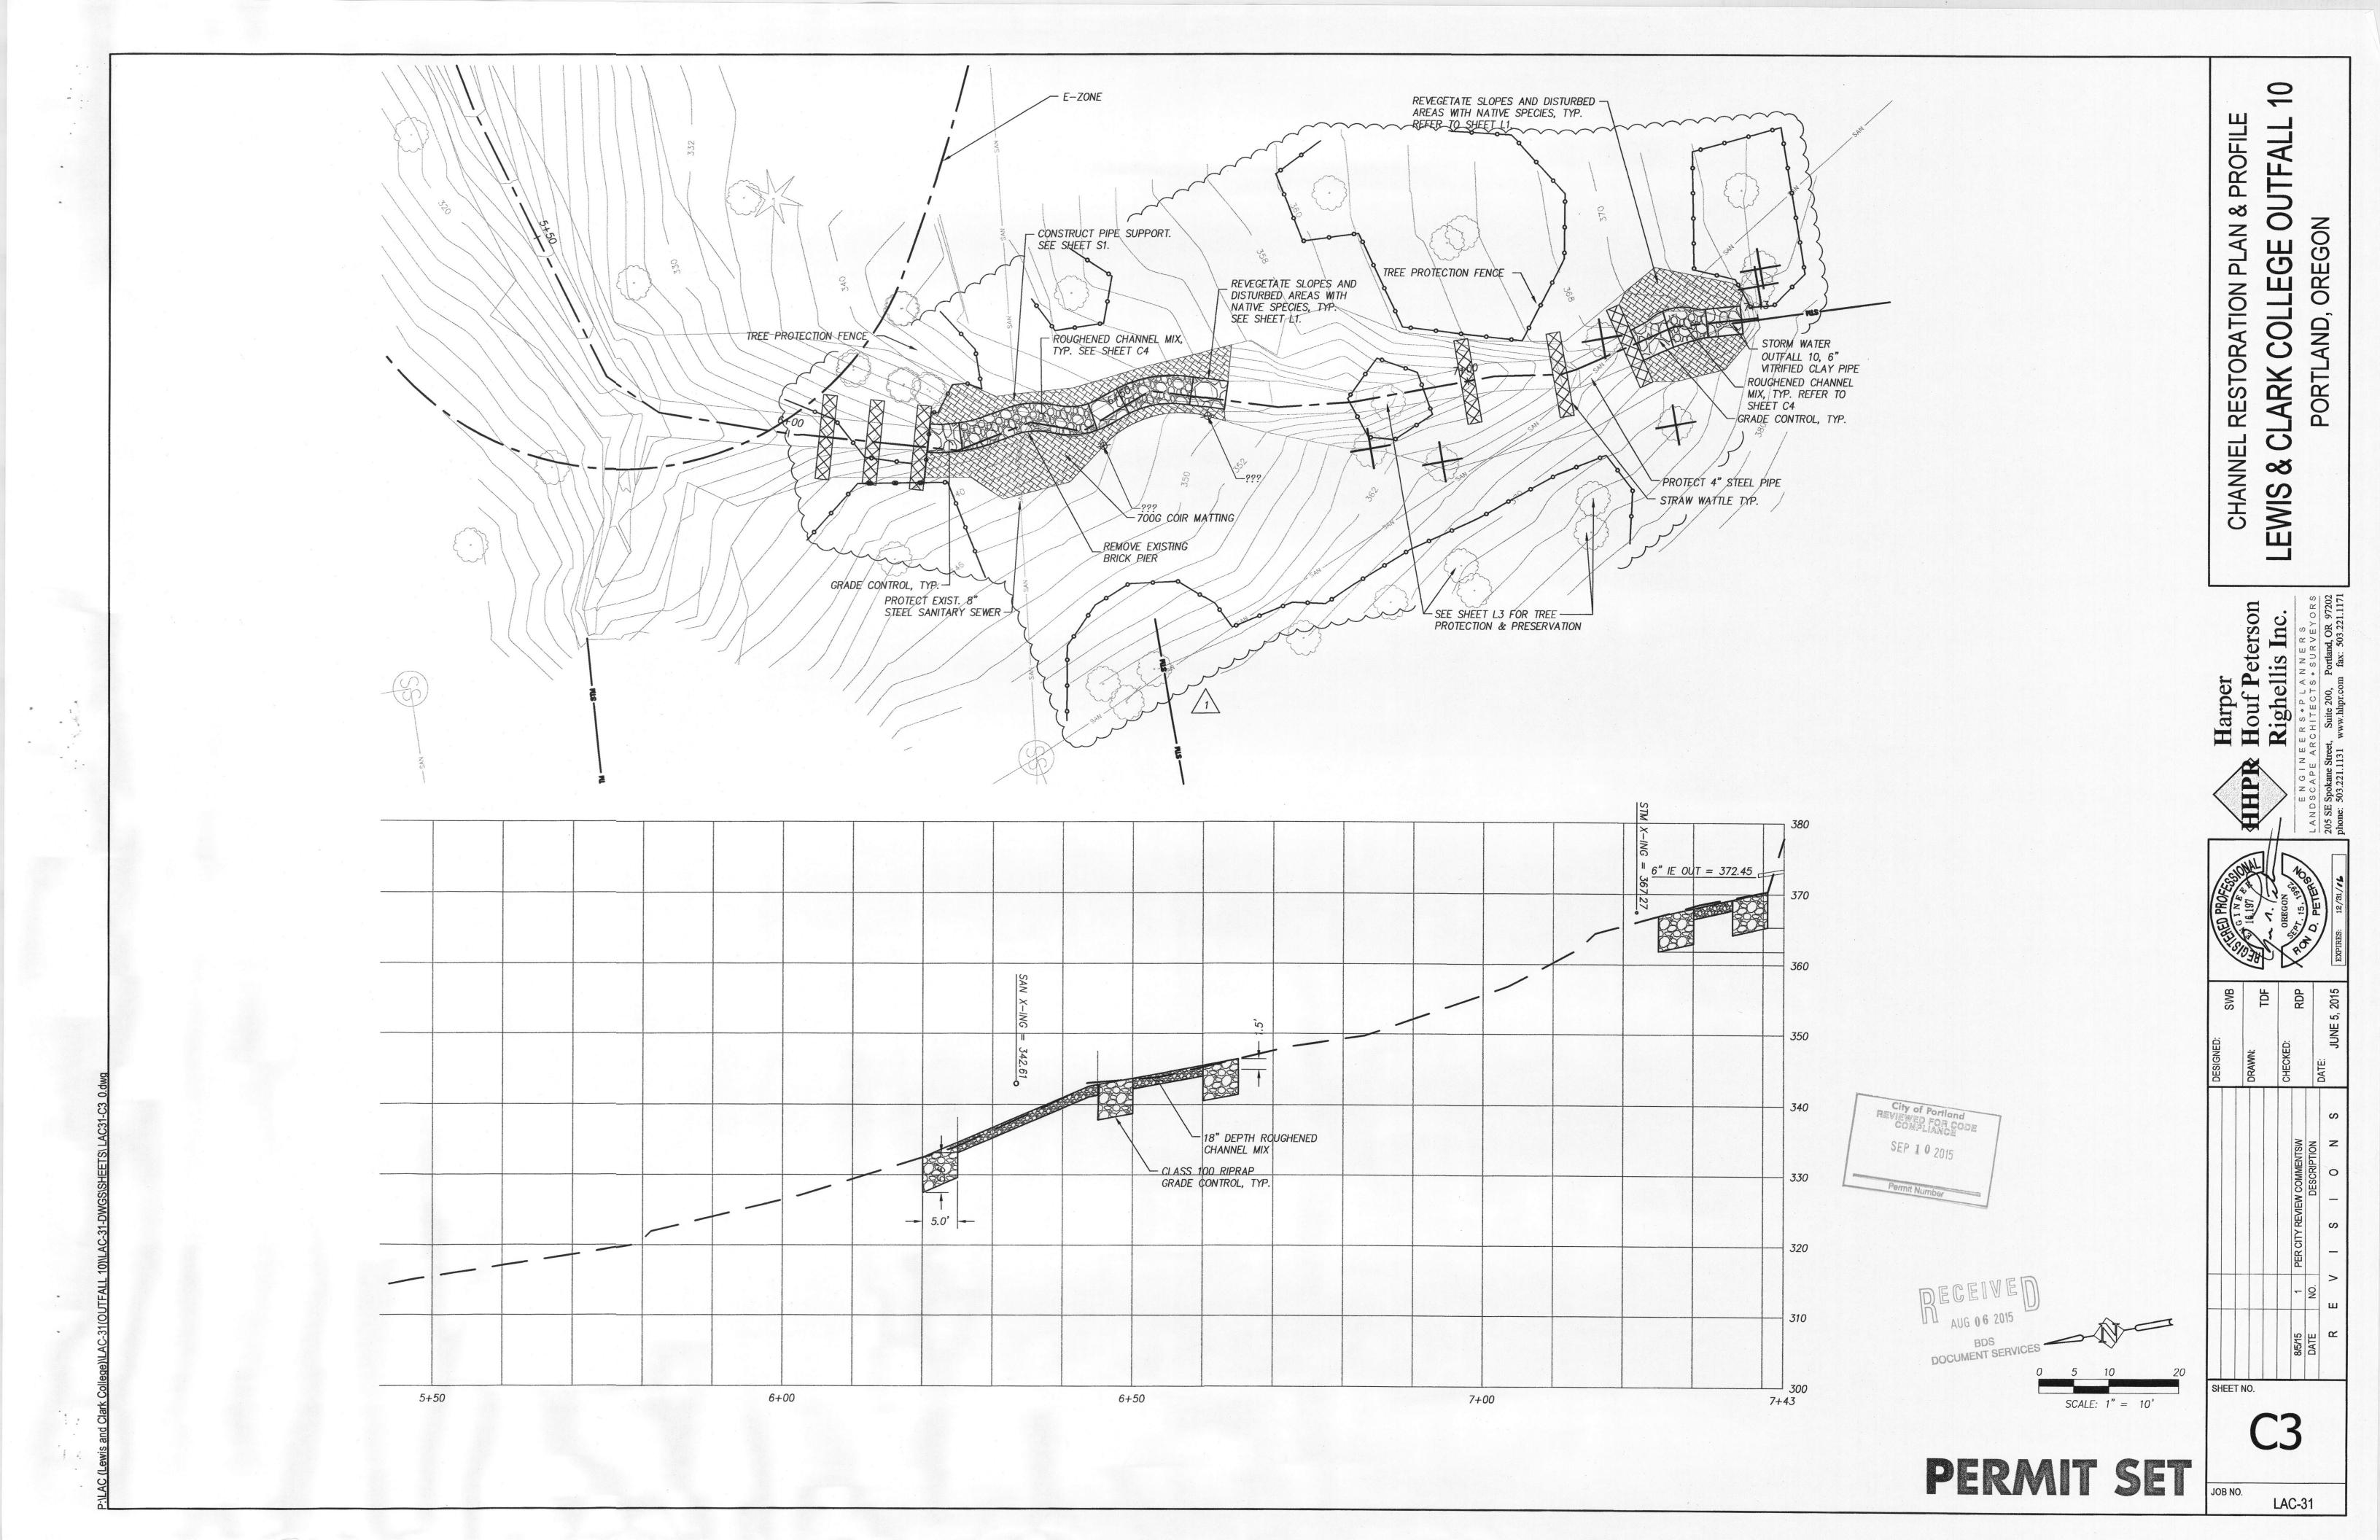
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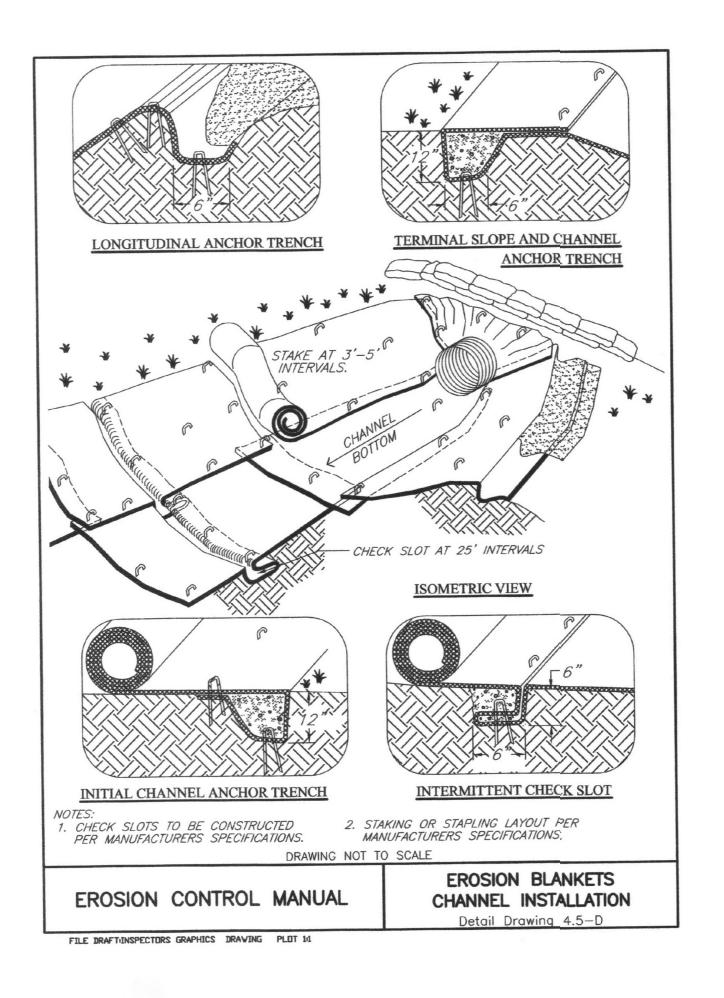



10 OUTFALL CONDITIONS PLAN OREGON COLLEGE ARK PORTL **EXISTING** ∞ŏ LEWIS


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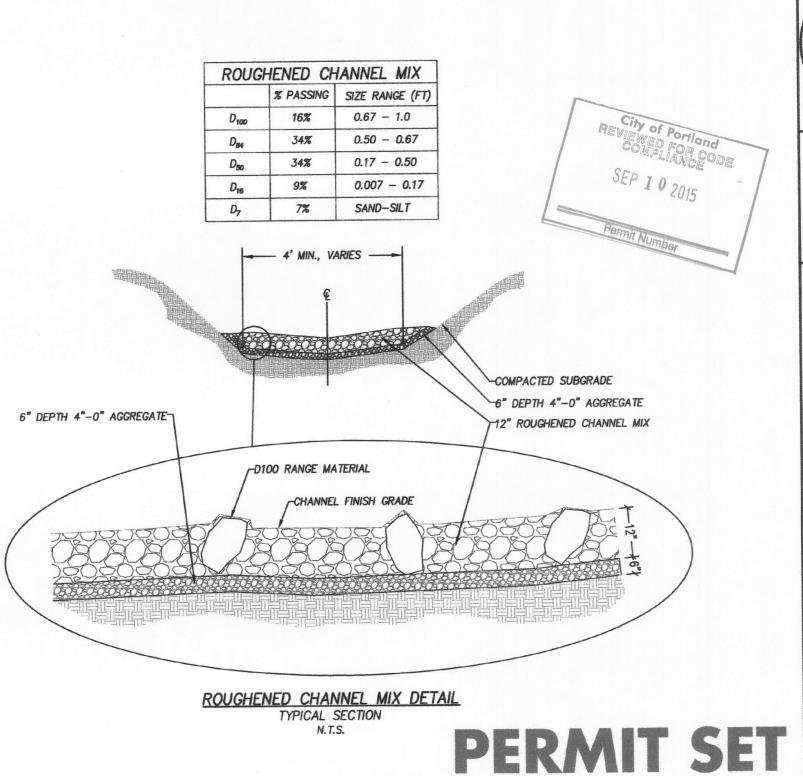
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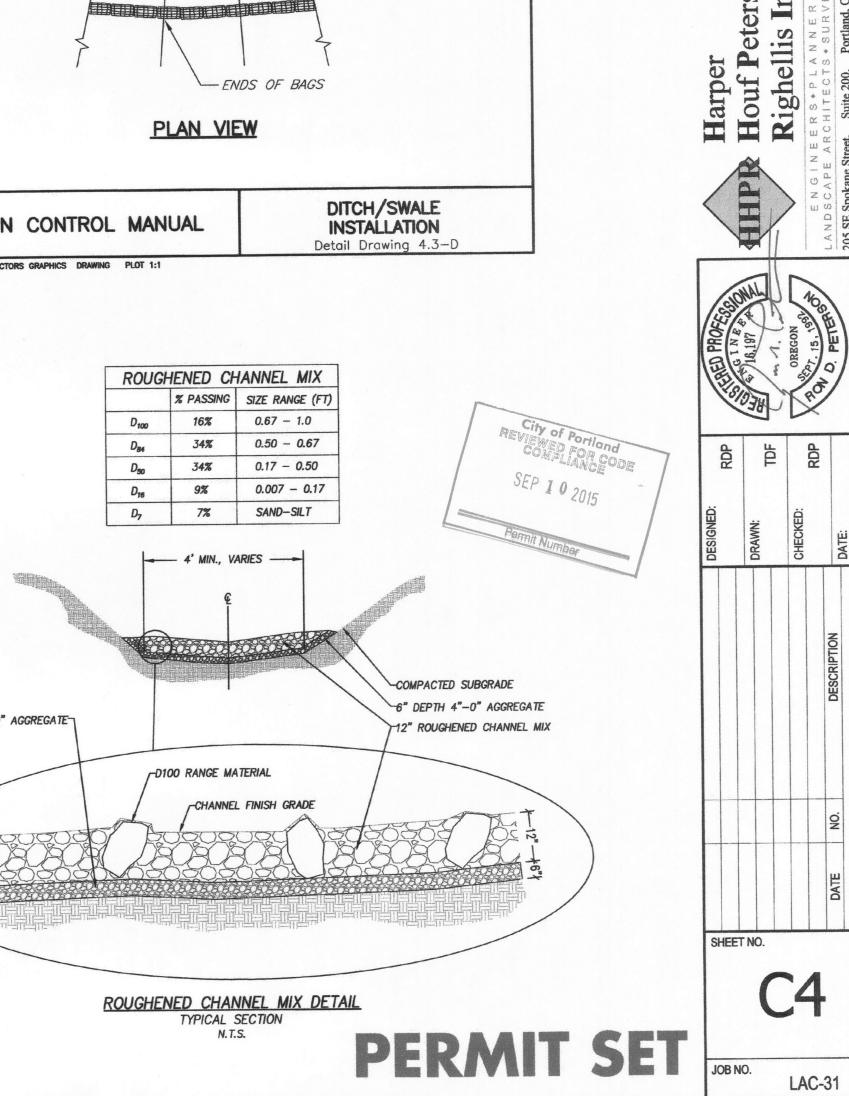


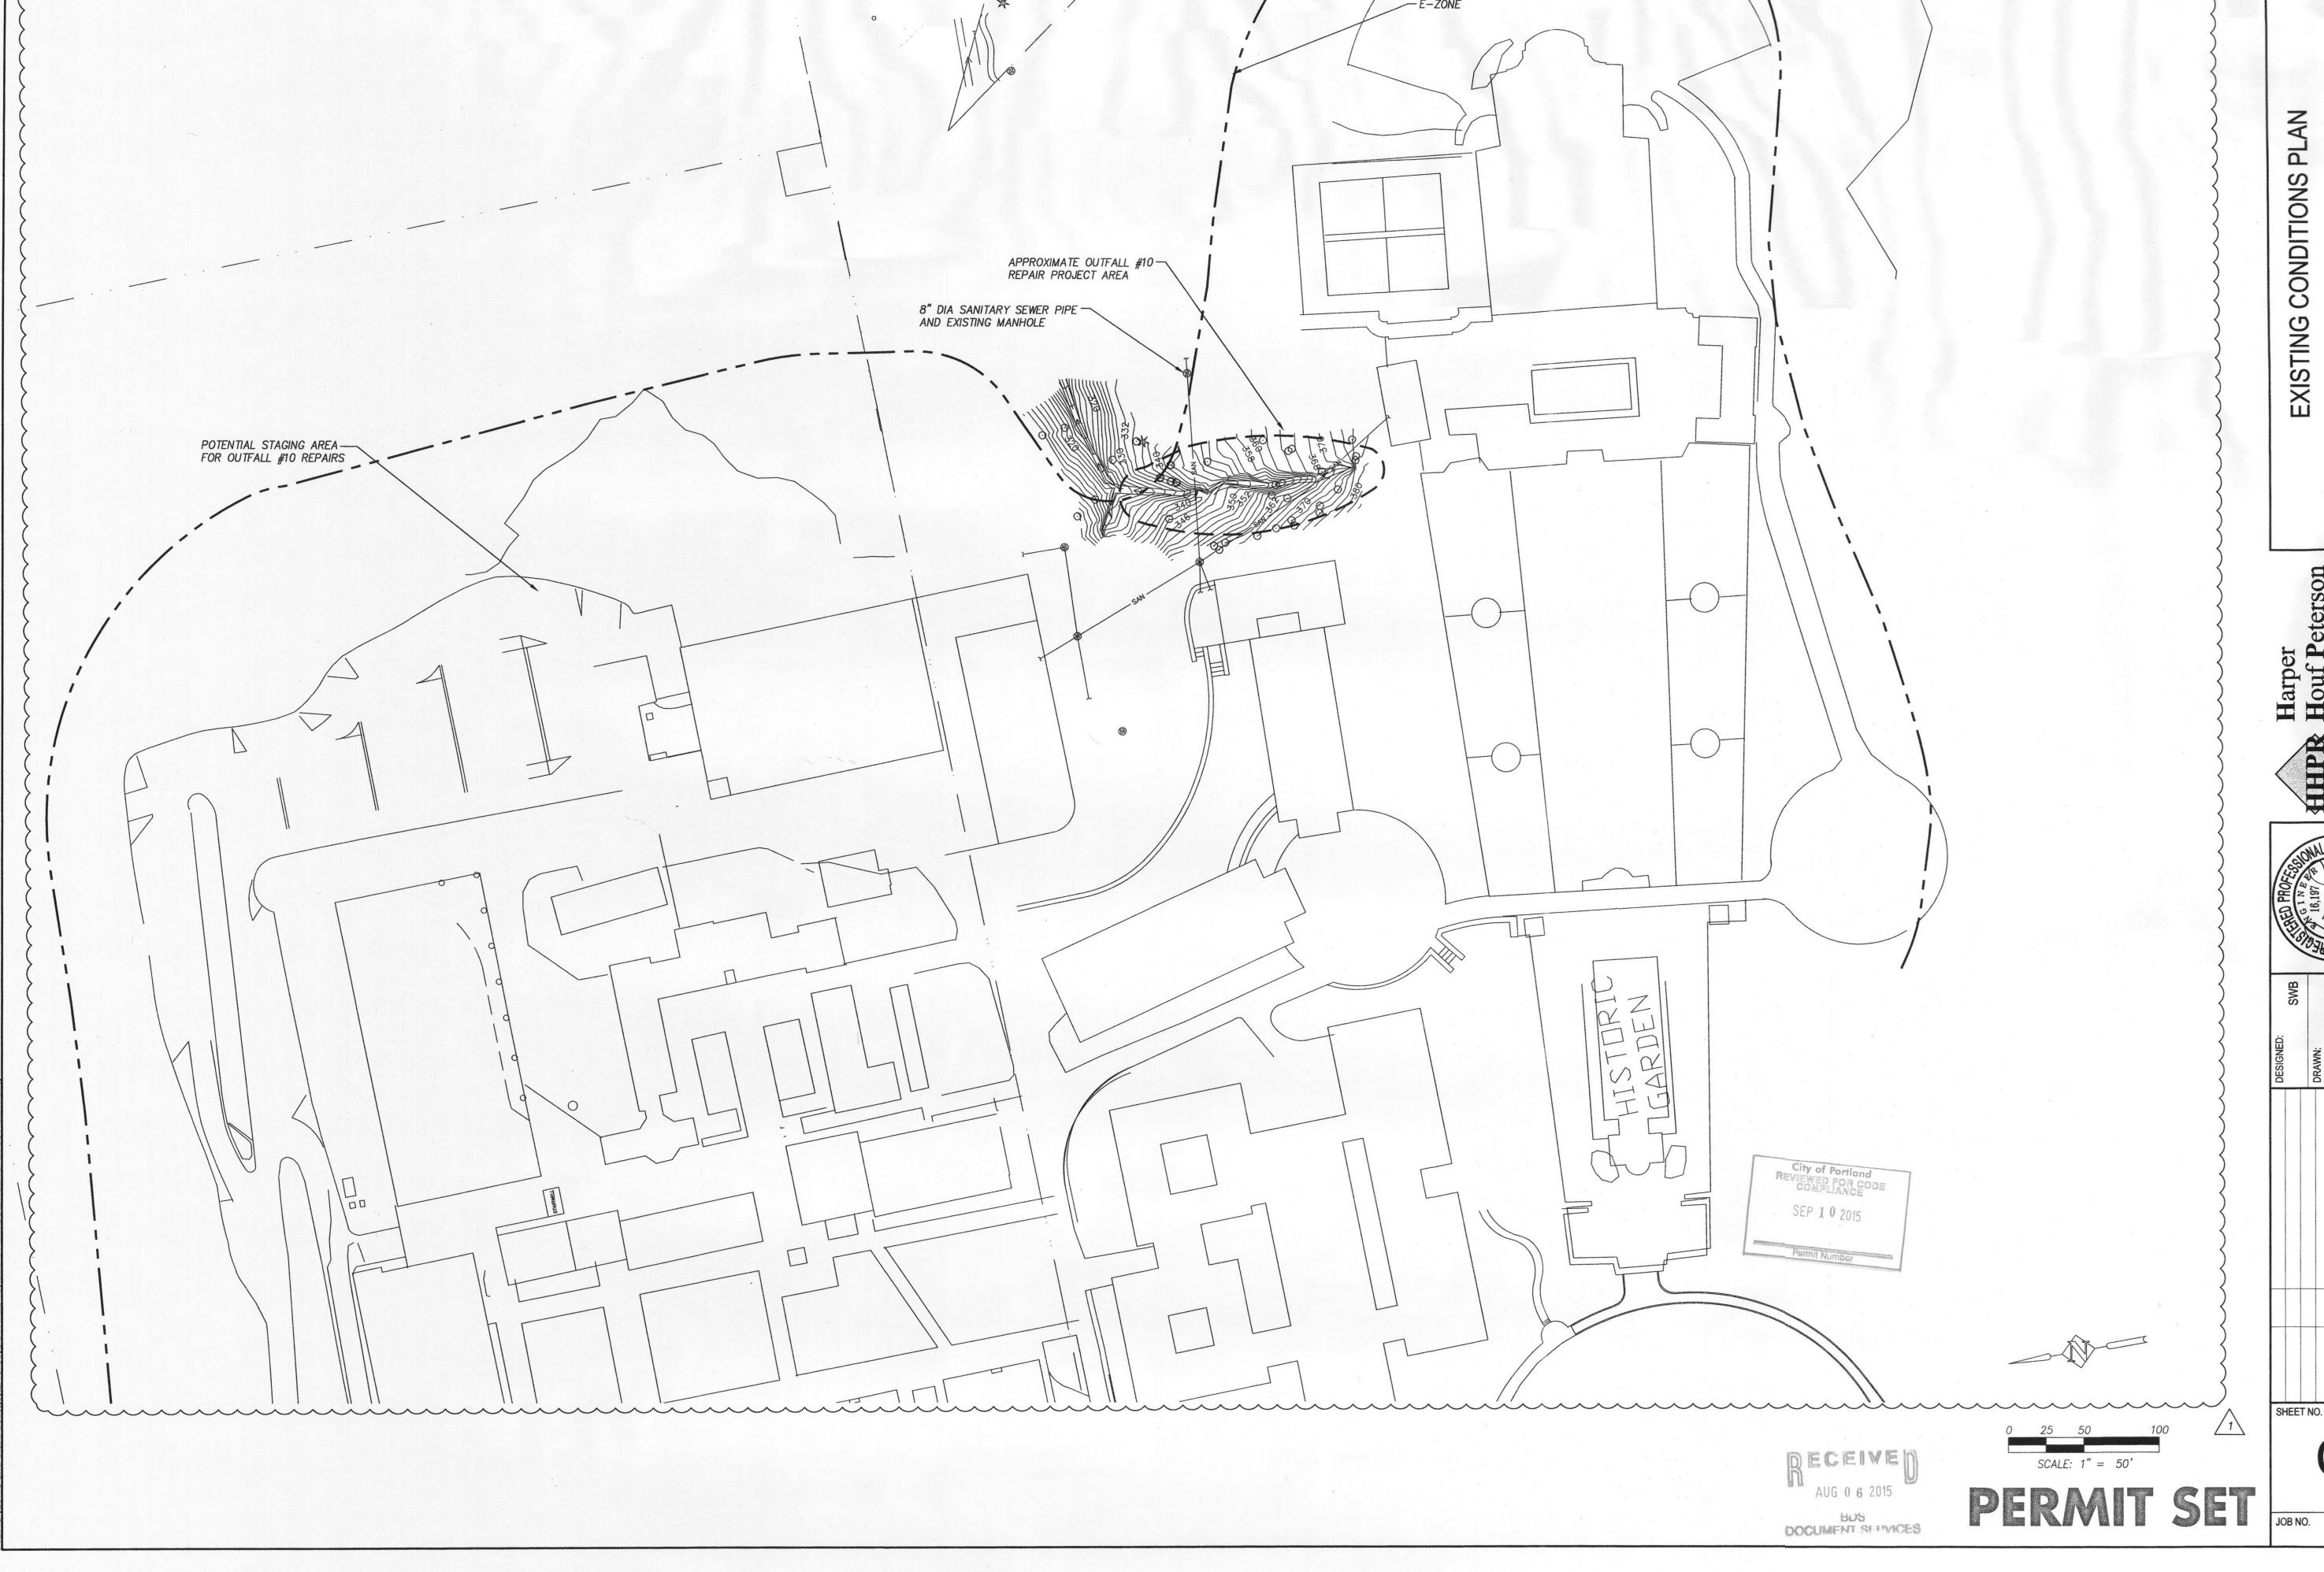





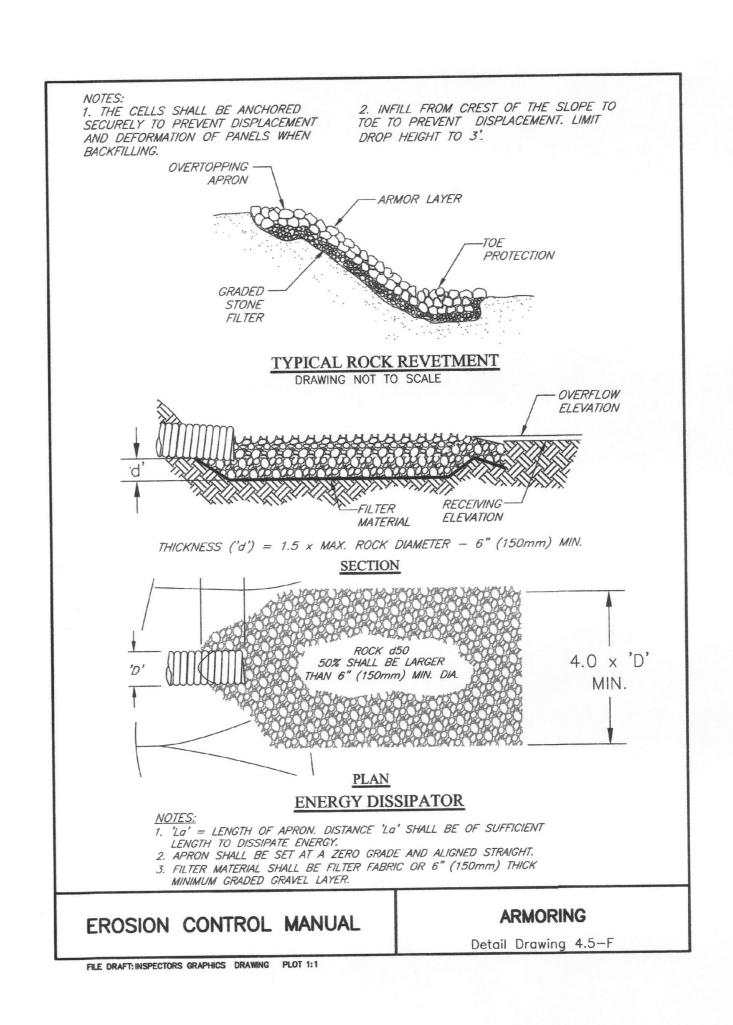

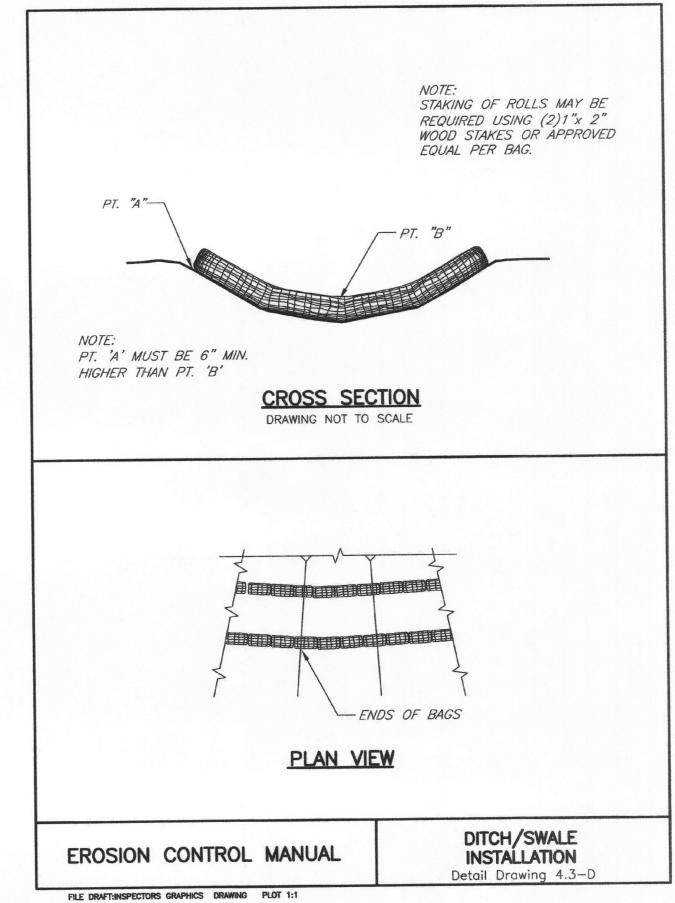

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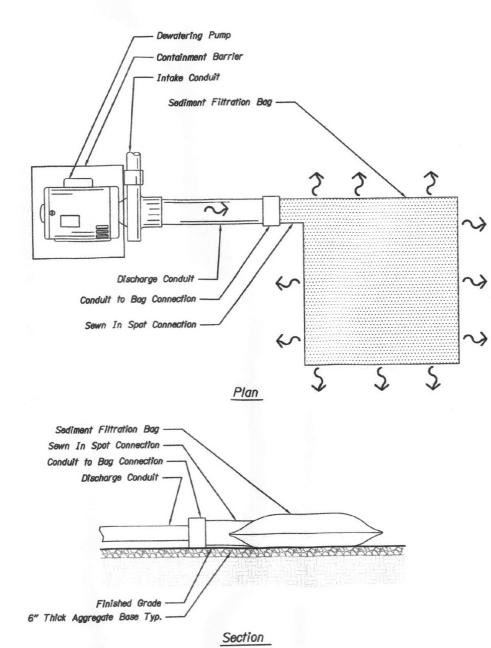
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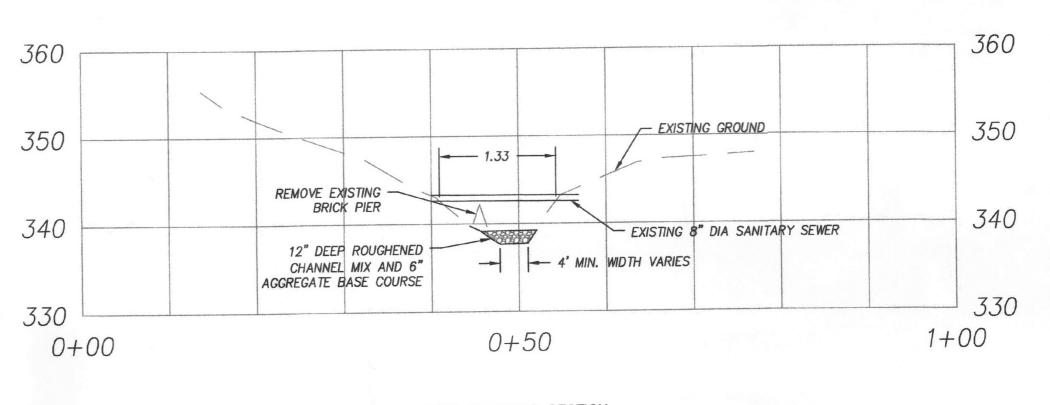
DETAIL

CONSTRUCTION



SEDIMENT FILTRATION DEVICE

N.T.S.



PIPE CROSSING SECTION Scale: 1" = 10' (H & V)




10 OUTFALL OREGON COLLEGE PORTLAND, CLARK **ං**ර **LEWIS**

Scott W. Banker
Scott W. Banker
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NOT TO SCALE

LEWIS & CLARK COLLEGE OUTFALL 10
PORTLAND, OREGON

Harper
Houf Peterson
Righellis Inc.

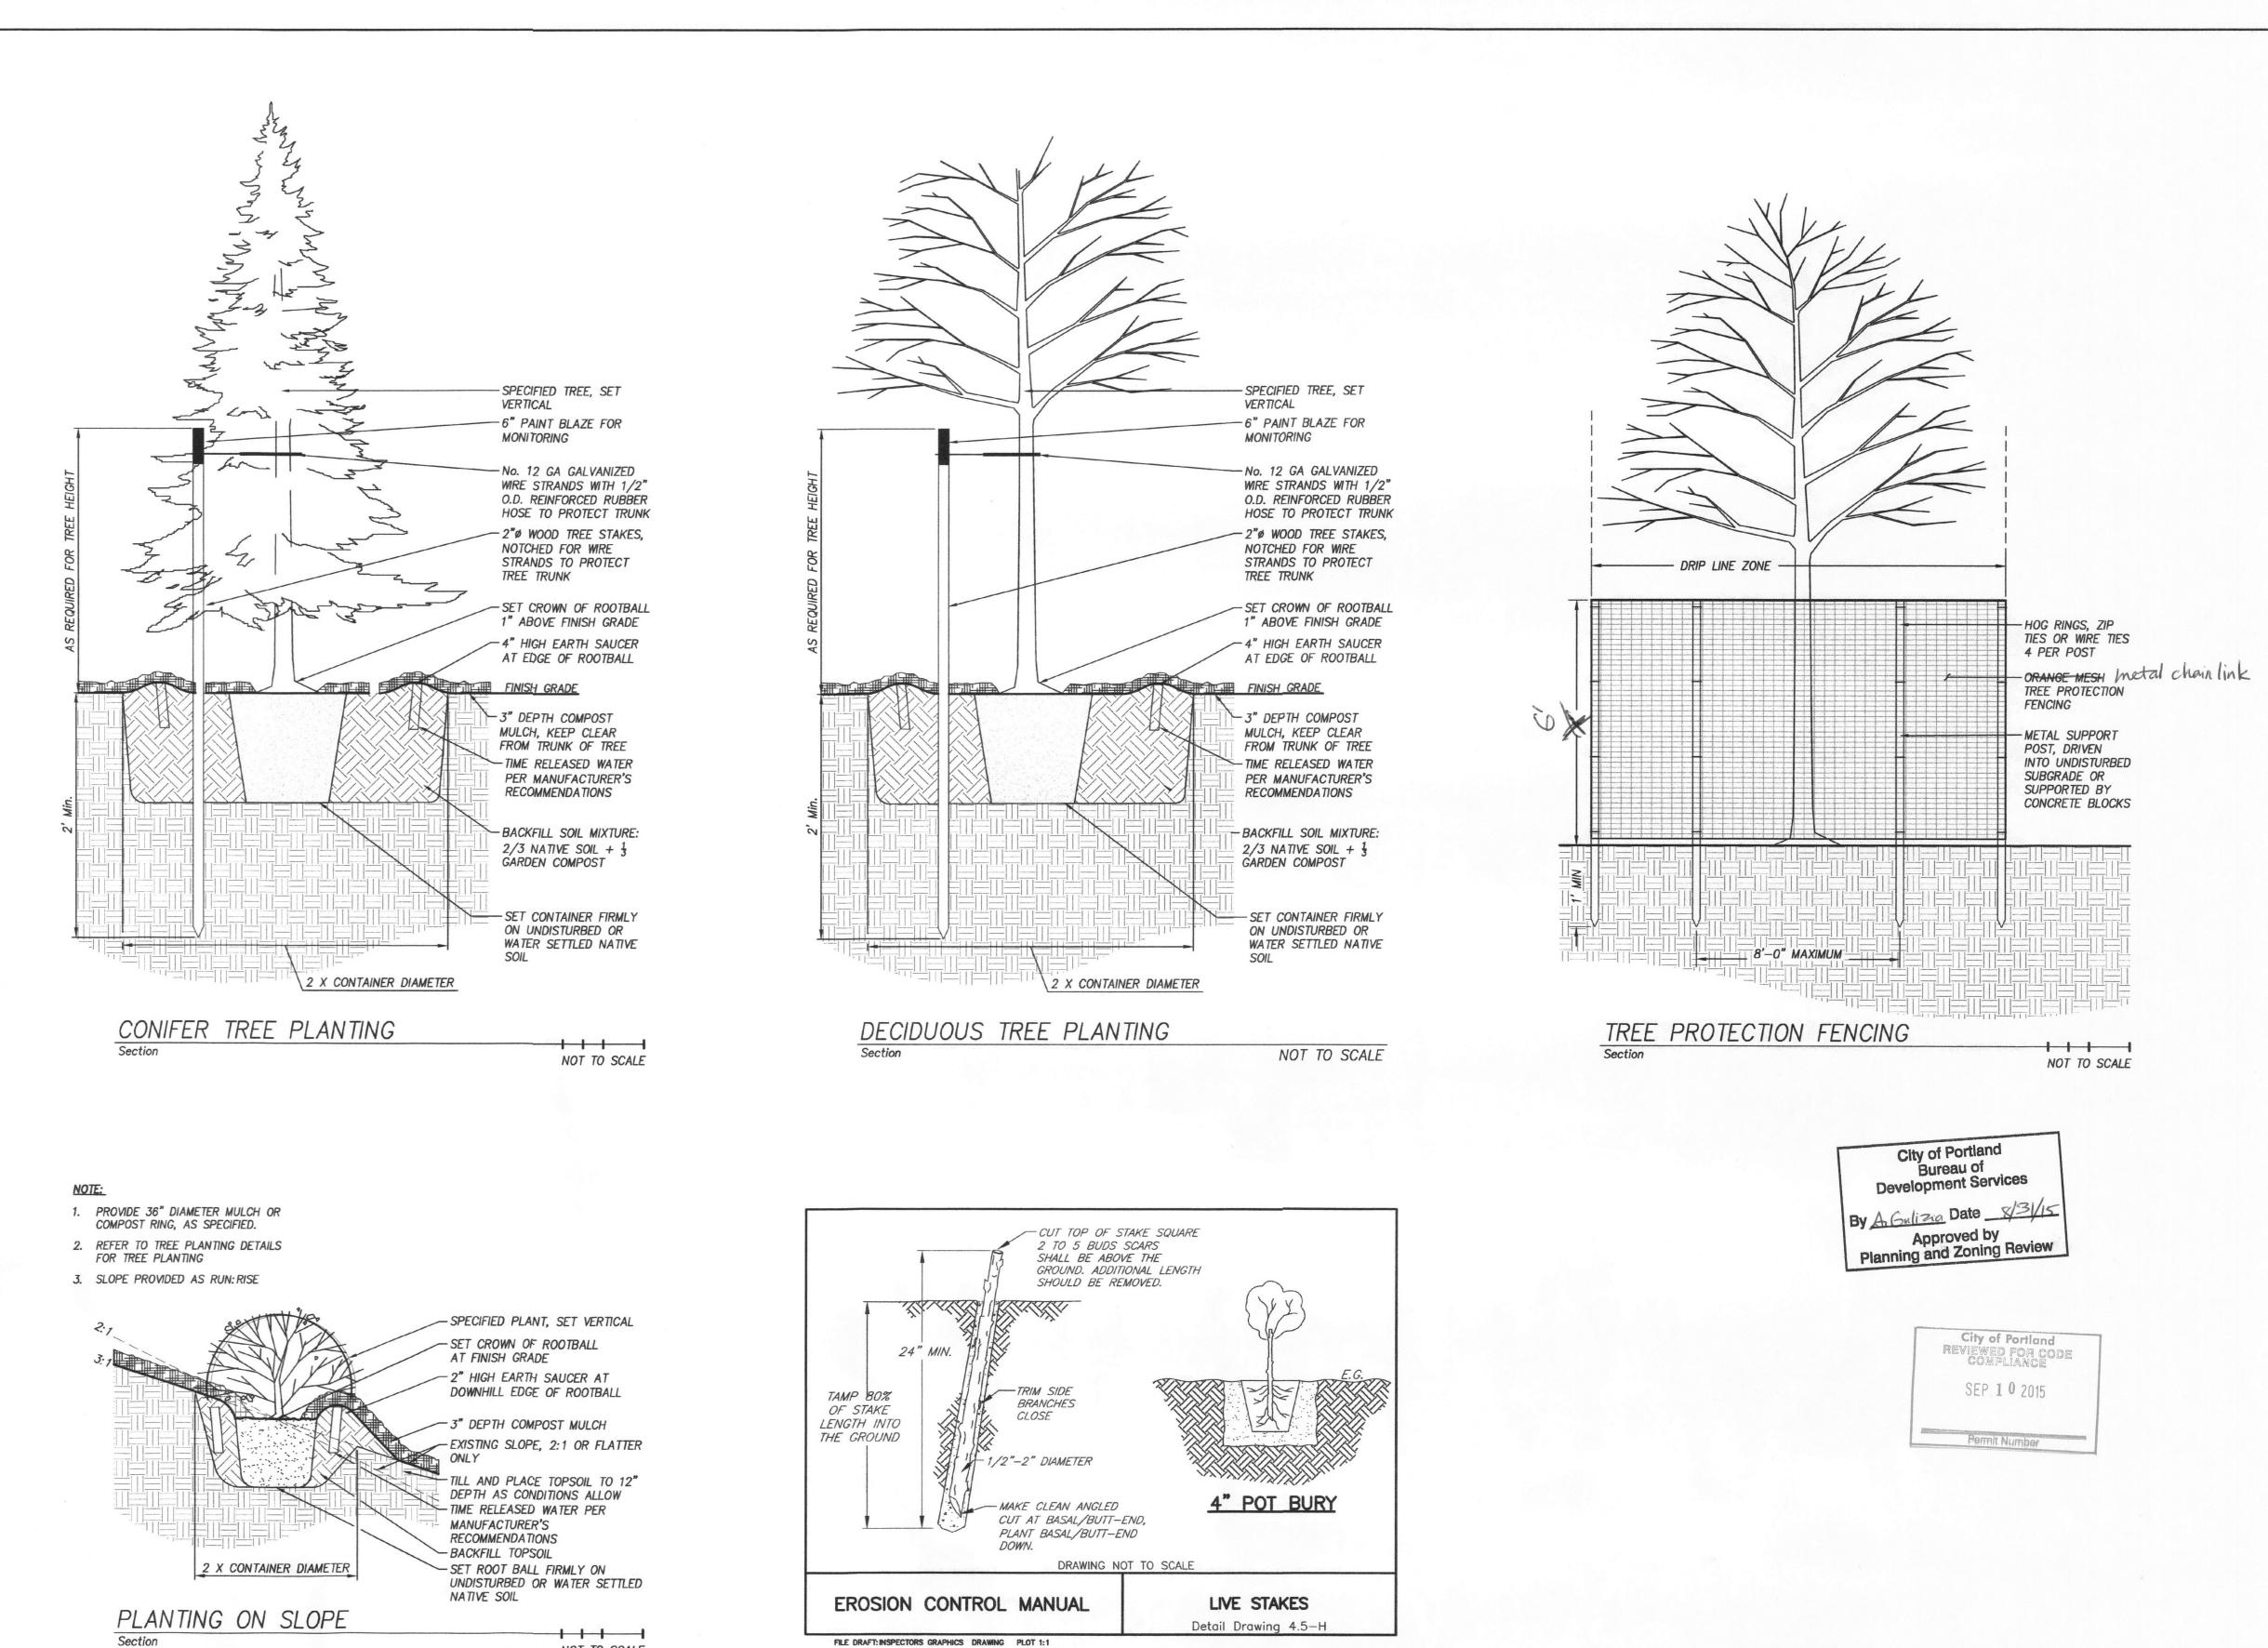WED: SWB ALEGA STERES.

TOF Scott W. Bankel Canal Scott W. Bankel

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REVISOR 1 O N S MAY 1, 2015


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— CONSTRUCTION LIMITS OF IMPACTS STAGING AREA

> EXISTING TREE TO BE REMOVED SEE DETAIL SHT. L2

NOTE: SEE THIS PLAN AND SHT. C3 FOR LIMITS OF CONSTRUCTION IMPACT.

#	TYPE	QUANITY	SIZE	CONDITION
1	DECIDUOUS	1	14"	PRESERVE
2	DECIDUOUS	1	22"	PRESERVE
3	EVERGREEN	1	48"	PRESERVE
4	DECIDUOUS	1	16"	PRESERVE
5	DECIDUOUS	1	16"	PRESERVE
6	DECIDUOUS	1	20"	PRESERVE
7	DECIDUOUS	1	22"	PRESERVE
8	DECIDUOUS	1	20"	PRESERVE
9	DECIDUOUS	1	22"	PRESERVE
10	DECIDUOUS	1	12"	PRESERVE
11	DECIDUOUS	1	10"	PRESERVE
12	DECIDUOUS	1	22"	PRESERVE
13	DECIDUOUS	1	10"	PRESERVE
14	DECIDUOUS	1	12"	PRESERVE
15	DECIDUOUS	1	10"	PRESERVE
16	DECIDUOUS	1	28"	PRESERVE
17	DECIDUOUS	1	14"	PRESERVE
18	DECIDUOUS	1	10"	REMOVE
19	DECIDUOUS	1	16"	REMOVE
20	DECIDUOUS	1	12"	REMOVE .
21	DECIDUOUS	1	10"	REMOVE
22	DECIDUOUS	1	6"	PRESERVE
23	DECIDUOUS	1	6"	PRESERVE
24	DECIDUOUS	1	10"	PRESERVE
25	DECIDUOUS	1	10"	PRESERVE
26	DECIDUOUS	1	. 8"	PRESERVE
27	DECIDUOUS	1	8"	REMOVE
28	DECIDUOUS	1	14	REMOVE -
29	DECIDUOUS	1	8"	REMOVE
30	DECIDUOUS	1	24"	PRESERVE
31	DECIDUOUS	1	24"	PRESERVE
32	DECIDUOUS	1	16	PRESERVE
33	DECIDUOUS	3	10"	PRESERVE

NOTE:
1) 20 TREES 12" DIA+

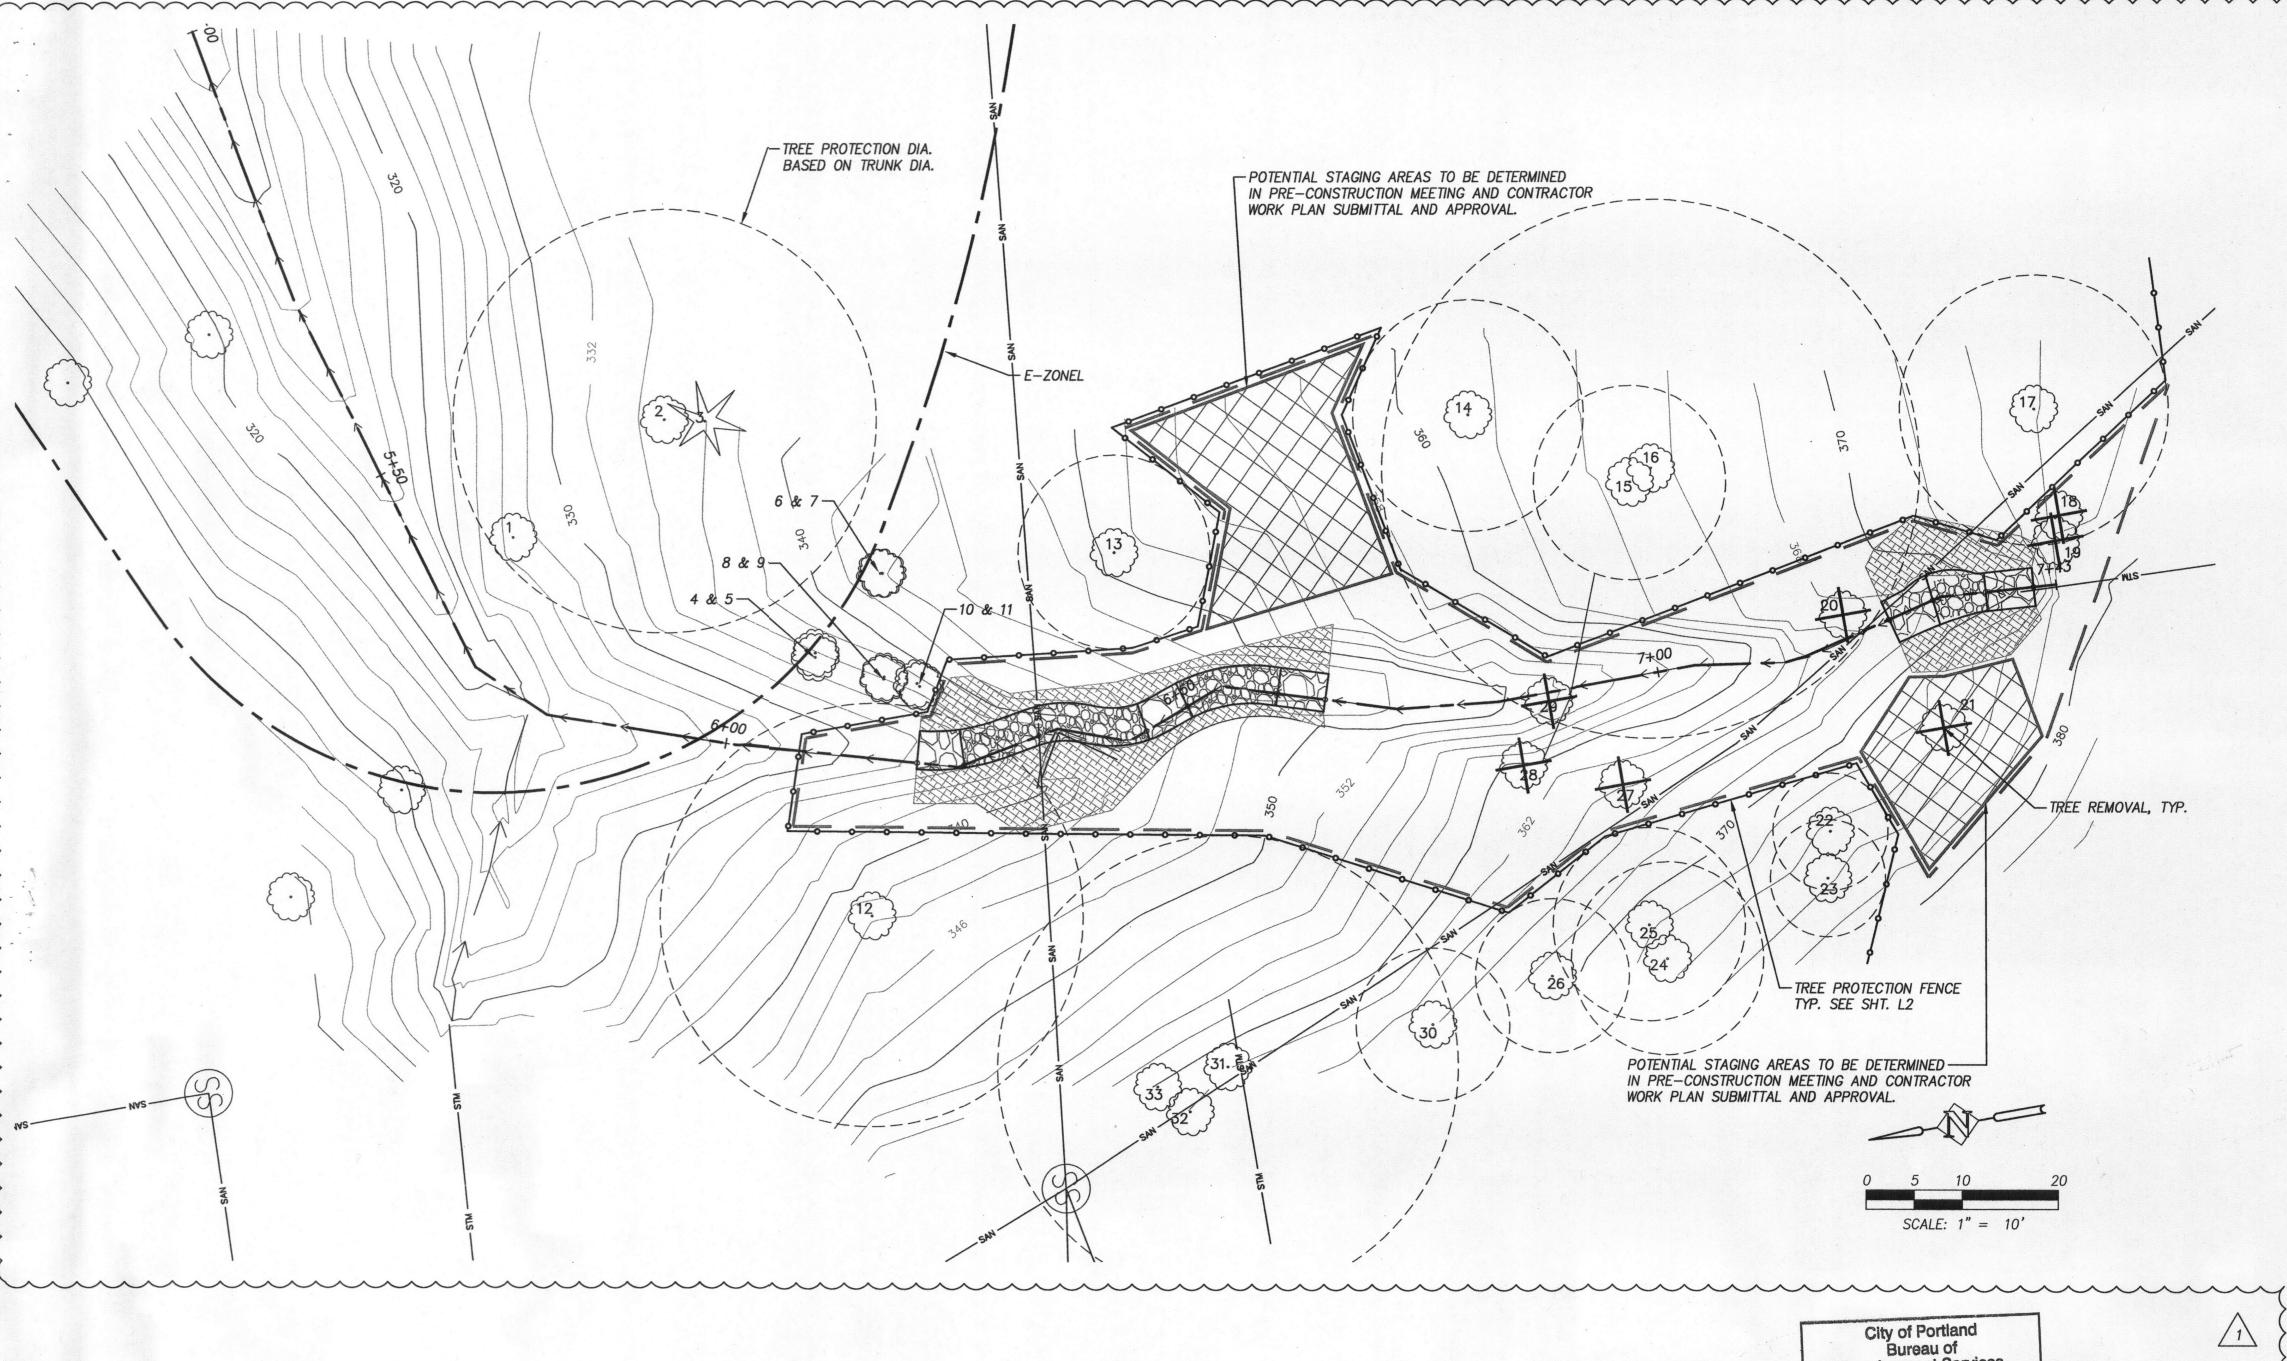2) 3 TREES 12" DIA+ TO BE REMOVED, 6 TOTAL TREES. 3) $\frac{1}{3}$ OF 20 TREES = 6.7 TREES, MUST BE PROTECTED.

DOCUMENT SERVICES

AUG 2 5 2015

Development Services By A Gulizia Date 8/31/15 Approved by Planning and Zoning Review

TREE PROTECTION REQUIRED

REQUIRED SIGN & TREE PROTECTION FENCING MUST BE INSPECTED BEFORE ANY GROUND DISTURBANCE. SEE ATTACHED SHEET FOR MORE INFORMATION ON REGULATIONS.

ROOT PROTECTION ZONE: PERFORMANCE PRESCRIPTIVE

City of Portland REVIEWED FOR CODE COMPLIANCE SEP 1 0 2015

Permit Number

GENERAL NOTES

- 1. ALL TREES 6" IN DIAMETER AND LARGER IN THE CONSTRUCTION ZONE HAVE BEEN SURVEYED AND SHOWN IN TOPOGRAPHIC MAPPING.
- CONTRACTOR IS RESPONSIBLE TO PROTECT TREES AS SHOWN AND AS NEEDED BASED ON SITE CONDITIONS, WITH TREE PROTECTION FENCE AS SHOWN THROUGHOUT CONSTRUCTION. SEE DETAIL SHEET L2.
- TREE PROTECTION FENCE SHALL LOCATED THE SAME NUMBER OF FEET FROM THE TRUNK AS TRUNK DIAMETER IN INCHES MINIMUM, OR AT THE DRIP LINE, WHICHEVER IS LARGER.
- CONSTRUCTION STAGING TO TAKE PLACE IN AREA AS SHOWN AND OUTSIDE THE DRIP ZONE OF EXISTING TREES IF ADDITIONAL SPACE IS REQUIRED. NO MATERIALS, EQUIPMENT, FUELS, OR FLUIDS SHALL BE STORED INSIDE THE DRIP ZONE OF EXISTING TREES.
- ANY TREE BRANCHES DAMAGED DURING CONSTRUCTION SHALL BE CUT OFF CLEANLY BEHIND THE DAMAGED AREA AND LEFT ON THE GROUND IN THE WORK ZONE AFTER CONSTRUCTION IS COMPLETED.

PERMIT SET

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Scott W. Banker

Scott W. Banker

A O R E G O N R

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SHEET NO.

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