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1360 Walnut, Suite 102 Boulder, Colorado 803 P: 720.565.0505



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Dallas, Texas 75225

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Type III Review	09.15.2017
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LLOYD CENTER LLOYD CENTER EAST

TYPE III LAND USE APPLICATION

1260 LLOYD CENTER PORTLAND, OREGON 97232

EA-17-127273

PROJECT NUMBER: CY1704

Title:
COVER PAGE



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**EAST MALL ENTRY** 

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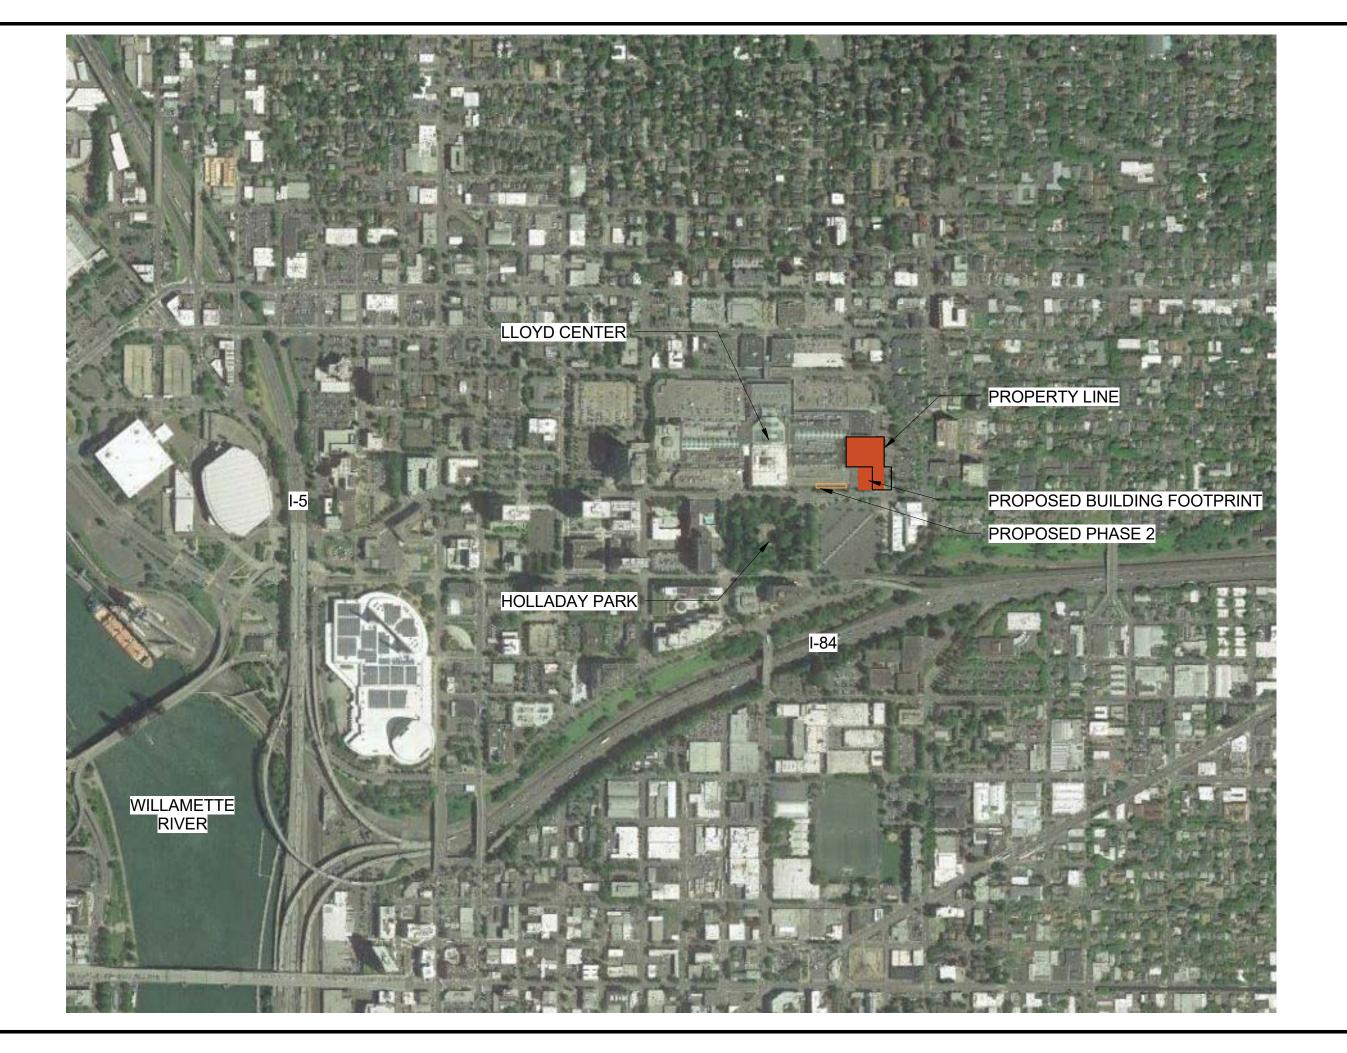
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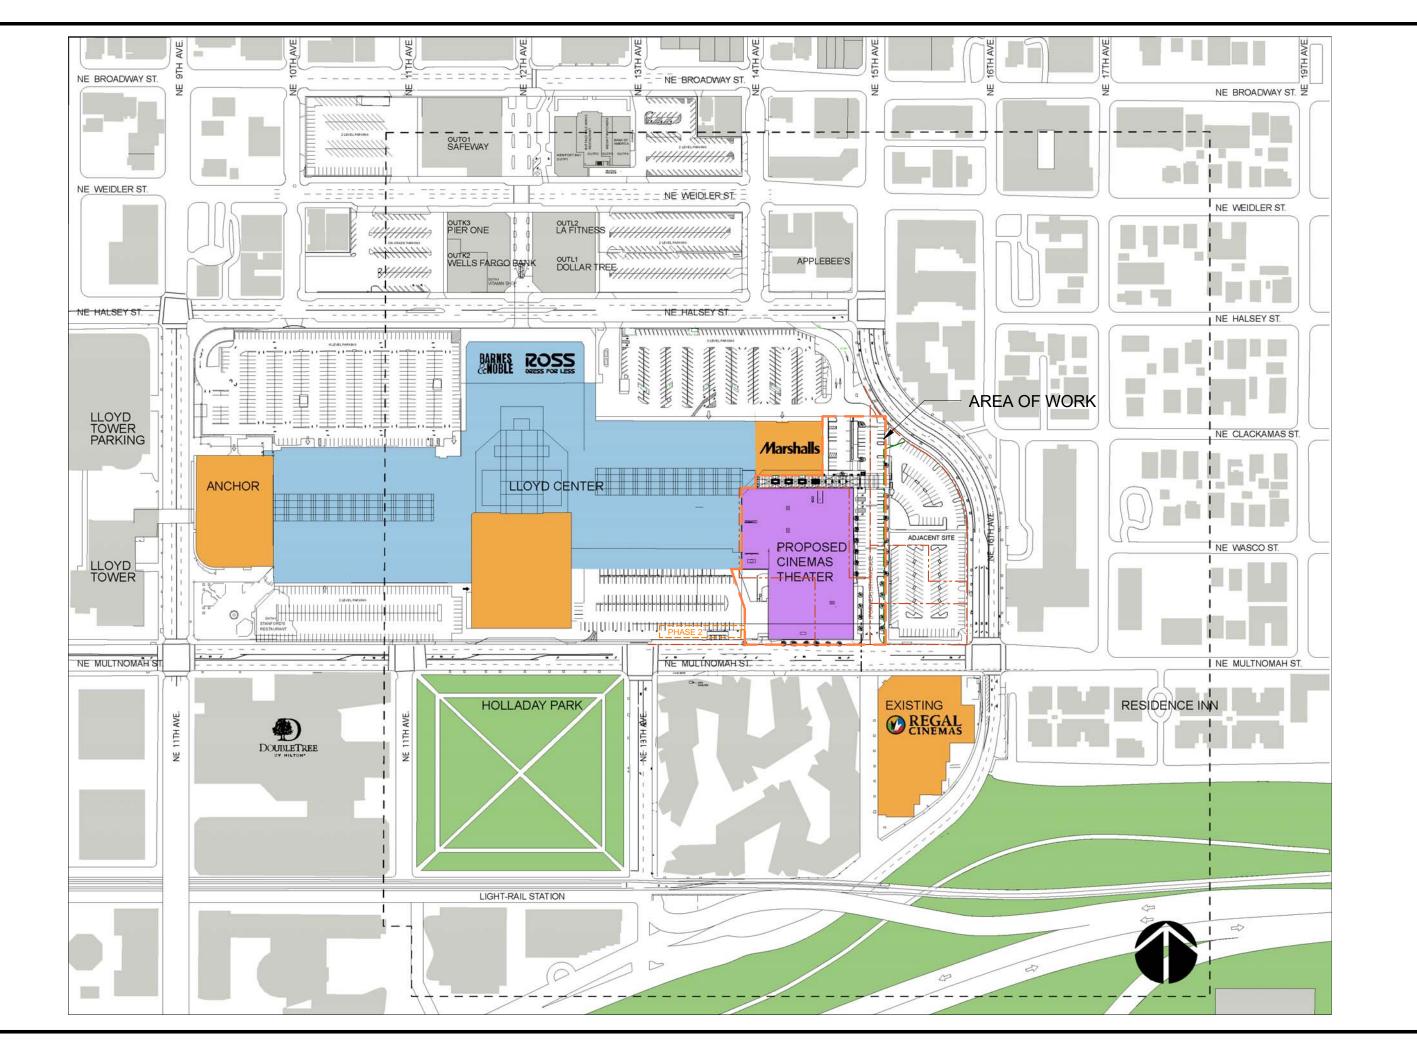
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PROJECT NUMBER: CY1704

Title: VICINITY MAP

Sheet No.





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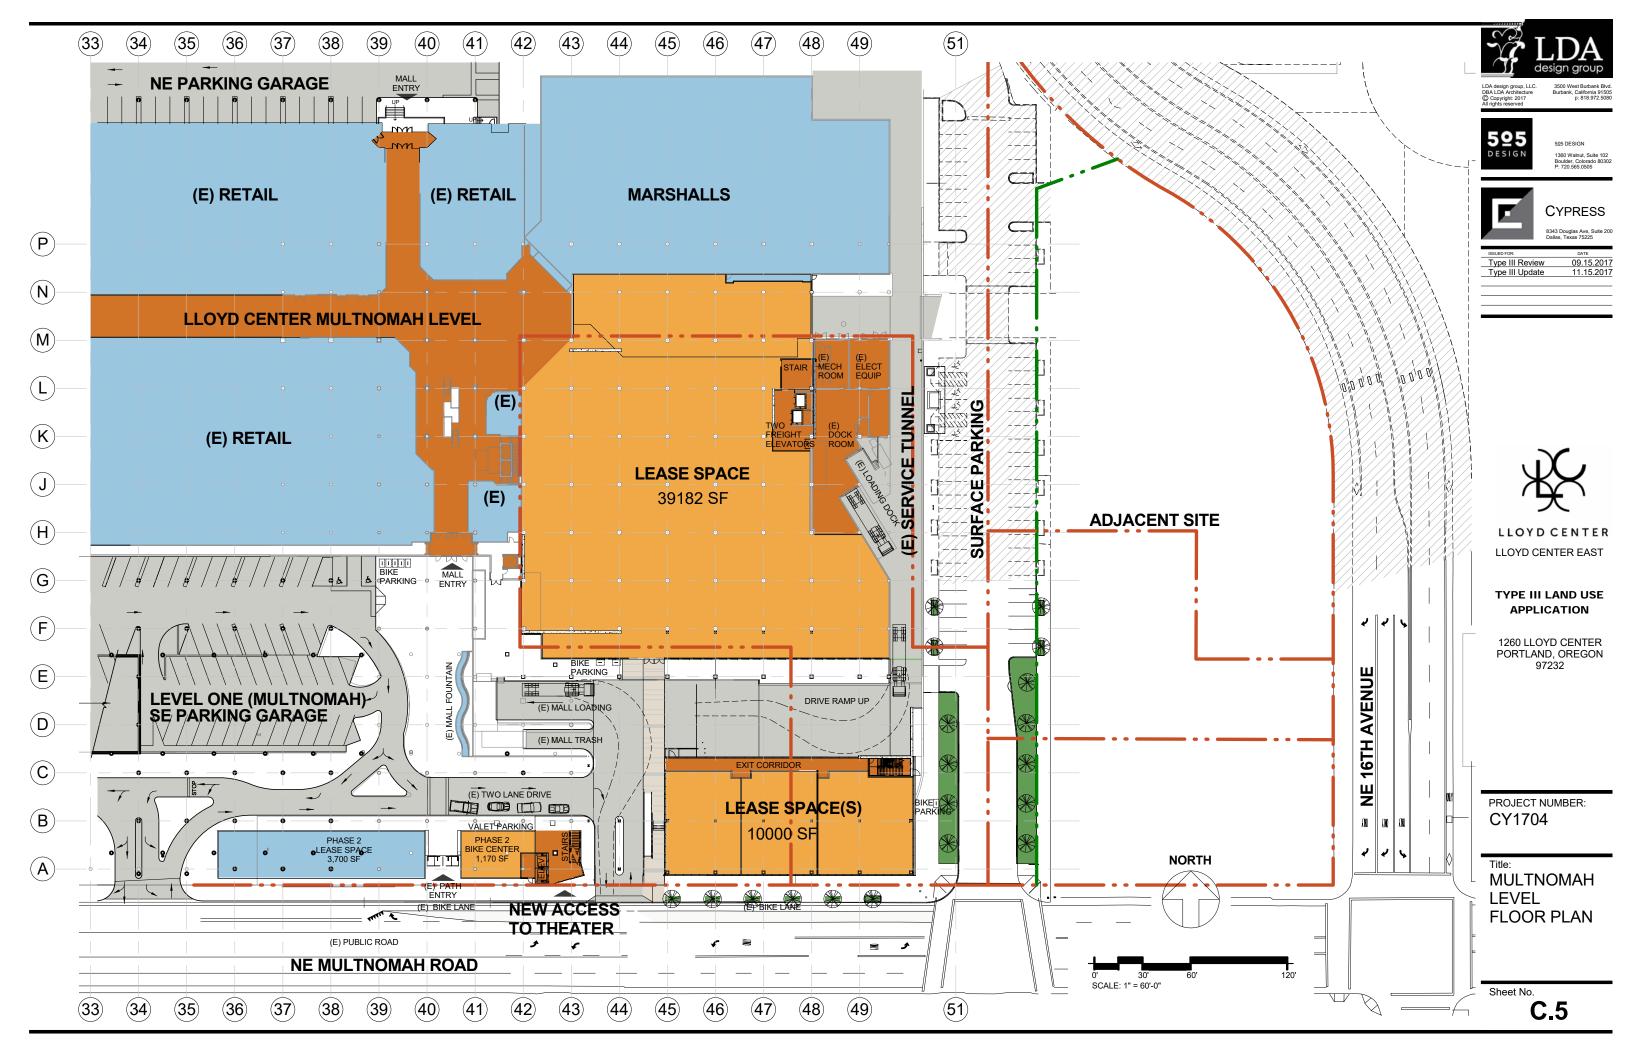
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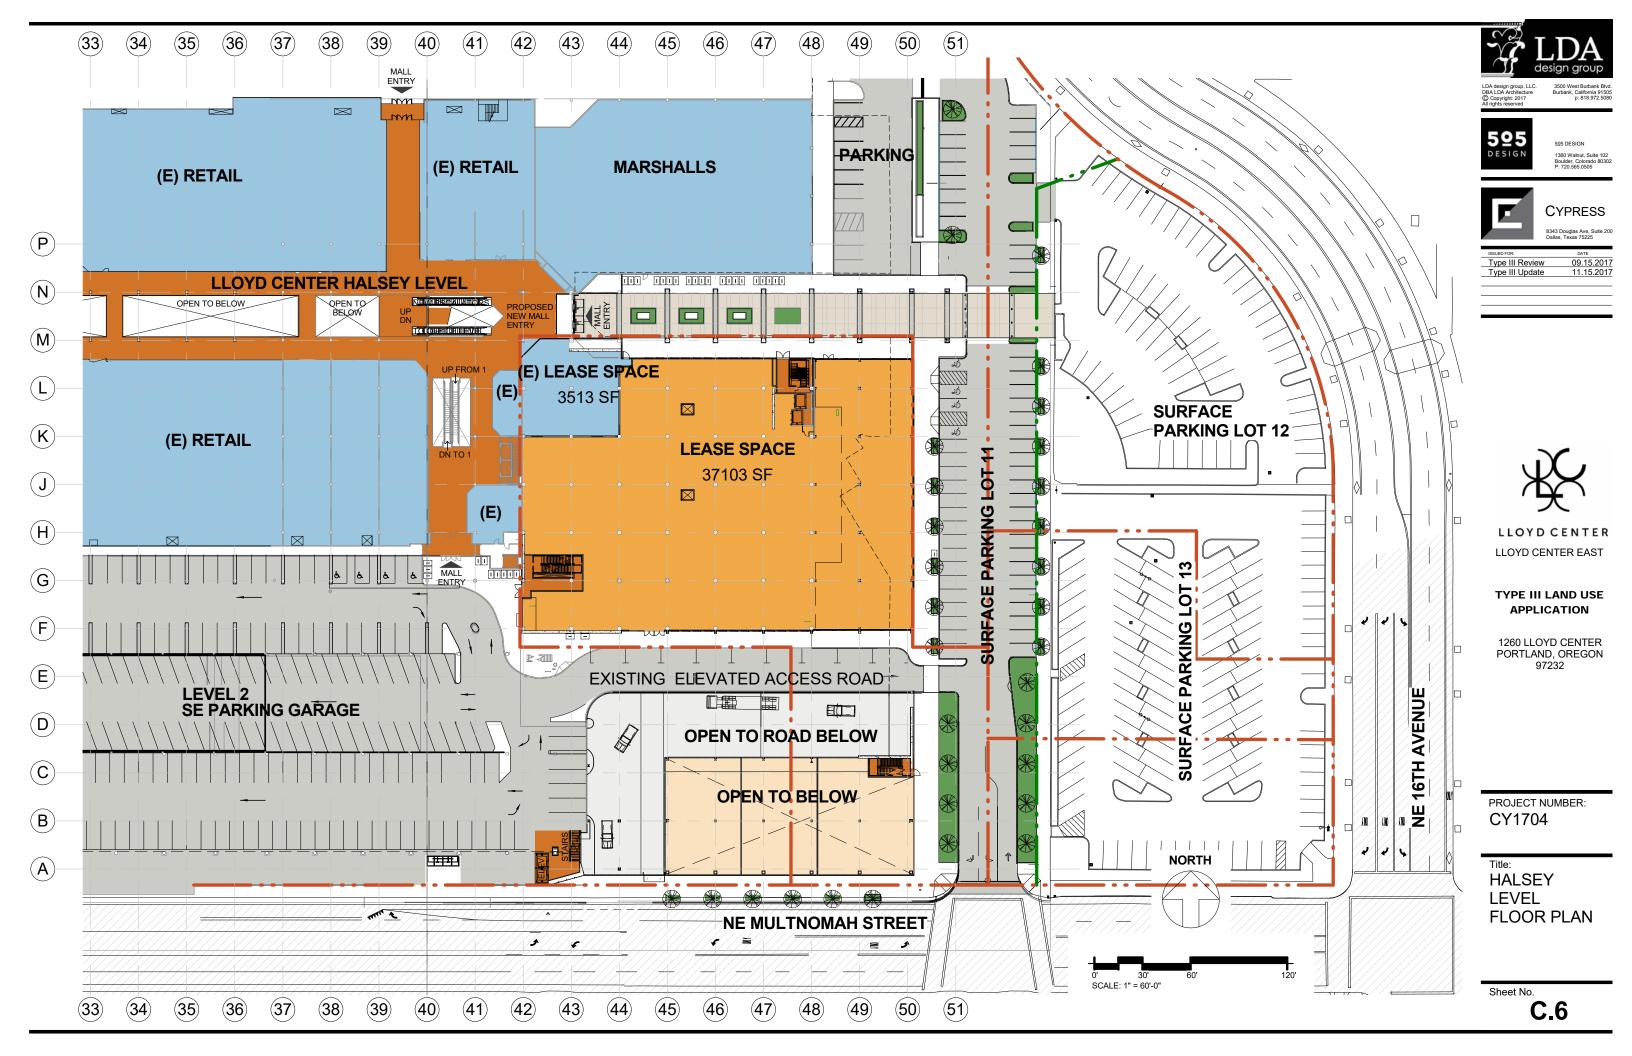
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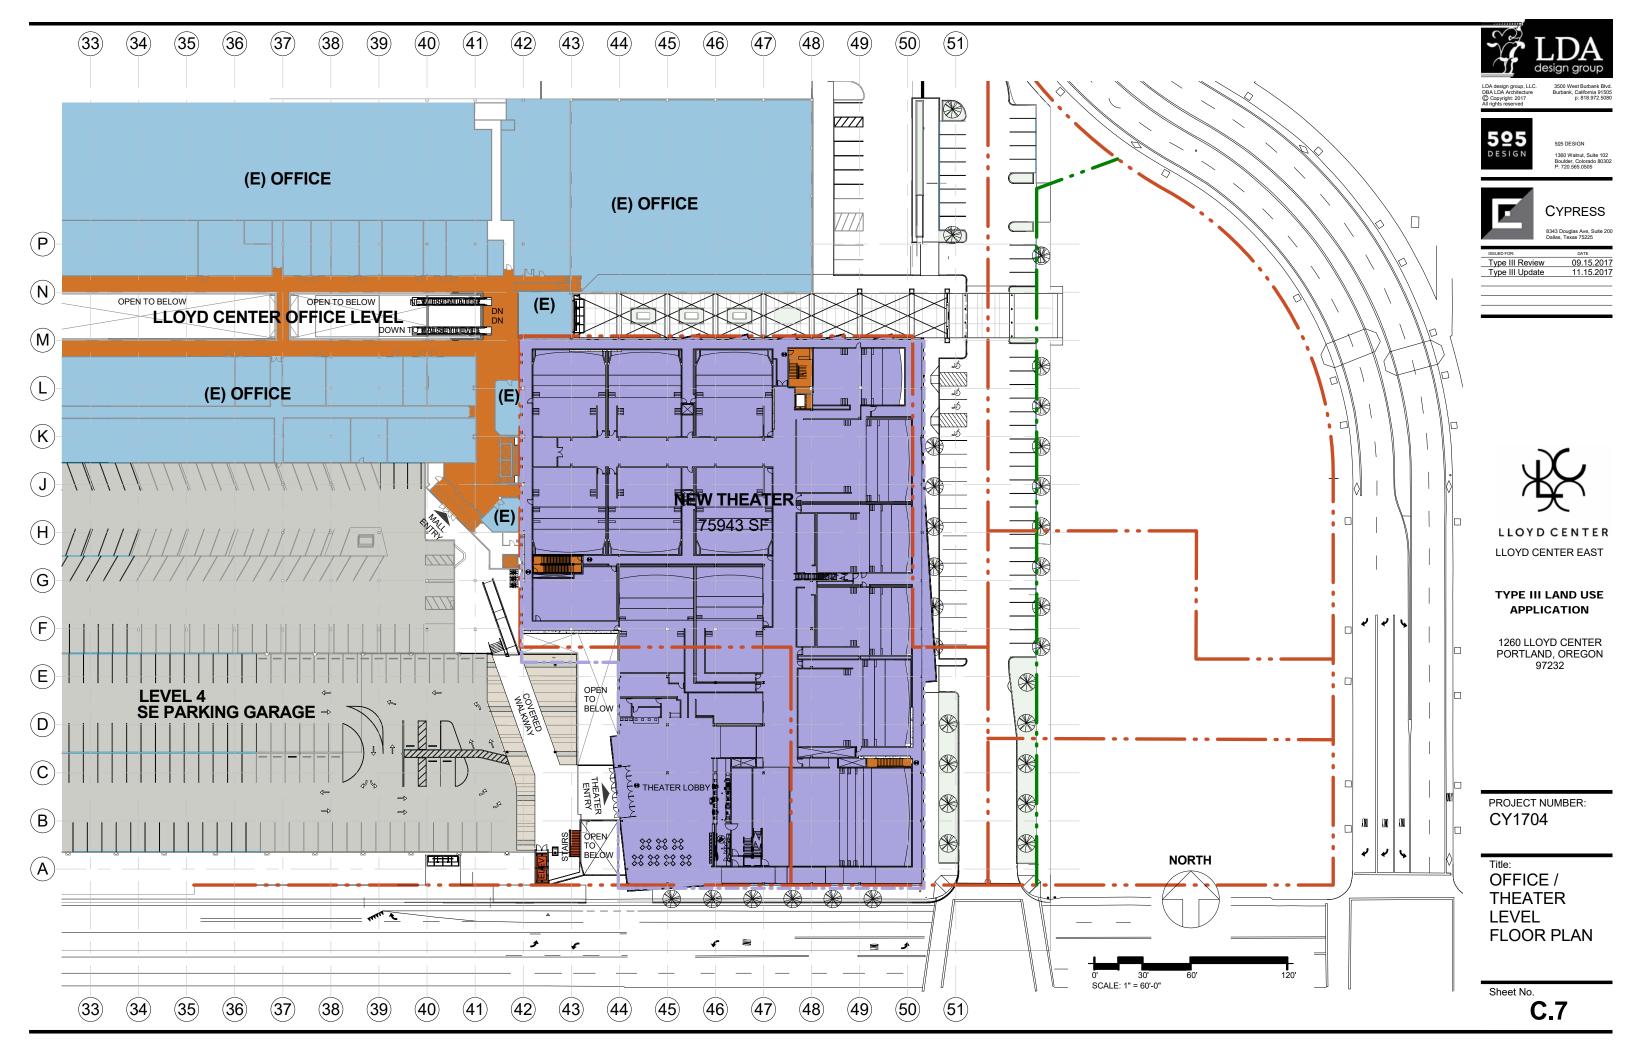
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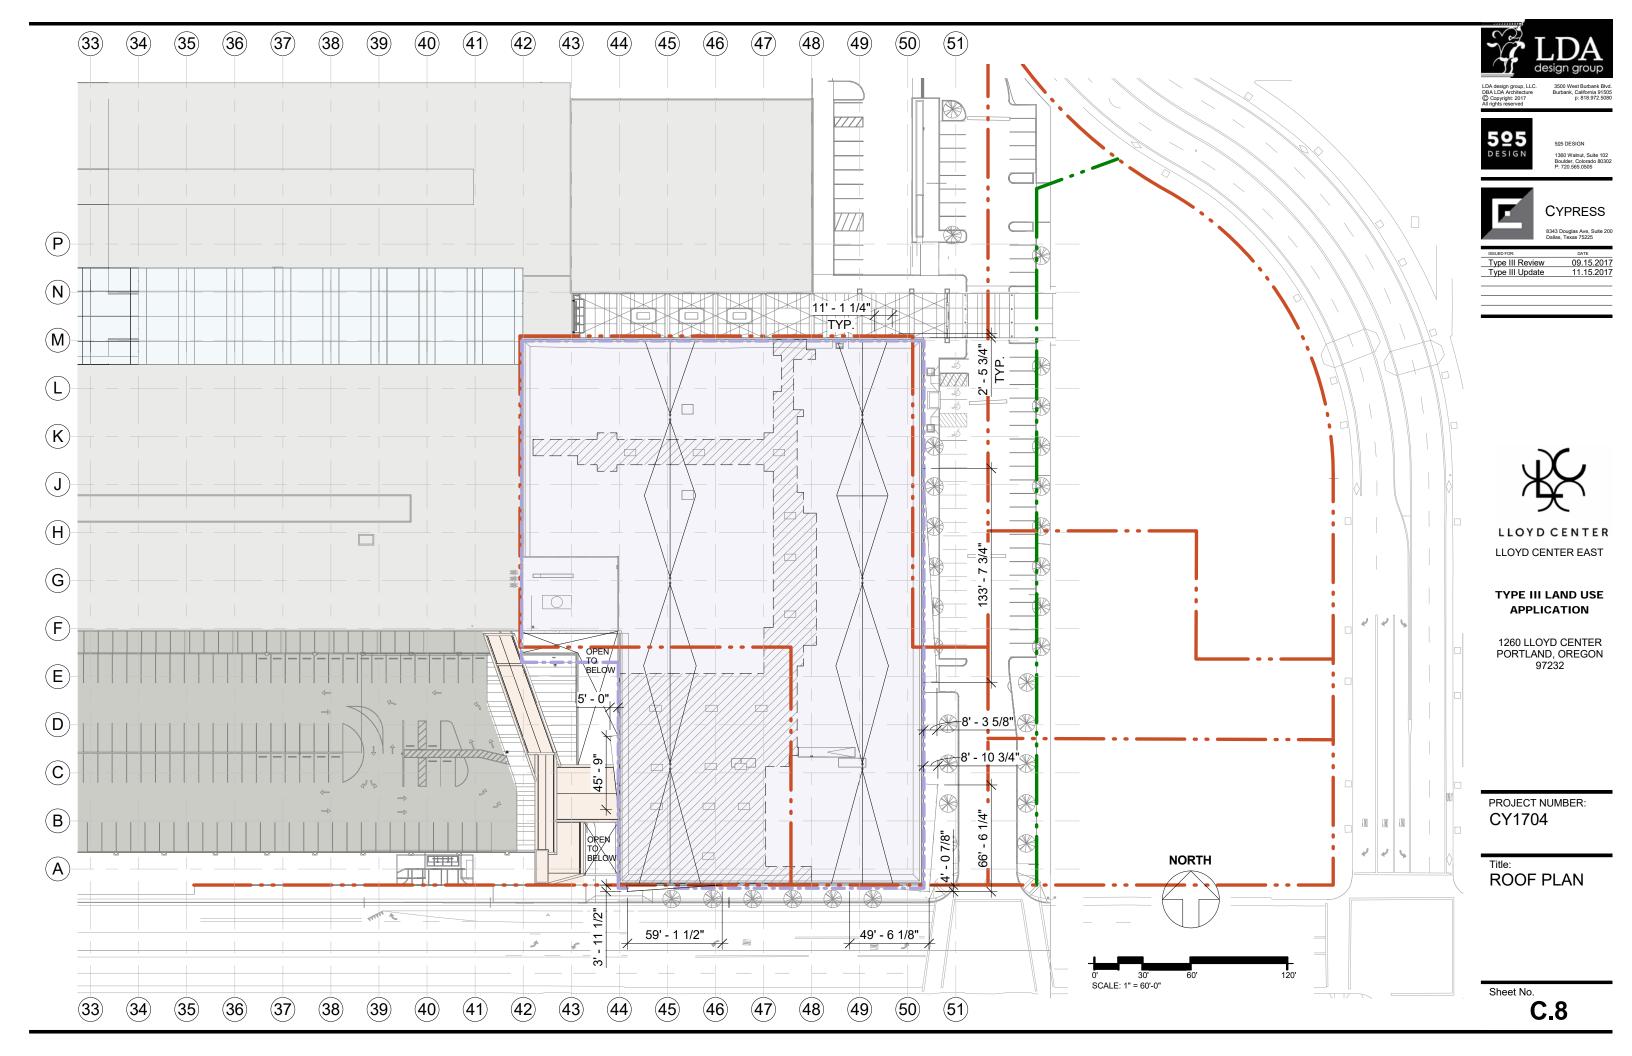
SITE PLAN

Sheet No.















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East Elevation 1" = 30'

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Title:

COLORED **BUILDING ELEVATIONS** 

Sheet No.

**C.9** 

#### MATERIAL LEGEND

ΑN ANODIZED METAL Ρ PAINT

ΜT

GFRC GLASS FIBER REINFORCED CONC.

PORCELAIN TILE





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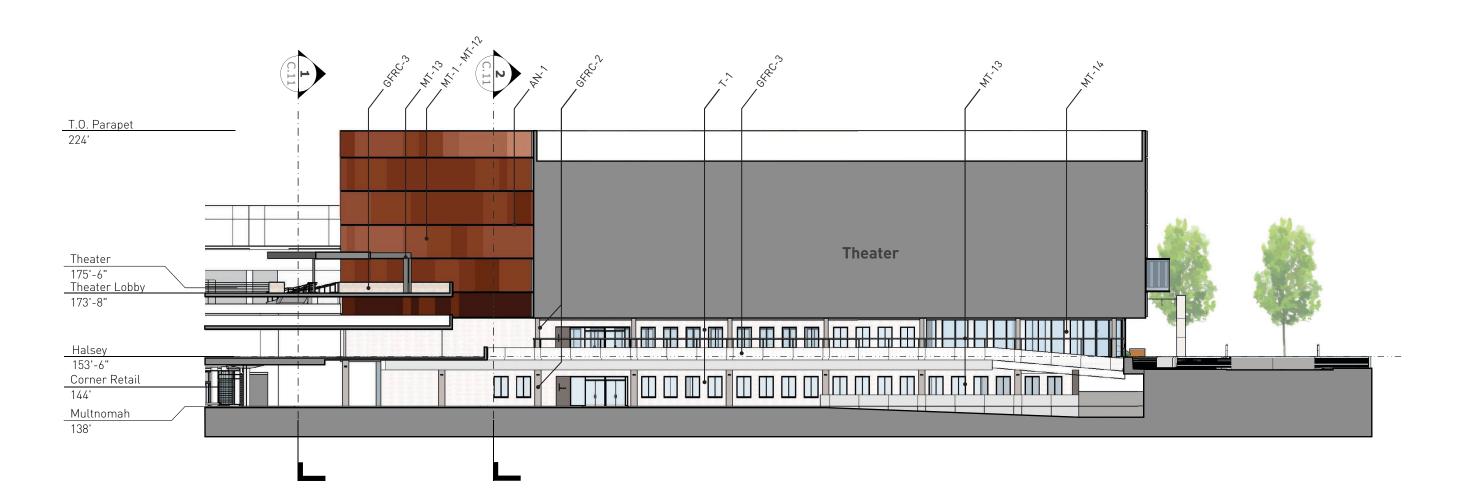
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PROJECT NUMBER: CY1704

Title: COLORED BUILDING ELEVATIONS

Sheet No.

C.11



## South Elevation 1" = 30'


#### MATERIAL LEGEND

AN ANODIZED METAL PAINT

MT MET.

GFRC GLASS FIBER REINFORCED CONC.

T PORCELAIN TILE

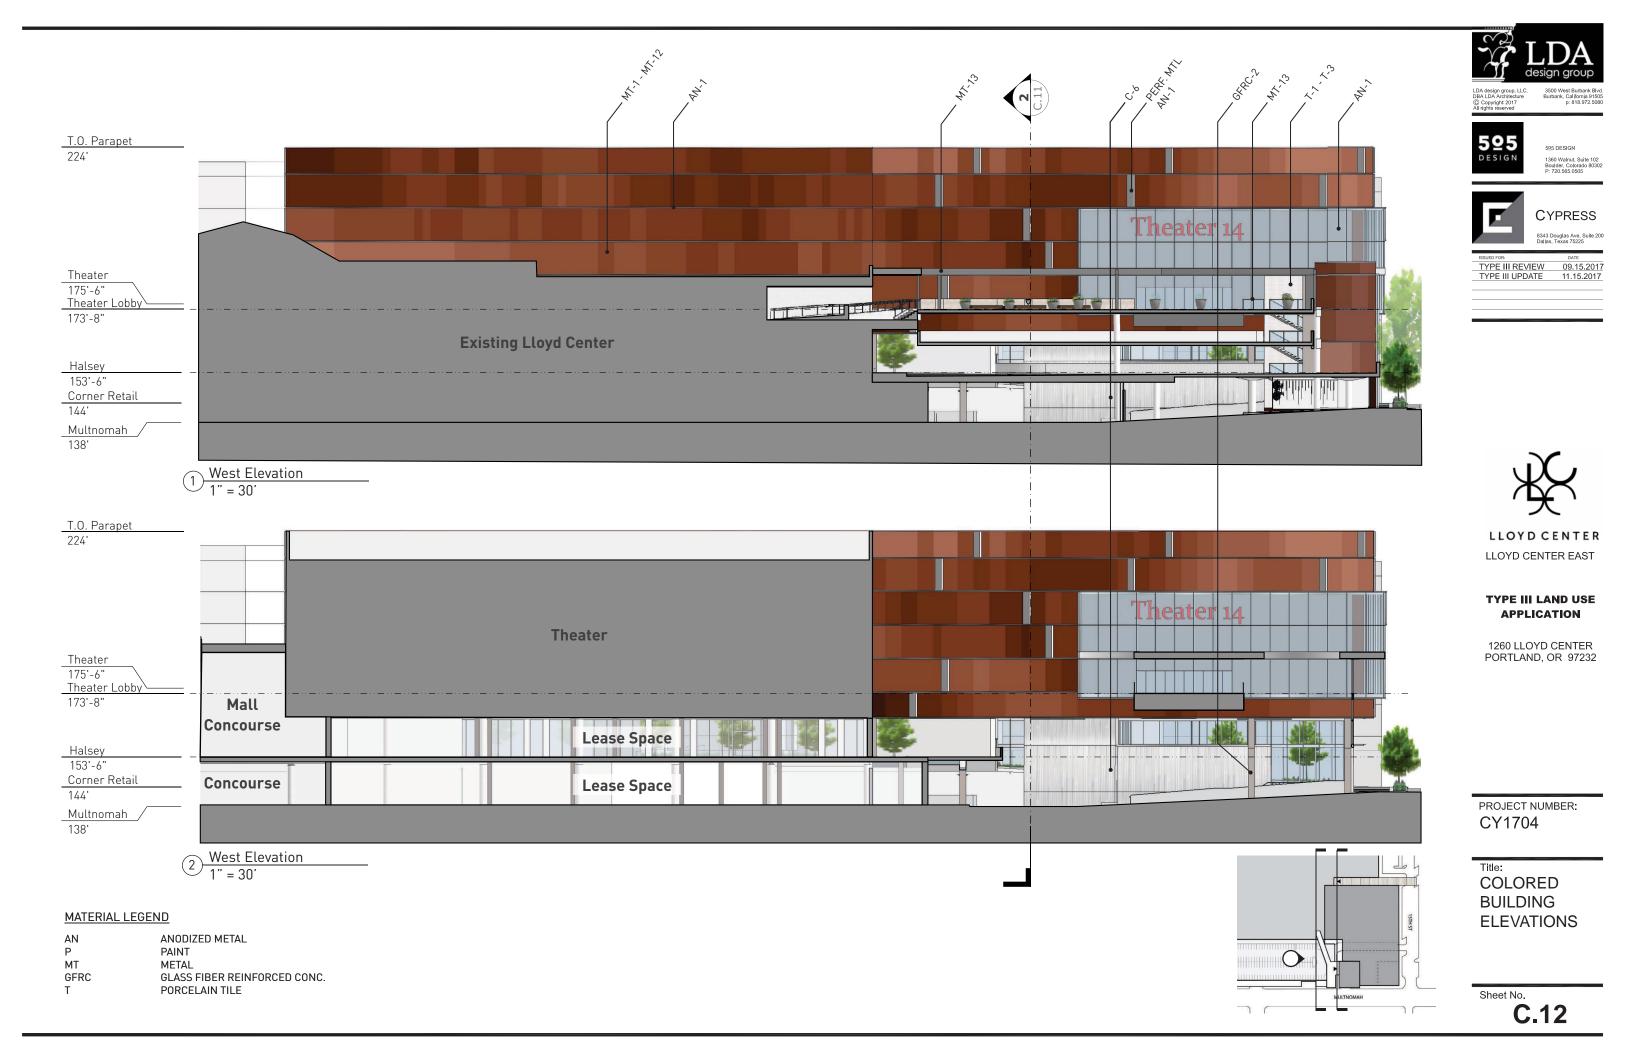





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Title: COLORED **BUILDING ELEVATIONS** 

Sheet No.

 $\underbrace{1 \quad \text{North Elevation}}_{1" = 30'}$ 

#### MATERIAL LEGEND

ΑN ANODIZED METAL Ρ PAINT

ΜT

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PORCELAIN TILE







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Title: COLORED **BUILDING ELEVATIONS** 

Sheet No.



 $2 \frac{\text{Circulation Lobby East Interior Elevation}}{1/16" = 1'}$ 

# Circulation Lobby West Interior Elevation 1/16" = 1'

#### MATERIAL LEGEND

Theater 175'-6"

Halsey 153'-6"

Corner Retail

Multnomah


Theater Lobby 173'-8"

ΑN ANODIZED METAL PAINT


MT

GFRC GLASS FIBER REINFORCED CONC.

PORCELAIN TILE

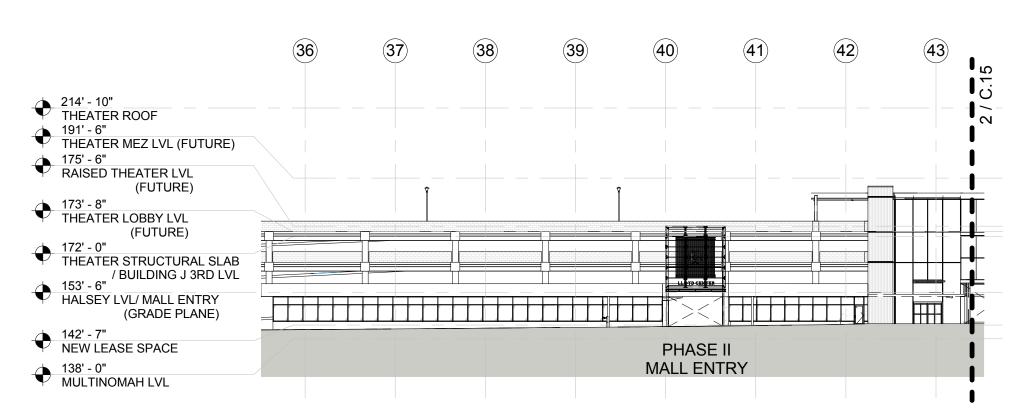



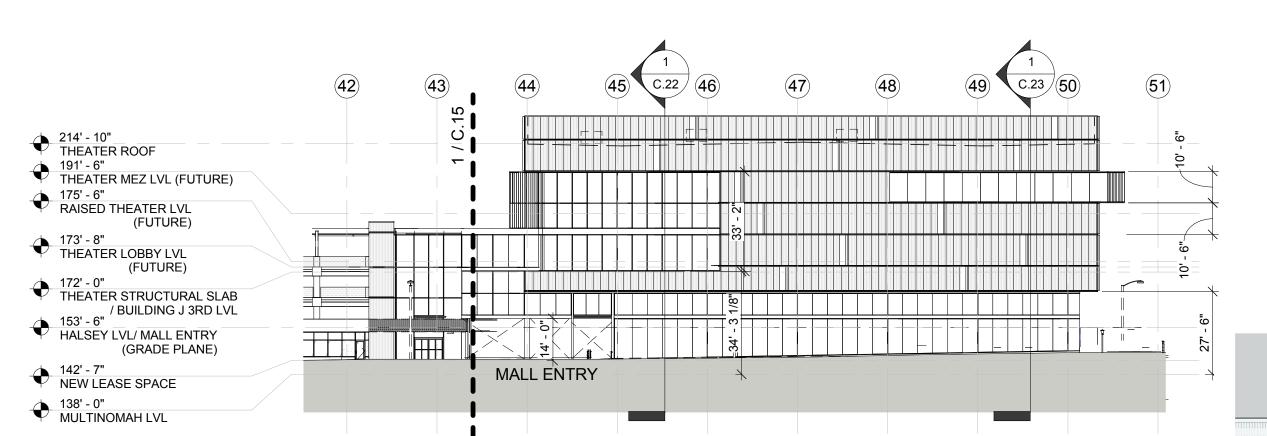

SOUTH ELEVATION - MULTNOMAH STREET - THEATER

SCALE: 1/32" = 1'-0"

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Title: BUILDING ELEVATIONS

Sheet No.

1




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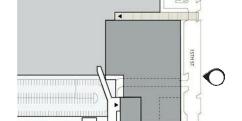


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### **EAST ELEVATION - 15TH AVENUE**


SCALE: 1/32" = 1'-0"



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Title:
BUILDING
ELEVATIONS

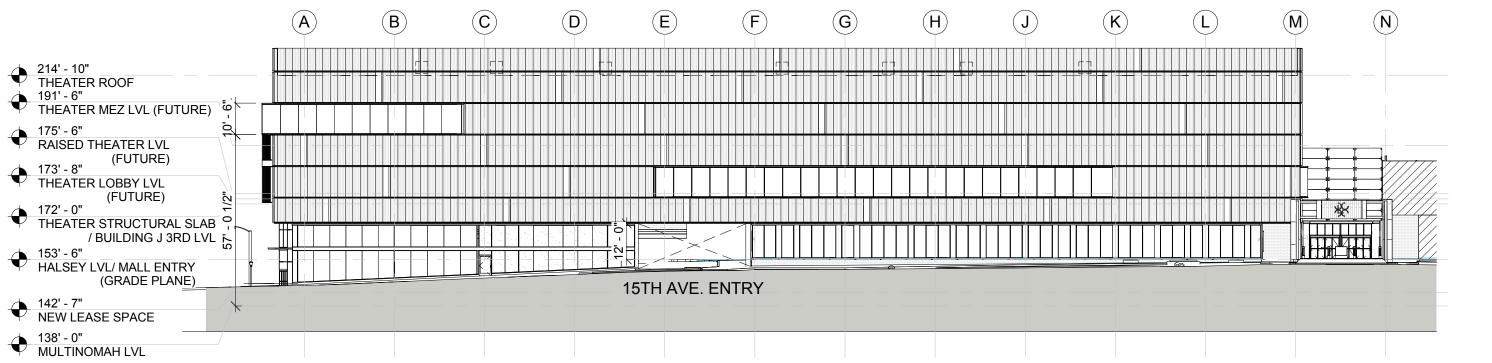Sheet No.

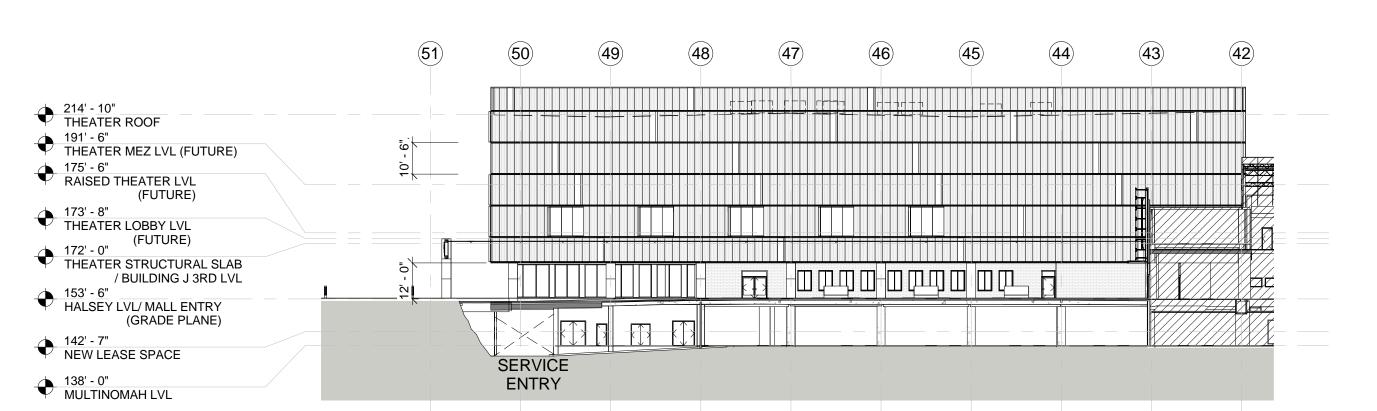

**NORTH ELEVATION - NEW EAST MALL ENTRY** 



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PROJECT NUMBER: CY1704

- 2 1/2"

34


22' - 11"

**↓**.

**BUILDING ELEVATIONS** 

Sheet No.

**C.17** 

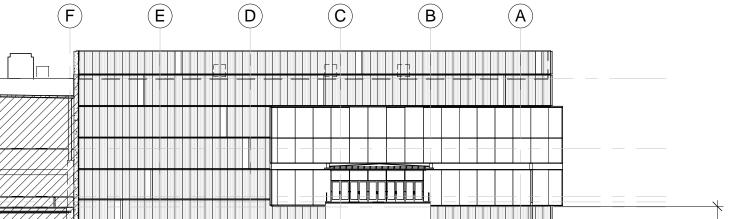

153' - 6" HALSEY LVL/ MALL ENTRY (GRADE PLANE)

142' - 7" NEW LEASE SPACE

214' - 10"

191' - 6"

175' - 6"

THEATER ROOF

THEATER MEZ LVL (FUTURE)

(FUTURE)

(FUTURE)

/ BUILDING J 3RD LVL

THEATER STRUCTURAL SLAB

RAISED THEATER LVL

THEATER LOBBY LVL

138' - 0" MULTINOMAH LVL


(G)

### **WEST ELEVATION - NEW THEATER ENTRY**

SCALE: 1/32" = 1'-0"

SCALE: 1/32" = 1'-0"

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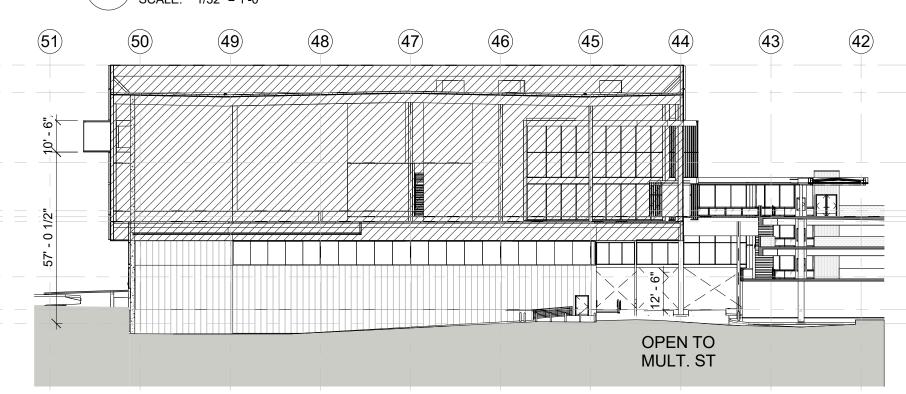
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PROJECT NUMBER: CY1704

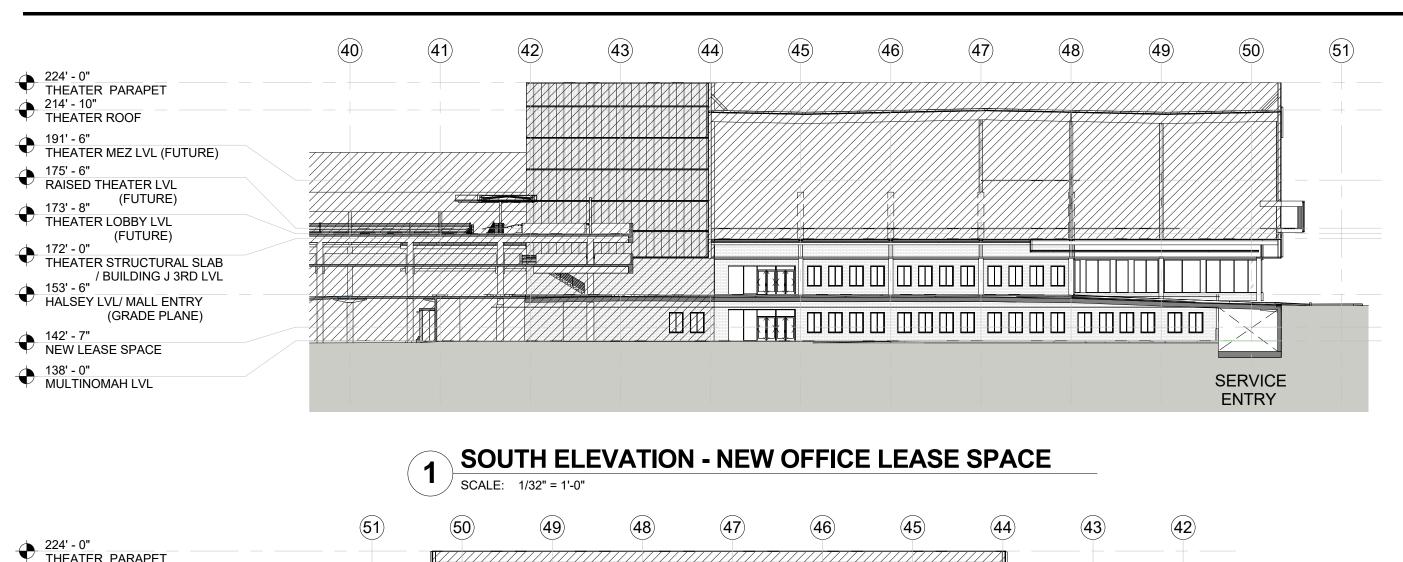**BUILDING ELEVATIONS** 

Sheet No. **C.18** 



SCALE: 1/32" = 1'-0"

THEATER PARAPET

RAISED THEATER LVL

THEATER LOBBY LVL

THEATER MEZ LVL (FUTURE)

(FUTURE)

(FUTURE)

/ BUILDING J 3RD LVL

(GRADE PLANE)

THEATER STRUCTURAL SLAB

HALSEY LVL/ MALL ENTRY

NEW LEASE SPACE

MULTINOMAH LVL

214' - 10" THEATER ROOF

191' - 6"

175' - 6"


173' - 8"

172' - 0"

153' - 6"


142' - 7"

**NORTH ELEVATION - BACK OF NEW LEASE SPACE** 

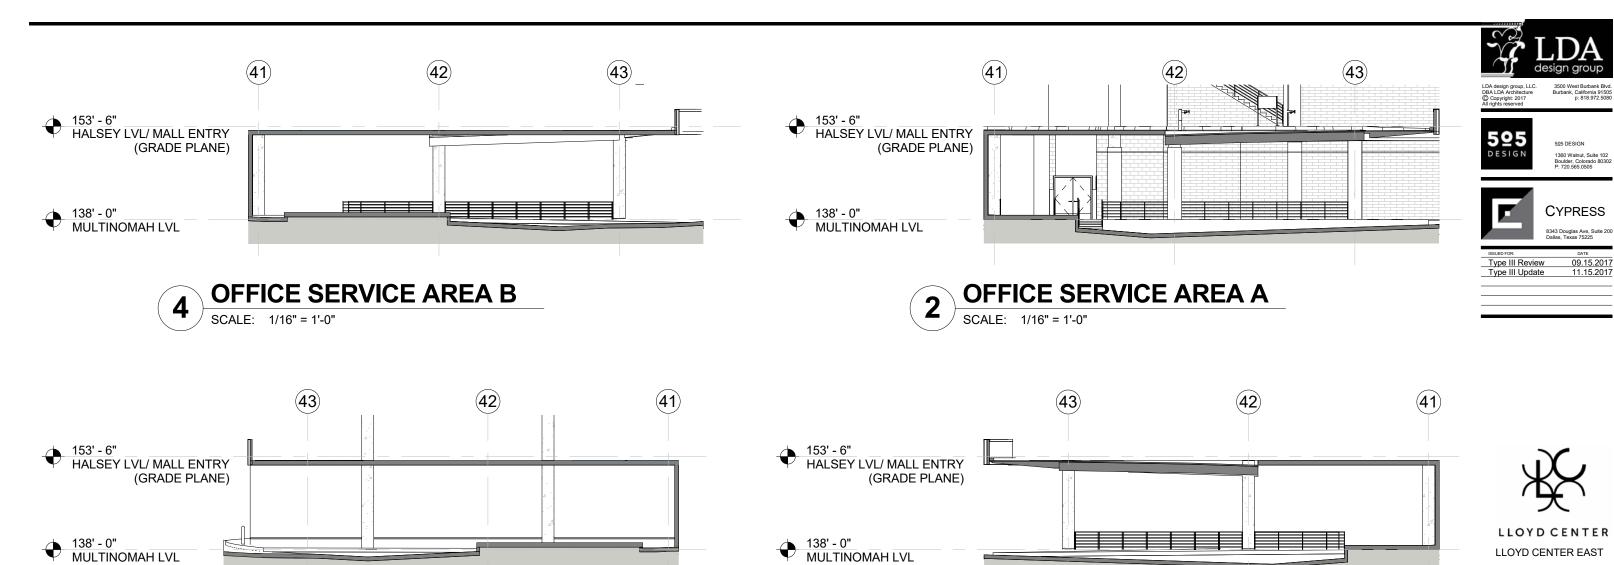






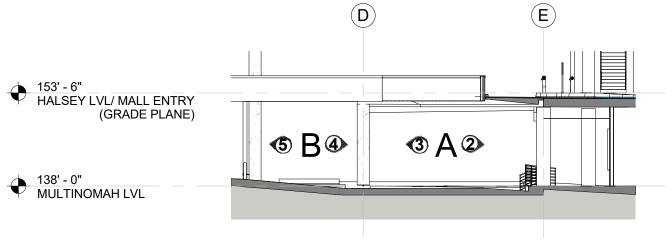

OFFICE SERVICE AREA ELEVATION

SCALE: 1/16" = 1'-0"

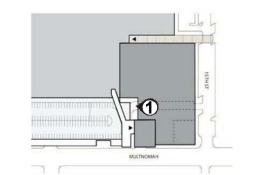


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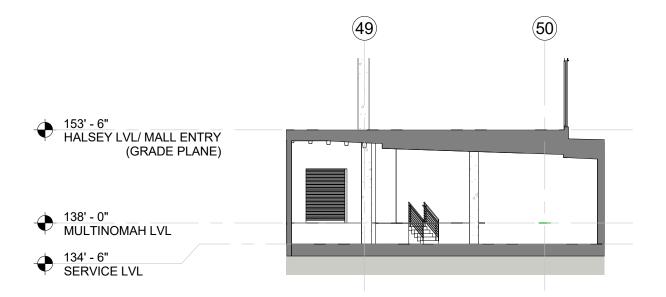
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Title: BUILDING ELEVATIONS

Sheet No.



### **THEATER SERVICE AREA ELEVATION** SCALE: 1/16" = 1'-0"

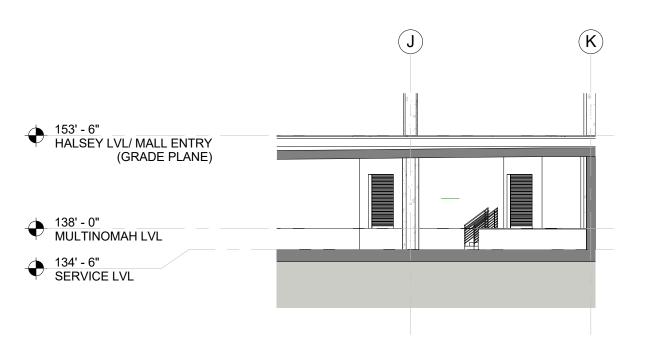







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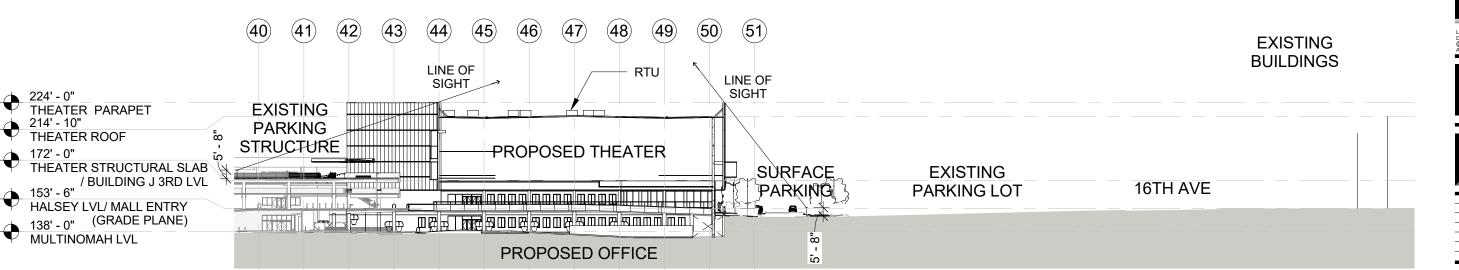
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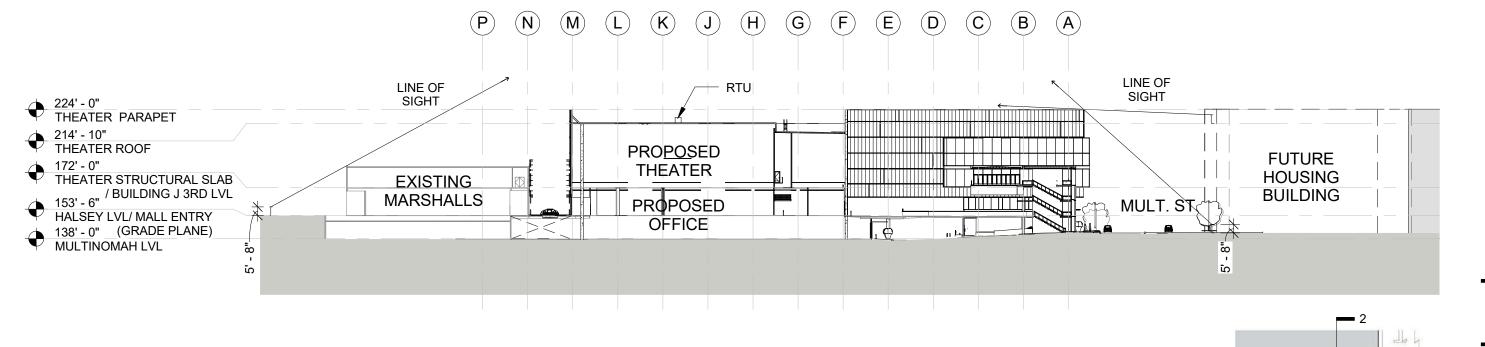
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### **OVERALL SITE LONGITUDINAL SECTION**

SCALE: 1/64" = 1'-0"



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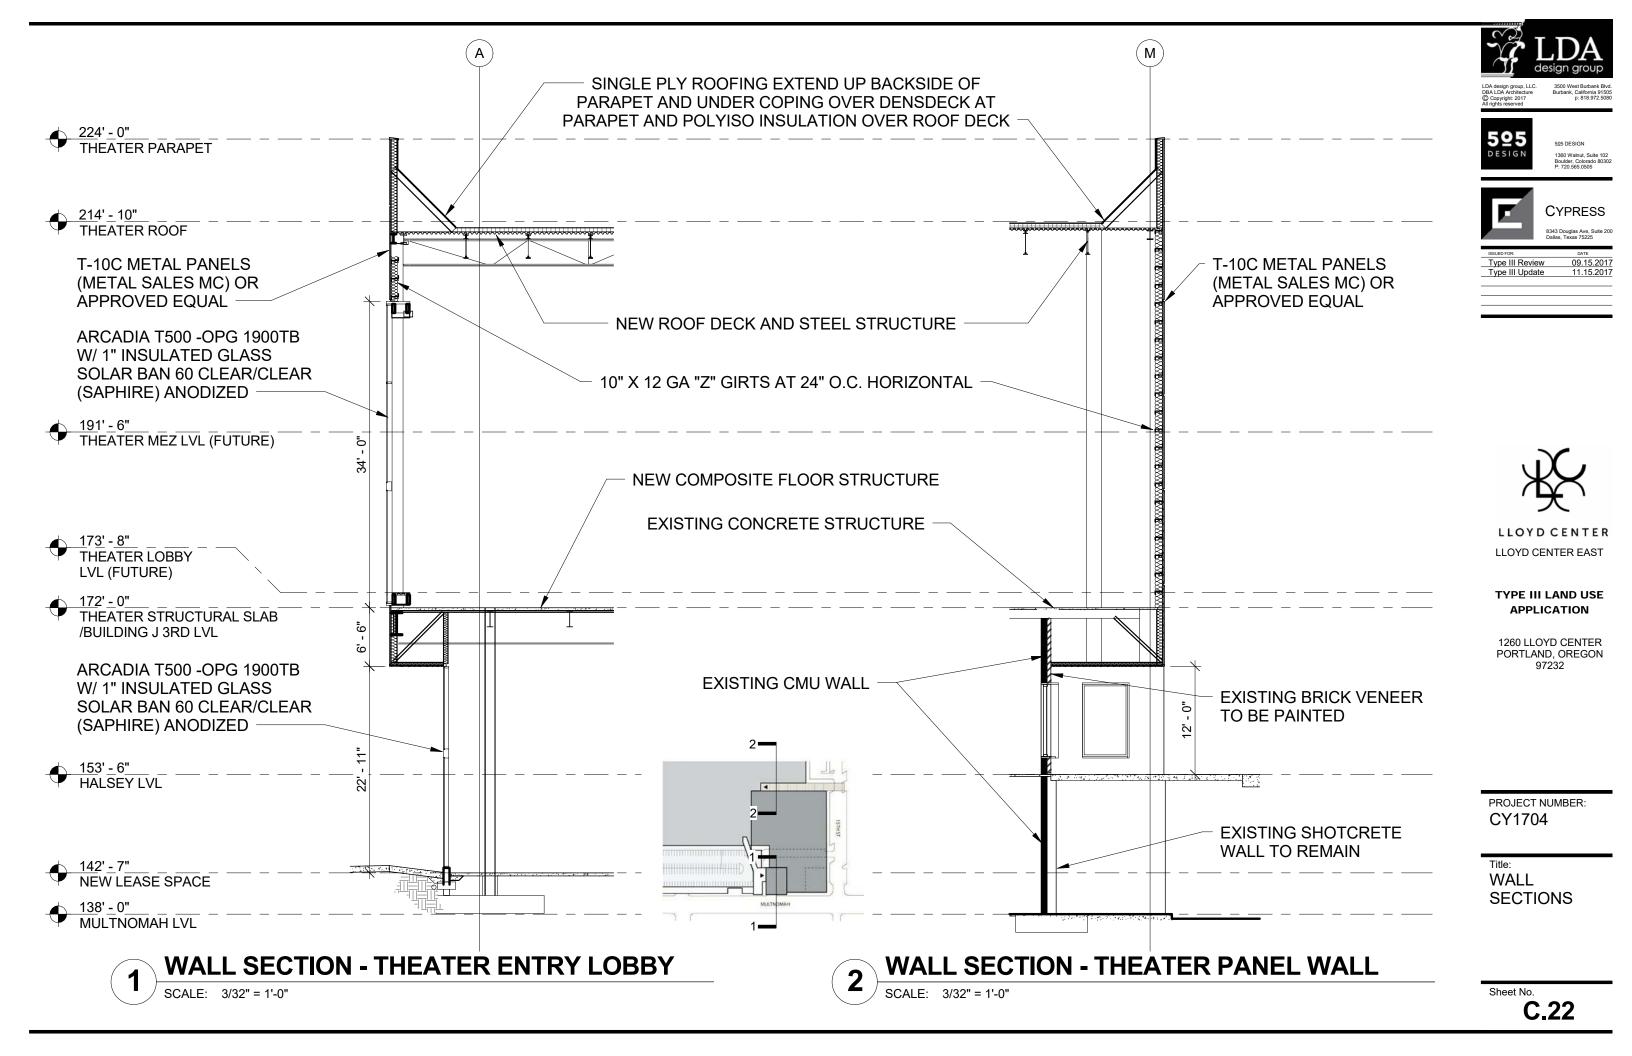
BUILDING **SECTIONS** AND SITE LINE **DIAGRAMS** 


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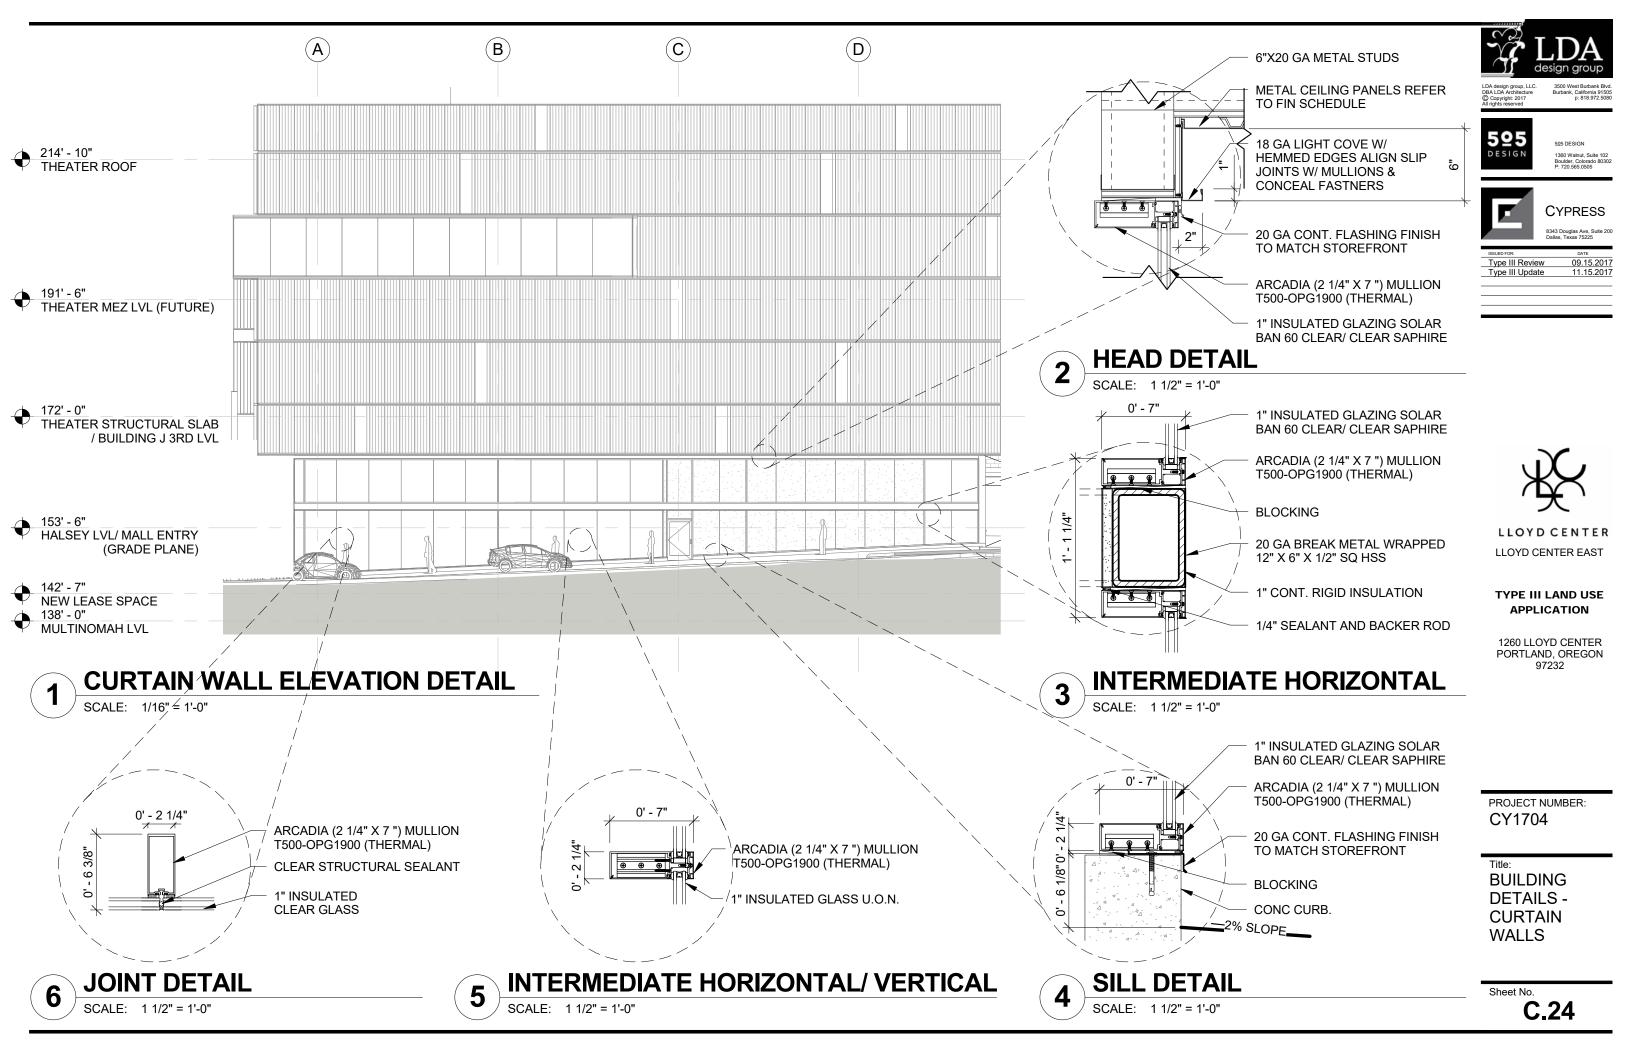
**C.21** 

### **OVERALL SITE CROSS SECTION**

SCALE: 1/64" = 1'-0"





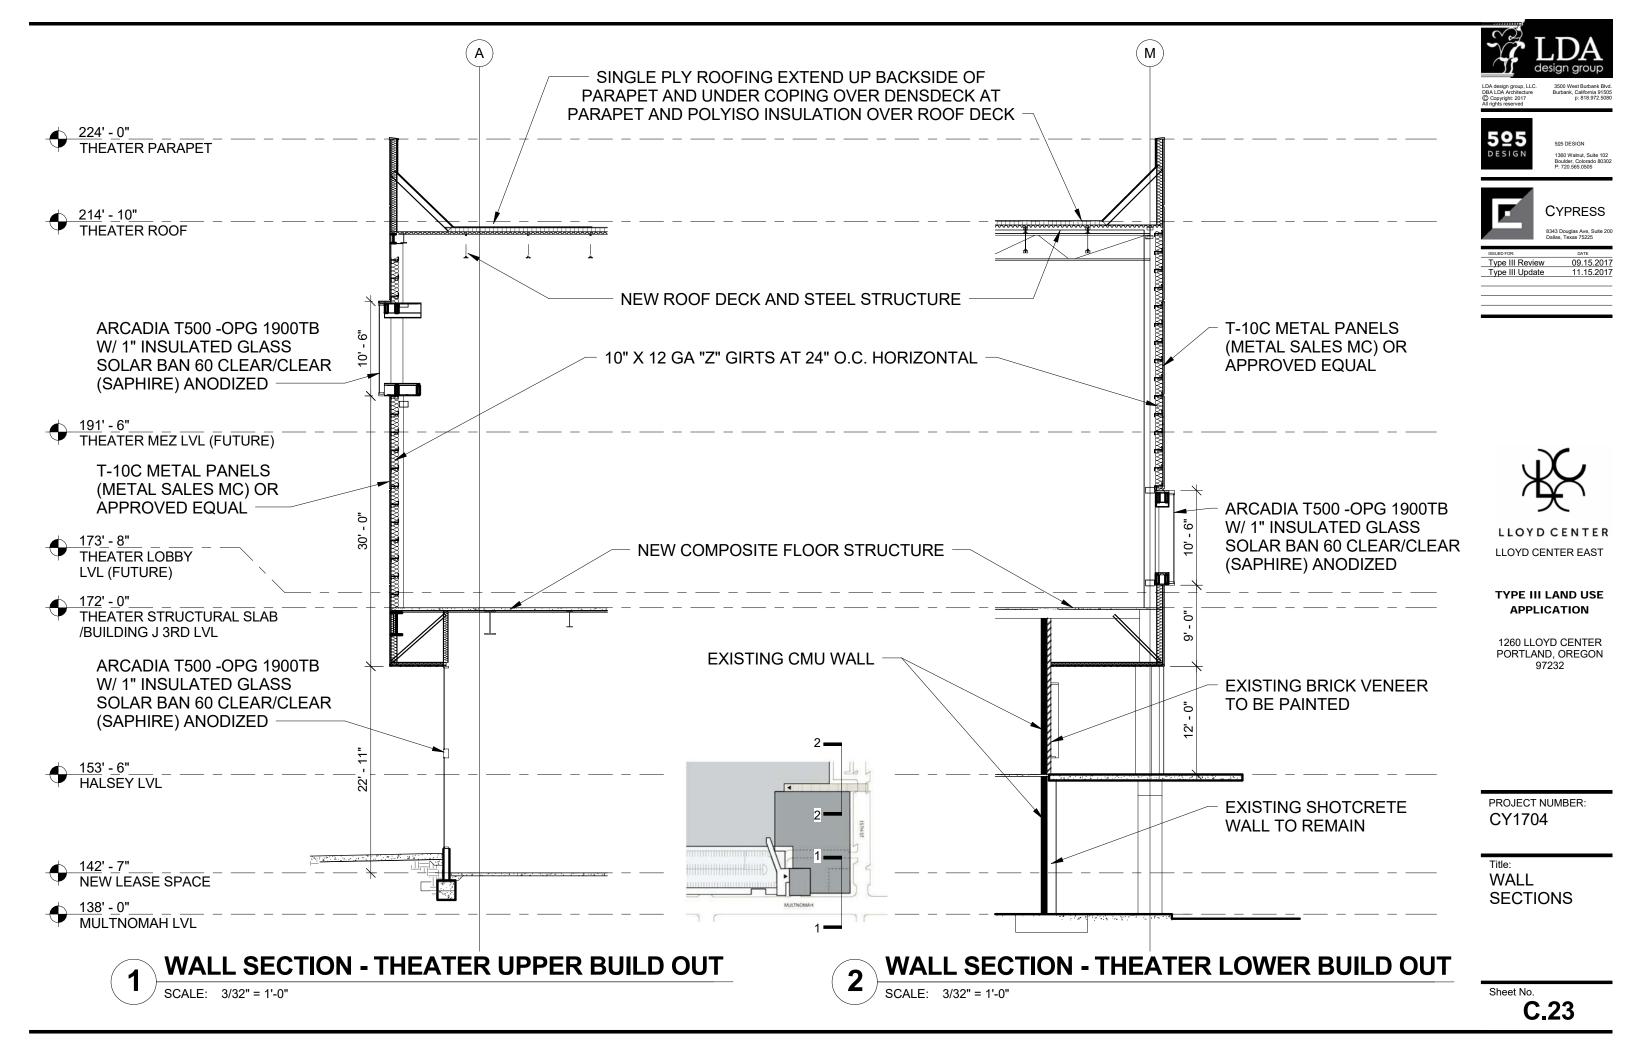





E

(D)

(C)

 $\overline{\mathsf{B}}$ 

(A)

(44)

(44)

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BUILDING **DETAILS** -CANOPY

**ENLARGED ROOF PLAN** SCALE: 1/32" = 1'-0"

(42)

**(41)** 


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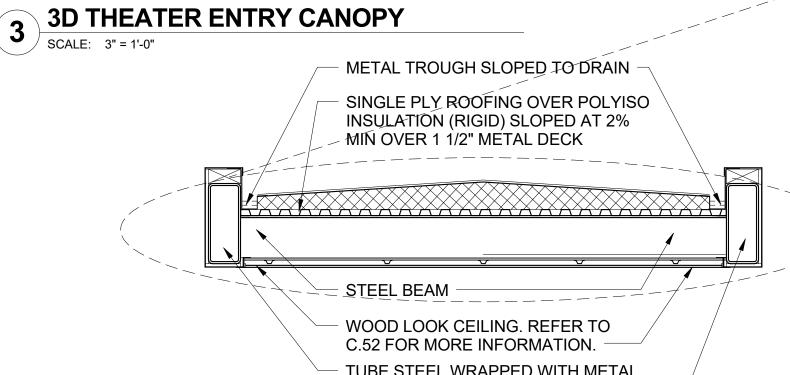
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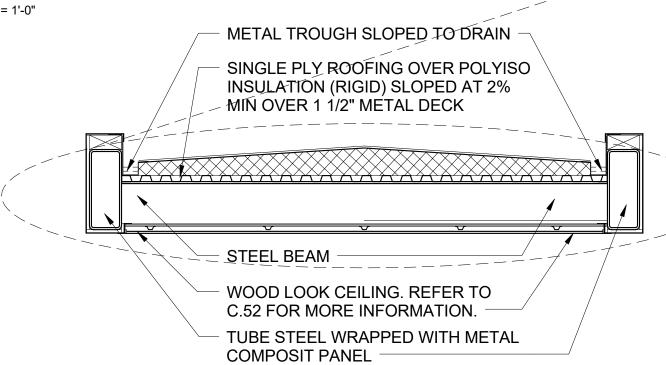
**B** 

(A)

(41)






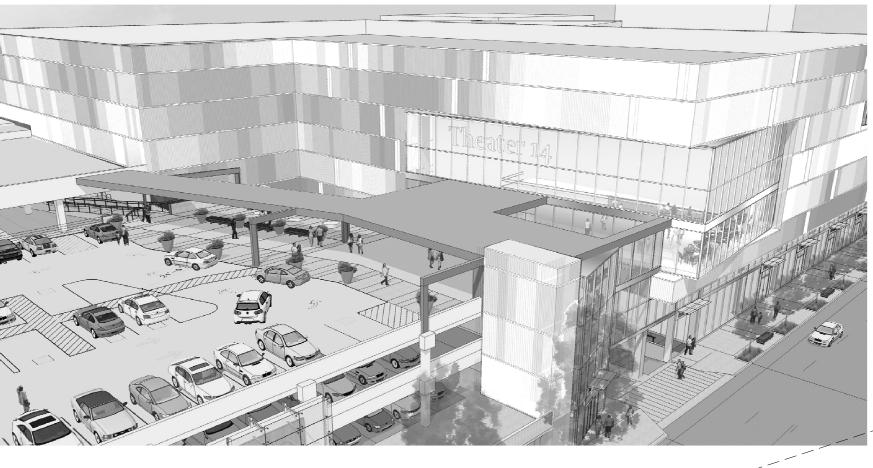


**CANOPY SECTION** 

SCALE: 1/2" = 1'-0"

Sheet No. C.25

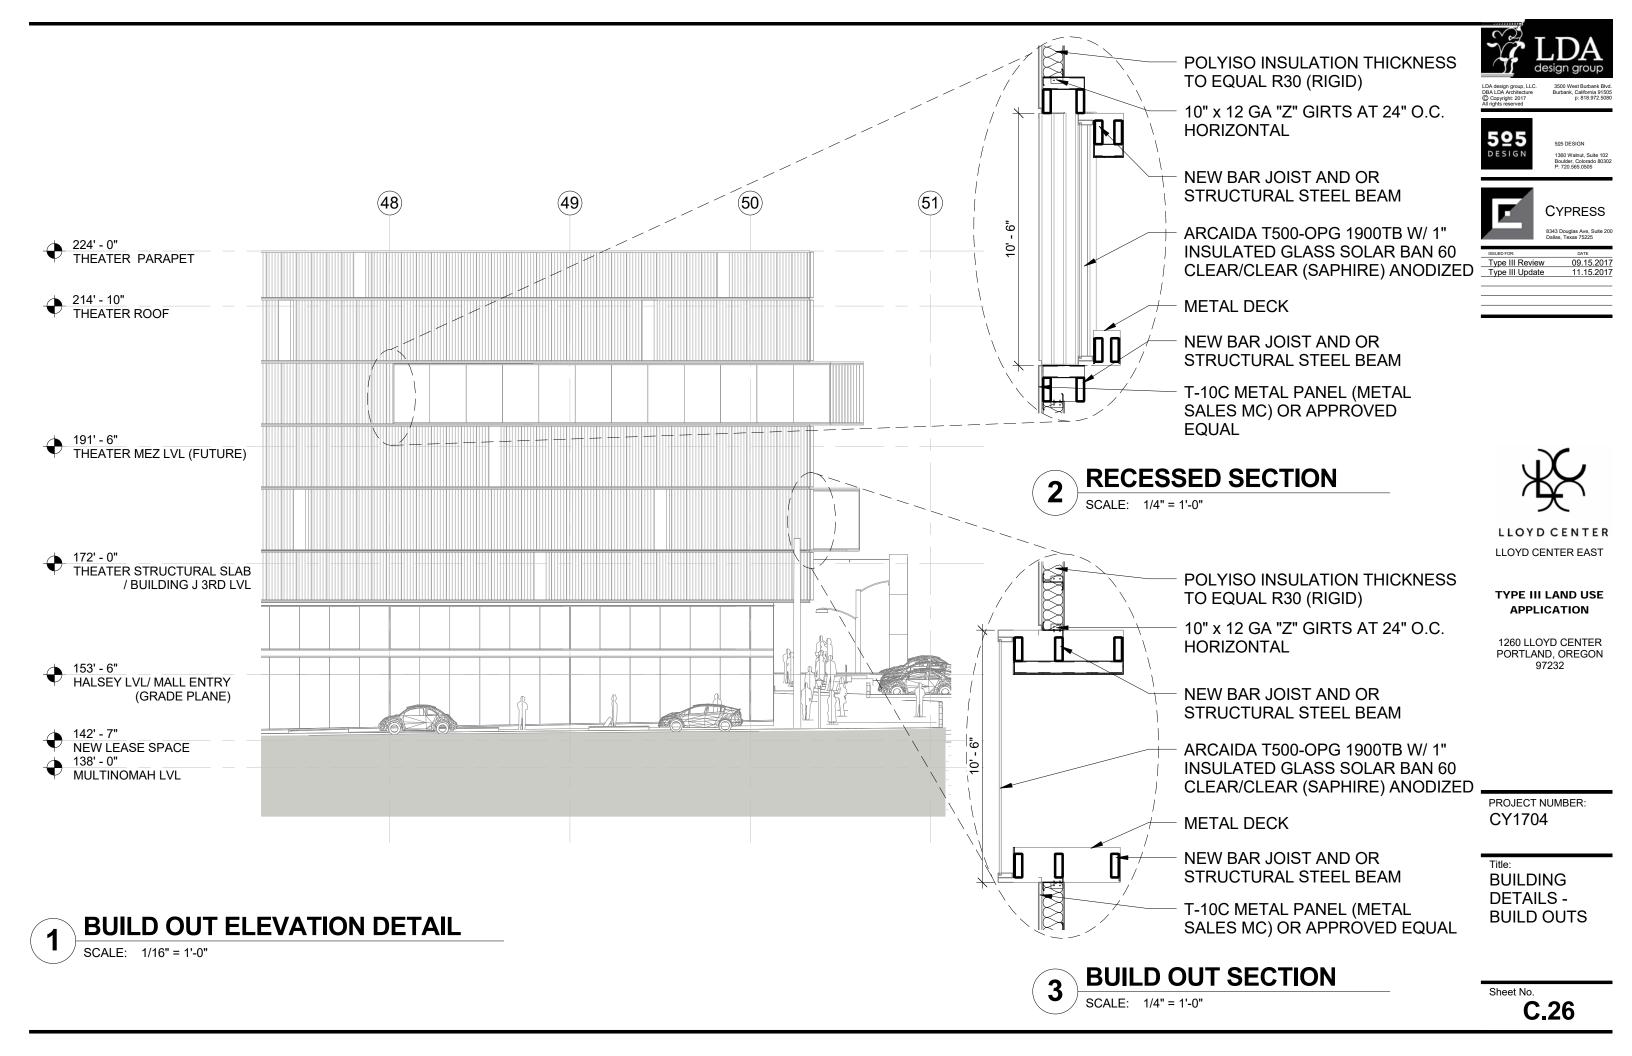

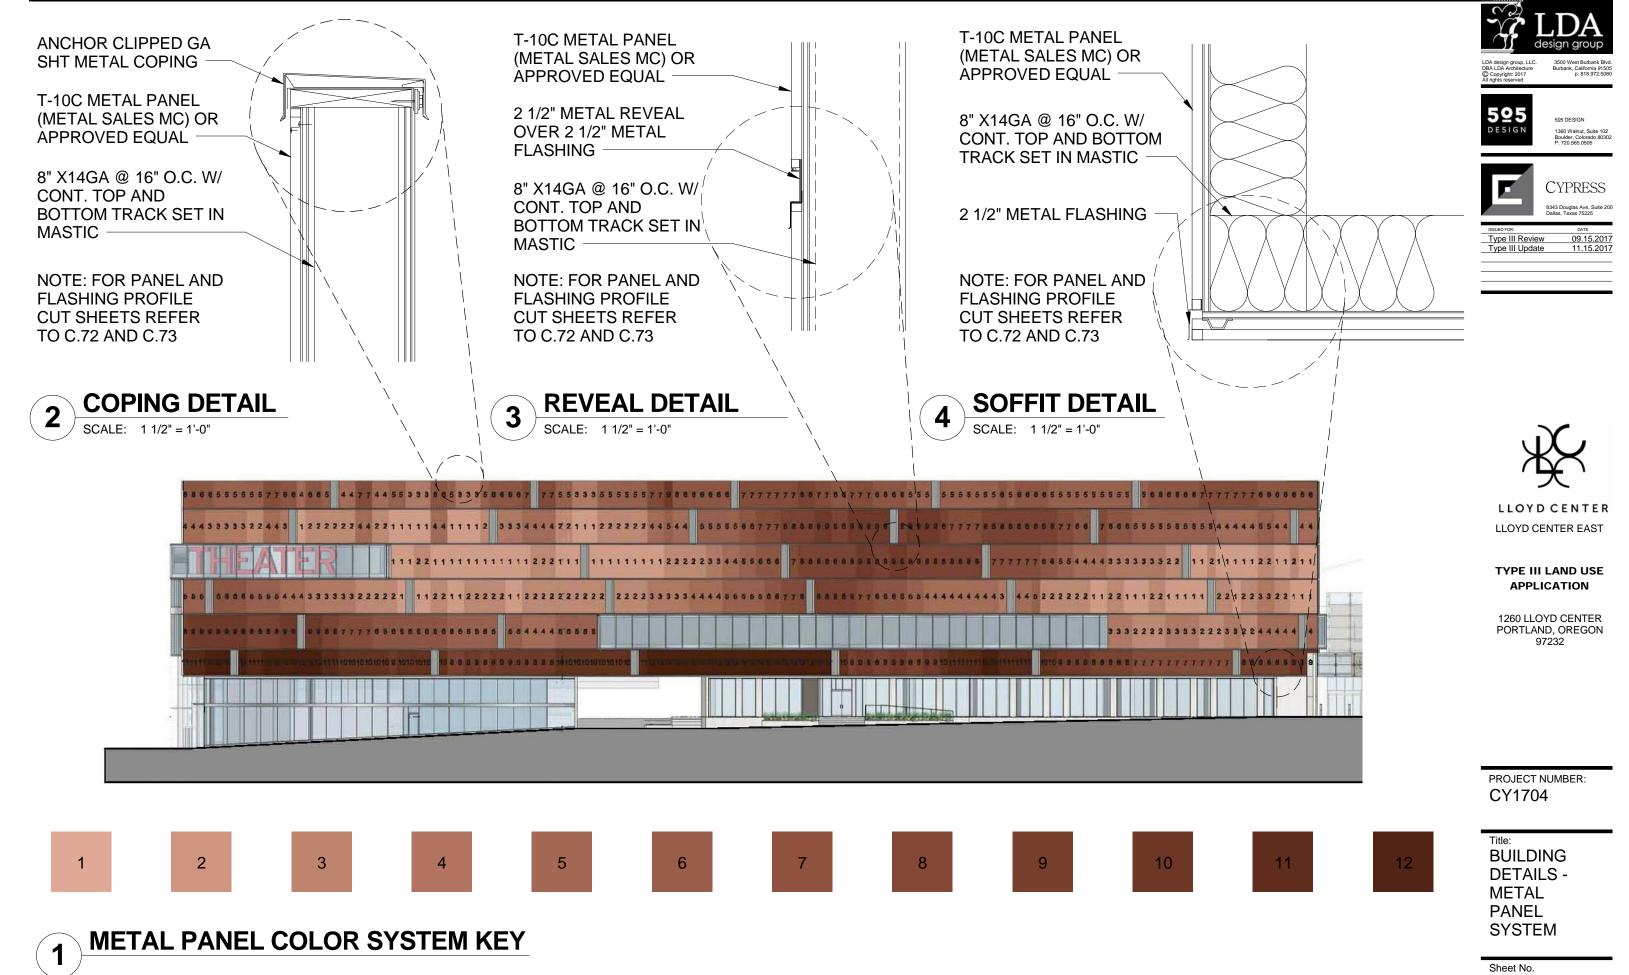






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Title: BUILDING **DETAILS** -DIMENSIONAL **FACADE PANELS** 

Sheet No.




Pedestrian view at Multnomah and 15th St.

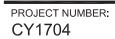


Panels occur every "24 frames" (24 panels) apart and signify one second of motion.



Internally illuminated box with a double layer of perforated metal to produce moire-effect

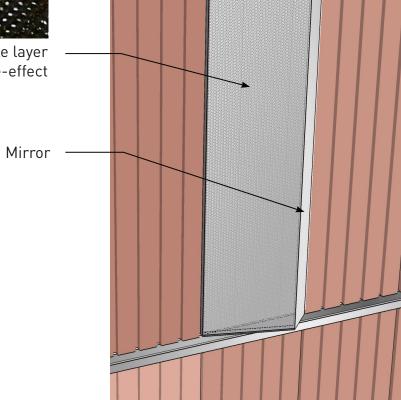

PERSPECTIVE

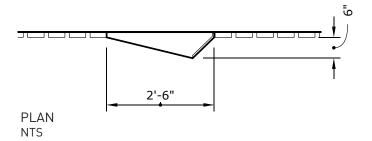



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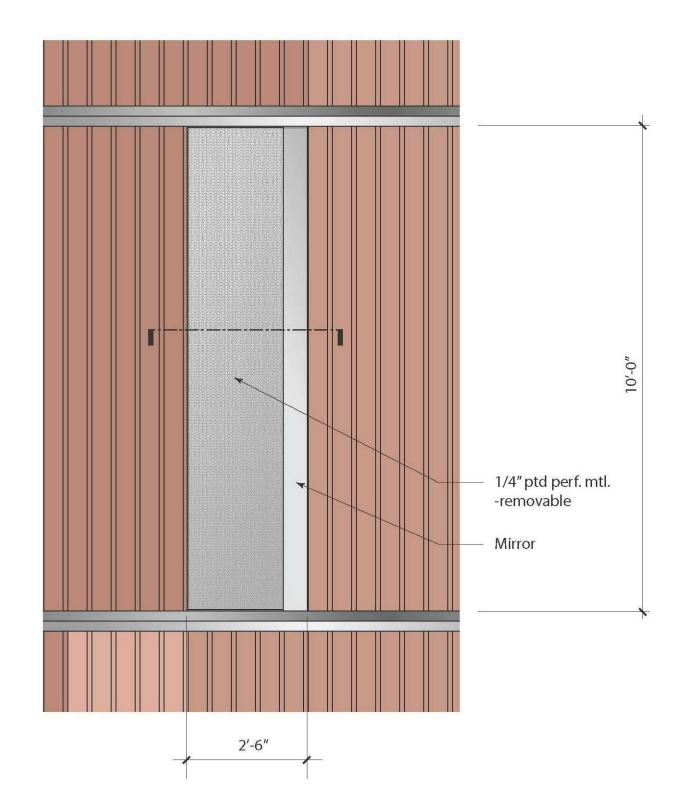
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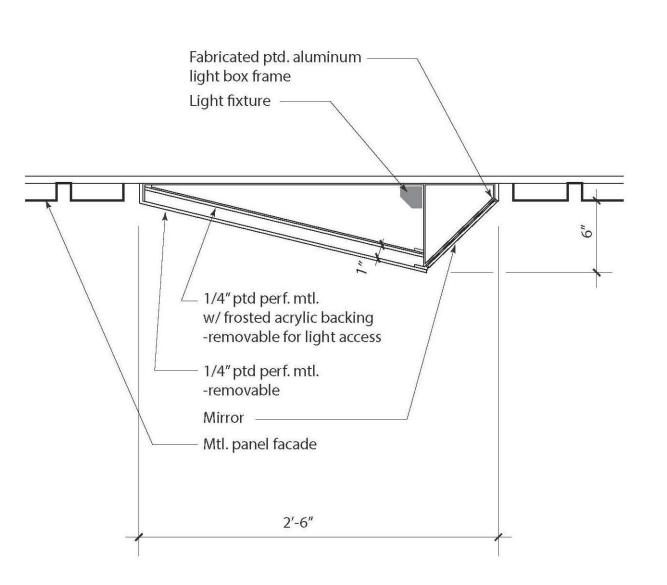
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BUILDING
DETAILS METAL
PANEL LIGHT
EXTRUSION

Sheet No.

C.29






### **ELEVATION - METAL PANEL LIGHT EXTRUSION**

SCALE: 1/2" = 1'-0"



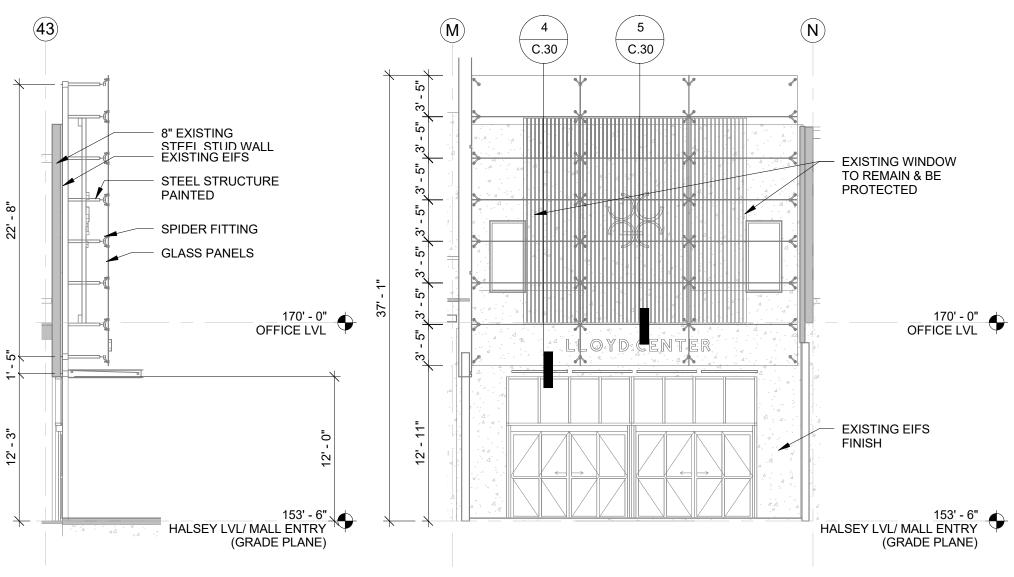





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**SIGN 1 - PHOTO** SCALE: 1/8" = 1'-0"

> HSS TUBE STEEL W/ PAINTED WOOD FINISH

GLASS PANEL W/ SPIDER FITTING


HSS TUBE STEEL

PROJECT NUMBER: CY1704

**BUILDING DETAILS** -**SIGNAGE** 

Sheet No.

C.30

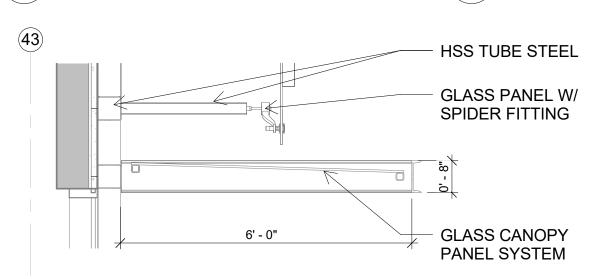

**SIGN 1 - SECTION** 

SCALE: 1/8" = 1'-0"

**Canopy Detail** 

SCALE: 1/2" = 1'-0"


3' - 4 1/4" 43

**SIGN 1 - ELEVATION** 

SCALE: 1/8" = 1'-0"

**Wood Slat Detail** 

SCALE: 1/2" = 1'-0"

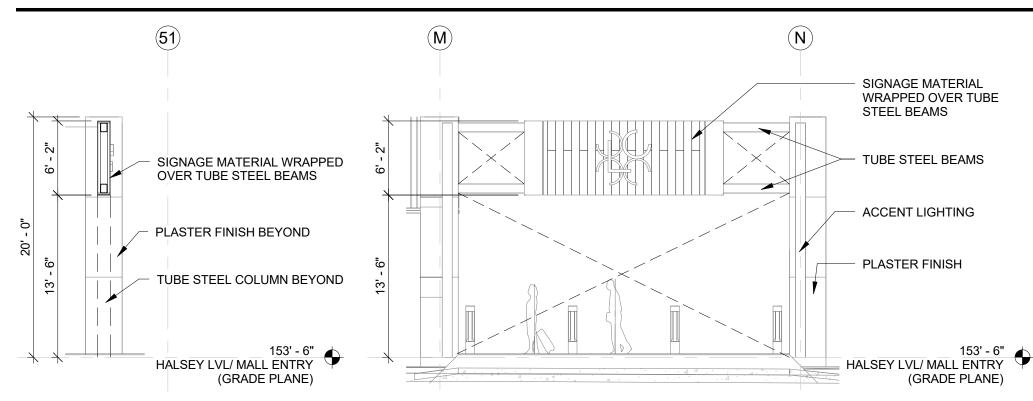

1

. 4





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Dallas, Texas 75225

 Type III Review
 09.15.2017

 Type III Update
 11.15.2017



/ SCALE: 1/8" = 1'-0"

EXISTING CONCRETE COLUMN

1/2" GFRC & 5/8" DENS GLASS OVER 2 1/2"x 20 GA MTL. STDS.

12"X12" COOLEDGE EXTERIOR

FIX/CASEMENT WINDOW 2600 SERIES INTERMEDIATE

FIX/CASEMENT WINDOW

WATERPROOF FLASHING

SAW CUT AND DRY PACK CONT.

TILE LIGHT

2600 SERIES

SIGN 2 - ELEVATION

SCALE: 1/8" = 1'-0"

3 SIGN 2 - RENDER

SCALE: 1/8" = 1'-0"

TYPE III LAND USE APPLICATION

LLOYD CENTER

LLOYD CENTER EAST


1260 LLOYD CENTER PORTLAND, OREGON 97232

PROJECT NUMBER: CY1704

Title: BUILDING DETAILS -SIGNAGE

Sheet No.

C.31

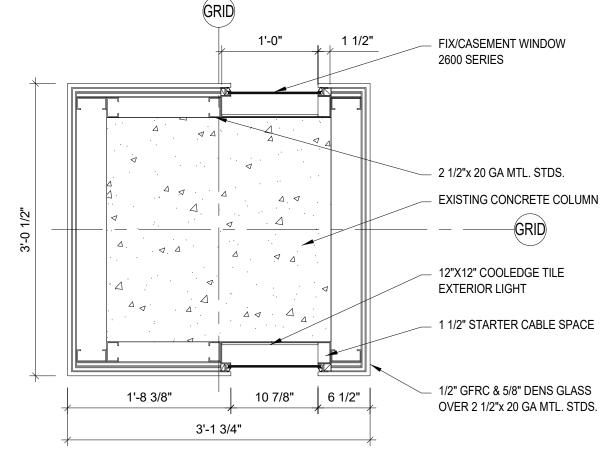


### **COLUMN LIGHT SECTION**

<sup>)</sup> SCALE: 3" = 1'-0"

5 COLUMN LIGHT PLAN

1

SCALE: 1" = 1'-0"

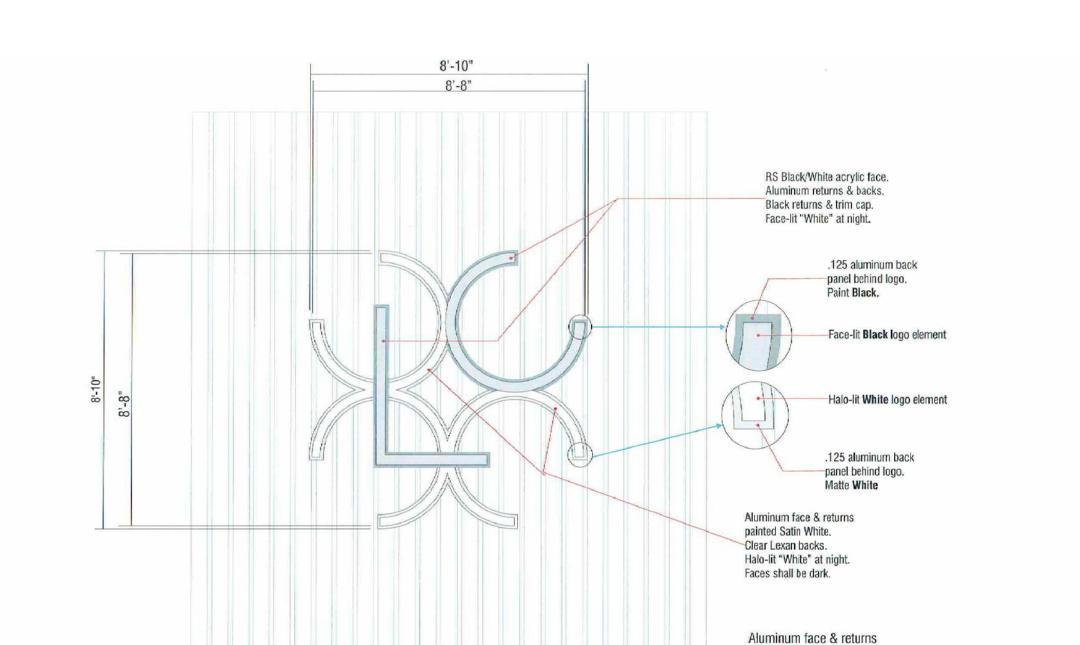

16'-6"

painted Satin Black. Nonilluminated.

If back of letters are visible,

Apply a Black vinyl set of letters to 2nd surface.

Mount to face of glass (verify mounting method)

3-1/2"

STOREFRONT GLASS PANELS

FRONT OF LOGO

space elements from

.125 aluminum back panel behind logo.

background 1-1/2"

wood slat background

1-1/2" deep nonilluminated

"LLOYD CENTER" copy.

Mount to face of glass. VERIFY MOUNTING METHOD.

on storefront.

3/8" = 1-0"









EAST END RENOVATION

#### TYPE III LAND USE APPLICATION

1260 LLOYD CENTER PORTLAND, OR 97232

PROJECT NUMBER: CY1401

SIGN **DETAILS** 

Sheet No.

#### LLOYD CENTER MALL SUPERBLOCK AREA CALCULATIONS

#### 2017.06.08

	AREAS, CURRENT	AREAS, 1988 ACTION NOTICE	NOTES
Area site	1,056,416 sf	1,032,186 sf	
Plaza/atrium requirement (5% total	20,000 sf	51,609 sf	
site area, 20,000 sf max.)			
Area vacated streets	373,800 sf	324,000 sf	
Open space requirement (50% total area of vacated streets)	186,900 sf	162,000 sf	1988 agreement states that ½ of required area (81,000 sf) must be exterior space. 50% of the interior open space (40,500 sf) must be a minimum of 20 feet in height. 40,500 sf of the interior space must be covered in skylights.
PLAZA			
Multnomah Level	51,000 sf		Exterior plaza (26,000 sf) meets current Superblock requirements
Halsey Level	17,900 sf		
Office Level	25,300 sf		
Total	94,200 sf	51,609 sf	Total current plaza area exceeds minimum plaza area required by 1988 Action Notice

	AREAS, CURRENT	AREAS, 1988 ACTION NOTICE	NOTES
EXTERIOR OPEN SPACE			
Multnomah Level	46,100 sf		
Halsey Level	39,900 sf 2,800 sf		
Office Level			
Total	88,800 sf	81,000 sf	Total current exterior open space area exceeds minimum exterior open space area required by 1988 Action Notice
INTERIOR OPEN SPACE			
Multnomah Concourse	87,700 sf		
Halsey Concourse	64,200 sf		
Office Concourse	57,900 sf		
Total	209,800 sf	73,200 sf	Total current interior open space exceeds minimum interior open space area required by 1988 Action Notice (162,000 sf - 88,800 sf = 73,200 sf)

# LLOYD CENTER CENTER LLOYD CENTER EAST

87,700 SF

51,000 SF

### TYPE III LAND USE APPLICATION

**CYPRESS** 

Type III Review
Type III Update


09.15.2017 11.15.2017

1260 LLOYD CENTER PORTLAND, OREGON 97232

PROJECT NUMBER: CY1704

Title: SUPER BLOCK DIAGRAMS

Sheet No.

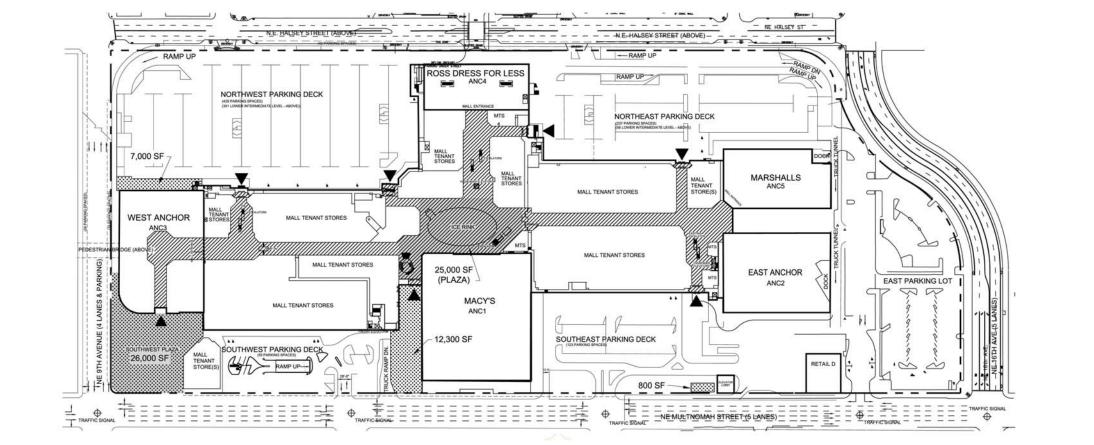





EXTERIOR OPEN SPACE 20,100 SF

PLAZA AREAS

MALL CONCOURSE ENTRANCE







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### LLOYD CENTER HALSEY LEVEL

### LEGEND: INTERIOR OPEN SPACE

EXTERIOR OPEN SPACE 39,900 SF PLAZA AREAS 17,900 SF

64,200 SF

MALL CONCOURSE ENTRANCE



LLOYD CENTER EAST

#### **TYPE III LAND USE APPLICATION**

1260 LLOYD CENTER PORTLAND, OREGON

### LLOYD CENTER **OFFICE LEVEL**

LEGEND:

INTERIOR OPEN SPACE

57,900 SF

2,800 SF

PLAZA AREAS 25,300 SF

MALL CONCOURSE ENTRANCE


EXTERIOR OPEN SPACE

PROJECT NUMBER: CY1704

Title:


**SUPER BLOCK DIAGRAMS** 


Sheet No. C.34

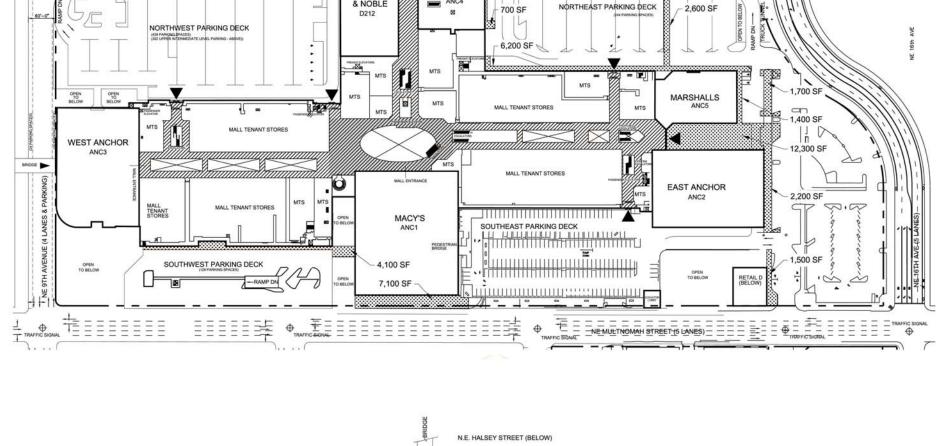

ANC4

BARNES & NOBLE

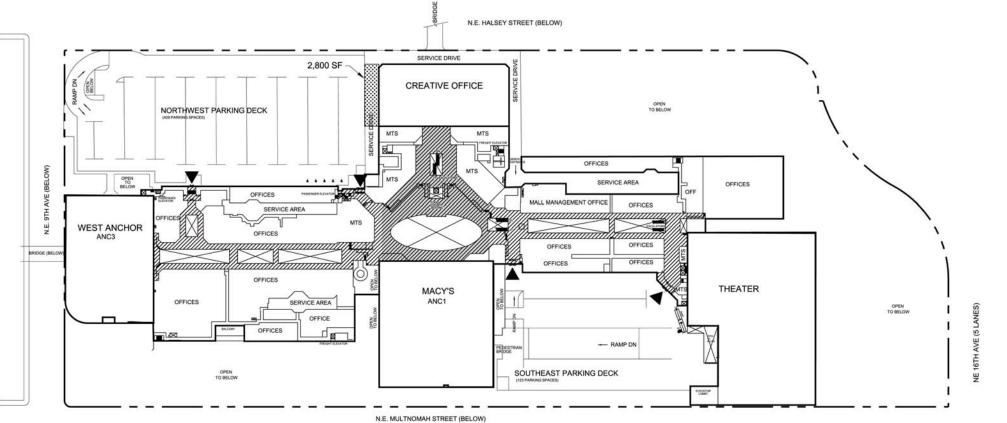

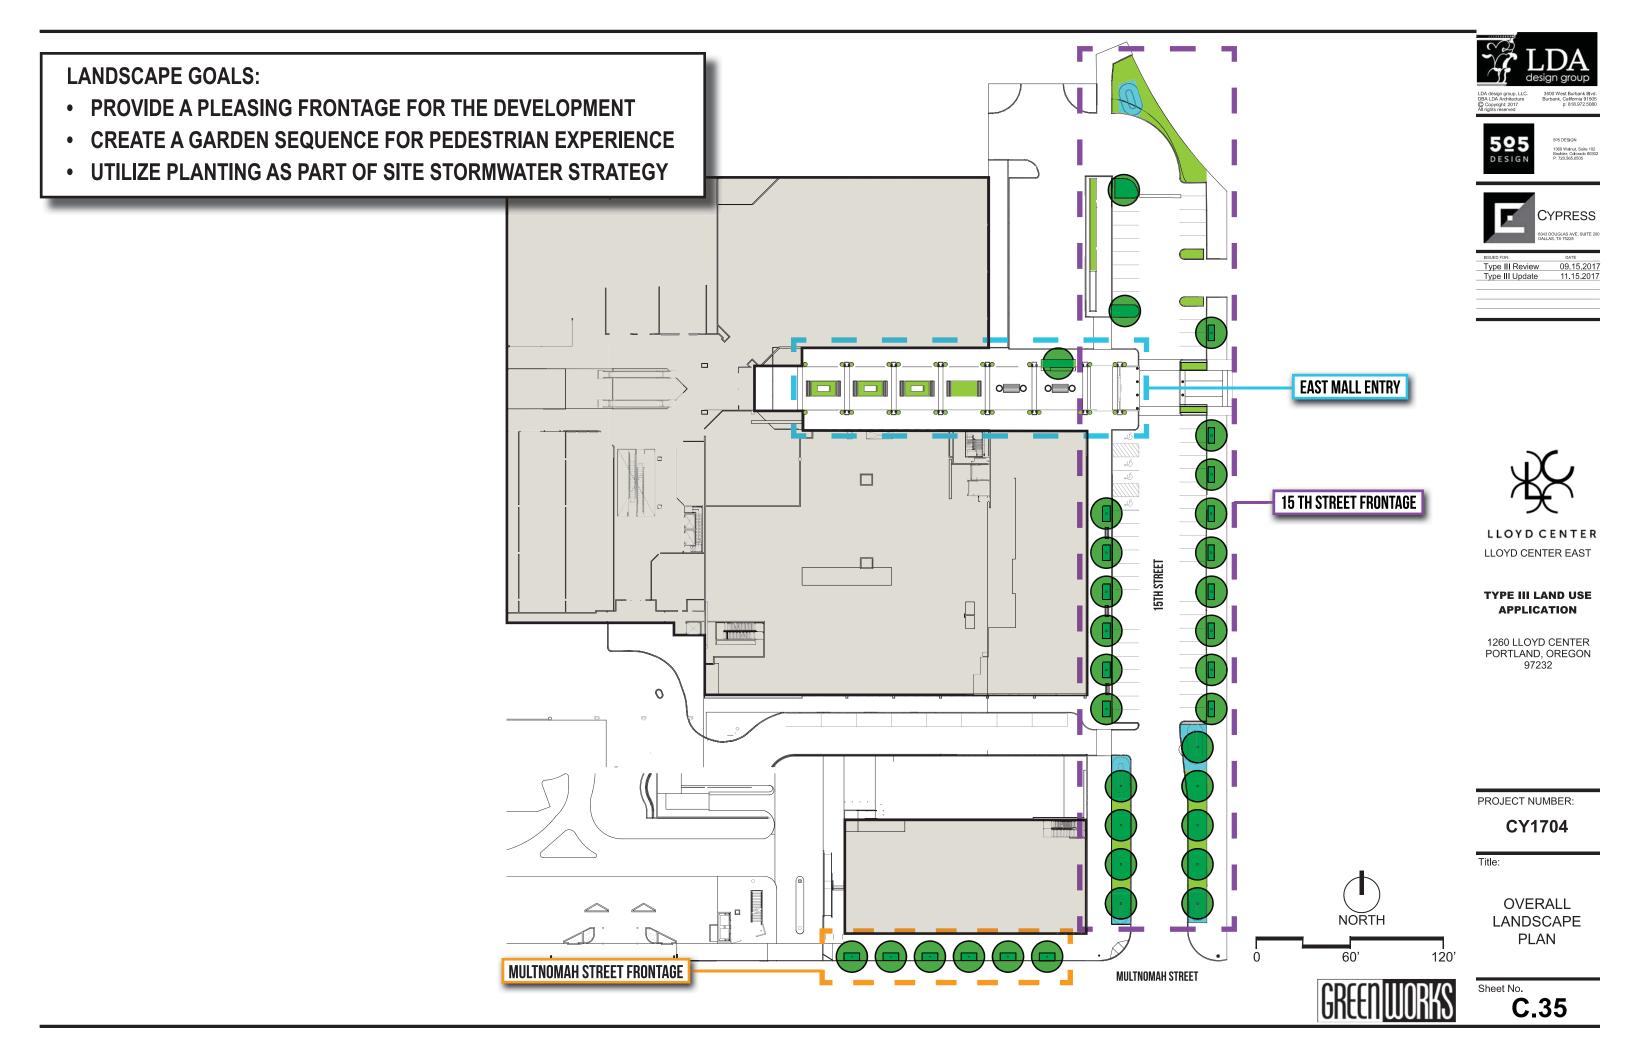


### **GARDEN PLANTER INSPIRATION**







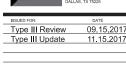




LLOYD CENTER LLOYD CENTER EAST

TYPE III LAND USE APPLICATION

1260 LLOYD CENTER PORTLAND, OREGON 97232



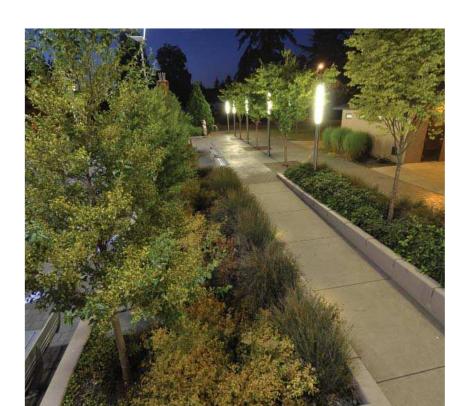



PROJECT NUMBER:

CY1704

Title:

INSPIRATION **IMAGES** 



Sheet No.

# STORMWATER PLANTER INSPIRATION












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TYPE III LAND USE APPLICATION

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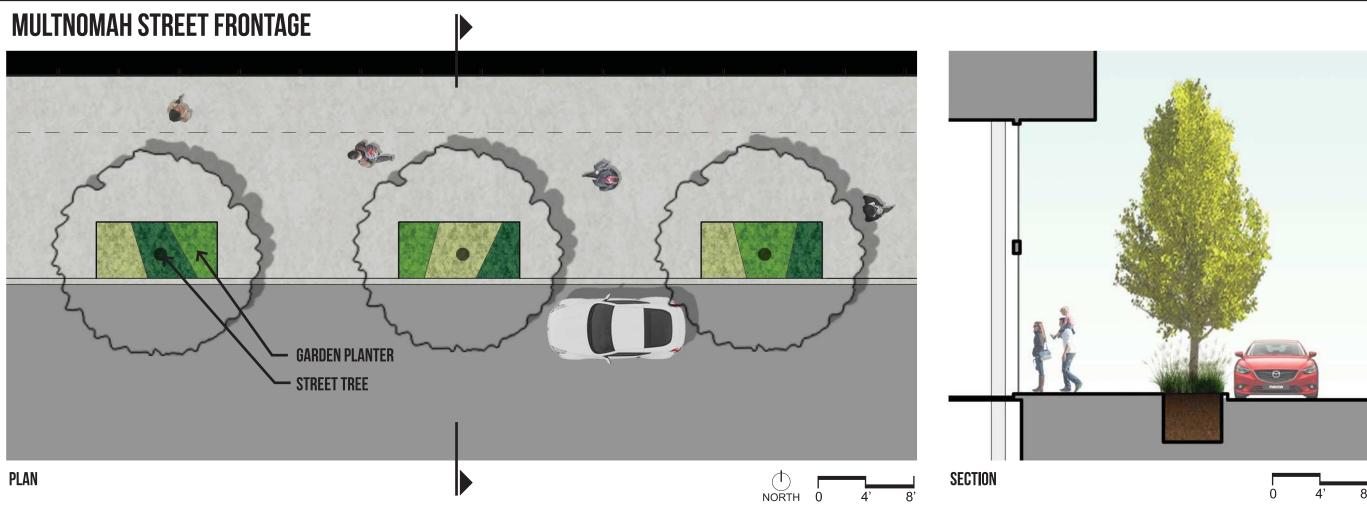
PROJECT NUMBER: CY1704

Title:

INSPIRATION **IMAGES** 

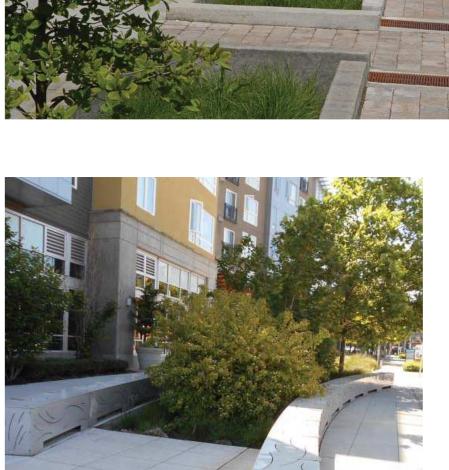

Sheet No.





Ginkgo biloba / Ginkgo

Viburnum opulus 'Nanum' / **Dwarf Cranberry Bush** 

Loropetalum chinense / Emerald Snow Loropetalum Carex oshimensis / Evergold Sedge

Loropetalum chinense / Purple Pixie Loropetalum Pennisetum alopecuroides / Cassian Pennisetum Festuca cinera / Blue Fescue

Gaultheria shallon / Salal

Ophiopogon nigrascens / Black Mondo Grass Seasonal Color / Tulip







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LLOYD CENTER EAST

TYPE III LAND USE **APPLICATION** 

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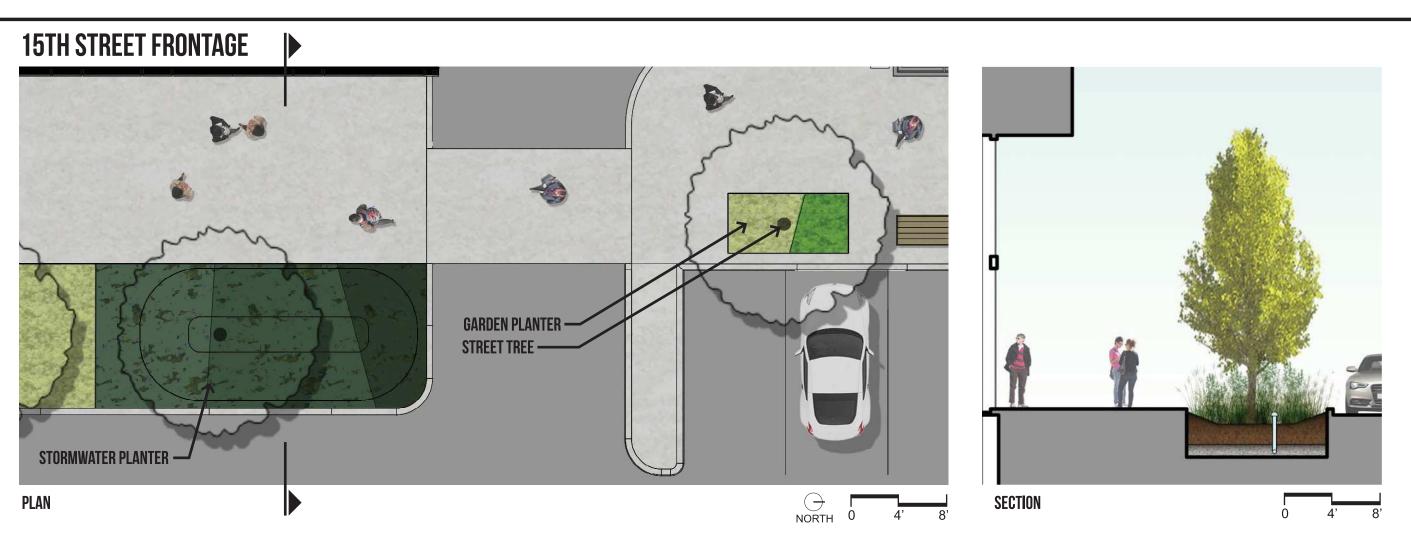
PROJECT NUMBER:

CY1704

Title:

MULTNOMAH STREET FRONTAGE

Sheet No.





Gleditsia triacanthos / Honey Locust Honey Locust (fall color)

Cornus sericea 'Kelseyi' / Kelsey's Dwarf Red Twig Dogwood

Polystichum munitum / Sword Fern Camassia quamassia / Camas Lily Seasonal Color / Daffodil Eleocharis ovata / Ovate Spike Rush Carex oshimensis / Evergold Sedge Iris sibirica / Siberian Iris







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Type III Review	09.15.2017
Type III Update	11.15.2017



LLOYD CENTER EAST

#### TYPE III LAND USE **APPLICATION**


1260 LLOYD CENTER PORTLAND, OREGON 97232

PROJECT NUMBER:

CY1704

Title:

15TH STREET FRONTAGE

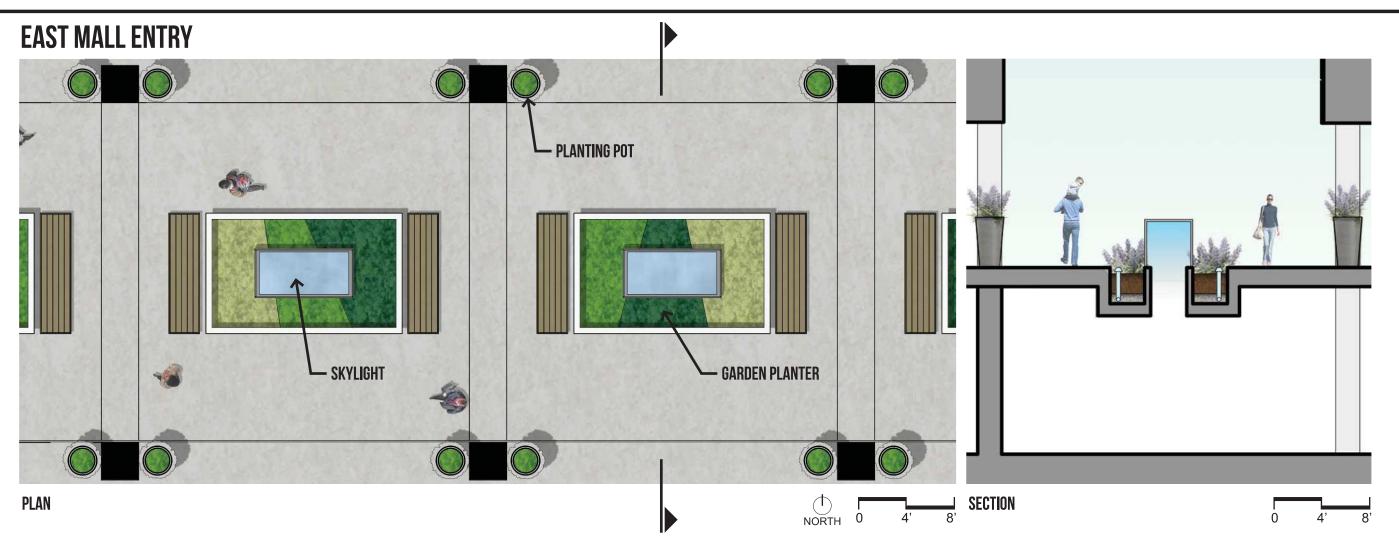



Athyrium filix-femina / Lady Fern

Hosta x 'Guacamole' Pachysandra terminalis / Pachysandra

Gaultheria procumbens / Red Baron Creeping Wintergreen Sarcococca ruscifolia / Sarcococca

Seasonal Color / Coleus



LLOYD CENTER LLOYD CENTER EAST

### TYPE III LAND USE **APPLICATION**

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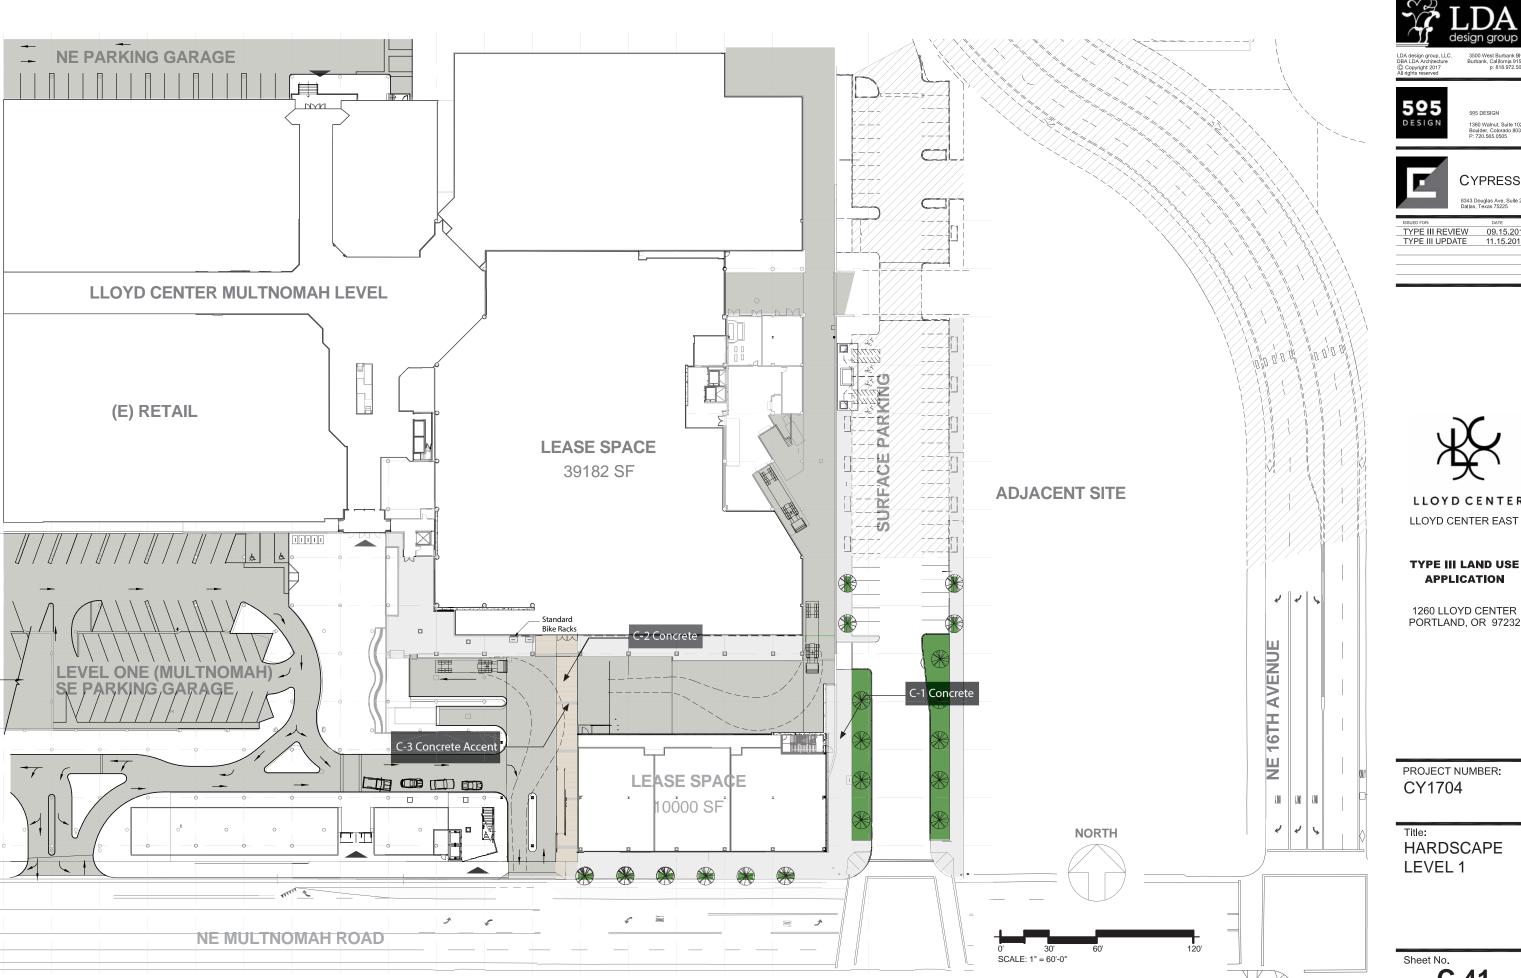
PROJECT NUMBER:

CY1704

Title:

**EAST MALL ENTRY** 

Sheet No. C.40



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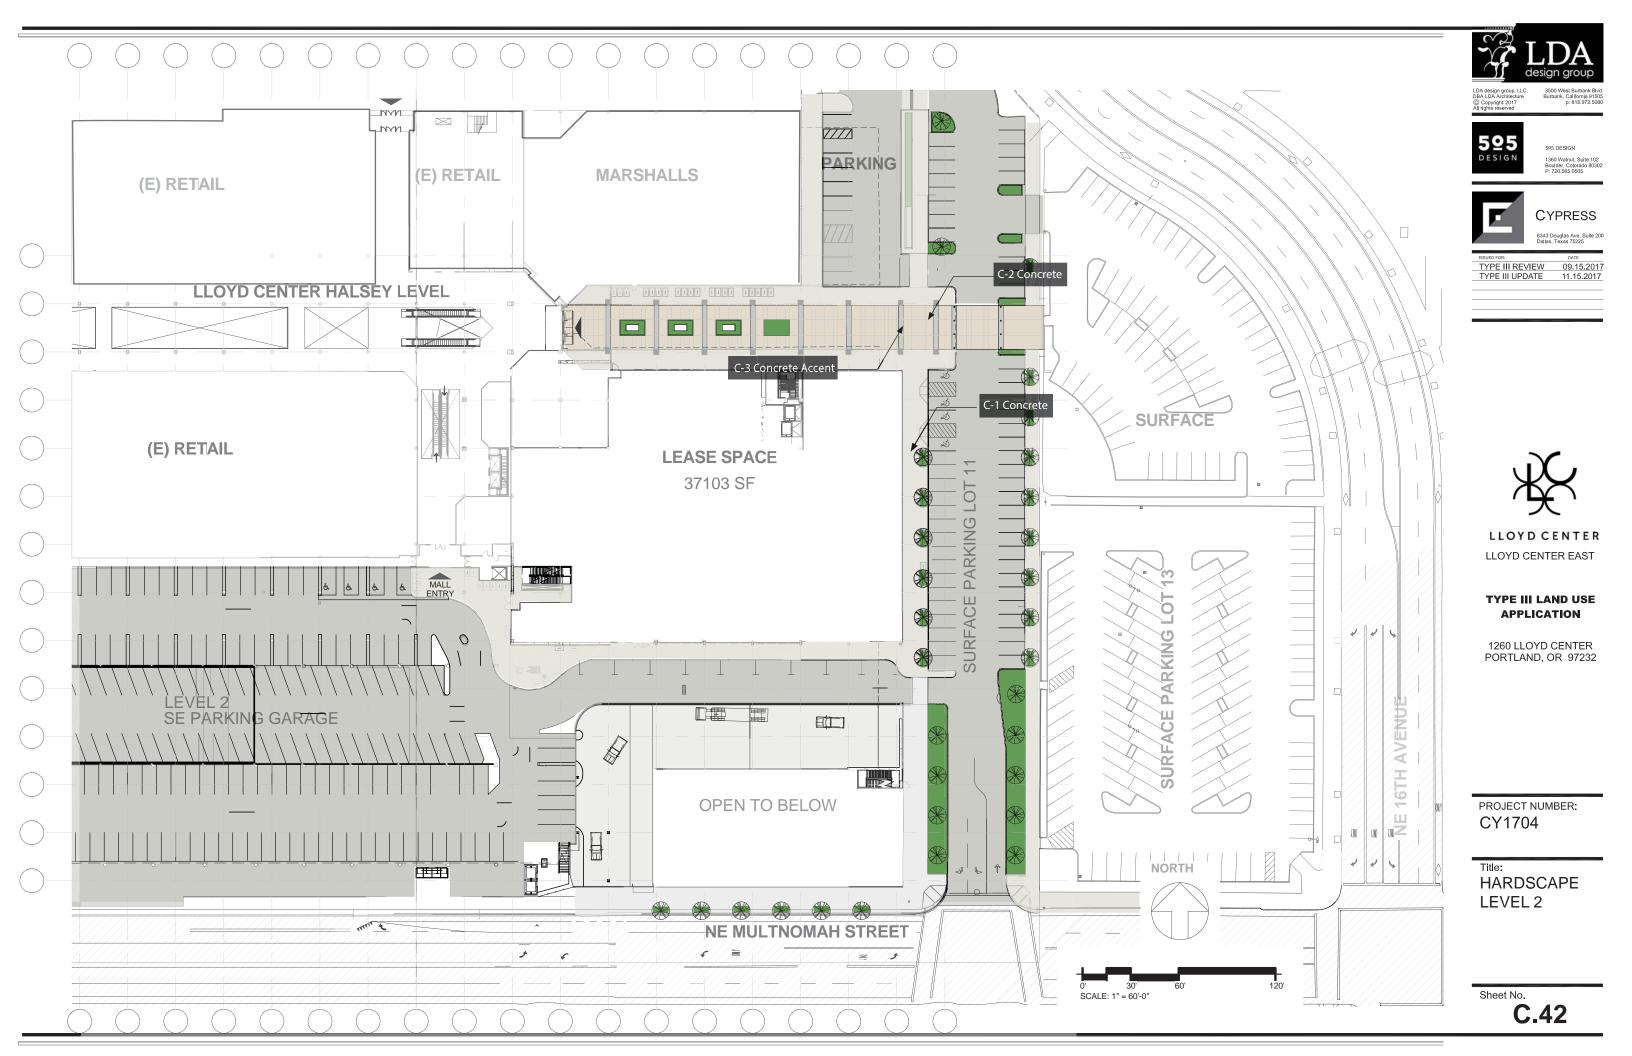
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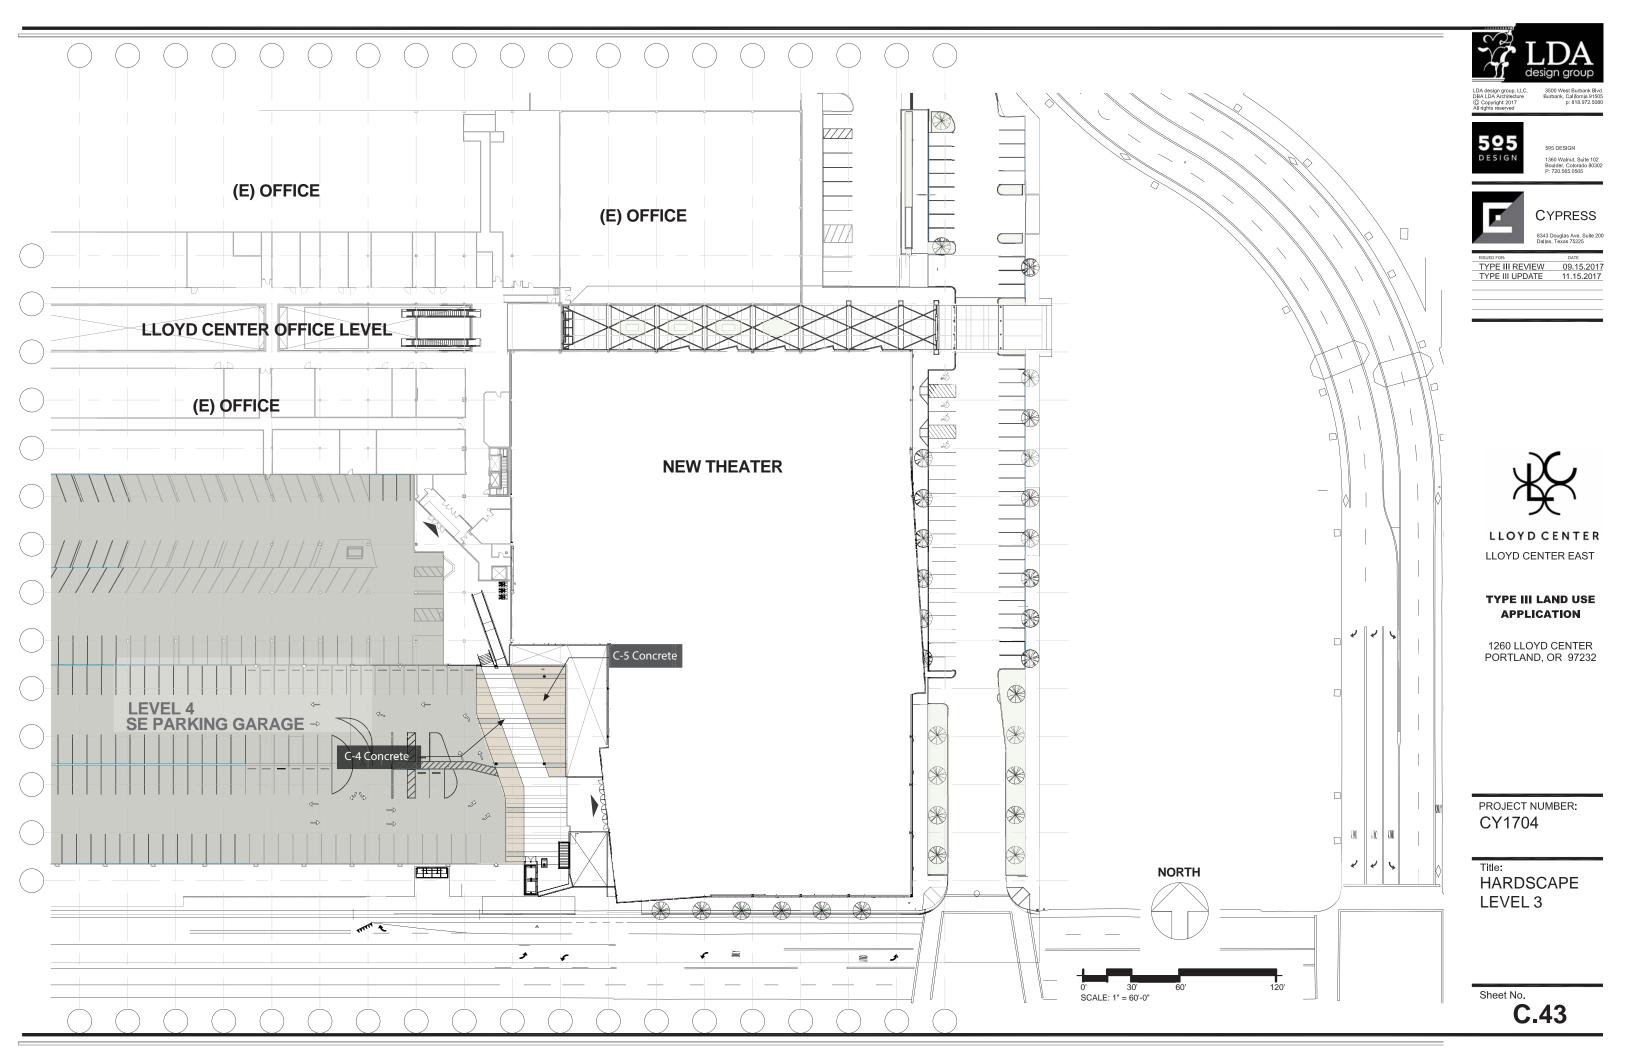


TYPE III LAND USE APPLICATION

1260 LLOYD CENTER PORTLAND, OR 97232

HARDSCAPE





## ANODIZED METAL



AN-1 Anodized Aluminum Mullions - Flashing- Horizontal Break Panels Pop-out - Soffit Frame

## CONCRETE




C-1 Concrete Sidewalk- Mall, Office, Theater, Ramp, Stairs, Truck Drive



C-2 Concrete Sidewalk - Office, Theater Entries, East Entry




C-3 Concrete Sidewalk Accent Office, Theater Entries, East Entry

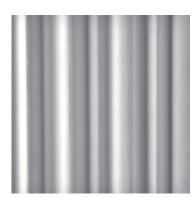

C-6 Concrete Formliner SE Lease Space Facades


## METAL

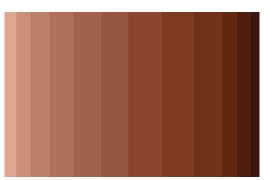

MT-1 - MT-12 Painted Corrugated Metal Panels Theater Facade




MT-11 Wood-Look Metal Plank Theater - Soffit & Circulation Ceiling/Canopy

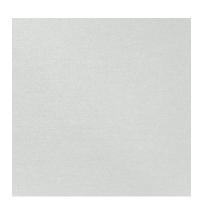

MT-12 Ceiling Metal Panel Satin Anodized Truck Drive



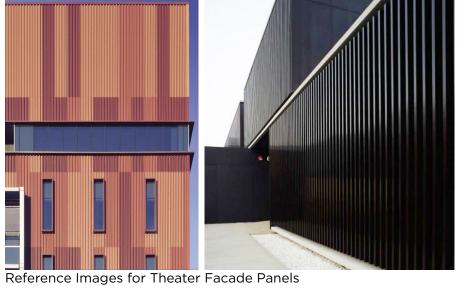



Reference Images for Overall Look of Panels



Reference Images for overall look of panels



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TYPE III UPDATE 11.15.2017

TYPE III LAND USE APPLICATION

1260 LLOYD CENTER PORTLAND, OR 97232

PROJECT NUMBER: CY1704

Title: **MATERIALS** 

Sheet No.

# METAL



MT-13 Powder Coating
Theater Canopy, Office
Window Frame & Handrails,
Entry Columns Metal Reveals



MT-14 Powder Coating
Office Vertical Break Panels

### GFRC

P 5 Glimmer



GFRC-1 Column Cladding East Entry Columns



GFRC-2 Column Cladding Theater & Offices Columns

# TILE



T-1, T-2, T-3 Porcelain Tile Circulation Lobby Wall Office Facade



Reference Images For Installation Pattern



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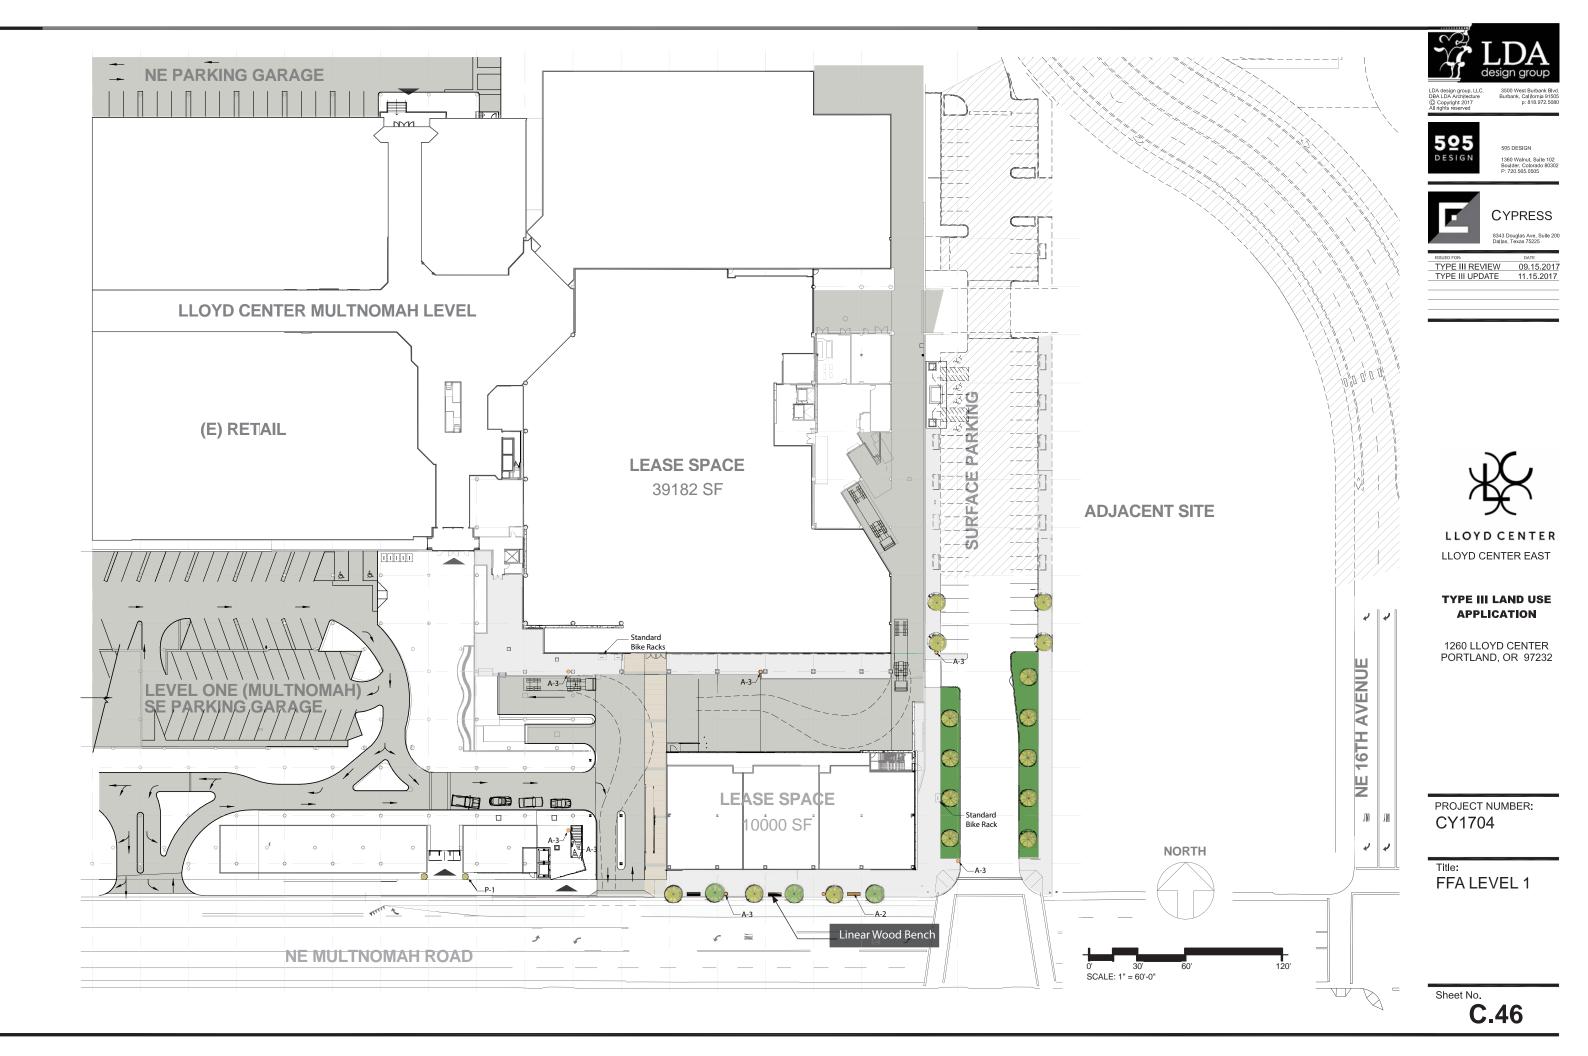
TYPE III LAND USE APPLICATION


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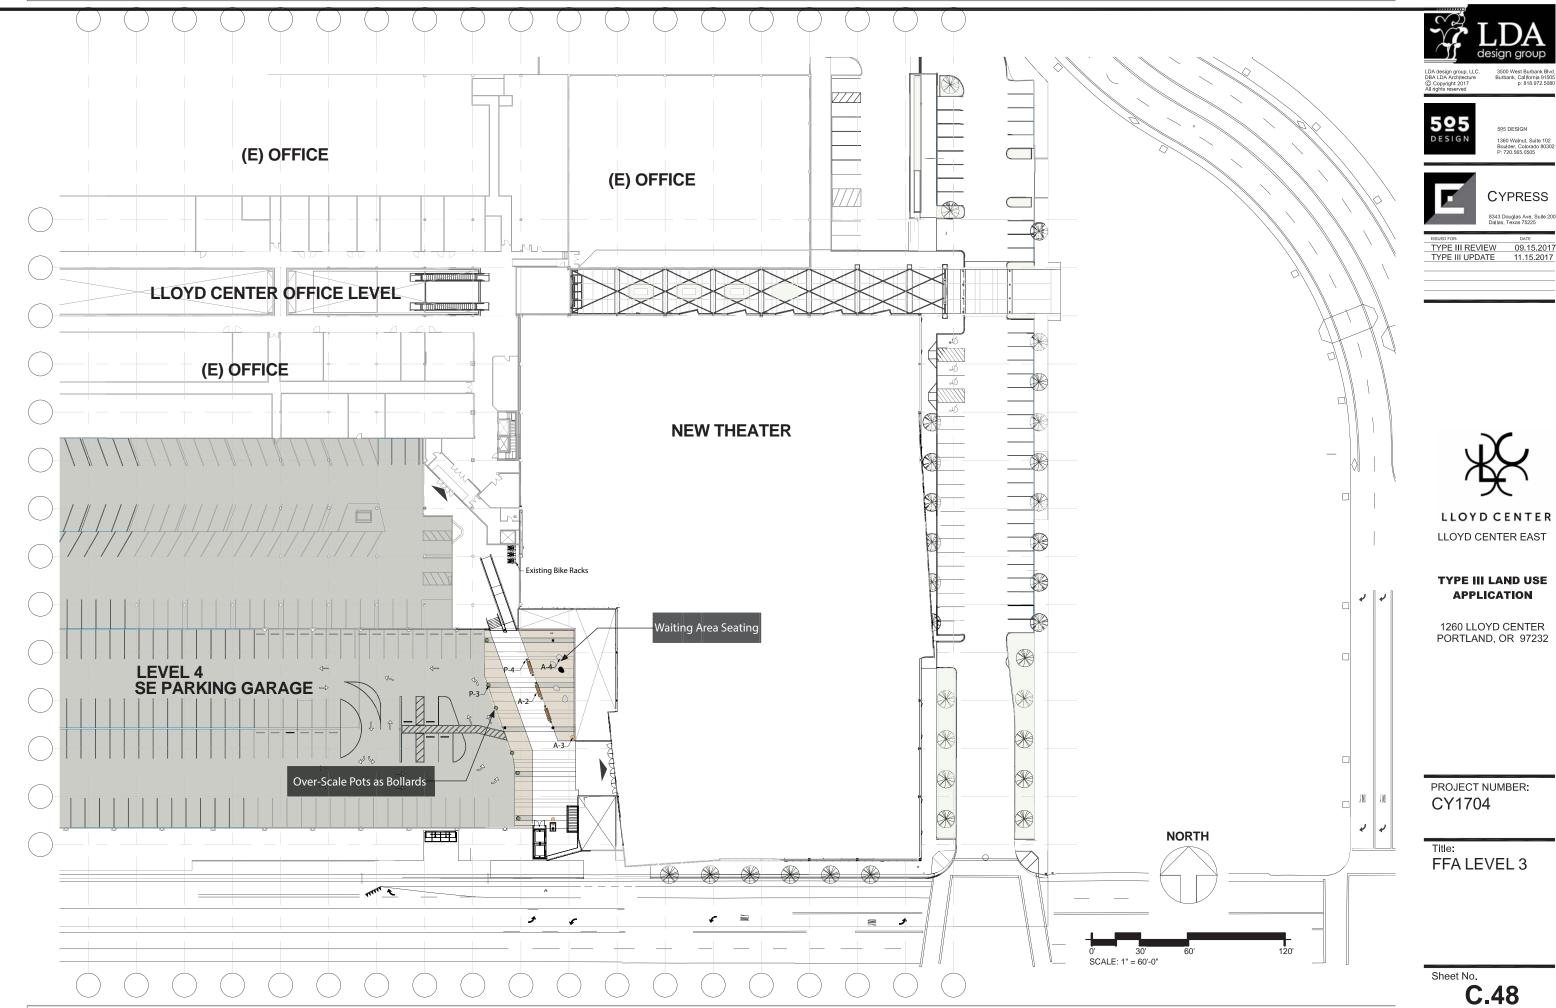
PROJECT NUMBER: CY1704

Title: MATERIALS

Sheet No.





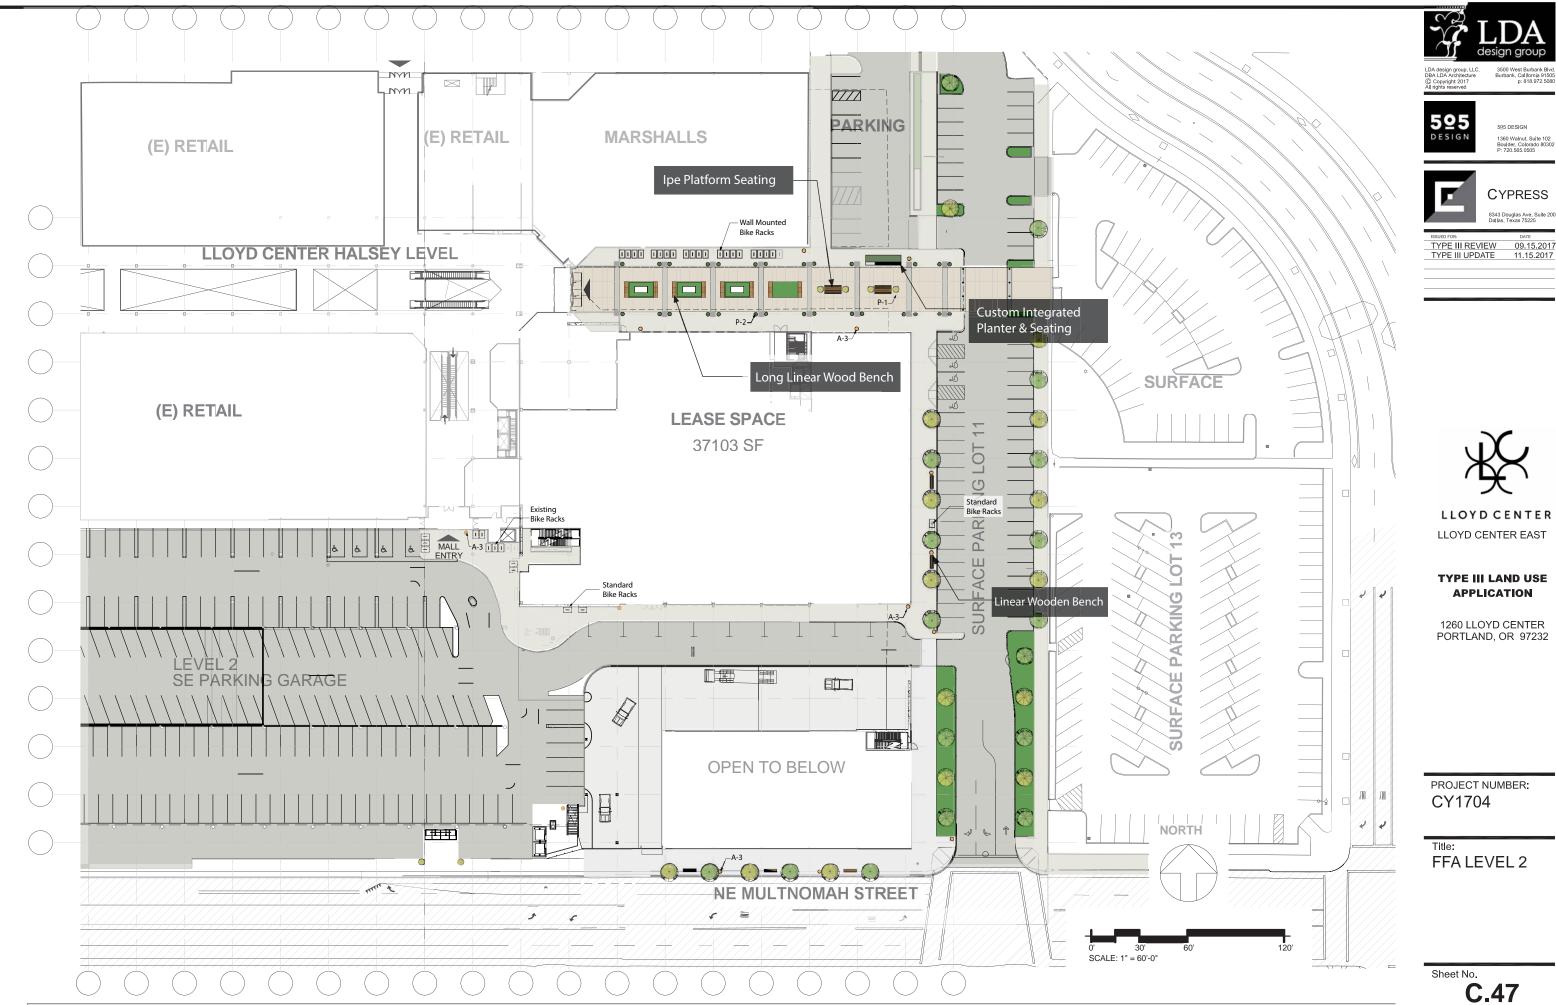





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#### TYPE III LAND USE APPLICATION

1260 LLOYD CENTER PORTLAND, OR 97232

PROJECT NUMBER: CY1704

Title: OUTDOOR **FURNITURE** 

# OUTDOOR FURNITURE











Linear Freestanding Benches - Wood and Powder-Coated Metal





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### TYPE III LAND USE **APPLICATION**

1260 LLOYD CENTER PORTLAND, OR 97232

PROJECT NUMBER: CY1704

Title: OUTDOOR **FURNITURE** 

## POTS














Fired Clay Over-Scaled Pots - East Entry



GFRC Large Over-Scaled Pots - Garage Lobby

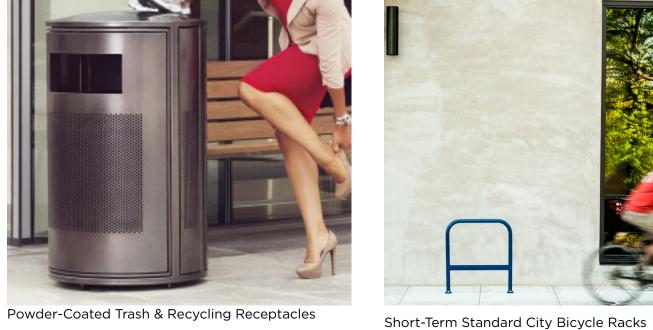




AMENITIES



Long-Term Sheltered Bicylcle Racks

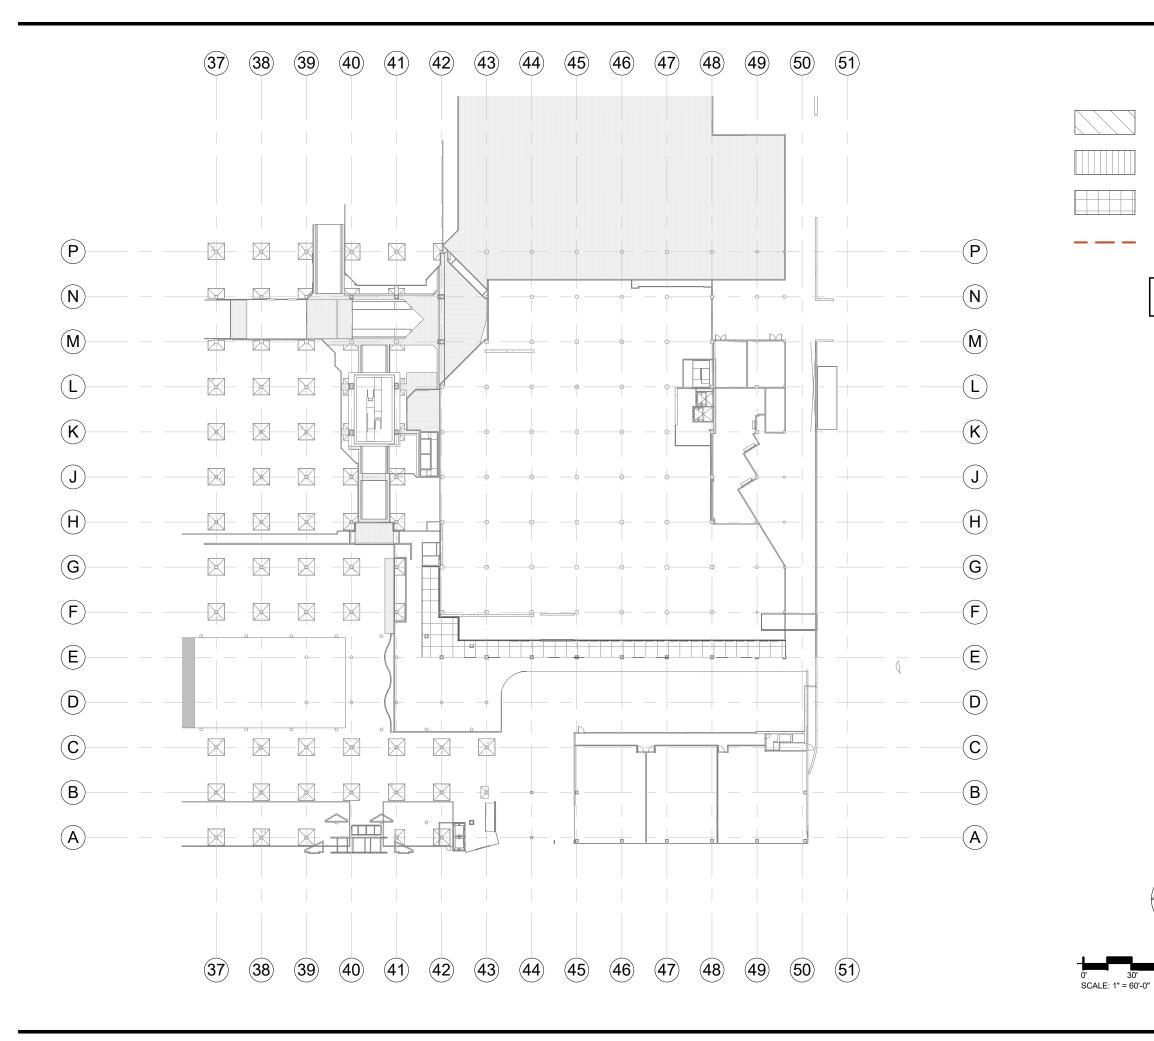



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AN-1 ANODIZED METAL PANEL

MT-11 WOOD-LOOK ANODIZED METAL PLANEL

MT-12 SATIN ANODIZED METAL PANEL

LIGHT COVE REFER TO DETAIL 2/C.24

FOR ADDITIONAL INFORMATION

NORTH

NOTE: REFER TO MATERIAL'S SHEET C.44

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TYPE III LAND USE APPLICATION


1260 LLOYD CENTER PORTLAND, OREGON 97232

PROJECT NUMBER: CY1704

Title:
MULTNOMAH
LEVEL
REFLECTED
CEILING
PLAN

Sheet No.



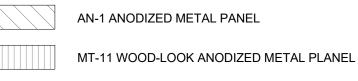

MT-12 SATIN ANODIZED METAL PANEL

LIGHT COVE REFER TO DETAIL 2/C.24

NOTE: REFER TO MATERIAL'S SHEET C.44 FOR ADDITIONAL INFORMATION CYPRESS

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595 DESIGN

**525** DESIGN



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TYPE III LAND USE APPLICATION

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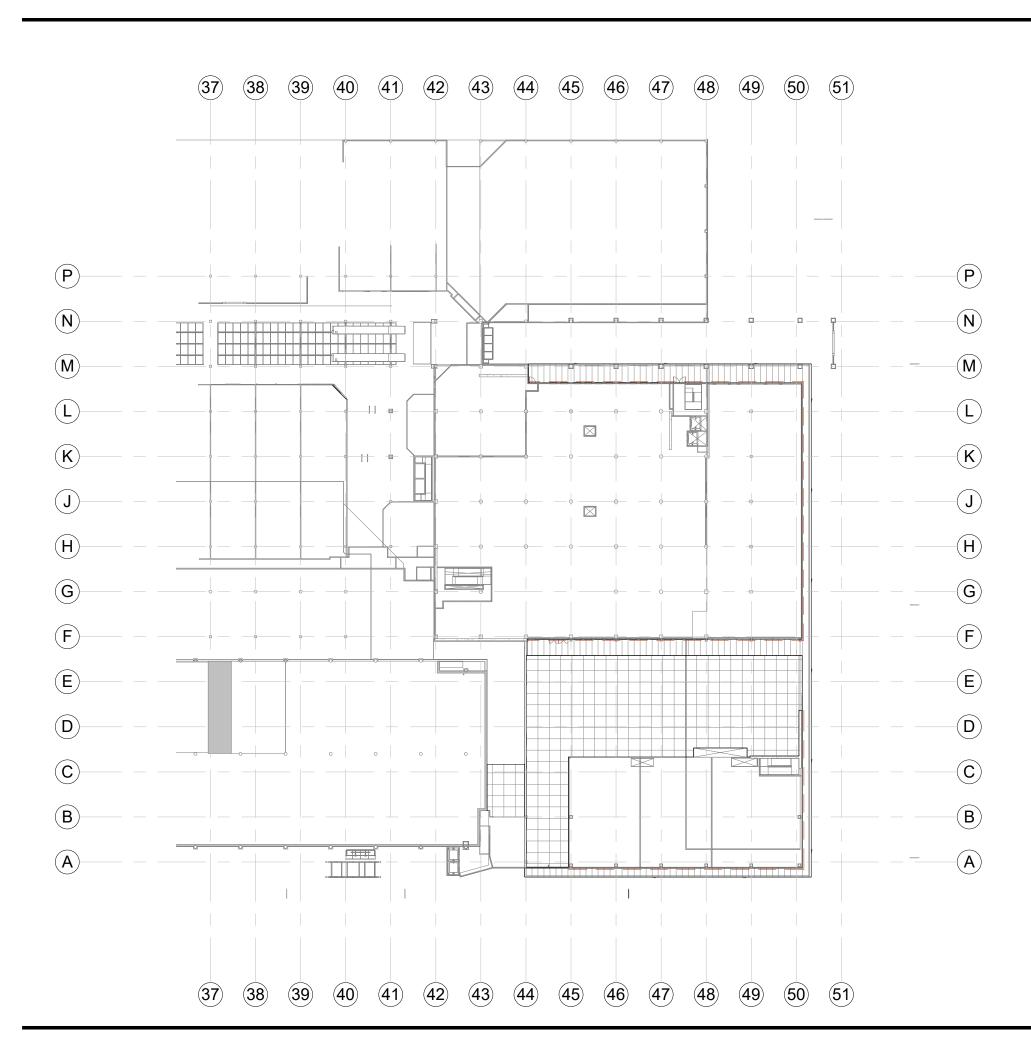
NORTH


30' 60' 120'

PROJECT NUMBER: CY1704

Title:
HALSEY
LEVEL
REFLECTED
CEILING
PLAN

Sheet No.



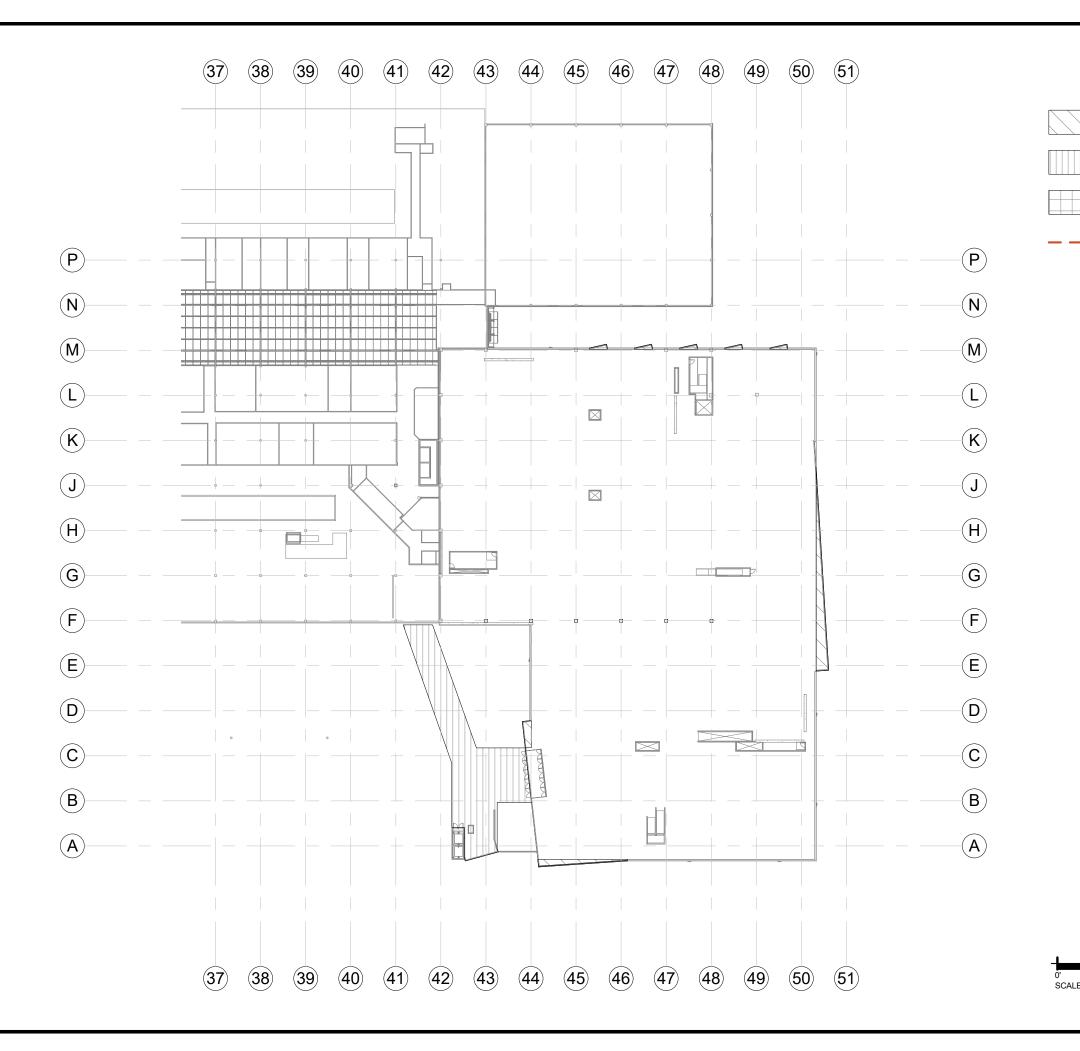



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**525** DESIGN

AN-1 ANODIZED METAL PANEL

MT-11 WOOD-LOOK ANODIZED METAL PLANEL

MT-12 SATIN ANODIZED METAL PANEL

LIGHT COVE REFER TO DETAIL 2/C.24

FOR ADDITIONAL INFORMATION

NORTH

NOTE: REFER TO MATERIAL'S SHEET C.44

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LLOYD CENTER LLOYD CENTER EAST


TYPE III LAND USE APPLICATION


1260 LLOYD CENTER PORTLAND, OREGON 97232


PROJECT NUMBER: CY1704

Title:
THEATER
LEVEL
REFLECTED
CEILING
PLAN

Sheet No.

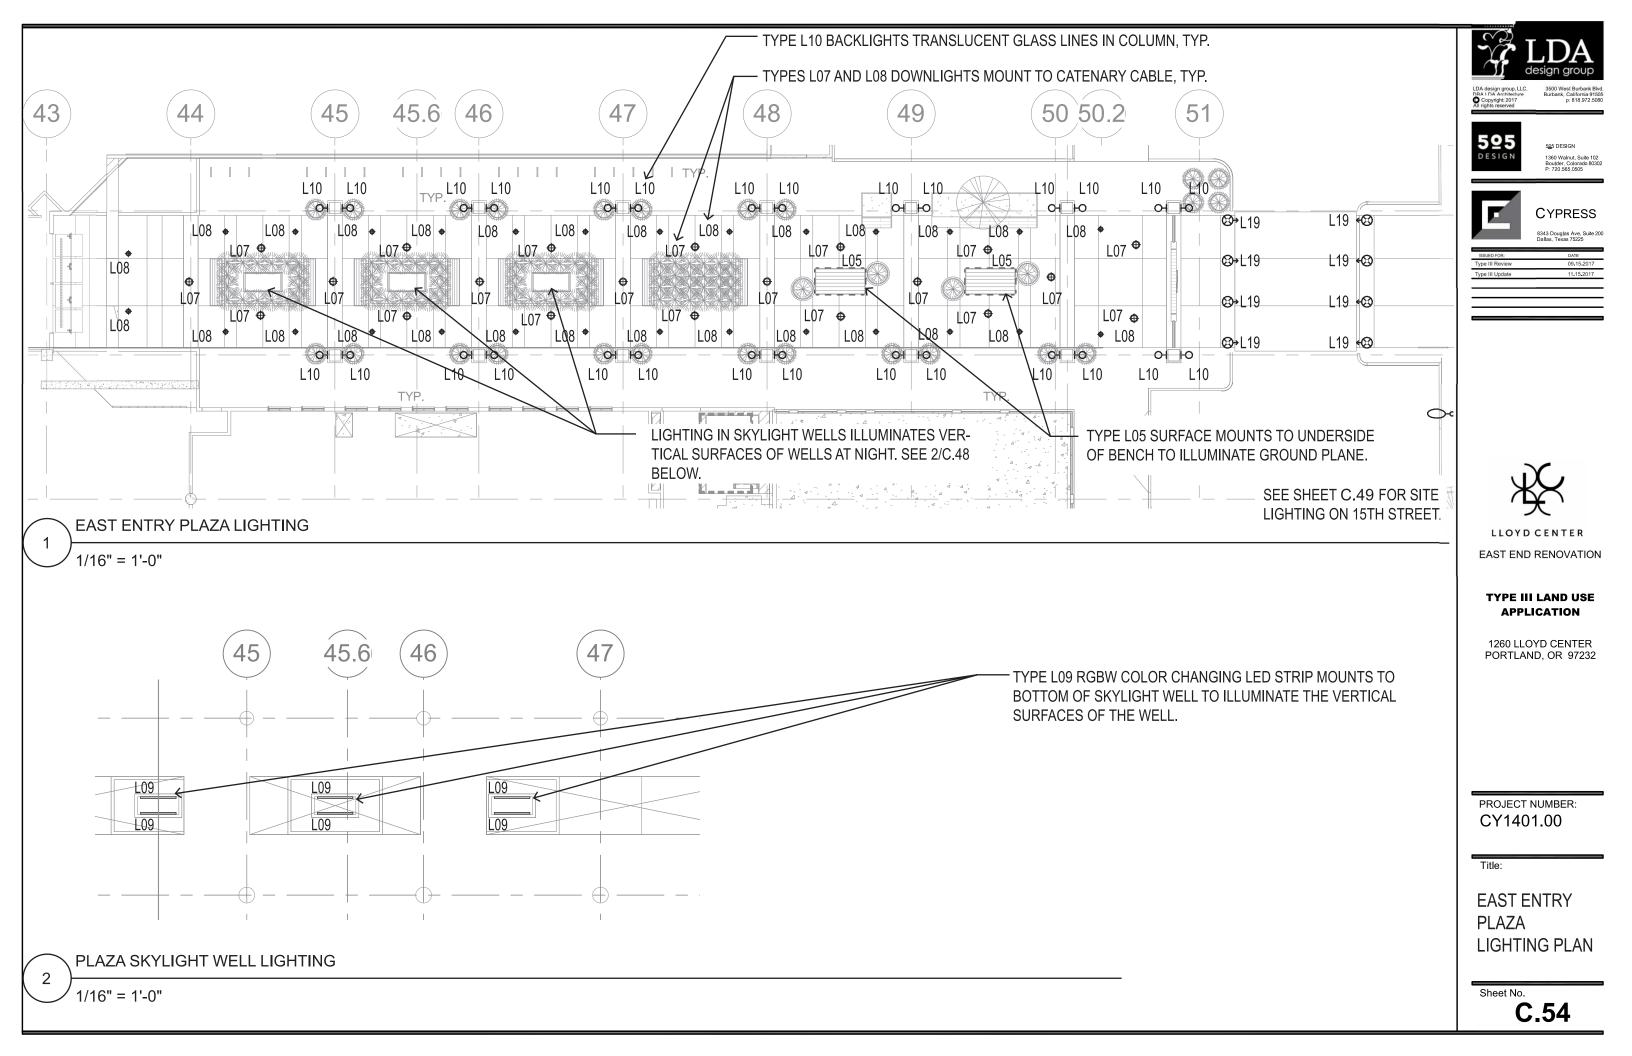

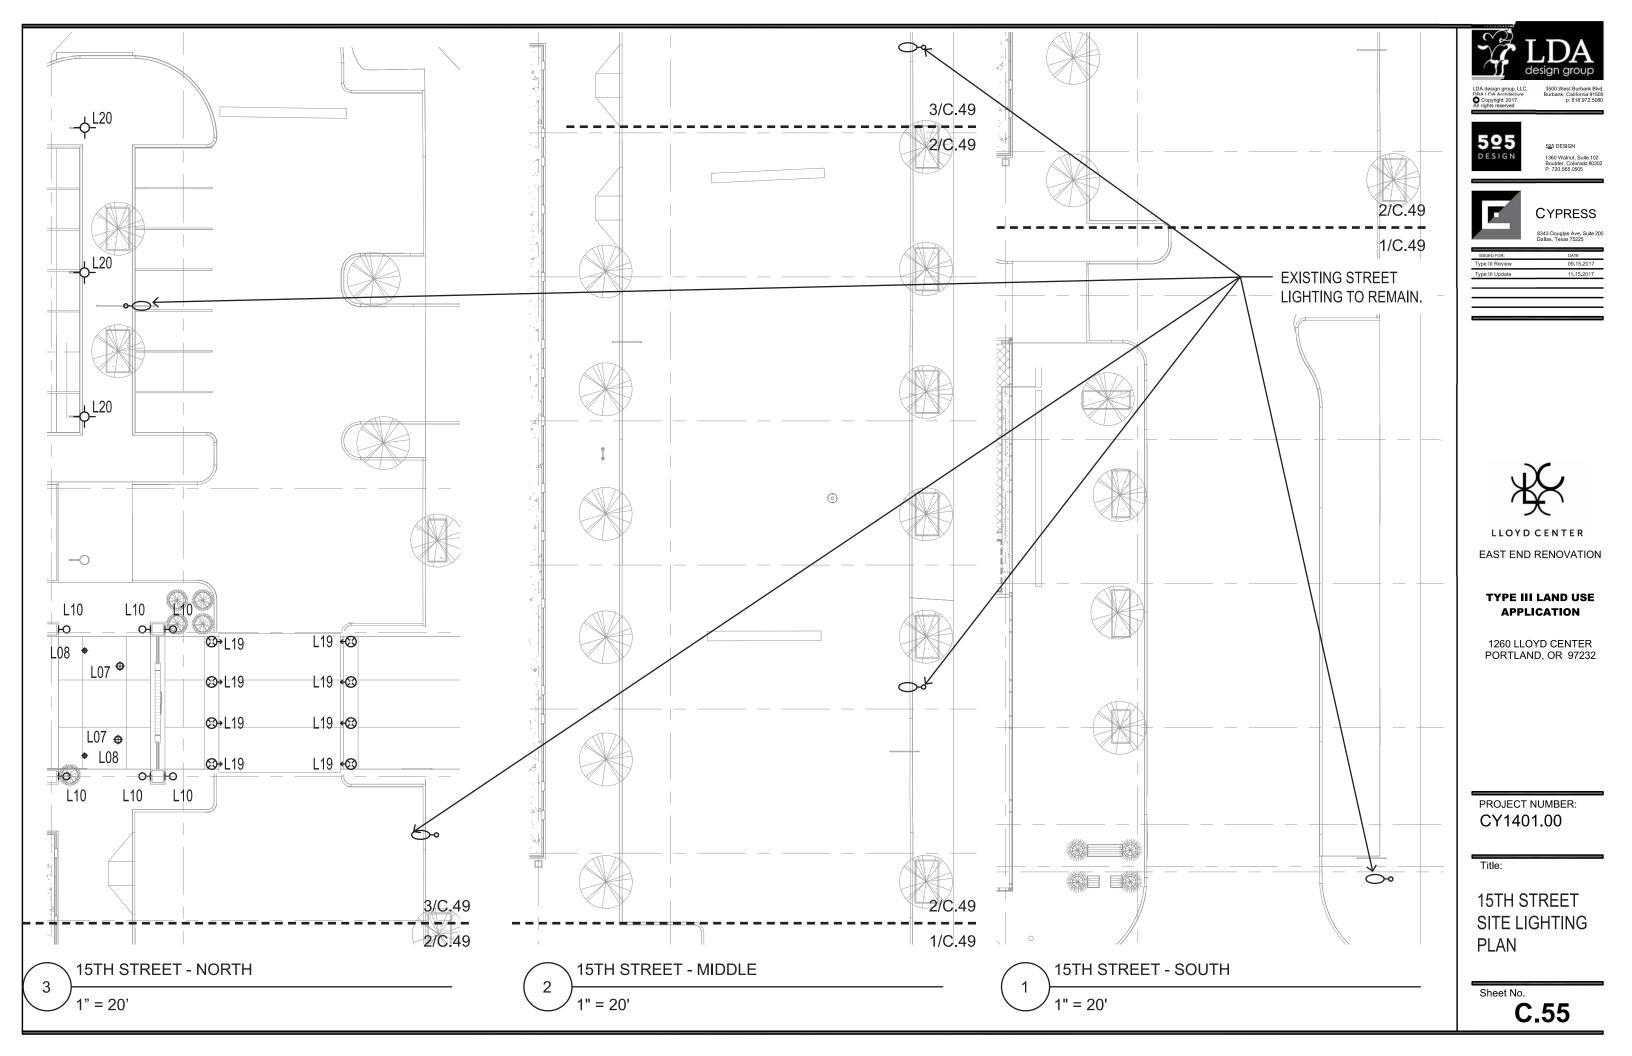

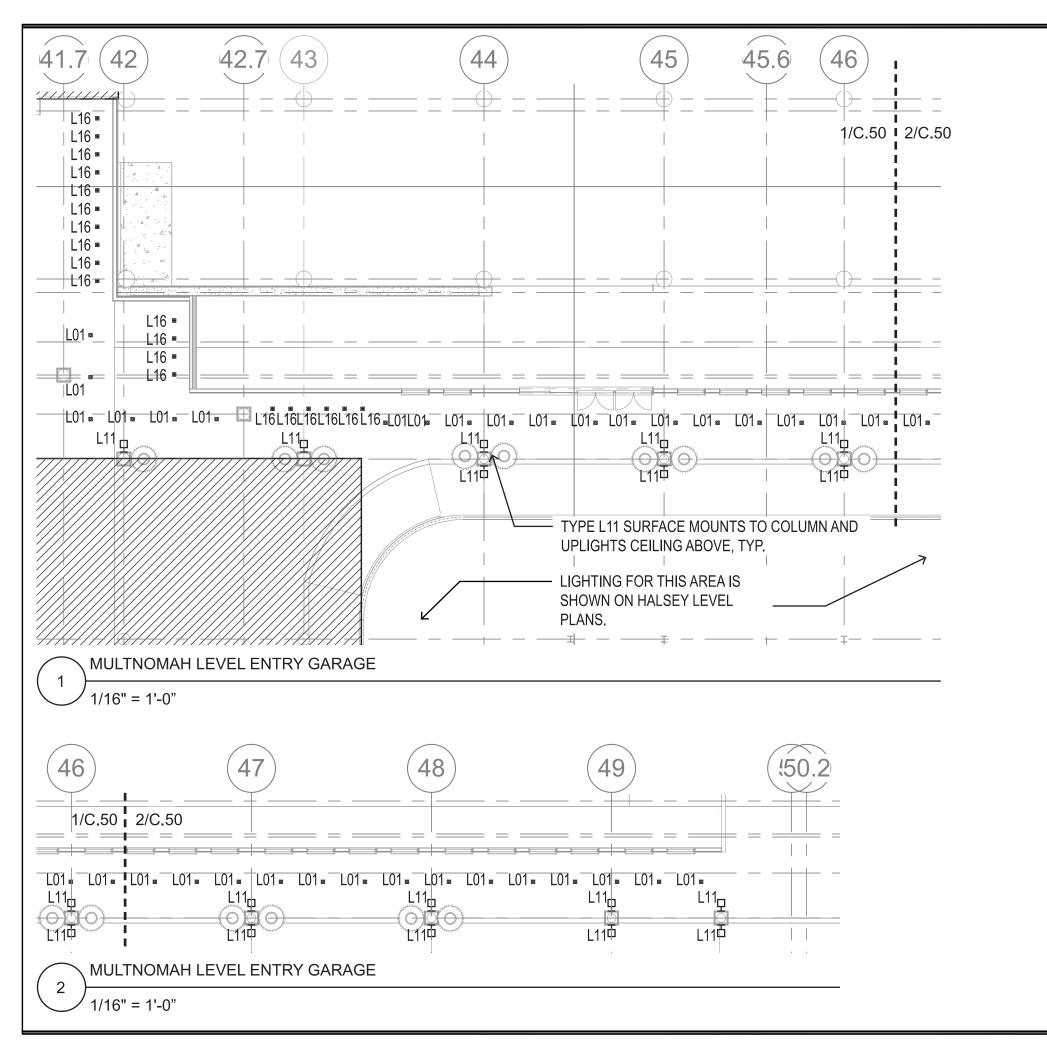



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EAST END RENOVATION

# TYPE III LAND USE APPLICATION


1260 LLOYD CENTER PORTLAND, OR 97232


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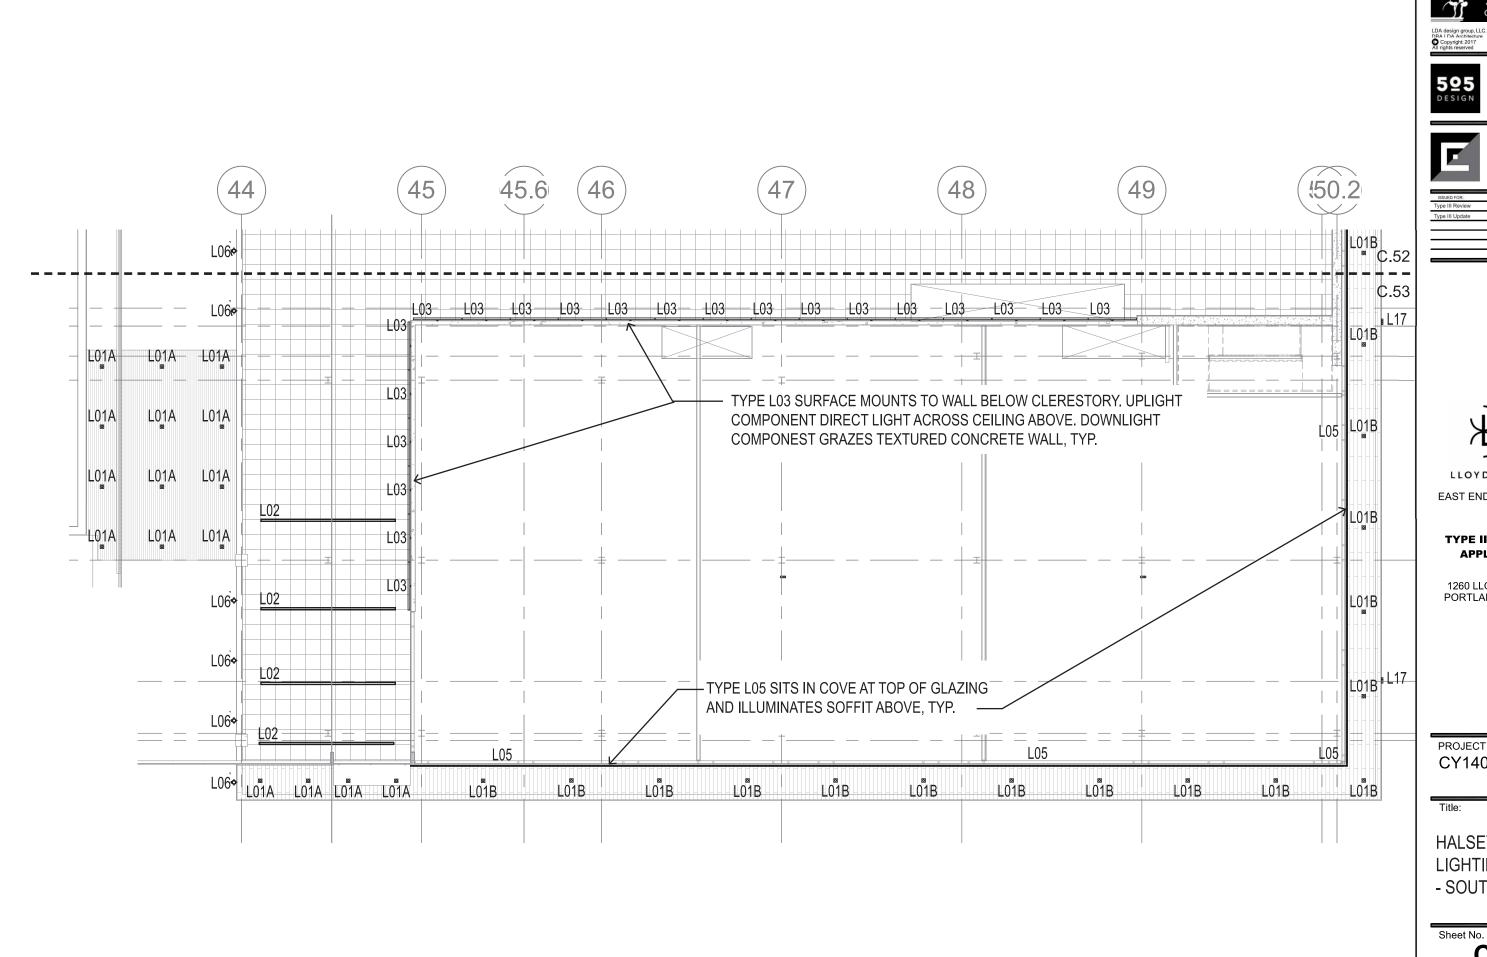
Title

MULTNOMAH LEVEL GARAGE ENTRY LIGHTING PLAN

Sheet No.



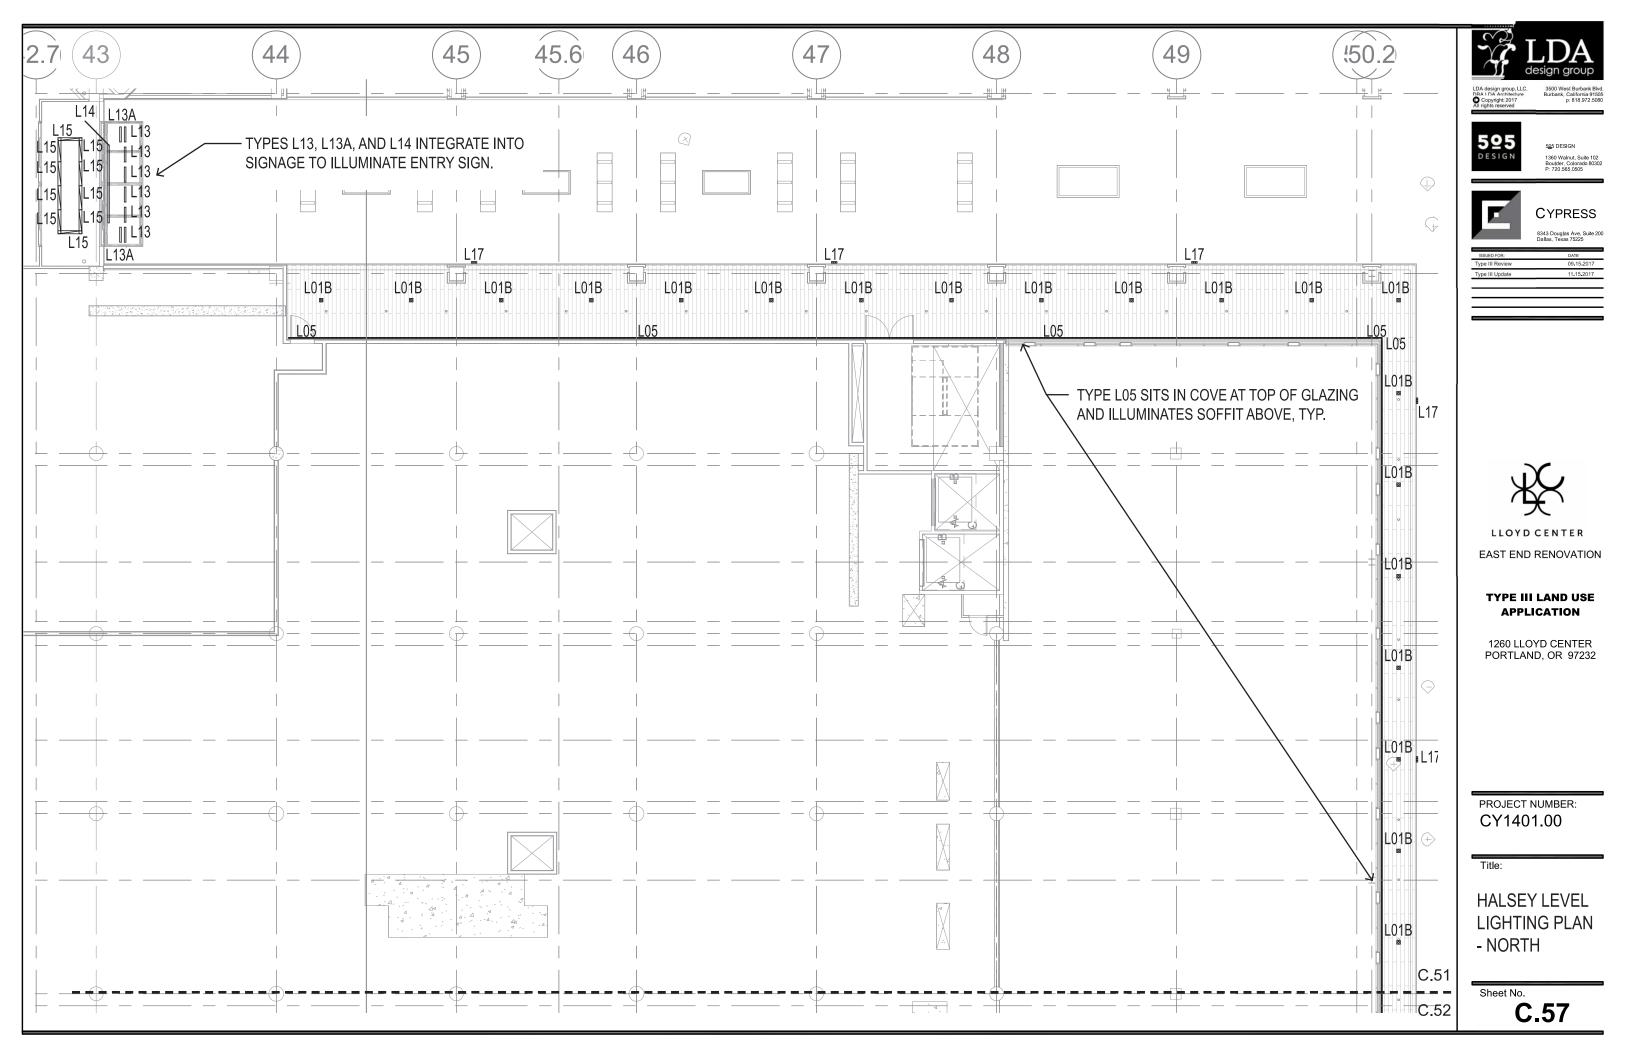

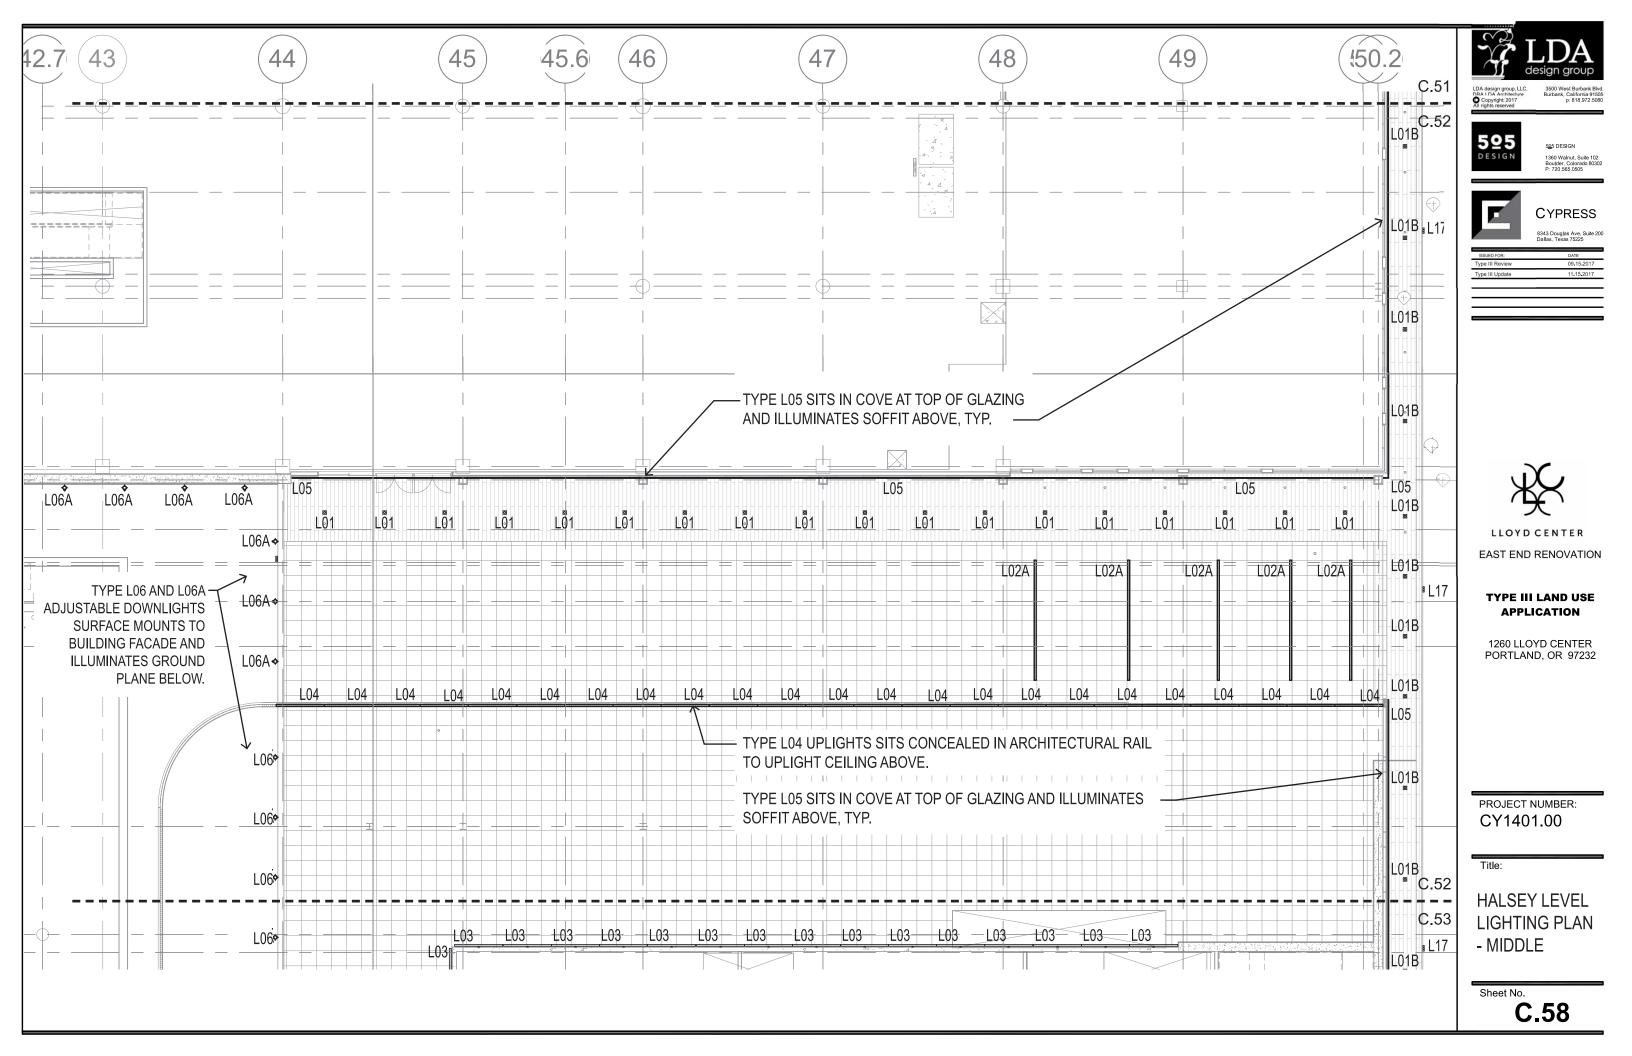



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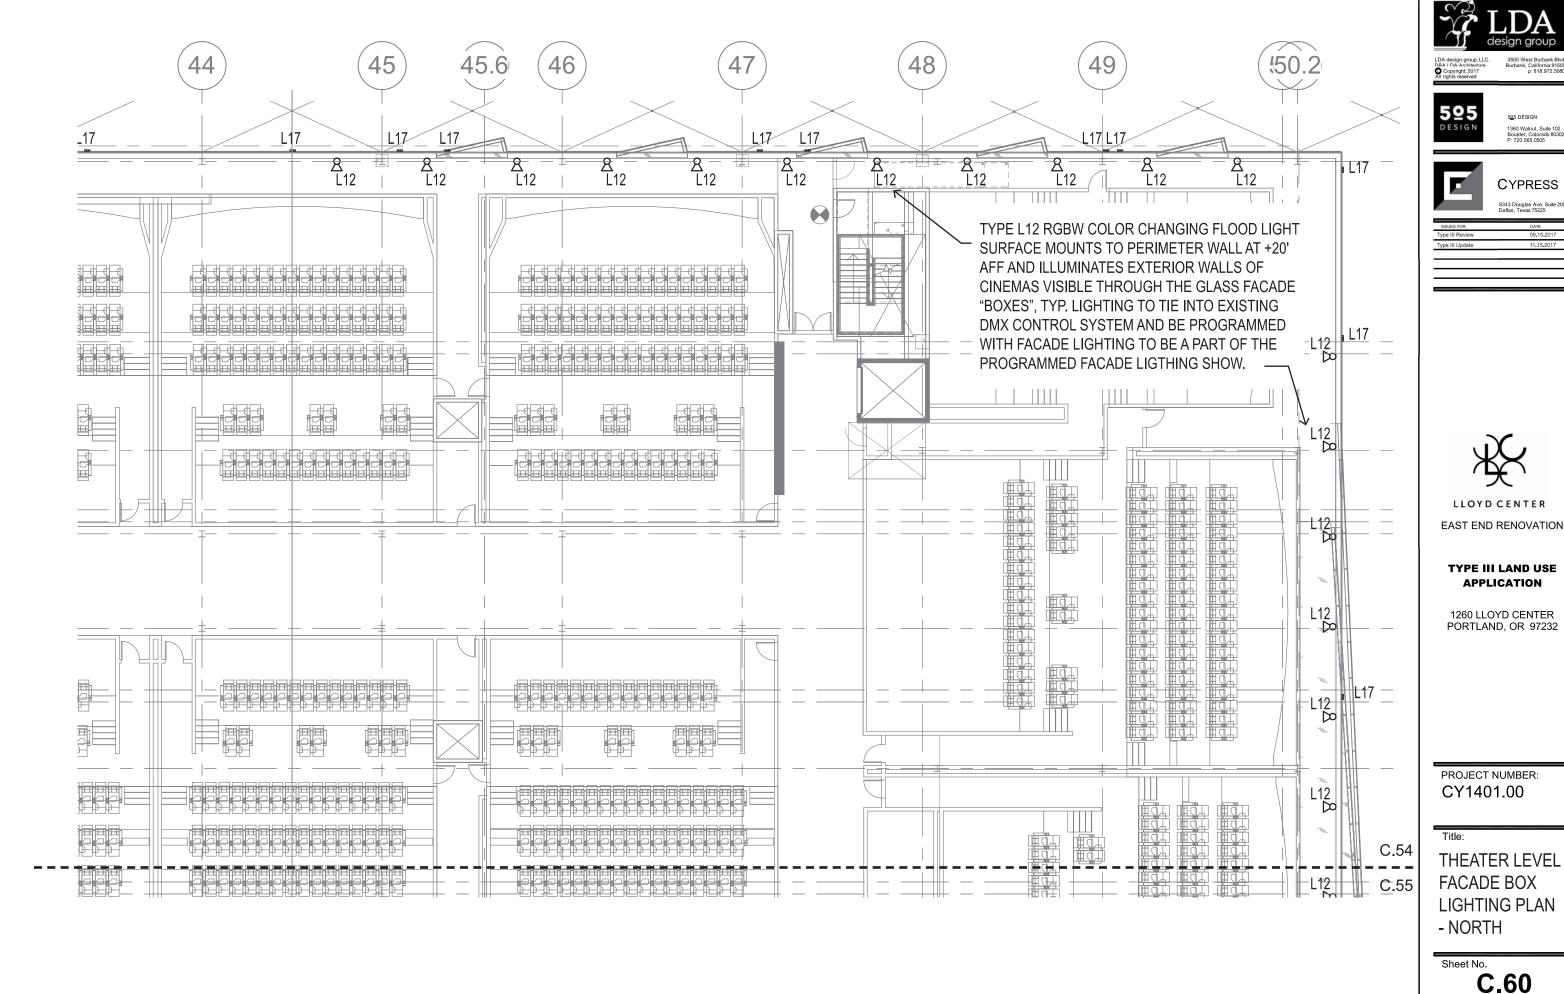
EAST END RENOVATION

#### **TYPE III LAND USE** APPLICATION

1260 LLOYD CENTER PORTLAND, OR 97232

PROJECT NUMBER: CY1401.00

HALSEY LEVEL LIGHTING PLAN - SOUTH






**CYPRESS** 





# **TYPE III LAND USE**


PORTLAND, OR 97232

THEATER LEVEL **FACADE BOX** LIGHTING PLAN

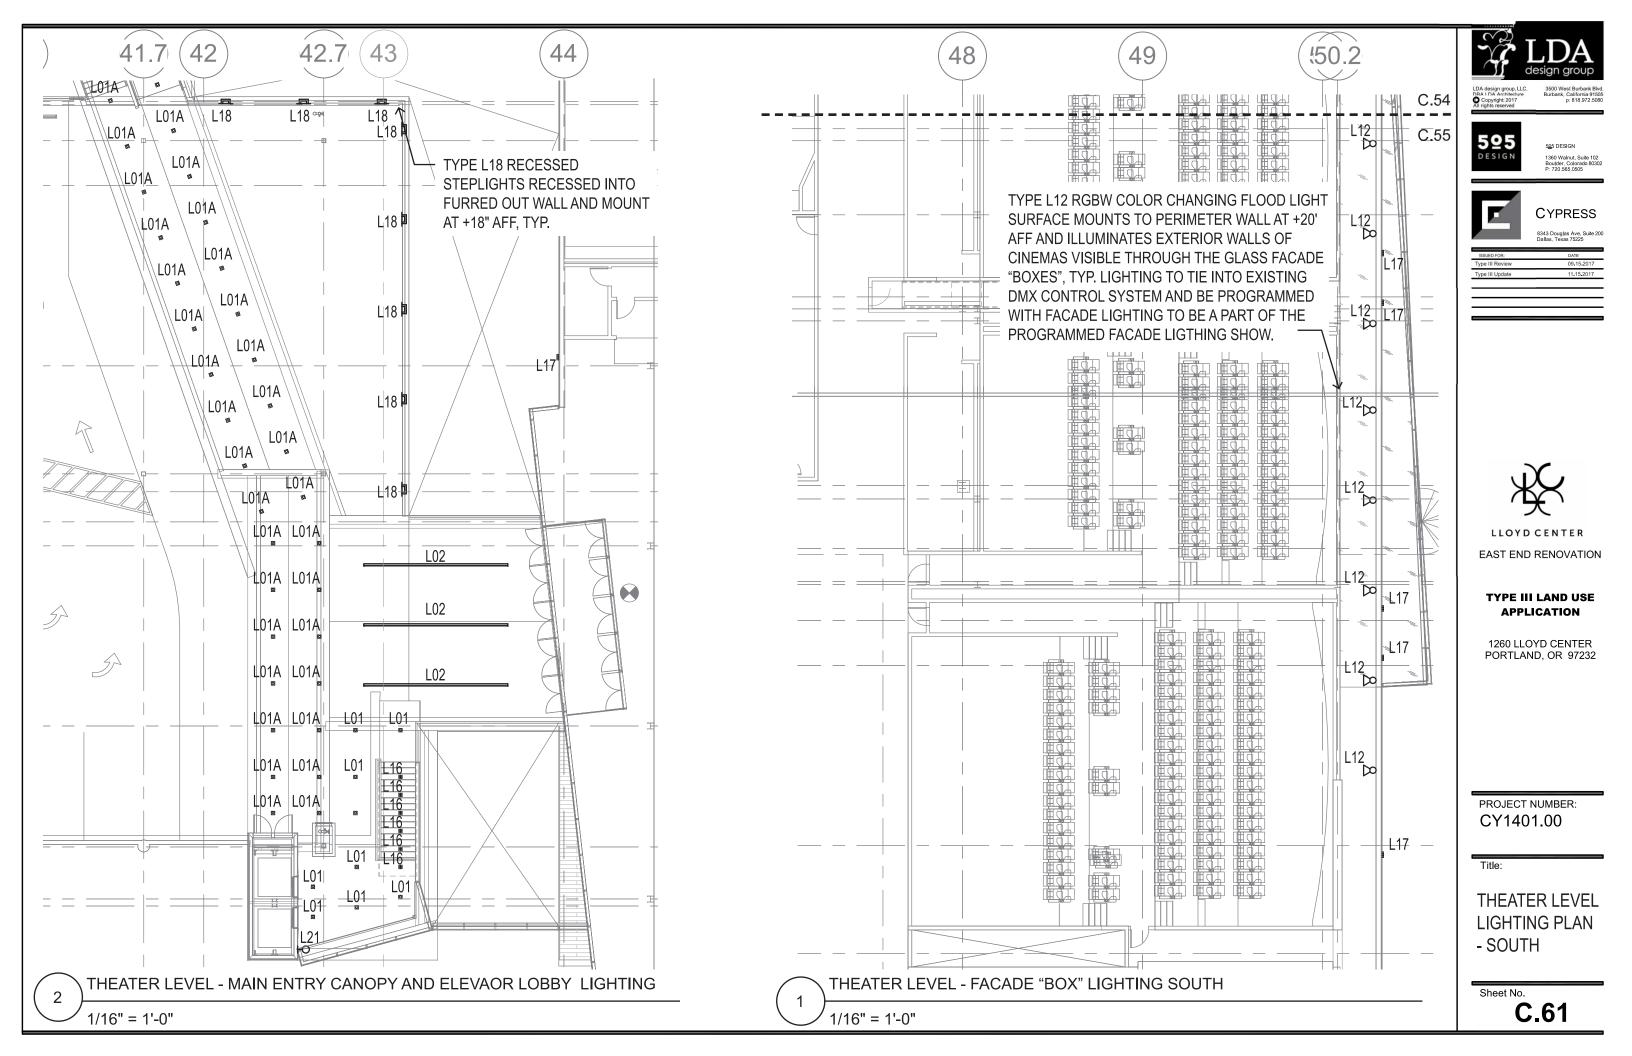

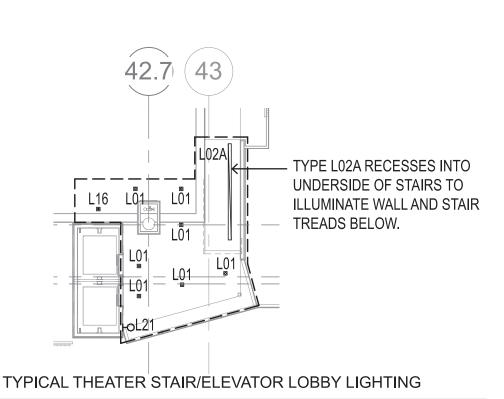

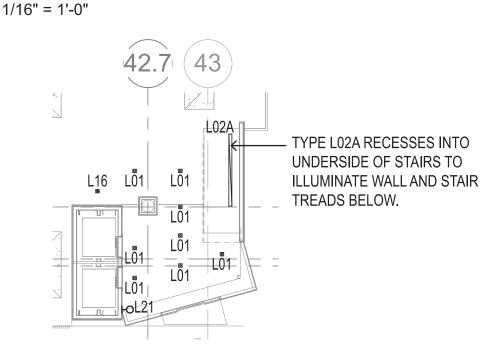

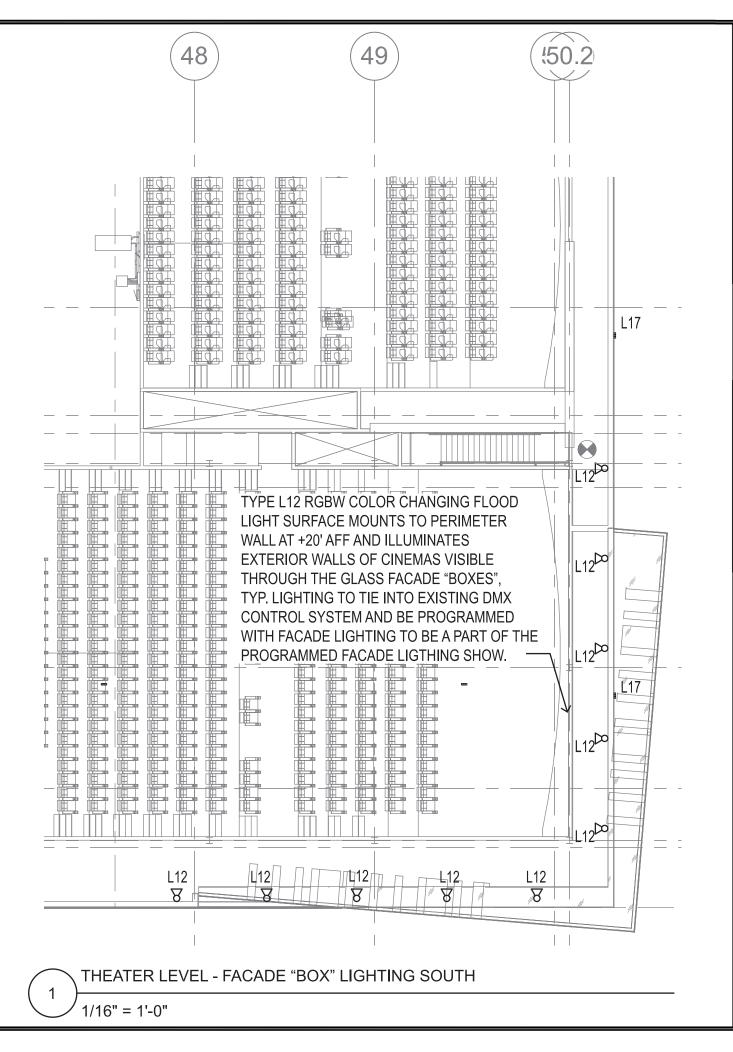







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LLOYD CENTER

**EAST END RENOVATION** 

#### **TYPE III LAND USE APPLICATION**

1260 LLOYD CENTER PORTLAND, OR 97232

PROJECT NUMBER: CY1401.00


**MEZZANINE FACADE BOX &** THEATER ENTRY STAIRS LIGHTING

Sheet No.

**C.62** 

MULTNOMAH LEVEL THEATER STAIR/ELEVATOR LOBBY LIGHTING


1/16" = 1'-0"

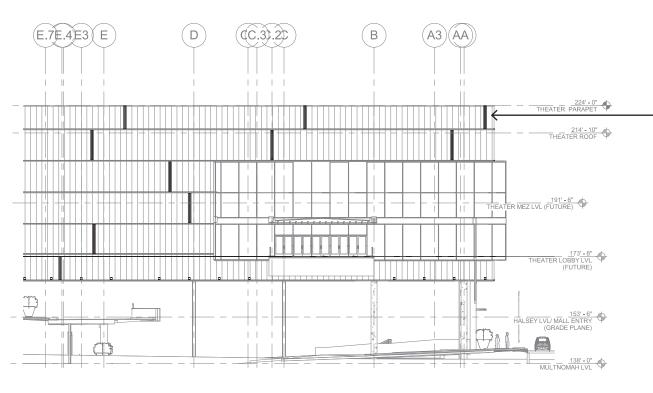


THREE ROWS OF TYPE L17 RGBW COLOR CHANGING LED STRIPS BACKGLIGHT ACRYLIC PANELS ON FACADE. LIGHTING TO TIE INTO EXISTING DMX CONTROL SYSTEM AND BE PROGRAMMED TO CREATE A LIGHTING SHOW ON FACADE. EACH PANEL TO BE PROGRAMMED AS A "PIXEL" FOR THE PURPOSES OF THE DMX SHOW PROGRAMMING.

#### FACADE FEATURE LIGHTING ELEVATION - THEATER ENTRY

1/32" = 1'-0"

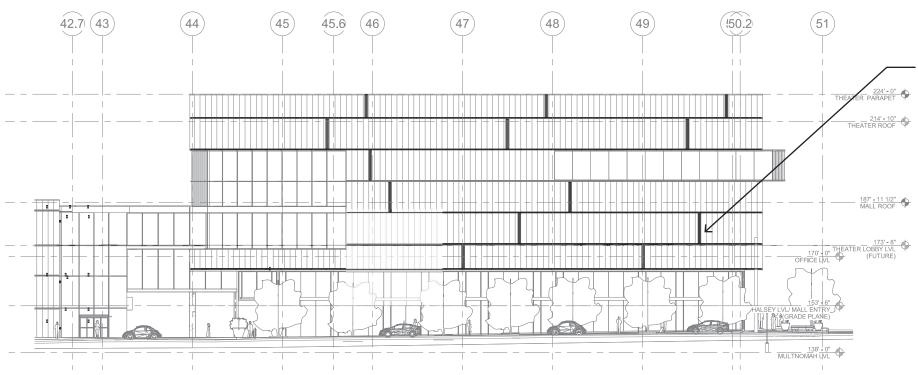

THREE ROWS OF TYPE L17 RGBW COLOR
CHANGING LED STRIPS BACKGLIGHT
ACRYLIC PANELS ON FACADE. LIGHTING
TO TIE INTO EXISTING DMX CONTROL
SYSTEM AND BE PROGRAMMED TO CREATE
A LIGHTING SHOW ON FACADE. EACH
PANEL TO BE PROGRAMMED AS A "PIXEL"
FOR THE PURPOSES OF THE DMX SHOW
PROGRAMMING.

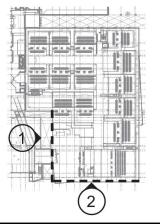



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EAST END RENOVATION

# TYPE III LAND USE APPLICATION

1260 LLOYD CENTER PORTLAND, OR 97232

PROJECT NUMBER: CY1401.00

Title


LIGHTING ELEVATIONS -THEATER ENTRY & MULTNOMAH

Sheet No.

**C.63** 

FACADE FEATURE LIGHTING ELEVATION - MULTNOMAH

<del>1/32" = 1'-0"</del>

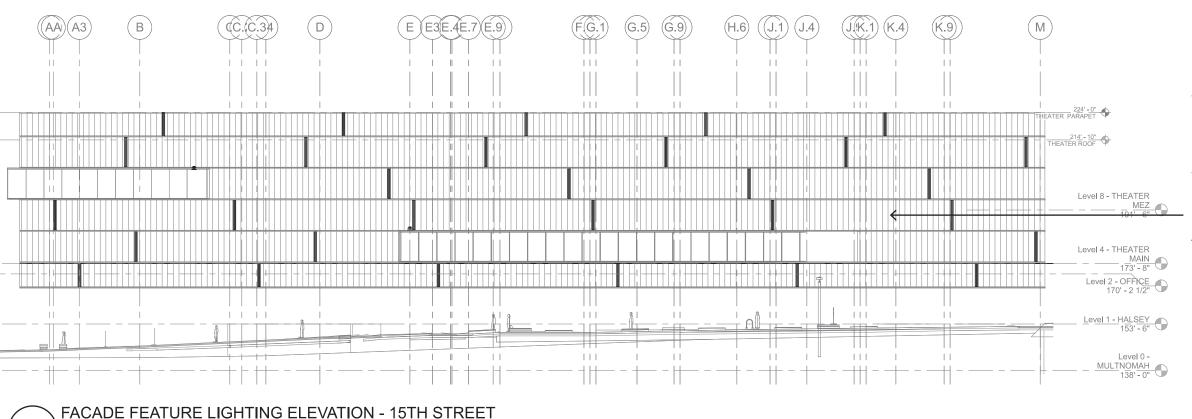

THREE ROWS OF TYPE L17
RGBW COLOR CHANGING LED
STRIPS BACKGLIGHT ACRYLIC
PANELS ON FACADE. LIGHTING
TO TIE INTO EXISTING DMX
CONTROL SYSTEM AND BE
PROGRAMMED TO CREATE
A LIGHTING SHOW ON
FACADE. EACH PANEL TO BE
PROGRAMMED AS A "PIXEL"
FOR THE PURPOSES OF THE
DMX SHOW PROGRAMMING.



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525 DESIGN 1360 Walnut, Suite 102 Boulder, Colorado 80302 P: 720.565.0505



CYPRESS

UED FOR: B III Review

LLOYD CENTER

EAST END RENOVATION

# TYPE III LAND USE APPLICATION

1260 LLOYD CENTER PORTLAND, OR 97232


PROJECT NUMBER: CY1401.00

Title:

LIGHTING ELEVATIONS - 15TH STREET & EAST ENTRY PLAZA

Sheet No.

C.64

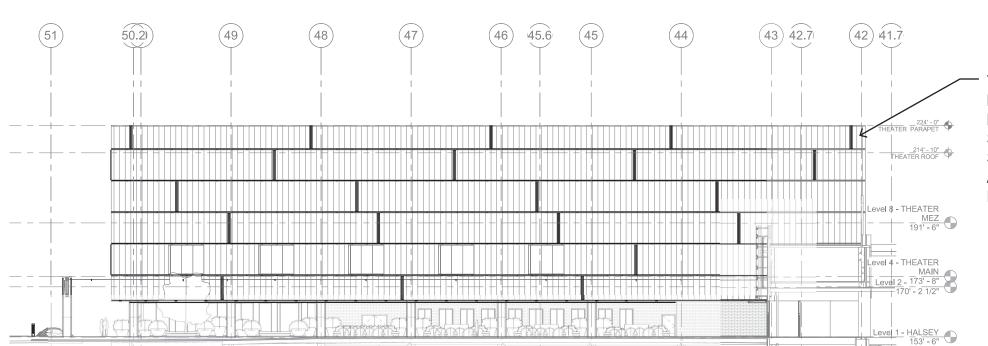

THREE ROWS OF TYPE L17 RGBW COLOR CHANGING LED STRIPS BACKGLIGHT ACRYLIC PANELS ON FACADE. LIGHTING TO TIE INTO EXISTING DMX CONTROL SYSTEM AND BE PROGRAMMED TO CREATE A LIGHTING SHOW ON FACADE. EACH PANEL TO BE PROGRAMMED AS A "PIXEL" FOR THE PURPOSES OF THE DMX SHOW PROGRAMMING.

FACADE FEATURE LIGHTING ELEVATION - EAST ENTRY PLAZA

2

1/32" = 1'-0"

1/32" = 1'-0"

### **LUMINAIRE SCHEDULE**

FIXTURE TYPE	IMAGE	PRODUCT DESCRIPTION	BASIS OF DESIGN MANUFACTURER	SIZE	INPUT WATTS	LAMP SOURCE	POWER SUPPLY	VOLTS	FINISH	MOUNTING	NOTES
L01		3.5IN DIA LED RECESSED DOWN LIGHT WITH SHORT CONE, 60° CUT-OFF AND WIDE FLOOD OPTIC	FOCAL POINT ID 3.5 SERIES	12.88" L X 10.90" W X 3.16" H X	10	3000K CCT 80+ CRI 900 LM	INTEGRAL, ELECTRONIC 0-10V (TO 10%)	277	CLEAR DIFFUSE REFLECTOR / NON-PAINTED FLANGE	CEILING RECESSED	
L01A		3.5IN DIA LED RECESSED DOWN LIGHT WITH SHORT CONE, 60° CUT-OFF AND WIDE FLOOD OPTIC	FOCAL POINT ID 3.5 SERIES	12.88" L X 10.90" W X 3.16" H X	10	3000K CCT 80+ CRI 900 LM	INTEGRAL, ELECTRONIC 0-10V (TO 10%)	277	CLEAR DIFFUSE REFLECTOR / NON-PAINTED FLANGE	CEILING RECESSED	FIXTURE SAME AS TYPE L01 BUT LOWER OUTPUT
L01B		3.5IN DIA LED RECESSED DOWN LIGHT WITH SHORT CONE, 60° CUT-OFF AND WIDE FLOOD OPTIC	FOCAL POINT ID 3.5 SERIES	12.88" L X 10.90" W X 3.16" H X	10	3000K CCT 80+ CRI 900 LM	INTEGRAL, ELECTRONIC 0-10V (TO 10%)	277	CLEAR DIFFUSE REFLECTOR / NON-PAINTED FLANGE	CEILING RECESSED	FIXTURE SAME AS TYPE L01 BUT LOWER OUTPUT
L02		LED WET LOCATION RECESSED LINEAR WITH FLUSH LENS WITH STANDARD OUTPUT	MARK ARCHITECTURAL LIGHTING SLOT 4 SERIES	4" W X 4.375" D LENGTH PER PLANS	6 W/FT	3000K CCT 80 CRI 541 LM/FT	INTEGRAL, ELECTRONIC 0-10V	277	TBD	CEILING RECESSED	
L02A		LED WET LOCATION RECESSED LINEAR WITH FLUSH LENS WITH LOW OUTPUT	MARK ARCHITECTURAL LIGHTING SLOT 4 SERIES	4" W X 4.375" D LENGTH PER PLANS	4 W/FT	3000K CCT 80 CRI 314 LM/FT	INTEGRAL, ELECTRONIC 0-10V (TO .1%)	277	TBD	CEILING RECESSED	FIXTURE SAME AS TYPE L02 BUT LOWER OUTPUT
L03		LED WALL MOUNT LINEAR WITH DIRECT NARROW BEAM WALL GRAZE OPTIC AND ASYMMETRIC THROW INDIRECT OPTIC. PROVIDE MATTE BLACK BAFFLE LOUVER FOR DOWNLIGHT COMPONENT.	MARK ARCHITECTURAL LIGHTING SLOT 4 WID SERIES	3.5" W X 5.25" D LENGTH PER PLANS	(UP)	3000K CCT 80 CRI 705 LM/FT (UP) 586 LM/FT (DN)	INTEGRAL, ELECTRONIC 0-10V (TO .1%) 2-CIRCUIT DIMMING	277	TBD	SURFACE WALL	PROVIDE LOUVRE FOR DOWN LIGHT OPTIC AND CLEAR DUST COVER FOR INDIRECT OPTIC



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ISSUED FOR:	DATE
Type III Review	09.15.2017
Type III Update	11.15.2017



#### TYPE III LAND USE APPLICATION

1260 LLOYD CENTER PORTLAND, OR 97232

PROJECT NUMBER: CY1401.00

LIGHTING **FIXTURE** SCHEDULE

FIXTURE TYPE	IMAGE	PRODUCT DESCRIPTION	BASIS OF DESIGN MANUFACTURER	SIZE	INPUT WATTS	LAMP SOURCE	POWER SUPPLY	VOLTS	FINISH	MOUNTING	NOTES
L04		LED SURFACE MOUNT INDIRECT LINEAR WITH WIDE BATWING UPLIGHT DISTRIBUTION. CLEAR DUST COVER LENS.	MARK ARCHITECTURAL LIGHTING SLOT 2 LI SERIES	2.5" W X 3.75" D LENGTH PER PLANS	6.75 W/LF	3000K CCT 80 CRI 705 LM/FT	INTEGRAL, ELECTRONIC 0-10V (TO .1%)	277	BLACK	SURFACE , RAIL MOUNTED	
L05	10C240 +	LED IP67WET LOCATION TAPE LIGHT IN ALUMINUM EXTRUSION WITH WHITE LENS. U.L. LISTED FOR WET LOCATIONS.	VOLT LIGHTING GROUP MX OUTDOOR / CH- 014-C SERIES	.39" W X .78" D LENGTH PER PLANS	1.9 W/LF	3000K CCT 90+ CRI 330 LM/FT	REQUIRES REMOTE DRIVER 0-10V	24/277	N/A	SURFACE MOUNT	PROVIDE WITH PIVOT MOUNTING CLIPS.  LOCATE TRANSFORMER IN NEARBY ACESSIBLE LOCATION. SIZE LOW VOLTAGE WIRING TO MINIMIZE VOLTAGE DROP TO WITHIN MANUFACTURER'S REQUIREMENTS.
L06		LED WET LOCATION SURFACE MOUNTED ADJUSTABLE SPOT LIGHT WITH 40° OPTIC. U.L. LISTED FOR WET LOCATIONS.	V2 LIGHTING CORE 200 LX SERIES	3.5" W X 8.1" L	11.7	3000K CCT 83 CRI 1300 LM	INTEGRAL, ELECTRONIC 0-10V	277	BLACK	SURFACE MOUNT	
L06A		SAME AS L06 EXCEPT LOWER WATTAGE AND LIGHT OUTPUT.	V2 LIGHTING CORE 200 LX SERIES	3.5" W X 8.1" L	5.6	3000K CCT 83 CRI 700 LM	INTEGRAL, ELECTRONIC 0-10V	277	BLACK	SURFACE MOUNT	
L07		LED WET LOCATION CATENARY LIGHT WITH 18IN FROSTED TUBE. U.L. LISTED FOR WET LOCATIONS.	V2 LIGHTING TUBE 200 SX SERIES	3.0" W X 23" L	8.2	3000K CCT 83 CRI 950 LM	REMOTE 0-10V DRIVER	277	BLACK	CATENARY MOUNT	PROVIDE V2 CATENARY MOUNTING SYSTEM J-BOX.
L08		LED WET LOCATION CATENARY LIGHT WITH SOLID METAL TUBE. PROVIDE 60 DEGREE BEAM REFLECTOR. U.L. LISTED FOR WET LOCATIONS.	V2 LIGHTING CORE 200 SX SERIES	3.5" W X 5" L	8.2	3000K CCT 83 CRI 950 LM	INTEGRAL, ELECTRONIC 0-10V	277	BLACK	CATENARY MOUNT	PROVIDE V2 CATENARY MOUNTING SYSTEM J-BOX.





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EAST END RENOVATION

#### TYPE III LAND USE APPLICATION

1260 LLOYD CENTER PORTLAND, OR 97232

PROJECT NUMBER: CY1401.00

LIGHTING **FIXTURE** SCHEDULE

FIXTURE TYPE	IMAGE	PRODUCT DESCRIPTION	BASIS OF DESIGN MANUFACTURER	SIZE	INPUT WATTS	LAMP SOURCE	POWER SUPPLY	VOLTS	FINISH	MOUNTING	NOTES
L09	T DC2*V	LED RGBW TAPE LIGHT IN ALUMINUM EXTRUSION WITH WHITE LENS	VOLT LIGHTING GROUP HC3RGBW / CH-607 SERIES	.72" W X .72" D LENGTH PER PLANS		RGB / WHITE CCT 90+ CRI 340 LM/FT	REQUIRES REMOTE DRIVER DMX	24/277	N/A	SURFACE MOUNT	PROVIDE MOUNT CLIPS. PROVIDE PROGRAMMABLE DMX CONTROL SYSTEM (PHAROS OR SIMILAR) THAT SETS AND STORES LIGHTING SHOWS (BY OTHERS). PROVIDE ALL NECESSARY PARTS AND PIECES FOR FULLY OPERATING SYSTEM, INCLUDING DMX CONTROLLER, DATA/POWER INTEGRATOR, POWER SUPPLY, AND PROGRAMMING SOFTWARE. INCLDUE PROGRAMMING AND INSTRUCTION FOR OWNER. DMX CONTROL SYSTEM TO INTEGRATE INTO EXISTING ETC PARADIGM CONTROL SYSTEM.  LOCATE TRANSFORMER IN NEARBY ACESSIBLE LOCATION. SIZE LOW VOLTAGE WIRING TO MINIMIZE VOLTAGE DROP TO WITHIN MANUFACTURER'S REQUIREMENTS.
L10		OUTDOOR RATED LED BACKLIGHTING TILE, WITH LEDS SPACED NOMINALLY 1.5" O.C. IP65 RATED AND U.L. LISTED FOR WET LOCATIONS.	COOLEDGE TILE EXTERIOR SERIES	12" W X 12" W	2.6 W/SF	3000K CCT 80 CRI 300 LM/SF	REQUIRES REMOTE DRIVER 0-10V	24/277	N/A	SURFACE MOUNT	PROVIDE ALL NECESSARY PARTS AND PIECES FOR FULLY OPERATIONAL SUSTEM, INCLUDING POWER SUPPLY, CABLE AND CONNECTORS.  LOCATE TRANSFORMER IN NEARBY ACESSIBLE LOCATION. SIZE LOW VOLTAGE WIRING TO MINIMIZE VOLTAGE DROP TO WITHIN MANUFACTURER'S REQUIREMENTS.
L11		LED IP65 WALL PACK WITH TYPE II DISTRIBUTION AND FROSTED LENS	LIGMAN LIGHTING UVK 3000 SERIES	7.7" W X 10.2" L X 3.1" D	20W	3000K CCT 80 CRI 1932 LM/SF	INTEGRAL, ELECTRONIC 0-10V	277	BLACK	SURFACE MOUNT	



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#### TYPE III LAND USE APPLICATION

1260 LLOYD CENTER PORTLAND, OR 97232

PROJECT NUMBER: CY1401.00

LIGHTING **FIXTURE** SCHEDULE

FIXTURE TYPE	IMAGE	PRODUCT DESCRIPTION	BASIS OF DESIGN MANUFACTURER	SIZE	INPUT WATTS	LAMP SOURCE	POWER SUPPLY	VOLTS	FINISH	MOUNTING	NOTES
L12		LED IP66 RGB/W FLOOD LIGHT WITH 60° WIDE FLOOD OPTIC (UL COMPLIANT)	LUMENPULSE LUMENBEAM LBG SERIES	13.375" W X 18.75" L X 5.75" D	TBD	RGB WITH 4000K WHITE CCT 80 CRI 2987 LM	INTEGRAL, ELETRONIC DMX	277	TBD	SURFACE MOUNT	PROVIDE MOUNT CLIPS. PROVIDE PROGRAMMABLE DMX CONTROL SYSTEM (PHAROS OR SIMILAR) THAT SETS AND STORES LIGHTING SHOWS (BY OTHERS). PROVIDE ALL NECESSARY PARTS AND PIECES FOR FULLY OPERATING SYSTEM, INCLUDING DMX CONTROLLER, DATA/POWER INTEGRATOR, POWER SUPPLY, AND PROGRAMMING SOFTWARE. INCLDUE PROGRAMMING AND INSTRUCTION FOR OWNER. DMX CONTROL SYSTEM TO INTEGRATE INTO EXISTING ETC PARADIGM CONTROL SYSTEM.
L13		LED SUFACE MOUNT WALL WASHER. U.L. LISTED FOR WET LOCATIONS. 70 X 40 DEGREE BEAM DISTRIBUTION.	ECOSENSE LIGHTING TROV SERIES	1.64" W X LENGTHS AS SHOWN ON DRAWINGS X 2.0" D	6 W/FT	3000K CCT 80 CRI 370 LM/FT	INTEGRAL DRIVER, REMOTE 0-10V CONTROL MODULE	277	TBD	SURFACE MOUNT	
L13A		SIMILAR TO L13 EXCEPT 25 X 25 DEGREE BEAM DISTRIBUTION	ECOSENSE LIGHTING TROV SERIES	1.64" W X LENGTHS AS SHOWN ON DRAWINGS X 2.0" D	6 W/FT	3000K CCT 80 CRI 370 LM/FT	INTEGRAL DRIVER, REMOTE 0-10V CONTROL MODULE	277	TBD	SURFACE MOUNT	
L14	000000	LED SUFACE MOUNT GRAZER. U.L. LISTED FOR WET LOCATIONS. 9 X 30 DEGREE BEAM DISTRIBUTION.	ECOSENSE LIGHTING TROV SERIES	1.64" W X TBD L X 2.0" D	10 W/FT	3000K CCT 80 CRI 600 LM/FT	INTEGRAL, ELETRONIC 0-10V	277	TBD	SURFACE MOUNT	
L15		RECESSED LED LINEAR CREATING A RECTANGULAR SHAPE IN THE CEILING. PROVIDE 90 DEGREE ILLUMINATED MITERED CORNERS WITH HAIRLINE SEAMS IN THE LENSING.	MARK ARCHITECTURAL LIGHTING SLOT 4L SERIES	4" W X 4.375" D LENGTH PER PLANS	6 W/FT	3000K CCT 80 CRI 540 LM/FT	INTEGRAL, ELECTRONIC 0-10V (TO .1%)	277	WHITE OVERLAP TRIM	CEILING RECESSED	





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#### TYPE III LAND USE APPLICATION

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PROJECT NUMBER: CY1401.00

LIGHTING **FIXTURE** SCHEDULE

FIXTURE TYPE	IMAGE	PRODUCT DESCRIPTION	BASIS OF DESIGN MANUFACTURER	SIZE	INPUT WATTS	LAMP SOURCE	POWER SUPPLY	VOLTS	FINISH	MOUNTING	NOTES
L16		3.5IN DIA LED RECESSED DOWN LIGHT WITH SHALLOW HOUSING. ANGLED CUTOUT IN TRIM, WITH SPREAD LENS OVERLAY.	FOCAL POINT ID 3.5 SERIES	12.88" L X 10.90" W X 3.16" H X	19	3000K CCT 80 CRI 1,500 LM	INTEGRAL, ELECTRONIC 0-10V (TO 10%)	277	NON-PAINTED ALUMINUM TRIM FLANGE	CEILING RECESSED	
L17	R. WILLIAM	LED RGBW TAPE LIGHT IN ALUMINUM EXTRUSION WITH WHITE LENS. IP67 RATED AND U.L. LISTED FOR WET LOCATIONS.	VOLT LIGHTING GROUP HC3RGBW / CH-607 SERIES	.95" W X 1.1" D LENGTH PER PLANS	4.8 W/LF	RGB / WHITE CCT 90+ CRI 340 LM/FT	REQUIRES REMOTE DRIVER DMX	24/277	N/A	SURFACE MOUNT	PROVIDE PROGRAMMABLE DMX CONTROL SYSTEM (PHAROS OR SIMILAR) THAT SETS AND STORES LIGHTING SHOWS (BY OTHERS). PROVIDE ALL NECESSARY PARTS AND PIECES FOR FULLY OPERATING SYSTEM, INCLUDING DMX CONTROLLER, DATA/POWER INTEGRATOR, POWER SUPPLY, AND PROGRAMMING SOFTWARE. INCLDUE PROGRAMMING AND INSTRUCTION FOR OWNER. DMX CONTROL SYSTEM TO INTEGRATE INTO EXISTING ETC PARADIGM CONTROL SYSTEM.  LOCATE TRANSFORMER IN NEARBY ACESSIBLE LOCATION. SIZE LOW VOLTAGE WIRING TO MINIMIZE VOLTAGE DROP TO WITHIN MANUFACTURER'S REQUIREMENTS.
L18	0 0	LED WET LOCATION RECESSED STEP LIGHT	WINONA LIGHTING STEP 13 SERIES	5.81" W X 5.50" T X 2.125" D	6	3000K CCT 80 CRI 102 LM	INTEGRAL, ELECTRONIC 0-10V	277	TBD	WALL RECESSED	
L19		LED COLUMN BOLLARD, WITH DIFFUSE CYLINDRICAL TOP SHADE AND ALUMINUM POST. IP66 RATED AND U.L. LISTED FOR WET LOCATIONS.	FORMS AND SURFACES LIGHT COLUMN BOLLARD SERIES	5" DIA X 45" TALL	17	3000K CCT 80 CRI 1,500 LM	INTEGRAL, ELECTRONIC 0-10V	277	TBD	GROUND SURFACE MOUNTED	





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ISSUED FOR:	DATE
Type III Review	09.15.2017
Type III Update	11.15.2017



EAST END RENOVATION

#### TYPE III LAND USE APPLICATION

1260 LLOYD CENTER PORTLAND, OR 97232

PROJECT NUMBER: CY1401.00

LIGHTING **FIXTURE** SCHEDULE

FIXTURE TYPE	IMAGE	PRODUCT DESCRIPTION	BASIS OF DESIGN MANUFACTURER	SIZE	INPUT WATTS	LAMP SOURCE	POWER SUPPLY	VOLTS	FINISH	MOUNTING	NOTES
L20		LED PEDESTRIAN POLE LIGHT COLUMN, WITH DIFFUSE CYLINDRICAL TOP SHADE AND ALUMINUM POST CONSTRUCTION. IP65 RATED AND U.L. LISTED FOR WET LOCATIONS.	BEGA 84 992 SERIES	7" DIA X 16' OVERALL HEIGHT	70	3000K CCT 80 CRI 8,900 LM	INTEGRAL, ELECTRONIC 0-10V	277	TBD	GROUND SURFACE MOUNTED	PROVIDE ANCHORAGE KIT AND NEW CONCRETE BASE FOR POLE. CONCRETE BASE STRUCTURAL DESIGN TO BE SIGNED BY LICENSED STRUCTURAL ENGINEER.
L21		LOW VOLTAGE LED ADJUSTABLE ACCENT LIGHT, WITH INTERCHANGEABLE OPTICS AND MATTE BLACK HONEYCOMB LOUVER. U.L. LISTED FOR WET LOCATIONS.	BK MICRO NITESTAR SERIES	4" L X 1.5" DIA X 1.5" STEM	7	3000K CCT 80 CRI 480 LM	REMOTE POWER SUPPLY	12/277	TBD	WALL SURFACE MOUNTED	PROVIDE SPOT AND NARROW FLOOD OPTIC LENSING. INSTALL WITH SPOT OPTIC.



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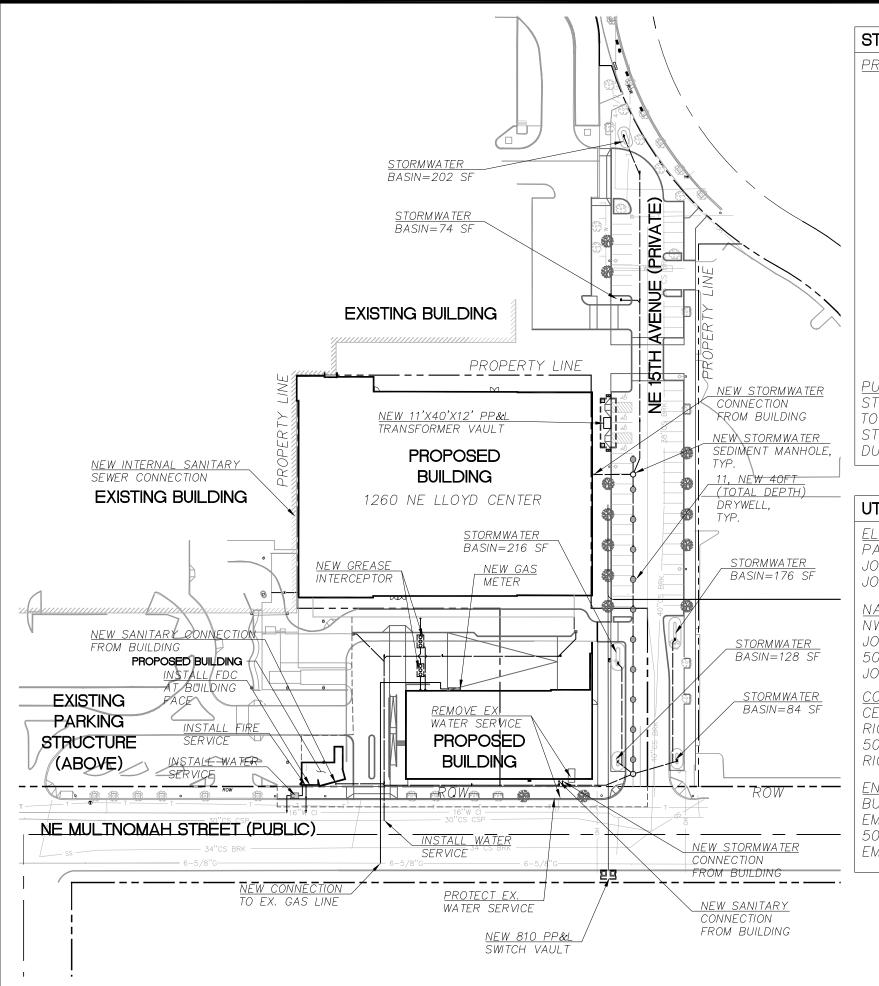


#### TYPE III LAND USE APPLICATION

1260 LLOYD CENTER PORTLAND, OR 97232

PROJECT NUMBER: CY1401.00

LIGHTING **FIXTURE** SCHEDULE



#### STORMWATER NARRATIVE

PRIVATE SITE:

WATER QUALITY

WATER QUALITY CONTROL IS MET WITH STORMWATER BASINS. THE BASINS ARE SIZED TO TREAT AN AREA EQUIVALENT TO THE NEWLY CONSTRUCTED PARKING LOT AND SIDEWALK IMPERVIOUS AREA OF 38,210 SF.

#### WATER QUANTITY

WATER QUANTITY CONTROL IS MET THROUGH THE INSTALLATION OF DRYWELLS (11, TOTAL), WHICH ARE DESIGNED TO INFILTRATE THE 10-YR STORM AND PROVIDE SAFE OVERLAND FLOW TO NE MULTNOMAH STREET FOR LARGER STORM EVENTS.

ALL RUNOFF FROM THE SITE WILL BE INFILTRATED ON SITE THROUGH THE USE OF DRYWELLS AND STORMWATER BASINS. THE PROJECT WILL FALL UNDER CATEGORY 1 & 2 OF THE STORMWATER DISPOSAL HIERARCHY.

#### PUBLIC STREET IMPROVEMENTS:

STORMWATER MANAGEMENT IS NOT REQUIRED FOR THE IMPROVEMENTS TO THE PUBLIC SIDEWALKS IN THE PUBLIC RIGHT-OF-WAY. THE EXISTING STORMWATER DRAINAGE FOR THE RIGHT-OF-WAY WILL BE PROTECTED DURING CONSTRUCTION.

#### UTILITY CONTACT LIST

**ELECTRICAL**:

PACIFIC POWER & LIGHTING

JON CONNELLY

JONATHAN.CONNELLY@PACIFICPOWER.NET

NATURAL GAS:

NW NATURAL

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#### COMMUNICATIONS:

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WATER:

WATER BUREAU

VU MAI

503-823-7475

VU.MAI@PORTLANDOREGON.GOV

PROJECT NUMBER: CY1407.00

UTILITY PLAN

GRAPHIC SCALE 1 inch = 80 ft.







LLOYD CENTER TYPE III LAND USE

**APPLICATION** 

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-13/4"

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Type III Review	09.15.2017
Type III Update	11.15.2017

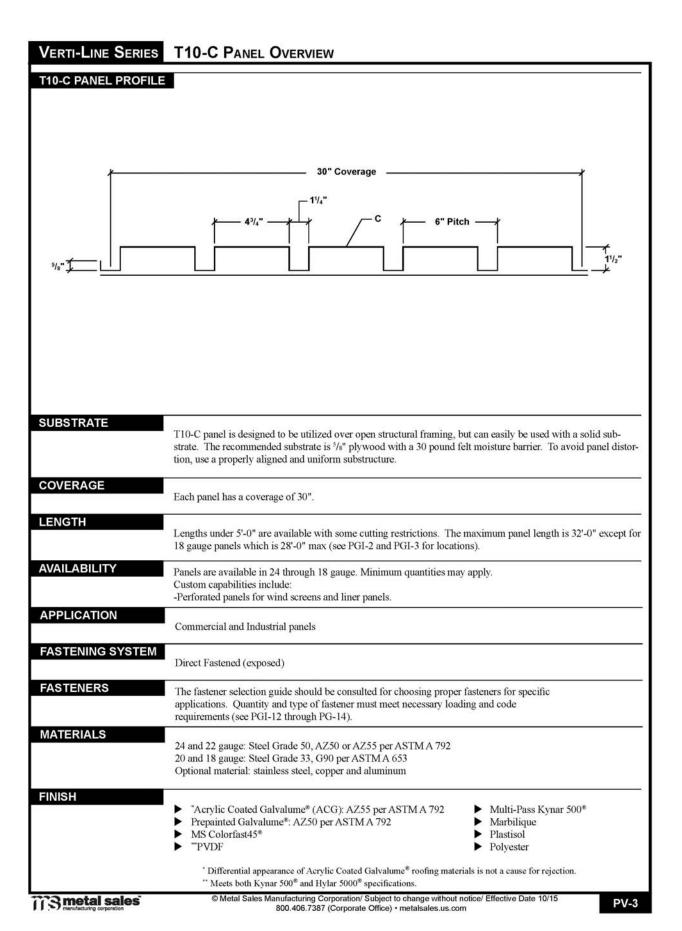

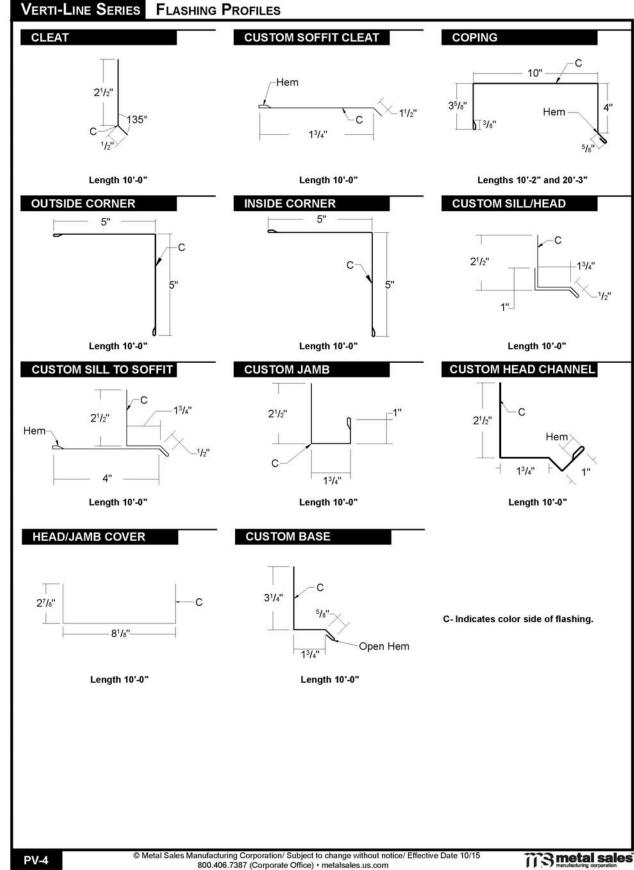**TYPE III LAND USE APPLICATION** 


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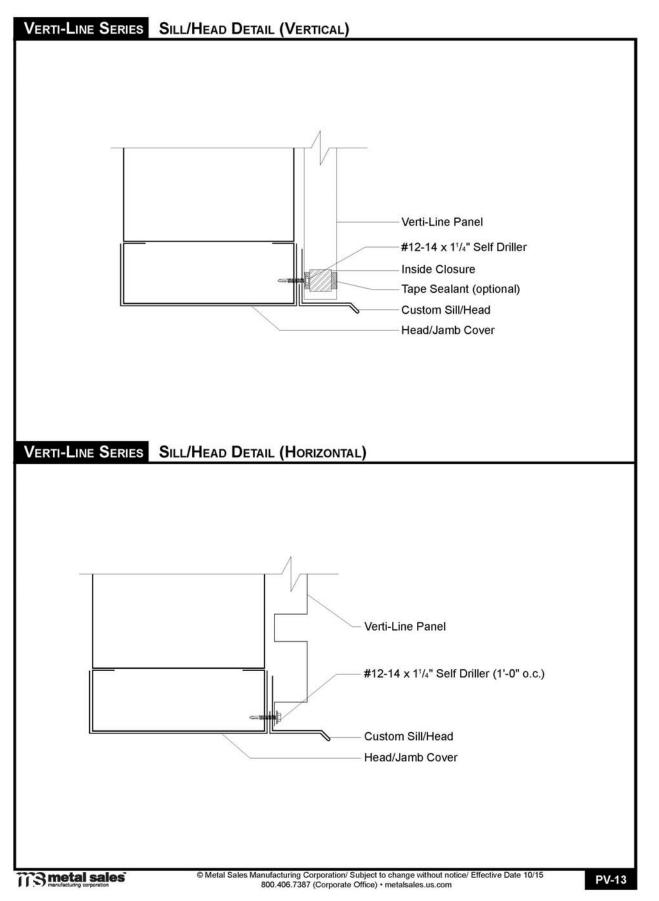
1260 LLOYD CENTER PORTLAND, OREGON

PROJECT NUMBER: CY1704

Title: **METAL** PANEL CUT **SHEETS** 

Sheet No.



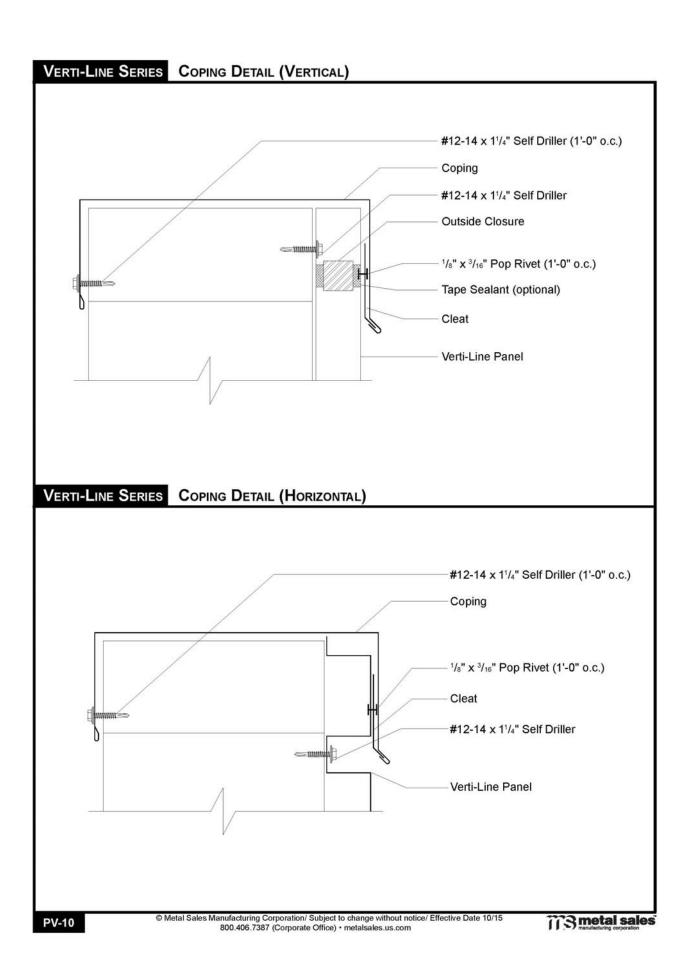



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| Type | | Update | 11.15.2017 |

LLOYD CENTER

TYPE III LAND USE APPLICATION

LLOYD CENTER EAST

1260 LLOYD CENTER PORTLAND, OREGON 97232


PROJECT NUMBER: CY1704

Title: METAL PANEL CUT SHEETS

Sheet No.

**C.73** 



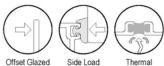

T500 (OPG1900) Series
Description:2 1/4" X 7" With 1/4" - 1 1/8" Glass
Function:Curtain Wall Detail:Horizontalrs

SHEET 1 OF 3

4

**(+)** 

**(+)** 





T500 (OPG1900) Series
Description:2 1/4" X 7" With 1/4" - 1 1/8" Glass
Function:Curtain Wall

Detail:Verticals

SHEET 2 OF 3



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ISSUED FOR:	DATE
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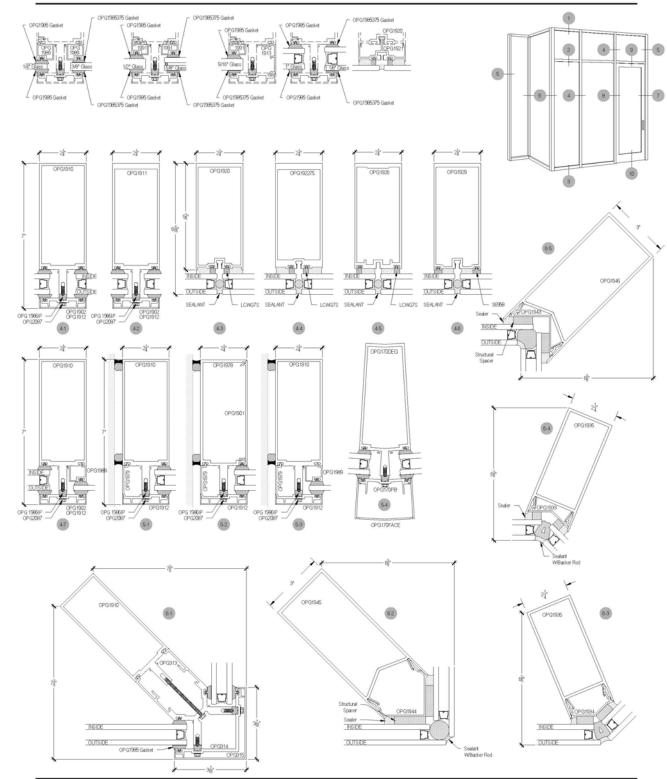
LLOYD CENTER EAST

**TYPE III LAND USE APPLICATION** 


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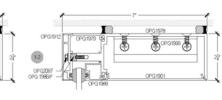



MULLION WALL CUT **SHEETS** 










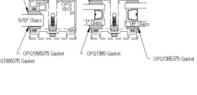


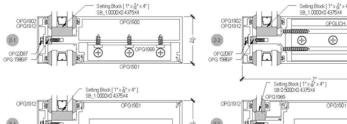


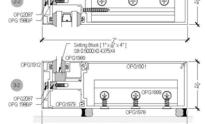

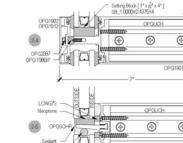

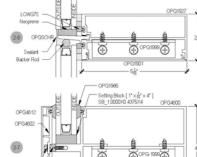

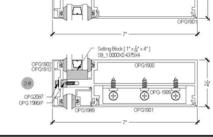

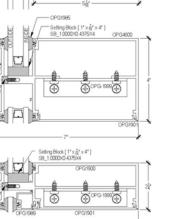

FRAMING-ARCADIA-THERMAL-OPG1900-ALL-SERIES.pdf As of: 10/14/15 FRAMING-ARCADIA-THERMAL-OPG1900-ALL-SERIES.pdf


Sheet No.

As of: 10/14/15

C.74



MULTNOMAH & 15TH ST CORNER

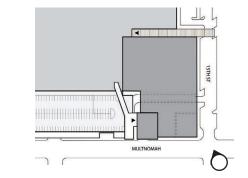









# TYPE III LAND USE APPLICATION

1260 LLOYD CENTER PORTLAND, OR 97232

PROJECT NUMBER: CY1704

Title: RENDERINGS



LOOKING WEST DOWN MULTNOMAH





 TYPE III REVIEW
 09.15.2017

 TYPE III UPDATE
 11.15.2017



TYPE III LAND USE APPLICATION

LLOYD CENTER EAST


1260 LLOYD CENTER PORTLAND, OR 97232

PROJECT NUMBER: CY1704

Title: RENDERINGS



LOOKING WEST DOWN MULTNOMAH

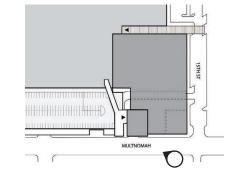







 TYPE III REVIEW
 DATE

 TYPE III UPDATE
 11.15.2017



# TYPE III LAND USE APPLICATION


1260 LLOYD CENTER PORTLAND, OR 97232

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Title: RENDERINGS



LOOKING EAST DOWN MULTNOMAH



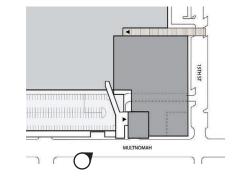





TYPE III LAND USE APPLICATION


1260 LLOYD CENTER PORTLAND, OR 97232

PROJECT NUMBER: CY1704

Title: RENDERINGS



**FUTURE PHASE 2 MALL ENTRY** 

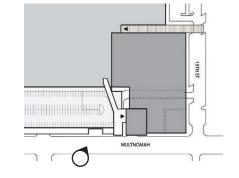







 TYPE III REVIEW
 09.15.2017

 TYPE III UPDATE
 11.15.2017



# TYPE III LAND USE APPLICATION


1260 LLOYD CENTER PORTLAND, OR 97232

PROJECT NUMBER: CY1704

Title: RENDERINGS



MULTNOMAH THEATER ENTRY

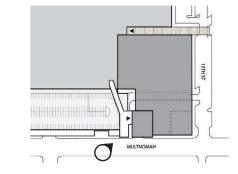







CYPRESS

TYPE III REVIEW 09.15.2017

TYPE III UPDATE 11.15.2017



# TYPE III LAND USE APPLICATION


1260 LLOYD CENTER PORTLAND, OR 97232

PROJECT NUMBER: CY1704

RENDERINGS





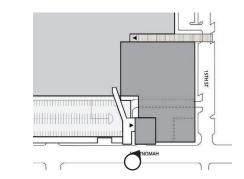









TYPE III LAND USE APPLICATION


1260 LLOYD CENTER PORTLAND, OR 97232

PROJECT NUMBER: CY1704

RENDERINGS



PROPOSED FUTURE EAST MALL ENTRY

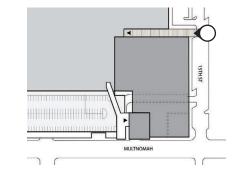









LLOYD CENTER EAST

TYPE III LAND USE APPLICATION


1260 LLOYD CENTER PORTLAND, OR 97232

PROJECT NUMBER: CY1704

Title: RENDERINGS



PROPOSED FUTURE EAST ENTRY AERIAL

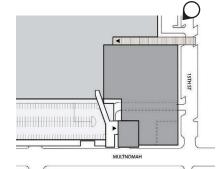







 TYPE III REVIEW
 09.15.2017

 TYPE III UPDATE
 11.15.2017



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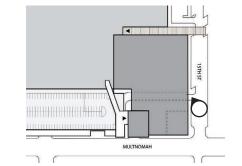
1260 LLOYD CENTER PORTLAND, OR 97232

PROJECT NUMBER: CY1704

Title: RENDERINGS



FUTURE TENANT ENTRY OFF 15TH









LLOYD CENTER EAST

TYPE III LAND USE APPLICATION


1260 LLOYD CENTER PORTLAND, OR 97232

PROJECT NUMBER: CY1704

Title: RENDERINGS



FUTURE TENANT ENTRY OFF 15TH

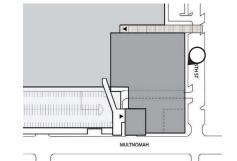









LLOYD CENTER EAST

TYPE III LAND USE APPLICATION


1260 LLOYD CENTER PORTLAND, OR 97232

PROJECT NUMBER: CY1704

Title: RENDERINGS



THEATER ENTRY AERIAL

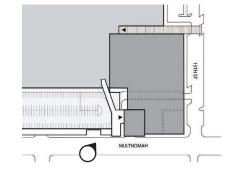









LLOYD CENTER EAST

TYPE III LAND USE APPLICATION


1260 LLOYD CENTER PORTLAND, OR 97232

PROJECT NUMBER: CY1704

RENDERINGS





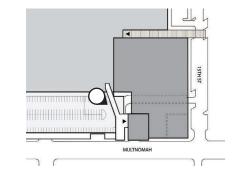









TYPE III LAND USE APPLICATION

1260 LLOYD CENTER PORTLAND, OR 97232

PROJECT NUMBER: CY1704

Title: RENDERINGS



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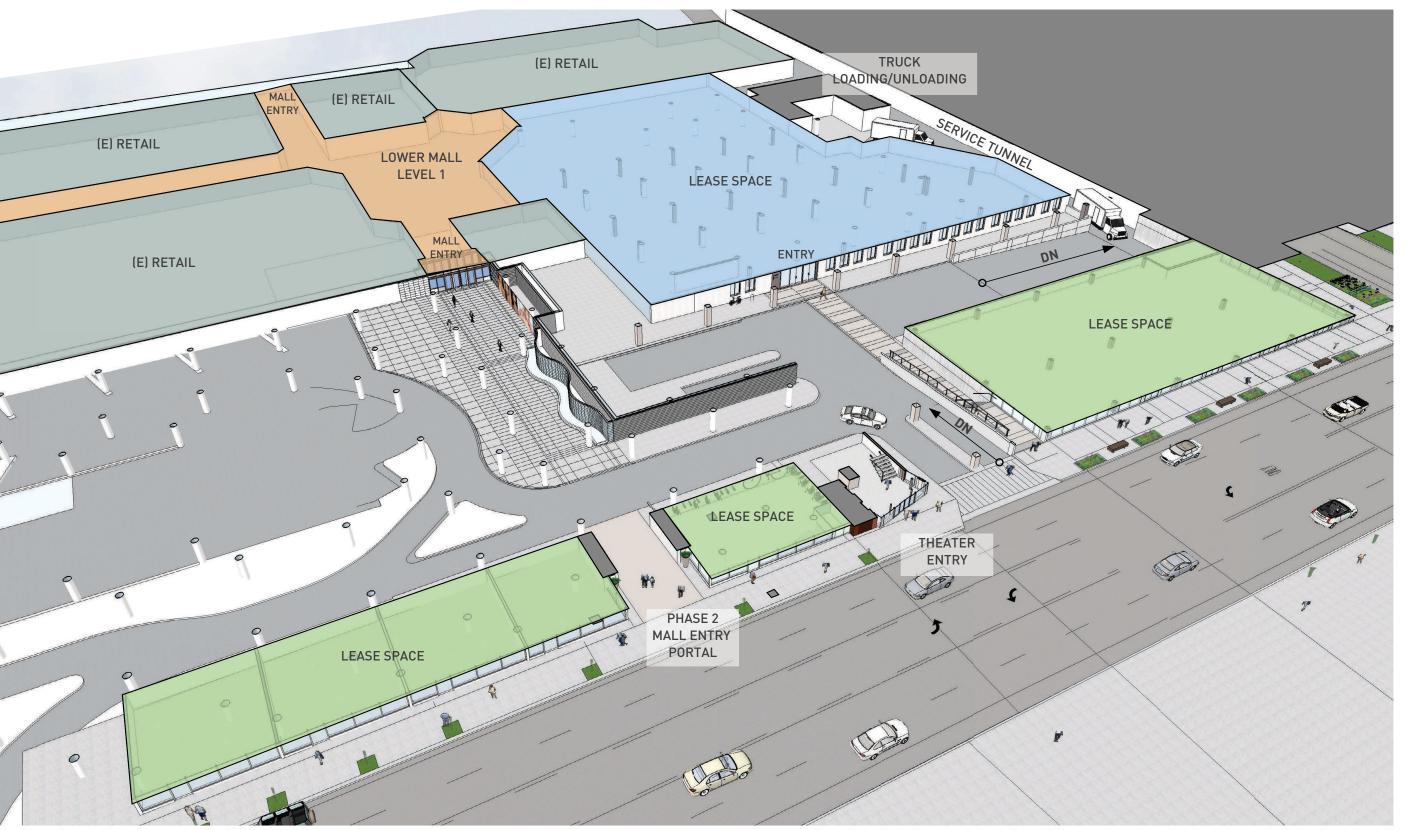
LLOYD CENTER EAST

TYPE III LAND USE **APPLICATION** 

1260 LLOYD CENTER PORTLAND, OR 97232

PROJECT NUMBER: CY1704

Title: PLAN **PERSPECTIVES** 







ISSUED FOR:	DATE
TYPE III REVIEW	09.15.2017
TYPE III UPDATE	11.15.2017



LLOYD CENTER EAST

#### TYPE III LAND USE **APPLICATION**

1260 LLOYD CENTER PORTLAND, OR 97232

PROJECT NUMBER: CY1704

Title: PLAN **PERSPECTIVES** 







LLOYD CENTER EAST

TYPE III LAND USE **APPLICATION** 

1260 LLOYD CENTER PORTLAND, OR 97232

PROJECT NUMBER: CY1704

Title: PLAN **PERSPECTIVES** 

1 Level 3 - Plan Perspective NTS







20100, 10100	
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TYPE III UPDATE	11.15.2017



LLOYD CENTER EAST TYPE III LAND USE APPLICATION


1260 LLOYD CENTER PORTLAND, OR 97232

PROJECT NUMBER: CY1704

Title: PLAN PERSPECTIVES



1 Full Aerial Perspective NTS

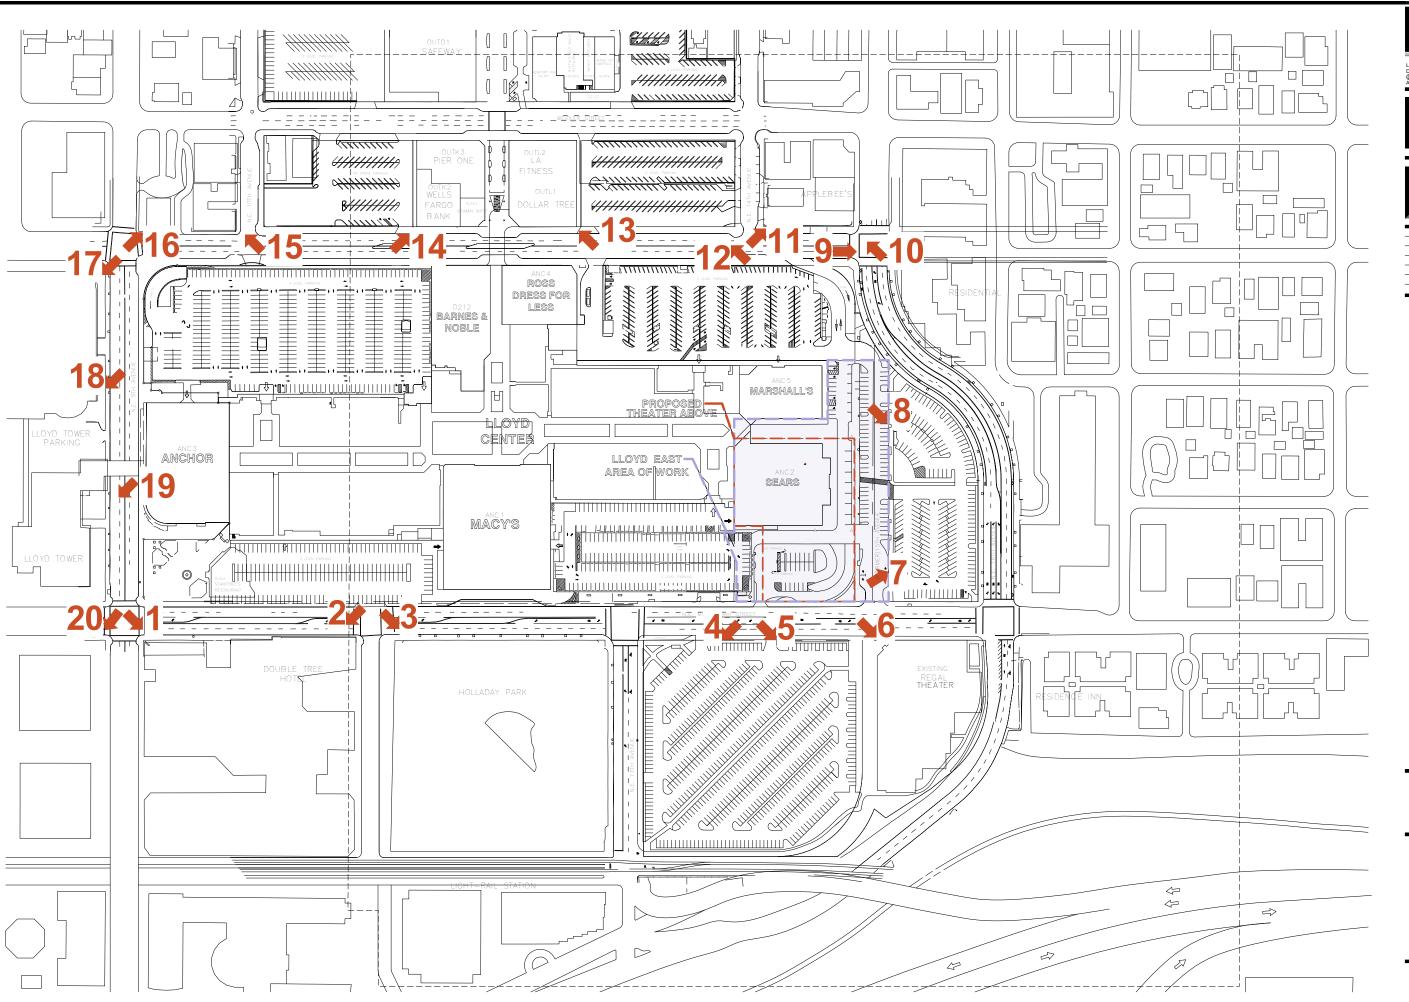





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LLOYD CENTER LLOYD CENTER EAST

**TYPE III LAND USE APPLICATION** 

1260 LLOYD CENTER PORTLAND, OREGON 97232

PROJECT NUMBER: CY1704

SURROUNDING **NEIGHBOR-HOOD PHOTOGRAPHS KEY PLAN** 

Sheet No.

**APP.18** 



Hotel across NE Multnomah Street

### **PHOTO 002**



Hotel across NE Multnomah Street



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# LLOYD CENTER

1260 LLOYD CENTER PORTLAND, OREGON 97232

## PROJECT NUMBER:

SURROUNDING

# LLOYD CENTER EAST

#### TYPE III LAND USE **APPLICATION**

## CY1704

**NEIGHBOR-**HOOD **PHOTOGRAPHS** 

Sheet No. APP.19

### **PHOTO 003**



Holladay Park across NE Multnomah Street

### **PHOTO 004**



Parking lot across NE Multnomah Street



Parking lot across NE Multnomah Street

### **PHOTO 007**



Parking lot across Private Street (15th Street)

#### **PHOTO 006**



Movie Theater cater croner NE Multnomah Street and Private Street (15th Street)

### **PHOTO 008**



Parking lot across Private Street (15th Street)









TYPE III LAND USE **APPLICATION** 

1260 LLOYD CENTER PORTLAND, OREGON 97232

PROJECT NUMBER: CY1704

SURROUNDING **NEIGHBOR-**HOOD **PHOTOGRAPHS** 



Multi-use building at NE Halsey Street and 15th Avenue

### **PHOTO 010**



Restaurant at northwest corner of NE Halsey Street and 15th Avenue





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1260 LLOYD CENTER PORTLAND, OREGON 97232

SURROUNDING

# LLOYD CENTER LLOYD CENTER EAST

#### TYPE III LAND USE **APPLICATION**

# PROJECT NUMBER: CY1704

**NEIGHBOR-**HOOD PHOTOGRAPHS

Sheet No. APP.21

### PHOTO 011



Building across NE Halsey Street, adjacent to restaurant

### PHOTO 012



Parking lot across NE Halsey Street

PHOTO 015



Retail and parking lot across NE Halsey Street

#### **PHOTO 014**



Retail and parking lot across NE Halsey Street

LLOYD CENTER LLOYD CENTER EAST

TYPE III LAND USE **APPLICATION** 

1260 LLOYD CENTER PORTLAND, OREGON 97232

## PROJECT NUMBER:

SURROUNDING **NEIGHBOR-**HOOD

Building across NE Halsey Street (at NE 10th Avenue)

### **PHOTO 016**



Northeast cornerr of NE Halsey Street and NE 9th Avenue



CY1704

**PHOTOGRAPHS** 



Northwest corner of Halsey Street and NE 9th Avenue

### **PHOTO 018**



Parking structure across NE 9th Avenue

#### D. 10-T0 000



Southwest corner of NE 9th Avenue and Multnomah Street





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TYPE III LAND USE APPLICATION

1260 LLOYD CENTER PORTLAND, OREGON 97232

PROJECT NUMBER: CY1704

SURROUNDING
NEIGHBORHOOD
PHOTOGRAPHS

Sheet No. APP.23

## **PHOTO 019**



Building across NE 9th Avenue









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LLOYD CENTER EAST

TYPE III LAND USE APPLICATION

1260 LLOYD CENTER PORTLAND, OREGON 97232

PROJECT NUMBER: CY1704

Title: AREA OF WORK PHOTO KEY PLAN




SE Parking Structure and Mall access from NE Multnomah Street

#### PHOTO 002



Vertical circulation at southeast end of SE Parking Structure

#### PHOTO 003

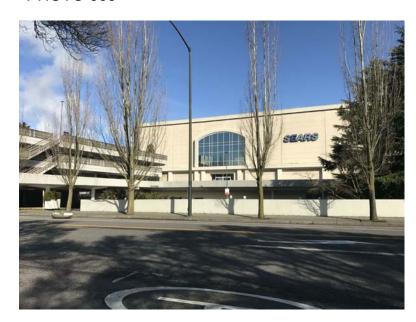

SE Parking Structure and South elevation of Sears anchor building

# LLOYD CENTER

**CYPRESS** 

LLOYD CENTER EAST

TYPE III LAND USE APPLICATION

1260 LLOYD CENTER PORTLAND, OREGON 97232

## PROJECT NUMBER:

CY1704

AREA OF WORK SITE PHOTOGRAPHS

Sheet No.


APP.25

### PHOTO 004




Street corner of NE Multnomah Street and Private Street (15th Street)

#### PHOTO 005

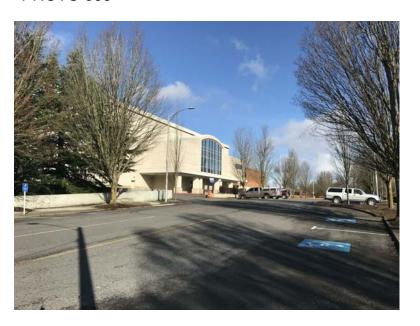

East elevation of Sears anchor building

#### **PHOTO 006**

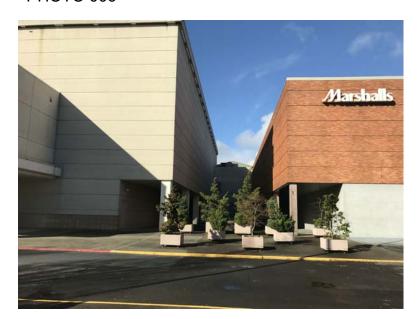

Open space between Sears anchor building and Marshalls anchor building




Open space between Sears anchor building and Marshalls anchor building

#### PHOTO 008



Open space between Sears anchor building and Marshalls anchor building

#### **PHOTO 009**

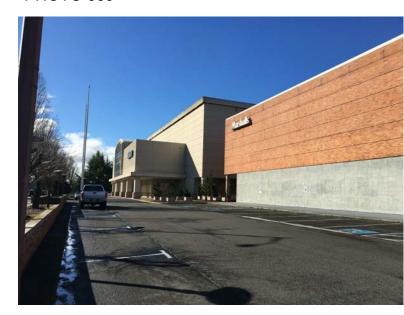

Sears anchor building and Marshalls anchor building; east facade

# LDA design group

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## TYPE III LAND USE APPLICATION

1260 LLOYD CENTER PORTLAND, OREGON 97232

## PROJECT NUMBER: CY1704

AREA OF
WORK SITE
PHOTOGRAPHS

#### **PHOTO 010**



Pedestrian access to adjacent site from NE 16th Avenue

### PHOTO 011



Pedestrian access from NE 16th Avenue



Access from NE Halsey Street to service tunnel / Multnomah level loading area

### PHOTO 013



Entrance to service tunnel and loading area at Multnomah level

#### **PHOTO 014**



Ramp to service tunnel and Multnomah level loading area



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**TYPE III LAND USE APPLICATION** 

1260 LLOYD CENTER PORTLAND, OREGON 97232

PROJECT NUMBER: CY1704

AREA OF **WORK SITE** 

**PHOTOGRAPHS** 


Sheet No. **APP.27** 

#### PHOTO 015



Multnomah loading area / service tunnel, looking south

#### PHOTO 016

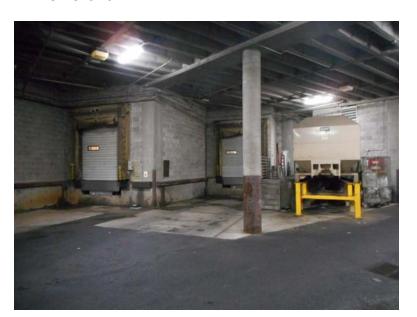

Loading docks at Sears

### **PHOTO 017**



Ramp up from Multnomah level service tunnel / loading area





4th level parking deck from mall entrance

#### PHOTO 019



4th level parking deck looking at south facade of Sears anchor building

#### **PHOTO 020**



4th level parking deck, looking east





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# LLOYD CENTER LLOYD CENTER EAST


TYPE III LAND USE **APPLICATION** 

1260 LLOYD CENTER PORTLAND, OREGON 97232

#### PROJECT NUMBER: CY1704


AREA OF **WORK SITE** PHOTOGRAPHS

#### **PHOTO 021**

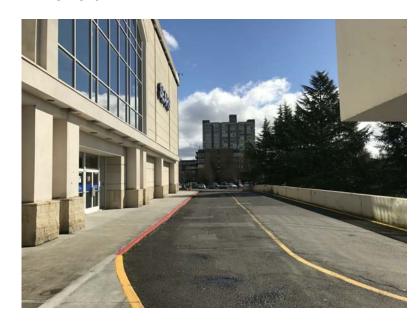

Halsey level elevated road and Sears entrance

#### **PHOTO 022**

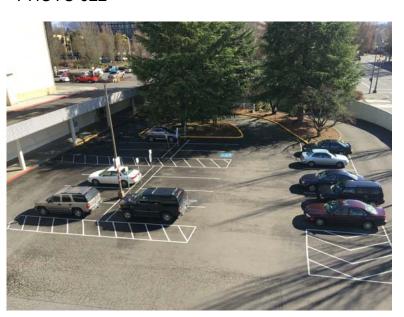

On grade parking south of Sears Anchor building







**TYPE III LAND USE** APPLICATION

LLOYD CENTER EAST

1260 LLOYD CENTER PORTLAND, OREGON 97232

PROJECT NUMBER: CY1704

Title: MASSING DIAGRAMS

1 PROPOSED MASSING OVERLAY

PROPOSED MASSING CONCEPT





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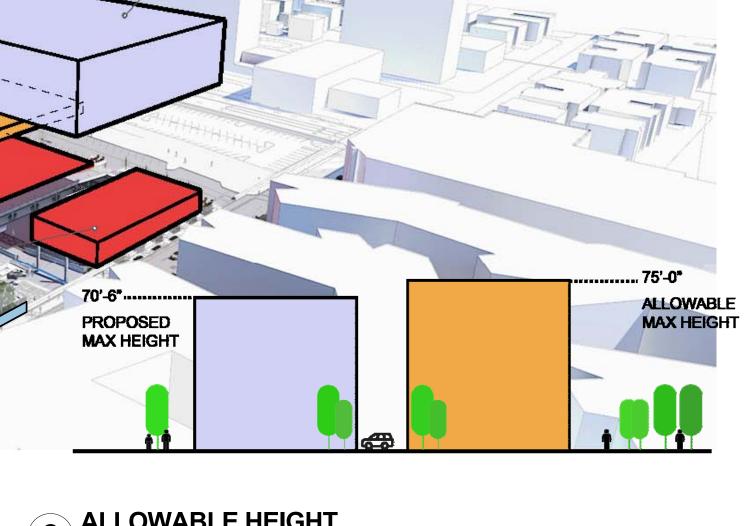


**TYPE III LAND USE** APPLICATION

1260 LLOYD CENTER PORTLAND, OREGON 97232

PROJECT NUMBER: CY1704

ZONING **DIAGRAMS** 



Theater Level: 76, 929 SF



TOTAL SITE AREA:

ALLOWABLE FAR:

ALLOWABLE HEIGHT:

PROPOSED HEIGHT:

TOTAL GSF: PROPOSED FAR:

Halsey Level: 33, 401 SF •

Multnomah Level: 46, 786 SF

Phase II: 4,870 SF

142, 966 SF

6:1 151, 116 SF

1.05:1

75'-0"

70'-6"



#### Legend

City Boundary

OS - Open Space

RF - Residential Farming

R20 - Residential 20,000

R10 - Residential 10,000

R7 - Residential 7,000

R5 - Residential 5,000

R2.5 - Residential 2,500

R3 - Residential 3,000

R2 - Residential 2.000

R1 - Residential 1,000

RH - High Density Residential

RX - Central Residential

IR - Institutional Residential

CN1 - Neighborhood Commercial 1

CN2 - Neighborhood Commercial 2

CO1 - Office Commercial 1

CO2 - Office Commercial 2

CS - Storefront Commercial

CM - Mixed Commercial

CG - General Commercial

CX - Central Commercial

EG1 - General Employment 1

EG2 - General Employment 2


EX - Central Employment

IG1 - General Industrial 1

IG2 - General Industrial 2

IH - Heavy Industrial

Unincorporated Multnomah County Pocket (City Zoning)

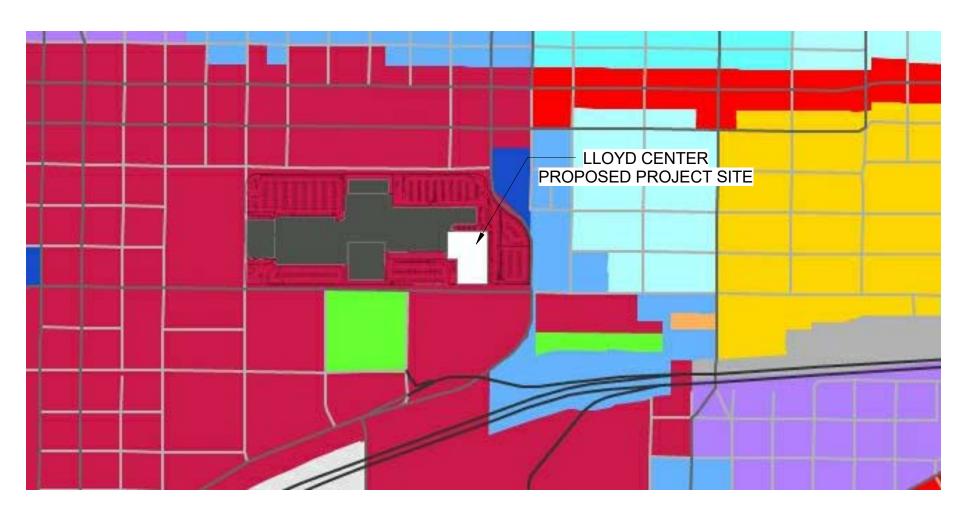

**Legal:** Portland HOLLOADAYS ADD, BLOCK; Partition Plat 1999-146, Lot 1 (same for anchor)

**Zoning:** Base: CX

> d - design zone Overlav:

Base Overlay Combination: CXd

CC - Central City Plan District **Plan District:** 

Lloyd District

**Neighborhood:** Lloyd District

Neighborhood Association of Sullivan Gulch

Kerns Neighborhood Association Northeast Coalition of Neighborhoods

Lloyd District Community Association (Business Association)

#### **Development Sandards:**

The Central Commercial (CX) zone is intended to provide for commercial development within Portland's most urban and intense areas. A broead range of uses is allowed to reflect Portland's role as a commercial, cultural and governmental center. Development is intended to be very intense with high building coverage, large buildings and building spaces close together.

THE CX ZONE DOES NOT HAVE ANY SETBACK REQUIREMENTS AND DOES NOT PROHIBIT DEVELOPMENT OF A STRUCTURE THAT SNCROACHES OVER A LOT LINE. THE OWNERS OF THE RESPECTIVE LOTS BOTH AUTHORIZE THIS APPLICATION AND WILL ENTER INTO THE REQUISITE AGREEMENTS TO AUTHORIZE DEVELOPMENT AS PROPOSED HEREIN.



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PROJECT NUMBER: CY1704

**ZONING DIAGRAMS** 

Sheet No.

**APP.31** 







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LLOYD CENTER LLOYD CENTER EAST

## TYPE III LAND USE APPLICATION


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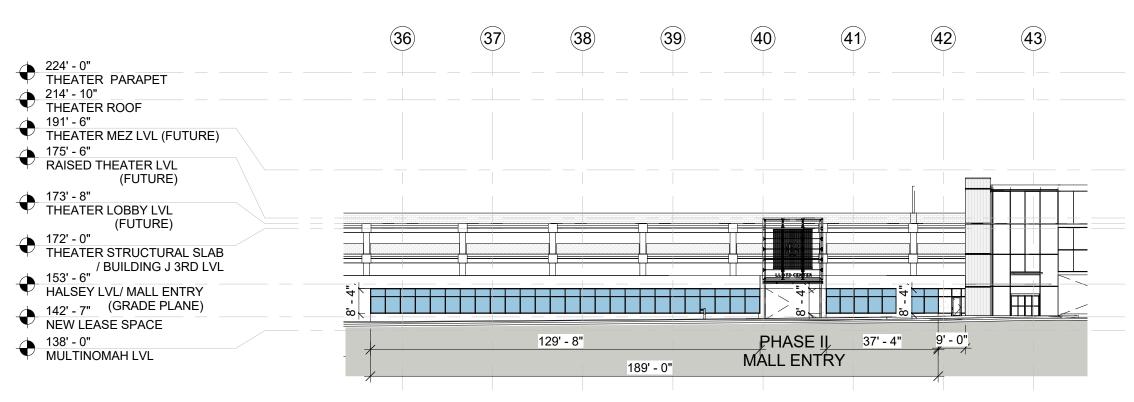
PROJECT NUMBER: CY1704

Title: LOT BOUNDARY DIAGRAM

Sheet No.

**APP.32** 



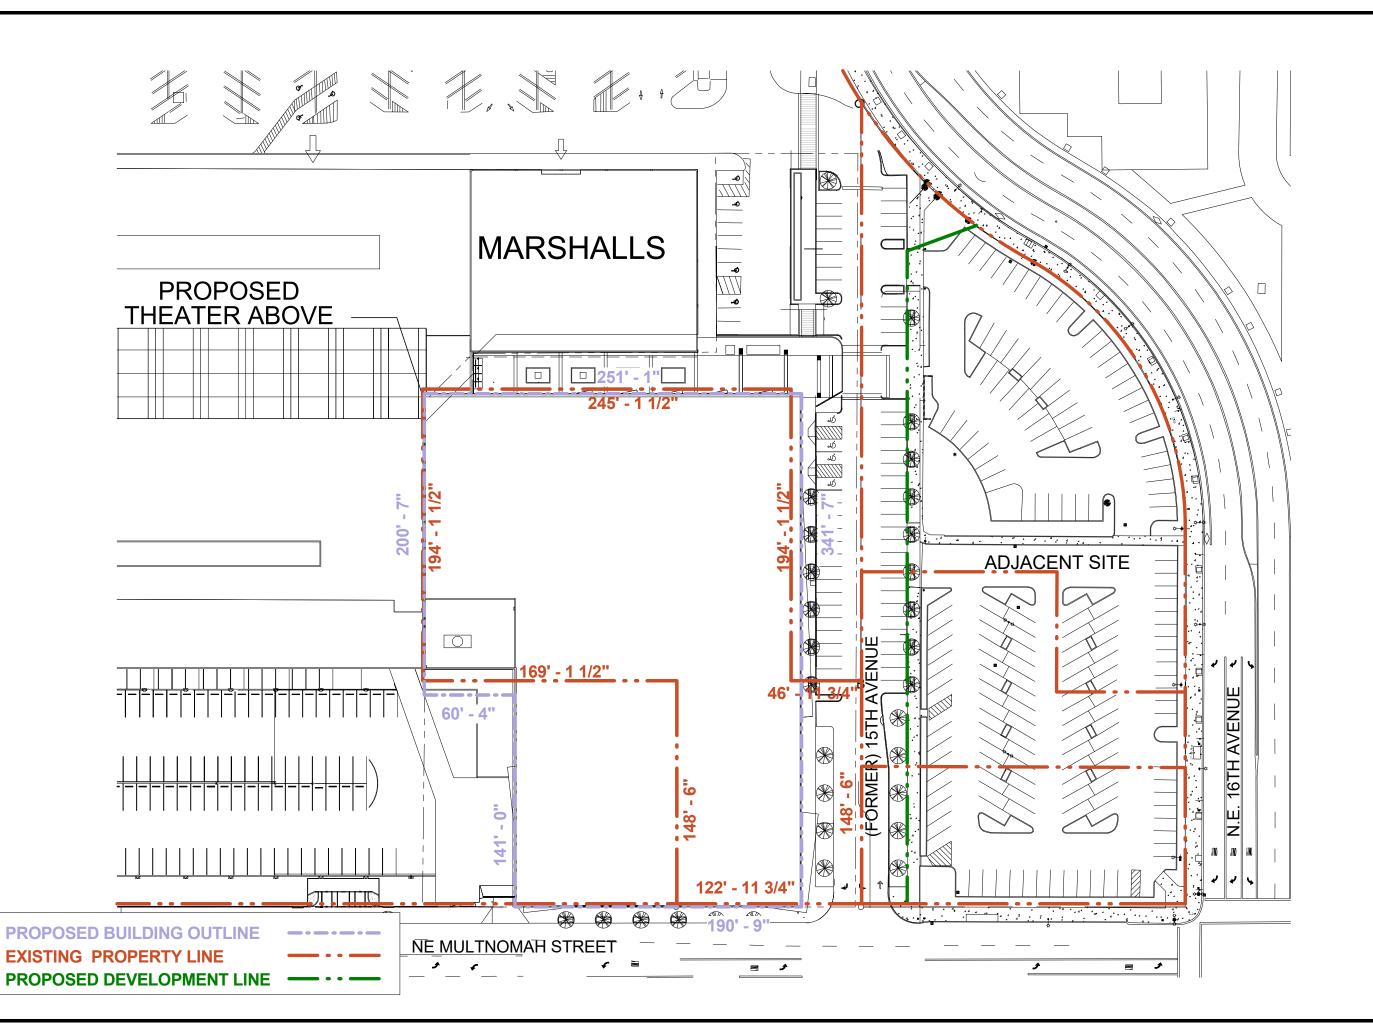

TOTAL BUILDING LENGTH: TOTAL AREA UP TO 9':

189' - 0" 1,701 SF

**GLAZING LENGTH: GLAZING AREA:** 

167' - 0" (88%) 1,392 SF (82%)





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09.15.2017 11.15.2017 Type III Update

# **SOUTH ELEVATION - PHASE II RETAIL**

SCALE: 1/32" = 1'-0"

(46) (50) (42) (43) (44) (45) (47) (48) (49) 224' - 0" THEATER PARAPET 214' - 10" THEATER ROOF 191' - 6" THEATER MEZ LVL (FUTURE) 175' - 6" RAISED THEATER LVL (FUTURE) 173' - 8" THEATER LOBBY LVL (FUTURE) 172' - 0" THEATER STRUCTURAL SLAB
/ BUILDING J 3RD LVL HALSEY LVL/ MALL ENTRY 142' - 7" (GRADE PLANE) **NEW LEASE SPACE MALL ENTRY** PHASE II 22' - 6" 154' -11" MULTINOMAHWALL ENTRY 245' - 4"

TOTAL BUILDING LENGTH: 245' - 4" 2,208 SF TOTAL AREA UP TO 9':

**GLAZING LENGTH:** 185' - 9" (76%) **GLAZING AREA:** 1,672 SF (76%) LLOYD CENTER

LLOYD CENTER EAST

**TYPE III LAND USE APPLICATION** 

1260 LLOYD CENTER PORTLAND, OREGON 97232

PROJECT NUMBER: CY1704

**GROUND WINDOW DIAGRAMS** 

Sheet No.

**APP.33** 

**SOUTH ELEVATION - THEATER** 

1

SCALE: 1/32" = 1'-0"

TOTAL BUILDING LENGTH: TOTAL AREA UP TO 9':

LENGTH: 322' - 6" TO 9': 2,903 SF

GLAZING LENGTH: GLAZING AREA: 283' - 8" (88%) 2,554 SF (88%)



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595 DESIGN


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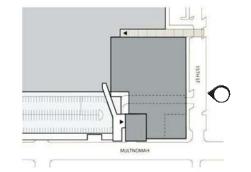


TYPE III LAND USE APPLICATION

1260 LLOYD CENTER PORTLAND, OREGON 97232

# 1 EAST ELEVATION

SCALE: 1/32" = 1'-0"

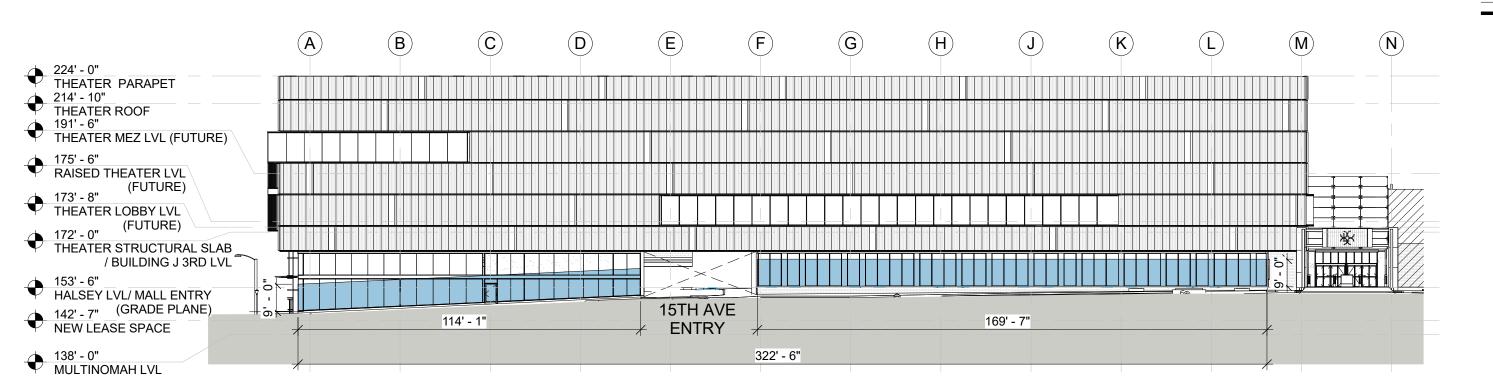


PROJECT NUMBER: CY1704

Title: GROUND WINDOW DIAGRAMS

Sheet No.

**APP.34** 

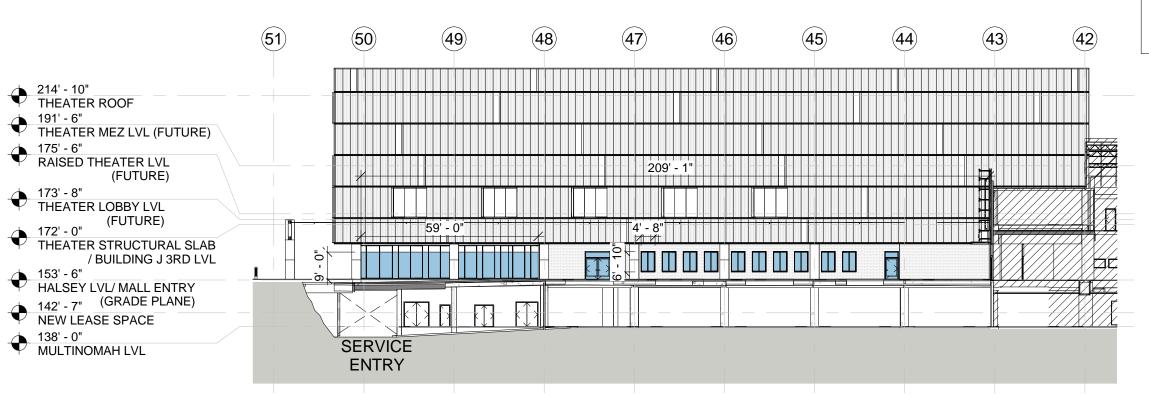

TOTAL BUILDING LENGTH: TOTAL AREA UP TO 9':

209' - 1" 1,882 SF

**GLAZING LENGTH: GLAZING AREA:** 

117' - 6" (56%) 963 SF (51%)





**CYPRESS** 

09.15.2017 Type III Update 11.15.2017

LLOYD CENTER LLOYD CENTER EAST

**TYPE III LAND USE APPLICATION** 

**TOTAL AREA UP TO 9':** 2,207 SF **GLAZING LENGTH:** 

TOTAL BUILDING LENGTH:

**GLAZING AREA:** 

141' - 2" (58%) 1,160 SF (53%)

245' - 2"

1260 LLOYD CENTER PORTLAND, OREGON 97232

PROJECT NUMBER: CY1704

**GROUND WINDOW DIAGRAMS** 

Sheet No.

**APP.35** 

**NORTH ELEVATION** SCALE: 1/32" = 1'-0"

(44) (46) **(47)** 48) 49 (50) (45) (51) 214' - 10" THEATER ROOF THEATER MEZ LVL (FUTURE) RAISED THEATER LVL (FUTURE) /245' - 2" 173' - 8" /22' - 4"/ THEATER LOBBY LVL (FUTURE) 172' - 0" THEATER STRUCTURAL SLAB / BUILDING J 3RD LVL HALSEY LVL/ MALL ENTRY 142' - 7" (GRADE PLANE) NEW LEASE SPACE 138' - 0" **SERVICE** MULTINOMAH LVL **ENTRY** 

**SOUTH ELEVATION** 

SCALE: 1/32" = 1'-0"







Daljas, Texas 73223		
DATE		
09.15.2017		
11.15.2017		






1260 LLOYD CENTER PORTLAND, OR 97232



Title: MULTNOMAH STREET **FRONTAGE** DIAGRAM

Sheet No. APP.36

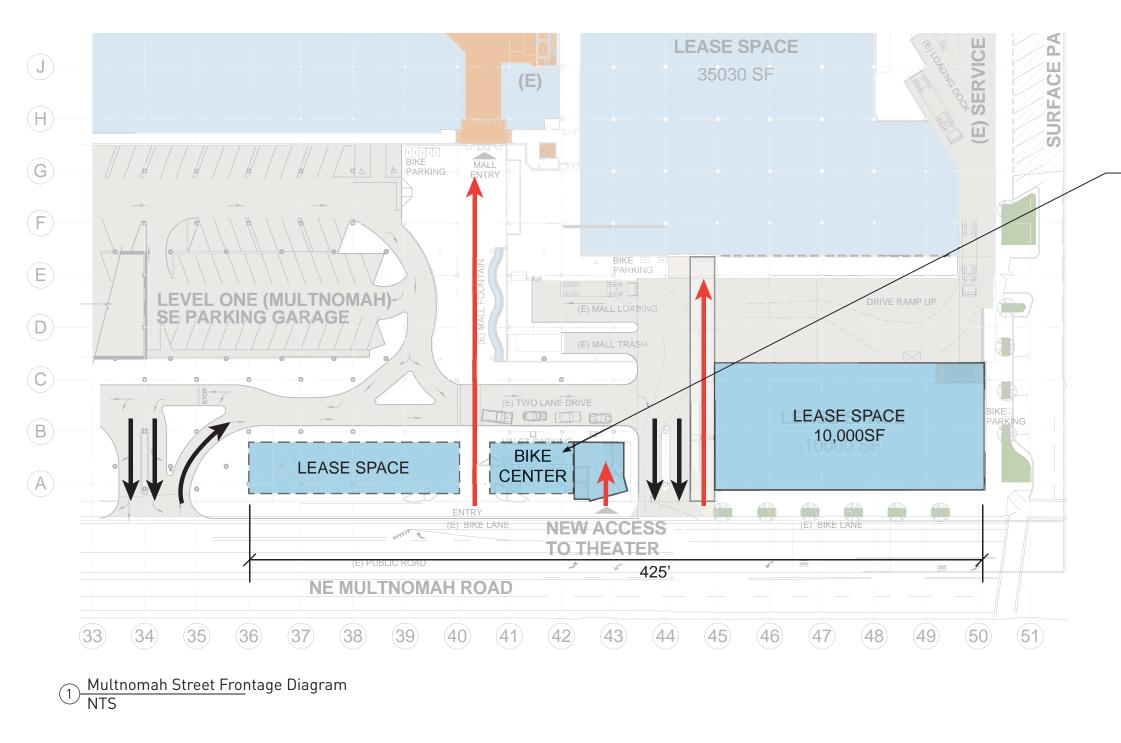


Ref: Santa Monica Bike Center






**MULTNOMAH MALL ENTRY** 


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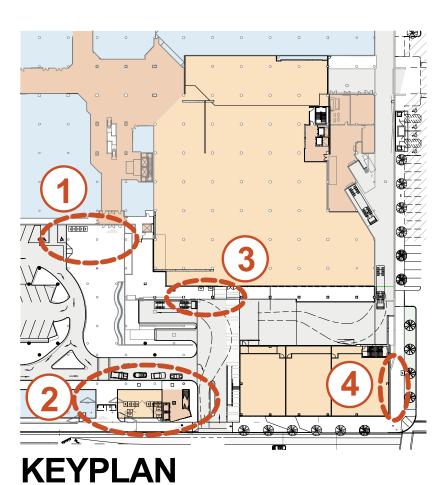


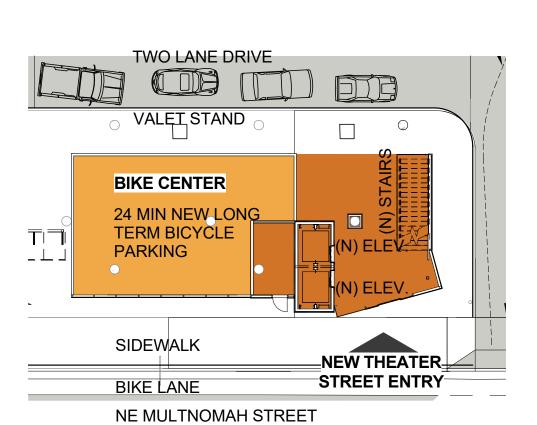

**NEW TENANT / OFFICE ENTRY LEVEL 1** 

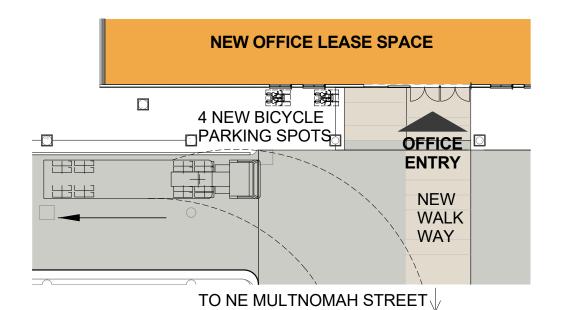



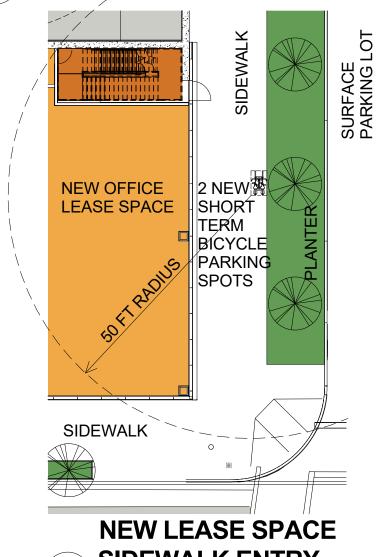







LLOYD CENTER EAST


**TYPE III LAND USE APPLICATION** 

1260 LLOYD CENTER PORTLAND, OREGON

PROJECT NUMBER: CY1704


**BICYCLE PARKING DIAGRAMS MULTNOMAH LEVEL** 

Sheet No.

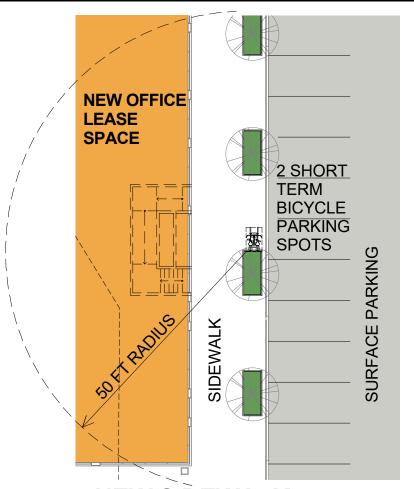




SCALE: 1" = 20'-0"

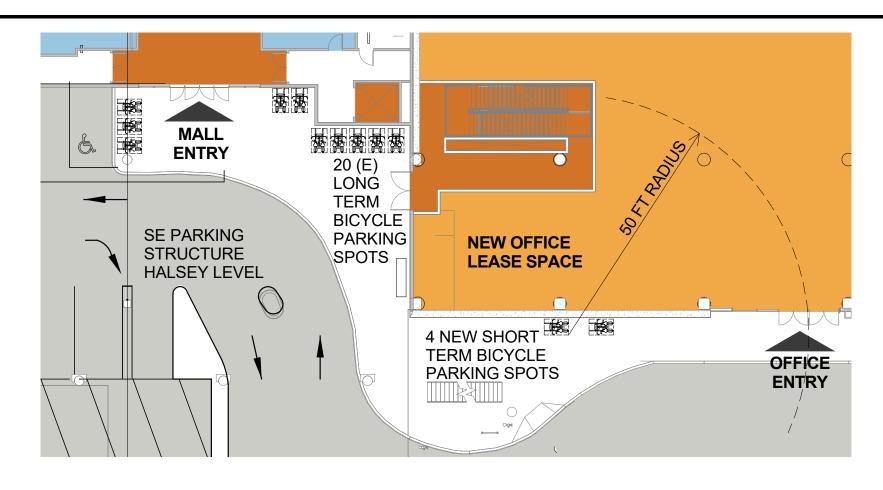


**EXISTING HALSEY LEVEL MALL ENTRY AND NEW** 

**TENANT / OFFICE LEVEL 2 ENTRY** 

SCALE: 1" = 20'-0"

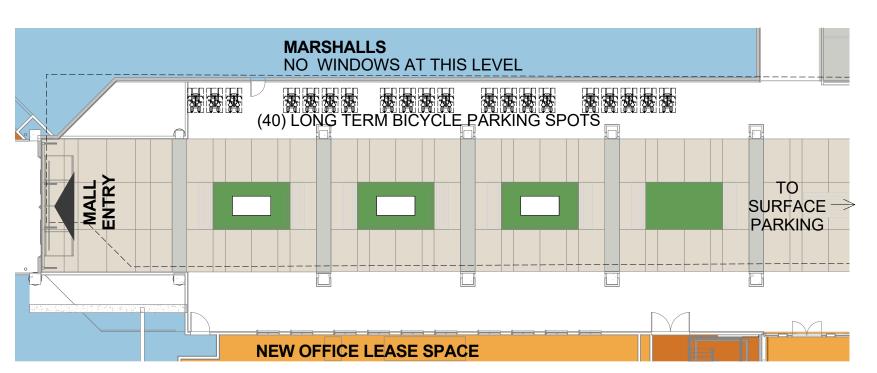



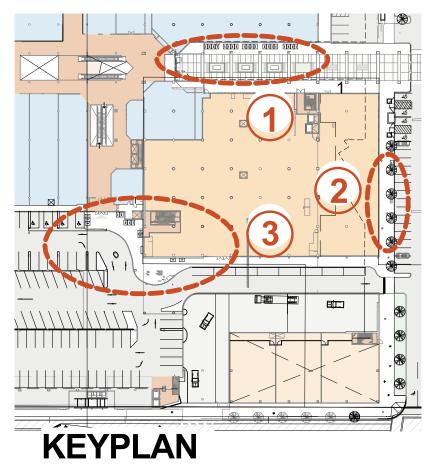



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**TYPE III LAND USE APPLICATION** 


1260 LLOYD CENTER PORTLAND, OREGON

PROJECT NUMBER: CY1704

**BICYCLE PARKING DIAGRAMS** 

**HALSEY LEVEL** 

Sheet No.

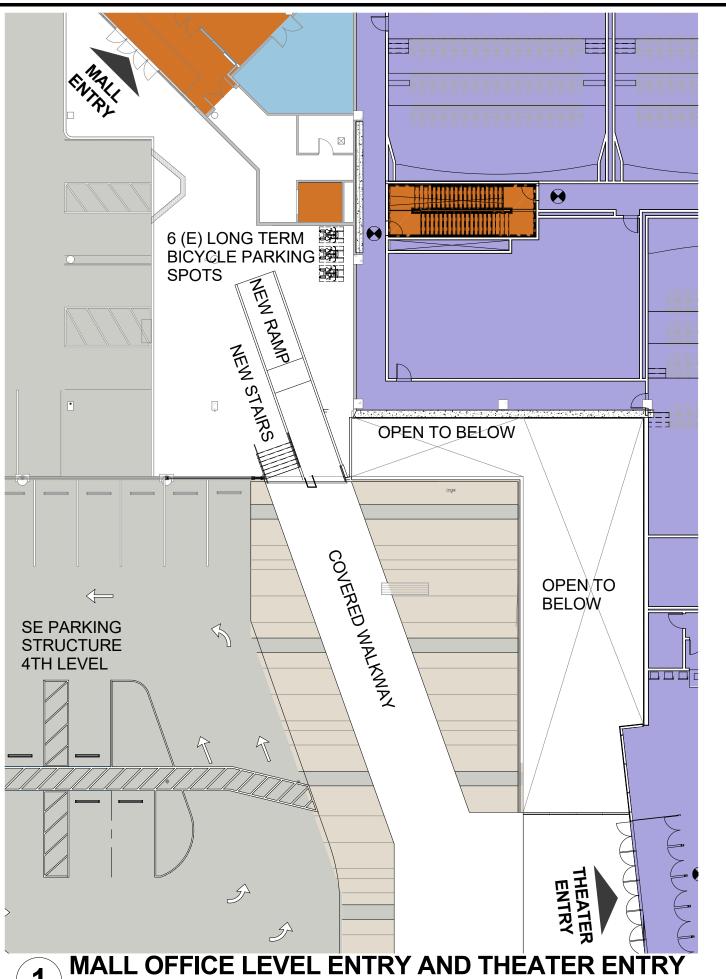

SCALE: 1" = 20'-0"







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Type III Update	11.15.2017
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LLOYD CENTER LLOYD CENTER EAST


**TYPE III LAND USE APPLICATION** 


1260 LLOYD CENTER PORTLAND, OREGON 97232

PROJECT NUMBER: CY1704

**BICYCLE PARKING DIAGRAMS** OFFICE / **THEATER** LEVEL

Sheet No. APP.39

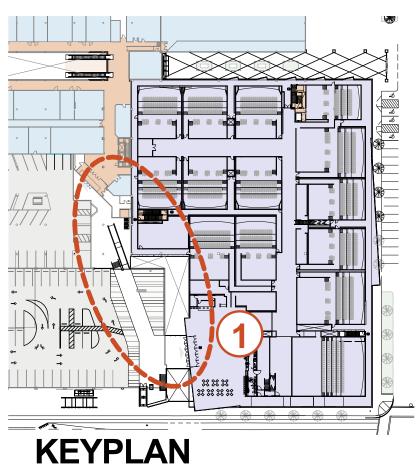

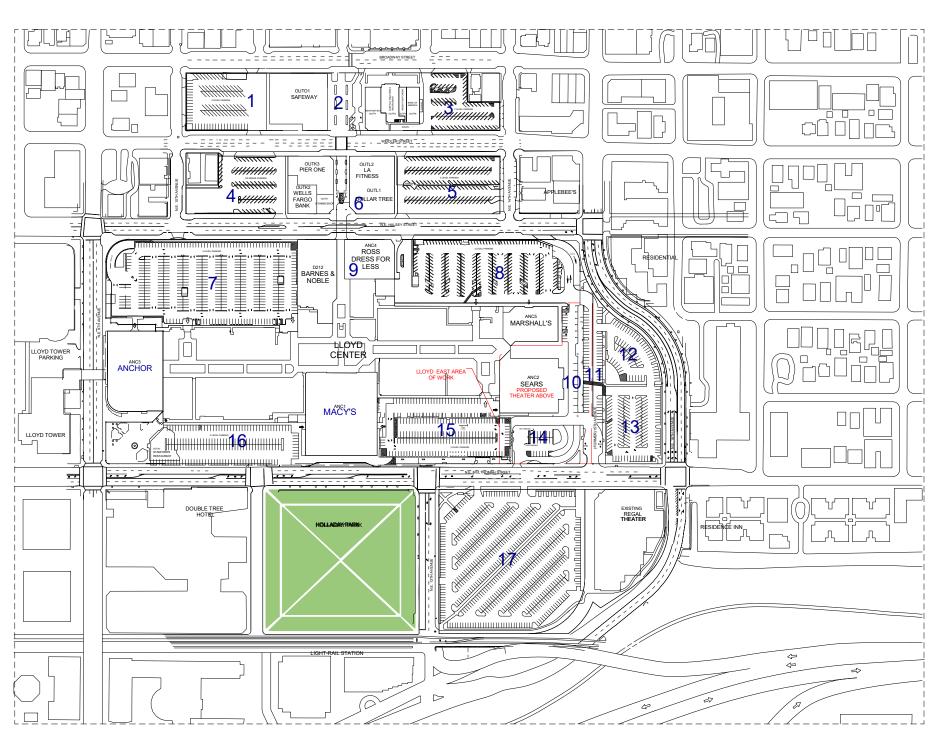

#### **EXISTING LLOYD CENTER PARKING COUNTS**

	PARKING AREA	STANDARD	ADA	TOTALS	NOTES
1.	SAFEWAY UPPER	89	3		
	SAFEWAY LOWER	88	4	184	
2.	SURFACE LOT	6	2	8	
_	BANK OF AMERICA STRUCTURE -UPPER	89	3		
-	BANK OF AMERICA STRUCTURE -LOWER	95	0	187	
4.	SURFACE LOT	121	2	123	
_	DOLLAR TREE STRUCTURE -TOP	152	4		
٥.	DOLLAR TREE STRUCTURE -MID	165	4		
	DOLLAR TREE STRUCTURE -LOW	20	0	345	
6	LA FITNESS LEVEL 1A	60	0	0.0	
٠.	LA FITNESS - LEVEL 1A	61	0	121	
7	LLOYD CENTER NW STRUCTURE-LEVEL 3	417	8		
	LLOYD CENTER NW STRUCTURE-LEVEL 3	348	4		
	LLOYD CENTER NW STRUCTURE-LEVEL 3	329	5		
	LLOYD CENTER NW STRUCTURE-LEVEL 3	348	3		
	LLOYD CENTER NW STRUCTURE-LEVEL 3	420	6	1888	
Ω	LLOYD CENTER NE STRUCTURE-LEVEL 2	224	6	1000	
u.	LLOYD CENTER NE STRUCTURE-LEVEL 2	55	0		
	LLOYD CENTER NE STRUCTURE-LEVEL 1A		2	517	
a	LLOYD CENTER TOP LOT	21	0	21	
	SEARS - EAST SURFACE LOT	7	0	7	
_	SURFACE LOT	70	10	80	
	SURFACE LOT	59	0	59	
	SURFACE LOT	113	1	114	
_	SURFACE LOT	18	2	20	
	LLOYD CENTER S. STRUCTURE LEVEL 3	175	6	20	
13.	LLOYD CENTER S. STRUCTURE RAMP	78	0		
	LLOYD CENTER S. STRUCTURE RAMP	7 o 82	0		
	LLOYD CENTER S. STRUCTURE LEVEL 2A	61	0		
	LLOYD CENTER S. STRUCTURE LEVEL 2A LLOYD CENTER S. STRUCTURE RAMP	129 57	7 0		
				004	
16	LLOYD CENTER S. STRUCTURE LEVEL 1 STANFORD'S -UPPER LEVEL	62 129	4 2	661	
10.	STANFORD'S -LOWER LEVEL	64	4		
	RAMP TO LOWER DELIVERY	14	0	213	
17	EXISTING THEATER SURFACE LOT	601	14	-615	
17.	EXISTING THEATER SURFACE LOT	001	14	-010	PER APPROVED
					DEVELOPMENT
	TOTALS	4456	92	4548	
	ADDITIONAL PARKING AREA				
	ON STREET PARKING				
	NON-METERED STANDARD				
	NON-METERED STANDARD 38 5 HOUR METERED 85				
	2 HOUR METERED 94				
	15 MINUTE METERED				
	TAXI ONLY				
	TAXI ONLY 4 TRUCK LOADING ONLY 5				1
	BUS DESIGNATED 1				
	SUBTOTAL 232				
	TOTALS			4780	



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LLOYD CENTER EAST

TYPE III LAND USE

**APPLICATION** 

1260 LLOYD CENTER PORTLAND, OREGON 97232

PROJECT NUMBER: CY1704

Title: PARKING PLANS -EXISTING

Sheet No.

APP.40



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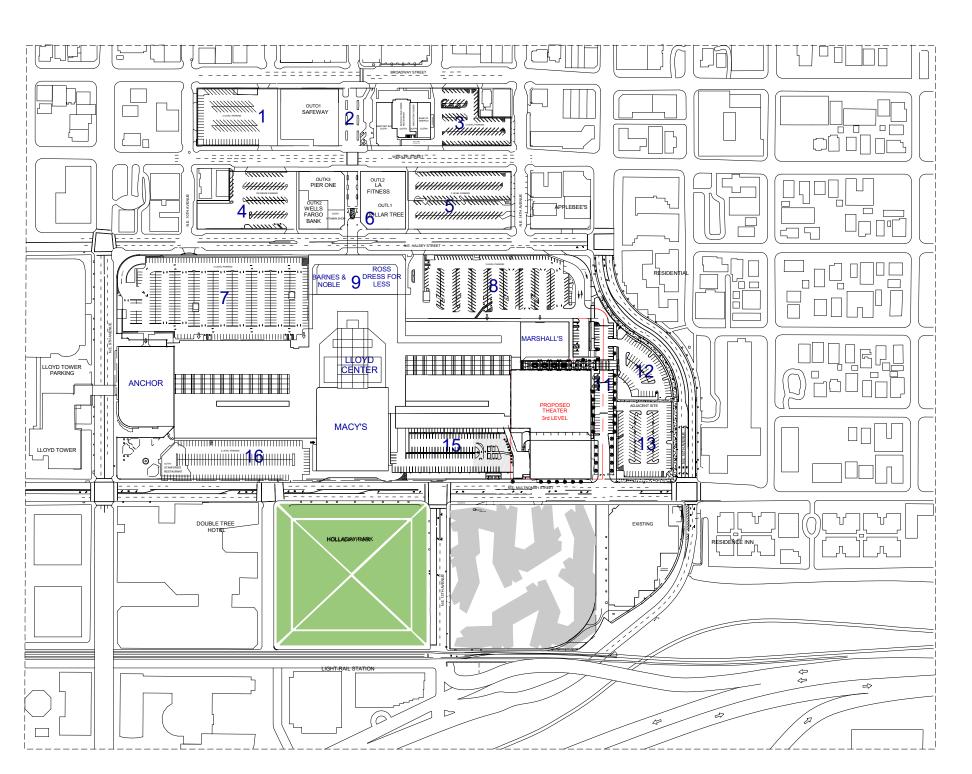
TYPE III LAND USE APPLICATION

1260 LLOYD CENTER PORTLAND, OREGON 97232

PROJECT NUMBER: CY1704


Title:
PARKING
PLANS PROPOSED

Sheet No. APP.41



### PROPOSED LLOYD CENTER PARKING COUNTS

	PARKING AREA	STANDARD	ADA	TOTALS	NOTES
1.	SAFEWAY UPPER	89	3		
	SAFEWAY LOWER	88	4	184	NO CHANGE
2.	SURFACE LOT	6	2	8	NO CHANGE
3.	BANK OF AMERICA STRUCTURE -UPPER	89	3		NO CHANGE
	BANK OF AMERICA STRUCTURE -LOWER	95	0	187	
4.	SURFACE LOT	121	2	123	NO CHANGE
5.	DOLLAR TREE STRUCTURE -TOP	152	4		NO CHANGE
	DOLLAR TREE STRUCTURE -MID	165	4		
	DOLLAR TREE STRUCTURE -LOW	20	0	345	
6.	LA FITNESS LEVEL 1A	60	0		NO CHANGE
	LA FITNESS - LEVEL 1A	61	0	121	
7.	LLOYD CENTER NW STRUCTURE-LEVEL 3	417	8		NO CHANGE
	LLOYD CENTER NW STRUCTURE-LEVEL 3	348	4		
	LLOYD CENTER NW STRUCTURE-LEVEL 3	329	5		
	LLOYD CENTER NW STRUCTURE-LEVEL 3	348	3		
	LLOYD CENTER NW STRUCTURE-LEVEL 3	420	6	1888	
8.	LLOYD CENTER NE STRUCTURE-LEVEL 2	224	6		NO CHANGE
	LLOYD CENTER NE STRUCTURE-LEVEL 1A	55	0		
	LLOYD CENTER NE STRUCTURE-LEVEL 1A	230	2	517	
9.	LLOYD CENTER TOP LOT	21	0		NO CHANGE
	SEARS EAST SURFACE LOT-REMOVED	_	_	-	LOT REMOVED
					DUE TO ADDITIO
11.	SURFACE LOT (ADDED NEW SPACES)	76	6	82	REVISED LAYOU
12.	SURFACE LOT	59	0		NO CHANGE
13.	SURFACE LOT	113	1	114	NO CHANGE
14.	SURFACE LOT -REMOVED	-	-	-	LOT REMOVED DUE TO ADDITION
15.	LLOYD CENTER S. STRUCTURE LEVEL 3	137	13		REVISED PARKII
	LLOYD CENTER S. STRUCTURE RAMP	78	0		LAYOUT
	LLOYD CENTER S. STRUCTURE LEVEL 2A	82	0		-THEATER DROF
	LLOYD CENTER S. STRUCTURE RAMP	61	0		OFF AREA
	LLOYD CENTER S. STRUCTURE LEVEL 2A	129	7		
	LLOYD CENTER S. STRUCTURE RAMP	57	0		
	LLOYD CENTER S. STRUCTURE LEVEL 1	62	4	630	
16.	STANFORD'S -UPPER LEVEL	129	2		NO CHANGE
	STANFORD'S -LOWER LEVEL	64	4		
	RAMP TO LOWER DELIVERY	14	0	213	
	TOTALS	4123	93	4498	
	TOTALS	4123	33	+430	
	ADDITIONAL PARKING AREA				
	ON STREET PARKING TOTALS				
	NON-METERED STANDARD 38				
	5 HOUR METERED 85				
	2 HOUR METERED			94	
	15 MINUTE METERED 5				
	TAXI ONLY 4				
	TRUCK LOADING ONLY			5	
	BUS DESIGNATED 1				
	SUBTOTAL 232				
	TOTALS			1720	
	TOTALS		4	1730	

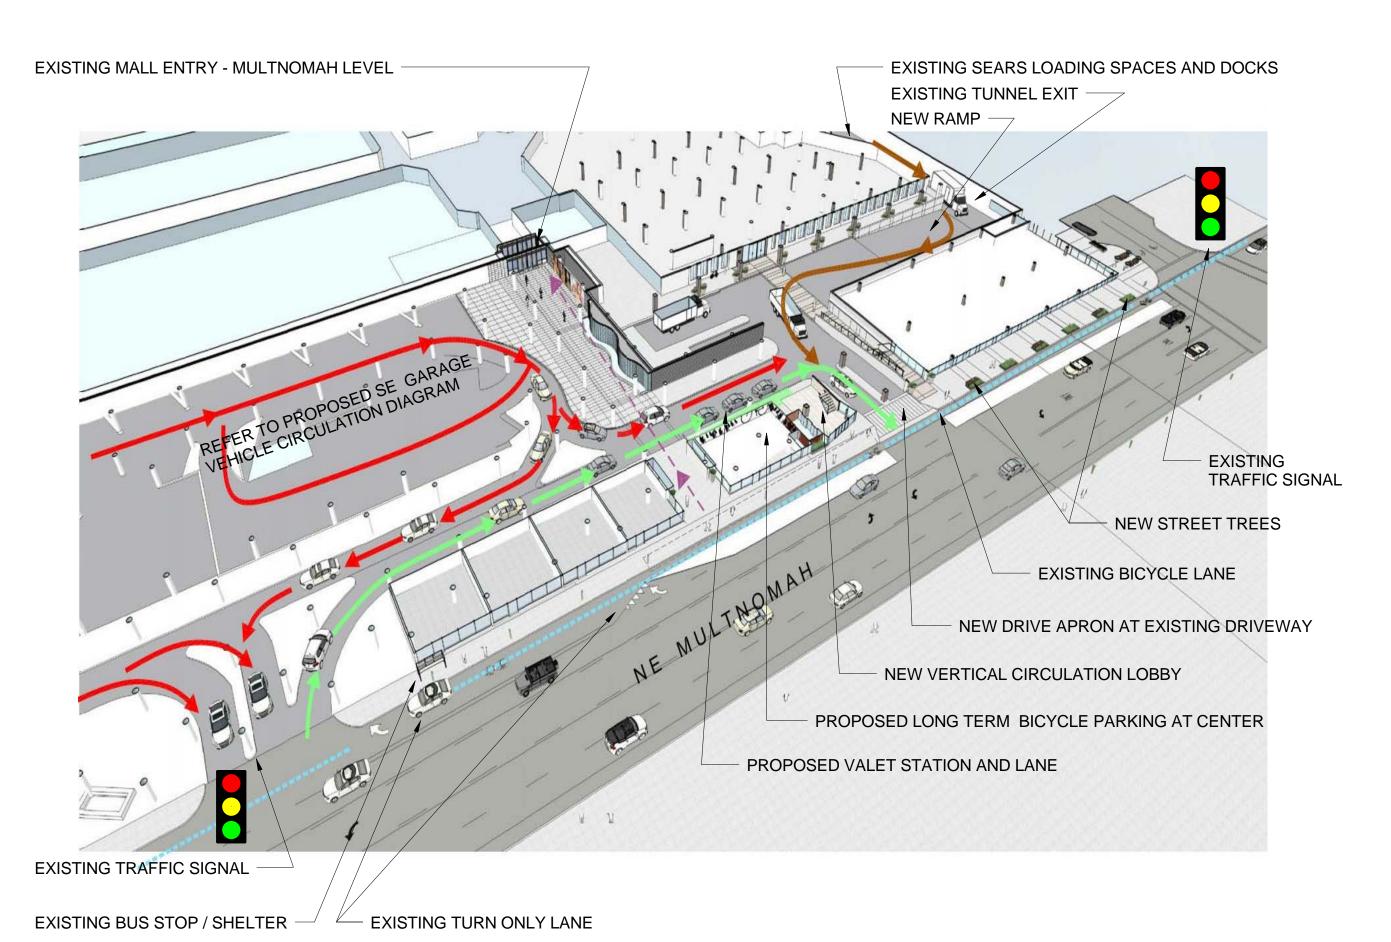



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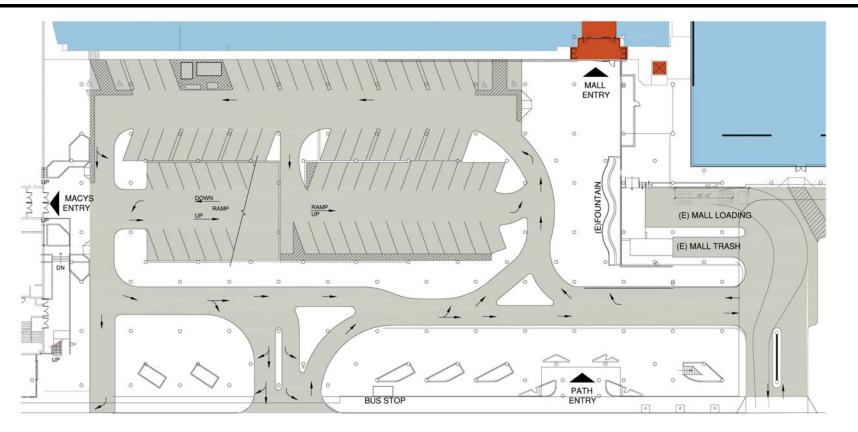
TYPE III LAND USE APPLICATION

1260 LLOYD CENTER PORTLAND, OREGON 97232

PROJECT NUMBER: CY1704

PROPOSED
TRANSPORTATION
DIAGRAM AT
MULTNOMAH

Sheet No.



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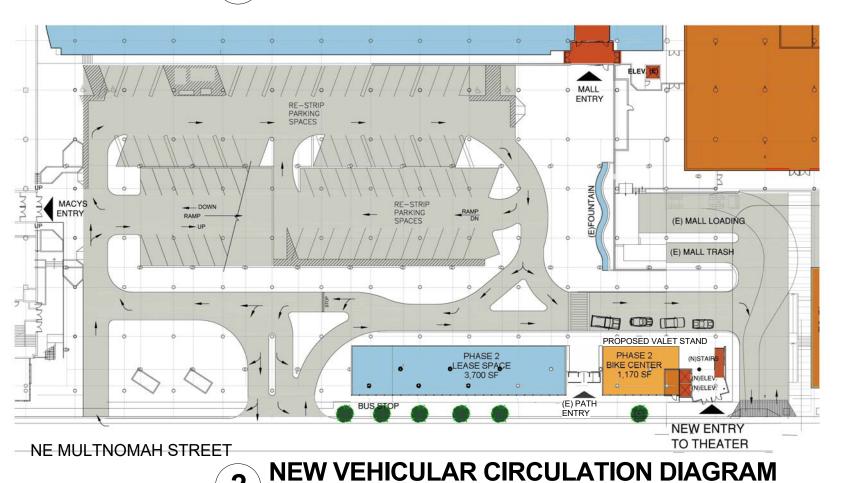
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NE MULTNOMAH STREET

# EXIST

## **EXISTING VEHICULAR CIRCULATION DIAGRAM**



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LLOYD CENTER LLOYD CENTER EAST

TYPE III LAND USE APPLICATION

1260 LLOYD CENTER PORTLAND, OREGON 97232

PROJECT NUMBER: CY1704

Title:

TRANS-PORTATION DIAGRAM AT MULTNOMAH

Sheet No.

#### Responses to issued raised at prior Design Advice Review

This memo summarizes Design Commission design direction provided on June 8, 2017.

Commissioners in attendance on June 8, 2017: David Wark, Julie Livingston, Sam Rodriguez, Don Vallaster, Tad Savinar

Note – These summary notes are in addition to those provided at the first DAR which occurred on April 13, 2013 and summarized in a memo dated May 18, 2017.

#### **Comments/Responses**

#### NE Multnomah Street-Level Parking | Access to Below-Grade Loading

• The Commission was supportive of the expansion of the building along Multnomah, however other elements of the frontage are not yet resolved.

Response: The façade of the proposed 10,000 square foot lease space along Multnomah Street is ordered with protective pedestrian canopy, rhythm of glass curtainwall vertical mullions and modular future tenant entry canopy and tenant sign design standard.

• The proposal isn't meeting urban streetscape guidelines along NE Multnomah.

Response: Building Façade along NE Multnomah meets streetscape guidelines by providing pedestrian rain protection.

• The triple-width drive and walk aisles should be minimized to the greatest extent possible.

Response: The driveway is reduced to two lanes.

• The theater entrance remains remote, separated from the theater lobby by 3 drive aisles, and doesn't support the street.

Response: Orientation of theater lobby is based on theater operator's prototypical design, requiring patrons to enter lobby from SE parking structure's top deck. The patrons are gathered from the street level or SE parking structure's lower levels and then cross the pedestrian walkway to enter the lobby.

• The entry sequence to the theater from Multnomah is not good as one enters into an unconditioned space and then an exterior path at the garage level before getting to the lobby.

Response: The added theater is a major entertainment venue that will now become a major tenant located on the third level of Lloyd Center Shopping Mall. As condition of the lease between the theater operator and mall owner, the mall owner is required to provide 2 elevators and stairs at the mall's SE parking structure for the convenience of theater patrons. (The existing parking structure's vertical circulation is dis-jointed and not direct.)

As part of the shopping mall use, the theater patron can utilize the internal mall entry sequence to access the theater via a new covered walkway from the interior of the mall's third level.

• The theater lobby and upper floors should extend and connect westward to the stair entry as conditioned space.

Response: The mall and theater owner would not like to condition the circulation "tower" or provide an extended lobby west to the parking deck due to added cost for additional built structure and climate conditioning. Furthermore, the Building Code requires a 20 feet separation between the anchor building and SE parking structure.

• The theater lobby should extend and connect westward to the stair entry.

Response: See response above.

• The perceived height of the garage entry along Multnomah needs to be lowered.

Response: The height of the truck access entry is lowered to 14'-0" to still allow large tractor trailer trucks.

• The walkway to the back office level and the glass wall is a "flimsy response" and creates a false sense of façade.

Response: Entry walkway to back offices has been revised to create a "stronger" horizontal glazed façade band to appear 'less" flimsy".

• If the walkway stays it should be narrowed as the extra width intended to provide spill out area would not be desirable given the surrounding vehicle activity within the garage.

Response: The walkway is narrowed.

• Be forward thinking toward reduced personal vehicles as the primary mode of accessing the theater.

Response: Existing Metro train station is in close proximity to the Lloyd Center. Bus stops are located adjacent to the mall along Multnomah. The mall currently provides required long and short term bicycle parking. Overall personal vehicle parking spaces will not be added to the Lloyd Center. A passenger drop off area may be created in front of new theater circulation tower, but Multnomah Street along the shopping center between former 15th and Macy's anchor currently has a dedicated bicycle lane.



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TYPE III LAND USE APPLICATION

1260 LLOYD CENTER PORTLAND, OREGON 97232

PROJECT NUMBER: CY1704

RESPONSES
TO DAR

Sheet No.

APP\_44

#### **Form**

• Three of the four major moves in the building (glass boxes) are form only, and not function (i.e. active space).

Response: The functions of the movie theater's interior space that can be expressed on the exterior are limited to the lobby function; other theater functions such as the auditoriums and theater access lobby corridors are inward focused.

 Given the high visibility and gateway quality of the southeast corner of the building, the glass box form (sign box) must have occupiable space. Extending the lobby area of the theater toward the east was suggested.

Response: Revising and Extending Lobby area prototype sequence (tickets to admission to concession to theater) towards the East.

A Commissioner expressed the glass forms seems forced and goes against precedent.

Response: The glass forms create large compositional elements can find precedent at previous Lloyd mall anchors were created from large compositional forms in masonry, concrete or perforated metal panels rather than glass to break down the large scale building massing.

#### **Materials**

• The selection of the building's skin will be critical to the success of the large box.

Response: The revised design of the exterior metal panel skin has a clean, neat appearance with shifting colored panels for a more dynamic skin. Details of the metal panels such as coping, outside corners, reveals, head and jambs will help create a uniform exterior skin concept.

- Creativity is welcome, however, there can be no doubt in success of the skin.
- The success of the material will come down to the color, texture and dimension.

Response: Design proposes 10 custom panel colors, panel profile and a 30"wide by 10'-6" high panel module.

• The façade design needs more "logic" in form, materials and construction details appropriate to the chosen materials.

Response: Façade design now has more development of "logic" in form, material and construction details as metal panel presentation has been developed with local sheet metal vendors. A datum of horizontal reveals now order the vertical divisions of the façade and allow the rotating glass forms to organize in between these reveals.

• Metal cladding was noted as being potentially successful; however, it depends on the detailing.

Response: See comments above.

• The Art House building in NW Portland was noted as an example of how the quality of an affordable material was elevated in its application.

Response: Multi colored panels and strong horizontal banding will help "elevate" the design character of the theater building, similar to the ArtHouse Building (although the ArtHouse building is more "Baroque" in its expression of out of plane metal panels).

• The Commission would not be supportive of EIFS.

Response: EIFS will not be used on this project.

Concern with the number of joints associated with stucco finish was expressed.

Response: Stucco finishes are reduced to the existing former Sears façade on Halsey Level along proposed new East mall entry.

Material samples will need to be provided at future hearings.

Response: Material samples and panel mock-up will be provided at scheduled Type III Land Use hearing.

#### **Driveway / 15th Avenue Frontage**

 The Commission was supportive of the changes along the eastern driveway, particularly the wide sidewalk, benches and landscaping (included street trees).

Response: The East facing façade contains a 12' wide sidewalk, pedestrian rain protection and street trees and benches. Planters and some Storm Water Planters will also be incorporated.

• The parking to remain angled, rather than parallel, is acceptable, especially given the recent addition of pedestrian amenities along the driveway.

Response: Angled parking remains in the proposed design of this surface interior parking lot (former 15th Avenue).

• The extension of the glazed wall along the driveway to enclose the vehicular movement behind could include be fritted glass that is denser at the pedestrian level to limit views into the garage while allowing light to the lower office level.

Response: Glazed wall above vehicular movement will be 'denser' at pedestrian level to limit views.

• It was suggested to reach out to PBOT to discuss any potential to allow drop off area or short term parking along the Multnomah frontage of the theater.

Response: Proposed Drop off area to be review in LU application for comment.











**TYPE III LAND USE APPLICATION** 

1260 LLOYD CENTER PORTLAND, OREGON

PROJECT NUMBER: CY1704

**RESPONSES** TO DAR (CONTINUED)

#### **East Mall Entry**

• The Commission was supportive of the changes to the east mall entry plaza that added bike parking, more glazing, landscaping and benches.

Response: Proposed new East Mall entry plaza will have long term bicycle parking spaces, landscaping, seating benches and glazed mall logo entry fascia sign.

• The entry /sign arch needs further study and design. It should be as elegant and sophisticated as the theater "box" that it is attached to.

Response: Free standing entry "arch" sign is updated a detached from building.

• New landscaping should draw from the history of landscaping at the mall when it was open-air, in terms of amount and species.

Response: Some of the original Lloyd Center landscaping had a 'tropical show' theme, which is not native to the Portland area.

#### **Other Comments**

• The project needs to focus and respond on the following design guidelines:

Response: See LU Narrative for design guidelines compliance.

• Integrate the Lloyd Center Shopping Center into the Lloyd District (A5.8)

Response: The Lloyd Center will evolve to its upcoming urban context by extending over the former parking areas that once surrounded the center. At the corner of Multnomah and 15th, a new urban gateway building mass will create the new neighborhood defining presence of the Lloyd Center at the Lloyd District boundary.

Provide Weather Protection (B6 and B6-1)

Response: The building provides pedestrian weather protection all along the street level.

Complement the Context of Existing Buildings (C4)

Response: The revised anchor building with theater will have a large mass, similar to the context of other existing large box anchor buildings such as Macy's and former Nordstrom on site. The adjacent large scale 4 level SE parking garage will complement the expanded anchor's large mass.

• Orient Development along the Lloyd District's Eastern Edge toward Adjacent Neighborhoods (C3-2)

Response: The proposed new East Mall entry will provide convenient access directly into the shopping mall from the neighborhood directly to the East. The orientation of the processional entry walkway creates a unique spacial experience.



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TYPE III LAND USE APPLICATION

1260 LLOYD CENTER PORTLAND, OREGON 97232

PROJECT NUMBER: CY1704

Title: RESPONSES TO DAR (CONTINUED)

Sheet No.

APP.46